


Site Plan Review Class 3


Size Plan Review Class 3

ARCHITECT

Auto Sales

SPR 11

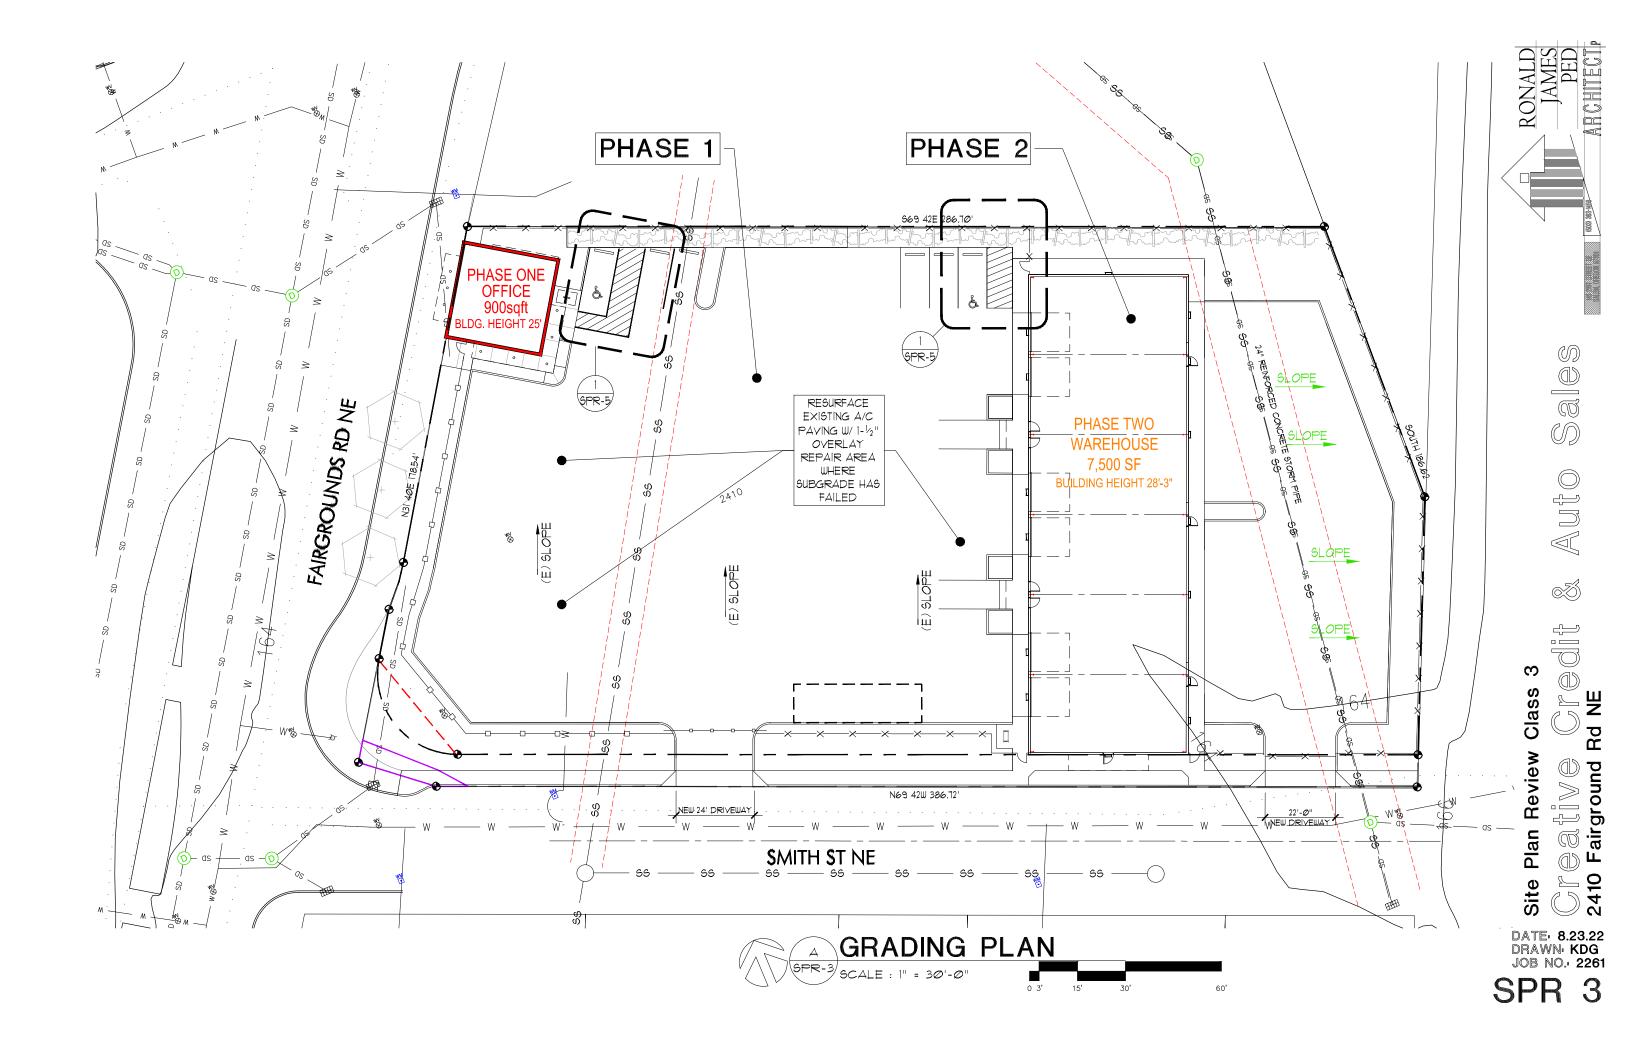

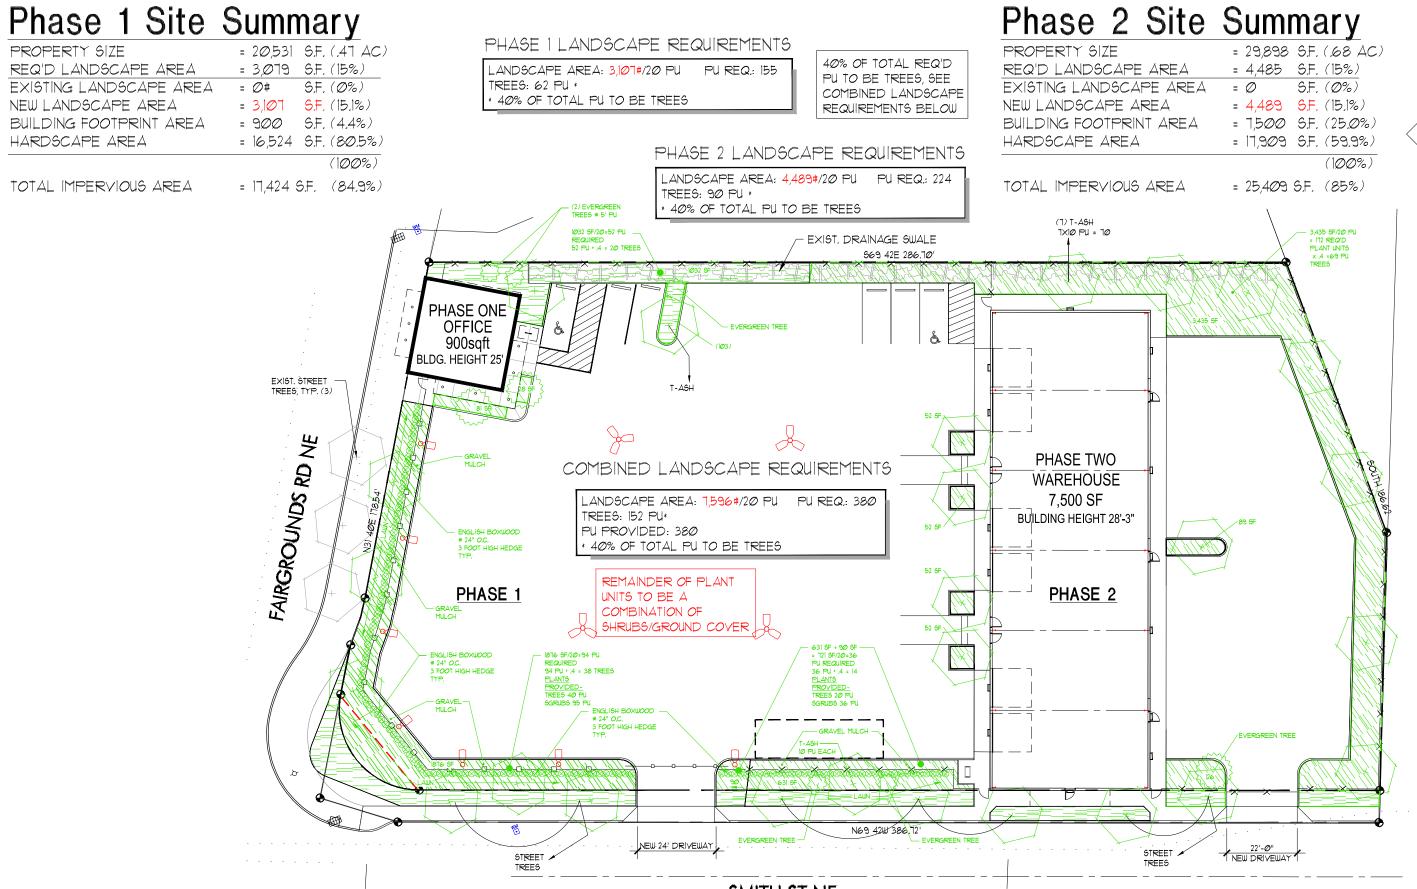




Site Plan Review Class 3

Creative Credit & //

RONALD JAMES PED ARCHITECTP

DATE: 8.23.22 DRAWN: KDG JOB NO.: 2261

SPR 6

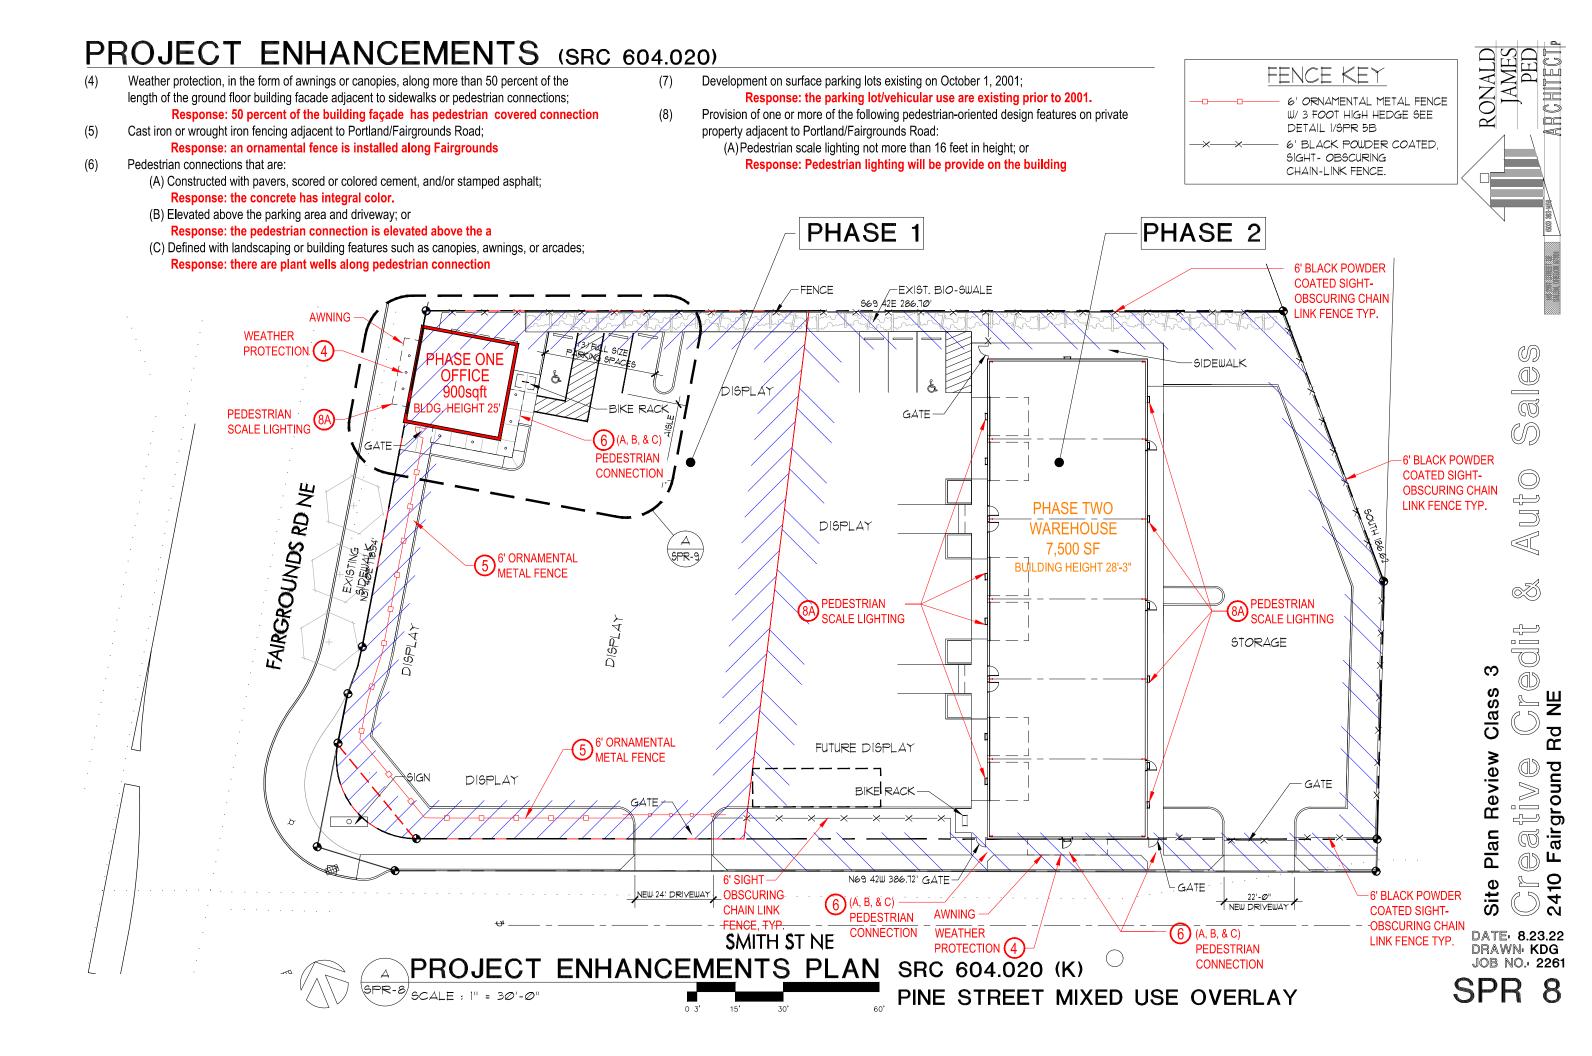

COMPLETE SITE SUMMARY
PROPERTY SIZE =50,429 SF (1.15AC)
REQUIRED LANDSCAPE =7,564 SF (15%)
NEW LANDSCAPE AREA =7,596 SF (15%)
BUILDING FOOTPRINT =8,400 SF (16.7%)
HARDSCAPE AREA =34,433 SF (68.2%)

PARKING SPACES

I PER 900 sf (MOTOR VEHICLE SALES)

PHASE I

SPACE REQ'D (900 sf / 900 = 1)

3 (1x2.5) SPACES PROVIDED

WAREHOUSE


2 CRASS PEOUS (15.00 st / 5.00 = 2)

2 SPACE REQ'D (1,500 sf / 5000 = 2) 5 (2x2.5) SPACES PROVIDED BICYCLE SPACES | PER 9,000 of (MOTOR VEHICLE SALES)
PHASE | | SPACE REQ'D (900 of / 9,000 = .1)
| SPACES PROVIDED

RONALD JAMES PED

ARCHIECT

PHASE 2
1ST FLR WAREHOUSE 4 SPACES PROVIDED

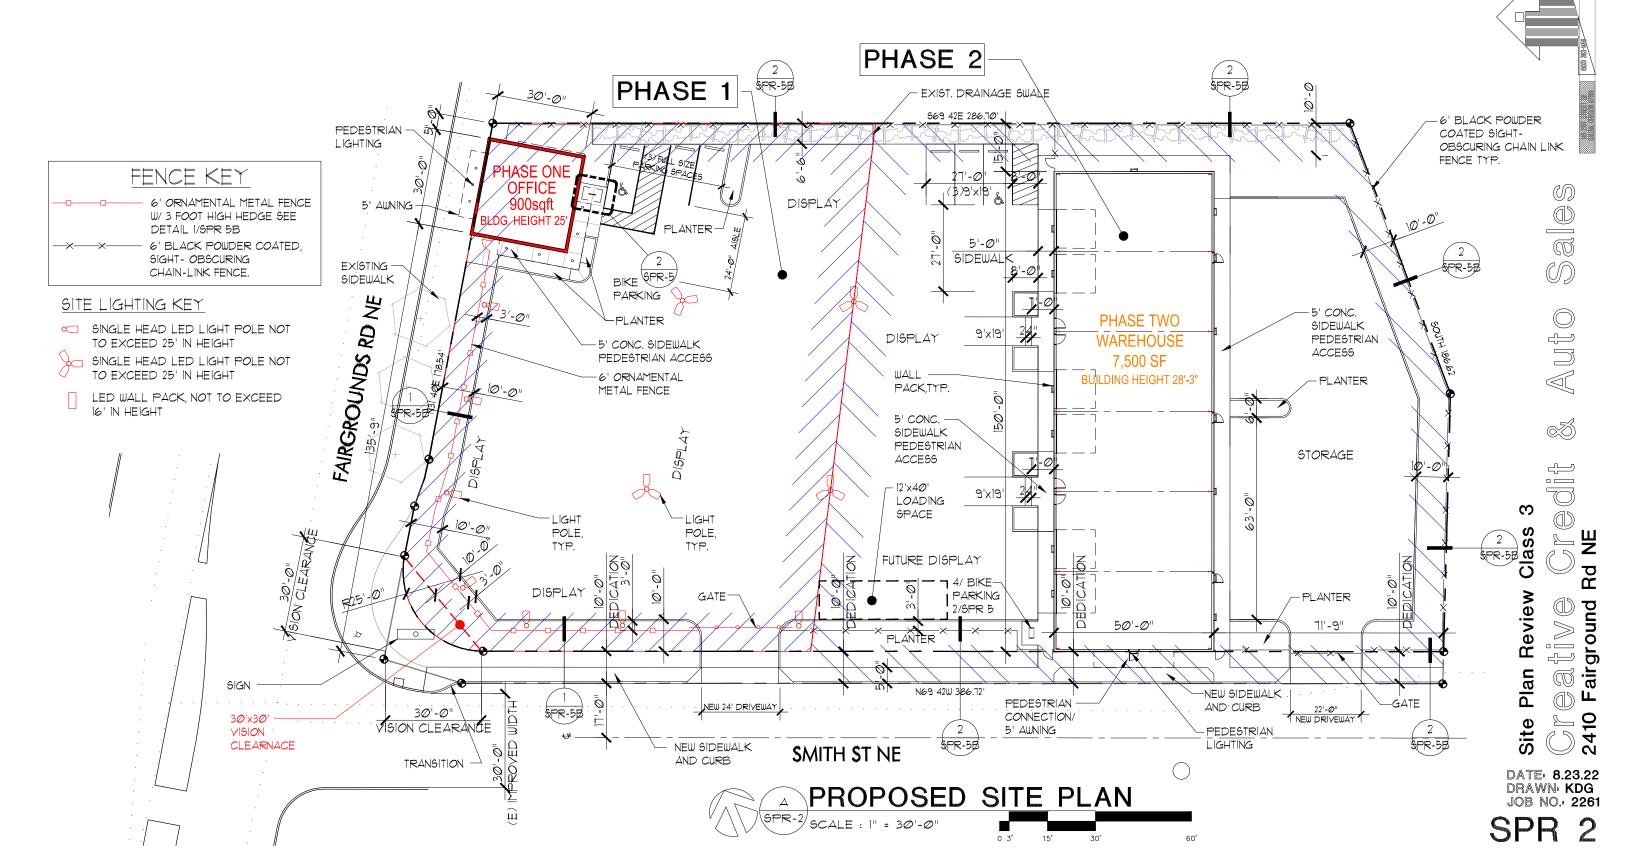


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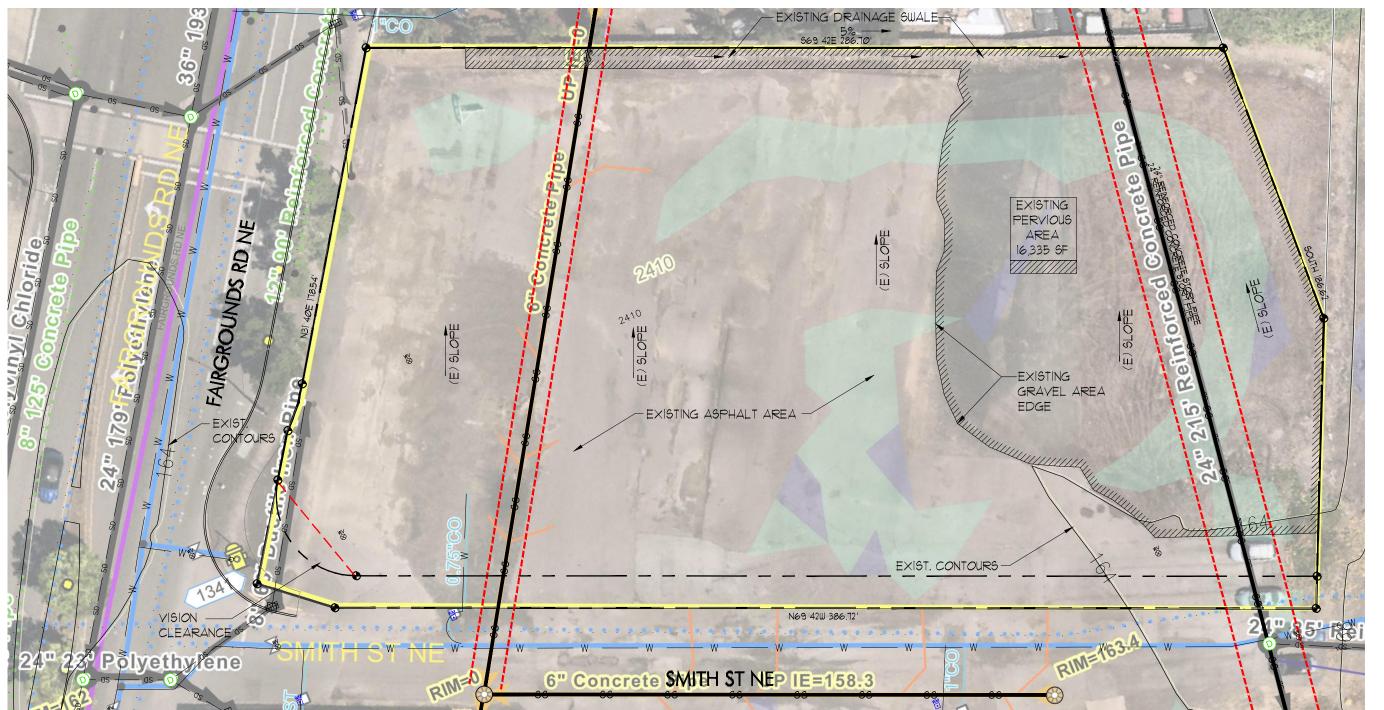
DRAWING INDEX

ENLARGED OFFICE PLAN

STORM WATER MANAGEMENT PLAN

SPR 1 EXISTING SITE PLAN FIRE ACCESS PLAN PROPOSED SITE PLAN SPR 2 A3.1 BUILDING ELEVATIONS BUILDING ELEVATIONS SPR 3 GRADING PLAN A3.2 NOT USED SPR 4 UTILITY PLAN A3,3 SPR 5 DETAILS A3.4 NOT USED SPR 6 PHASE 1 & PHASE 2 LANDSCAPING A3.5 NOT USED COMPLETE LANDSCAPING & DETAILS SITE ENHANCEMENTS PLAN



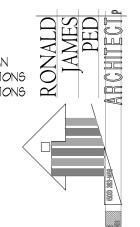



H Rd Plan Review ⊜ative Fairground ∣ **2410** Site


JOB NO. 2261 SPR 1

DATE: 8.23.22 DRAWN: KDG

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SPR 5B



NOTES:

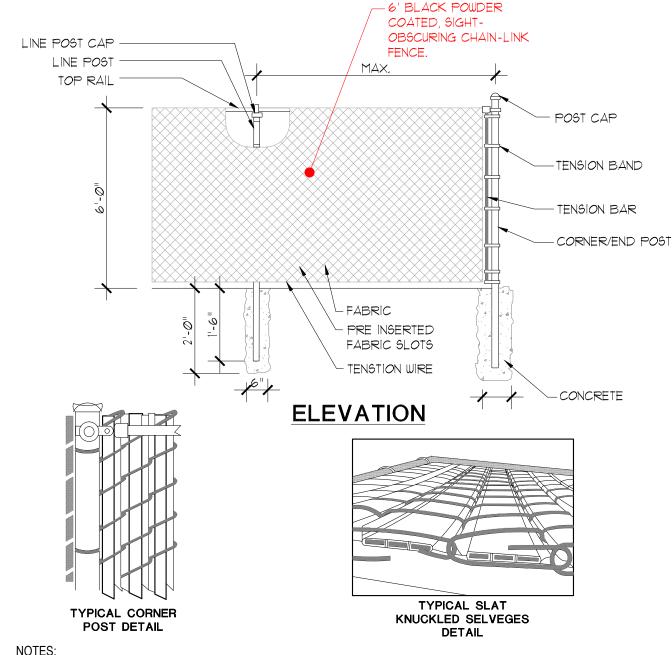- 1. INSTALLATION TO BE COMPLETED IN ACCORDANCE WITH MANUFACTURER'S SPECIFICATIONS.
- 2. DO NOT SCALE DRAWING.
- 3. THIS DRAWING IS INTENDED FOR USE BY ARCHITECTS, ENGINEERS, CONTRACTORS, CONSULTANTS AND DESIGN PROFESSIONALS FOR PLANNING PURPOSES ONLY. THIS DRAWING MAY NOT BE USED FOR CONSTRUCTION.
- 4. ALL INFORMATION CONTAINED HEREIN WAS CURRENT AT THE TIME OF DEVELOPMENT BUT MUST BE REVIEWED AND APPROVED BY THE PRODUCT MANUFACTURER TO BE CONSIDERED ACCURATE.
- 5. CONTRACTOR'S NOTE: FOR PRODUCT AND COMPANY INFORMATION VISIT www.CADdetails.com/info AND ENTER REFERENCE NUMBER 3437-001.



STEEL PICKET a 6" O.C. 6x6 -2×2 STEEL STEEL TOP/BTM COL. TUBE 6x6 STEEL COL. PLAN VIEW 2×2 STEEL 3"x2" ∨ERT TOP/BTM STEEL PICKET **ORNAMENTAL** a 6" O.C. TUBE <u>Metal fence detail</u> SCALE: 1/2"=1'-0'

MTL CAP ਭੂ"x2" ∨ERT




Class Rd NE Plan Review `⊜ative **⊘ [€ 2410**

ARCHITECT

DATE: 8.23.22 DRAWN: KDG JOB NO.: 2261

SPR 9



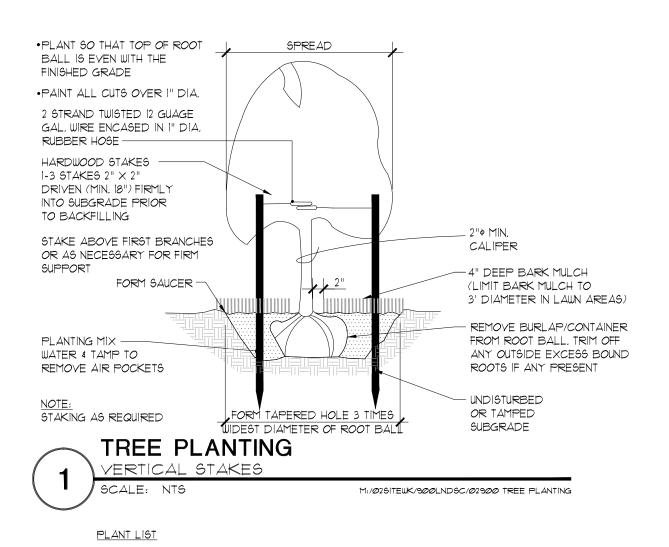

SIZE

7-8'

7-8'

7-8'

7-8'

LARGE

LARGE

MEDIUM

MEDIUM

LARGE

COMMENTS

2" CALIPER

2" CALIPER

2" CALIPER

2" CALIPER

2" CALIPER

10 PU

10 PU

10 PU

10 PU

10 PU

<u>COUNT</u>

STREET TREES COMMON NAME/BOTANICAL NAME

ASH, RAYWOOD

TILIA CORDATA 'HALA'

ARMSTRONG MAPLE,

ACER RUBRUM 'ARMSTRONG'

ACER rumbrum/RED MAPLE October

DOUGLAS FIR / Pseudotsuga menziesii

LINDEN

Glory

FRAXINUS OXYCARPA 'RAYWOOD'

T-ASH

T-LIN

T-MAP

T-MAP

T-DOUG

RED

FIR

ARM

	ORNAMENTAL TREES	COMMON NAME/BOTANICAL NAME	<u>SIZE</u>	<u>COMMENTS</u>
£	T-JAP0	CRYPTOMERIA JAPONICA "ELEGANS"	7-8'	2" MIN CALIPER 5 PU
	Т-ТАМА	CRYPTOMERIA JAPONICA /TAISHO TAMA (TAISHO TAMA JAPANESE CEDAR)	4-6'	2" MIN CALIPER 5 PU
	T-BLA	CRYPTOMERIA JAPONICA /BLACK DRAGON	4-6'	2" MIN CALIPER 5 PU
	T-MAP VINE	VINE MAPLE/ACER circinatum	7-8'	2" MIN CALIPER 2 PU
	T-CRAB	CRABAPPLE/MALUS 'AMERICAN BEAUTY'	7-8'	2 MIN CALIPER 2 PU
	T-CRY	CRYPTOMERIA JAPONICA /GEKKEN-SUGI	6'	2" MIN CALIPER 5 PU
	T-CUP	CUPRESSUS SEMPERVIRENS ITALIAN CYPRESS 'STRICTA'	6'	2" MIN CALIPER 5 PU
	T-CHA	CHAMAECYPARIS OBTUSA HINOKI FALSE CYPRESS 'GRACILIS'	6'	2" MIN CALIPER 5 PU
<u>SIZE</u> 1 gal. 3 g	<u>SHRUBS</u>	COMMON NAME/BOTANICAL NAME	<u>C(</u>	OMMENTS
Θ/\mathbb{Q}	S-HYB.	HYBISCUS/Hybiscus Syriacus ROSE OF SHARON 'MINERVA' 'AZURRI SATIN'	1 PU 1 g	al / 2 PU 3 gal
£ / £	9-STRA.	DEUTZIA x hybridia 'STRAWBERRY FIELD\$'	1 PU 1 g	al / 2 PU 3 gal
	S-ABE	ABELIA grandiflora 'EDWARD GOUCHER' (EVERGREEN)	1 PU 1 g	al / 2 PU 3 gal
	S-VIB.D	VIBURNUM Japonicum (EVERGREEN)	1 PU 1 g	al / 2 PU 3 gal
\otimes/\bigcirc	S-PIE.	PIERIS japonicum LILLY-OF-THE-VALLEY (EVERGREEN/SHAI		al / 2 PU 3 gal
\oplus/\bigcirc	5-AUC	AUCUBA JAPONICA JAPANESE AUCUBA (EVERGREEN/SHADE)	1 PU 1 g	al / 2 PU 3 gal
$\odot/($	S-VIB.	YIBURNUM ELLIPTICUM. COMMON YIBURNUM	1 PU 1 g	al / 2 PU 3 gal
(+)/{-	5-CURR.	RED-FLOWERING CURRANT/Ribes sanguinem	I PU I g	al / 2 PU 3 gal
	GROUND COVE	R BOTANICAL NAME/COMMON NAME	<u>SIZE</u>	<u>COMMENTS</u>
	G-PHL	PHLOX SUBLATA CREEPING PHLOX	1 gal.	24" SPACING 1 PU
	G-VIN	VINCA MAJOR PERIWINKLE	1 gal.	24" SPACING 1 PU
2	PLANT	LIST		

SCALE: N/.A

M:/@25ITEWK/95@PLNTS/@295@ PLANTLIST

ALL DETAILS ARE TO COMPLY WITH THE ACCESSIBLE STANDARDS PUBLISHED BY OREGON DEPT OF TRANSPORTATION (2018)

https://www.oregon.gov/ODOT/Engineering/DOCS_ADA/ADA_Standards-Accessible-Parking.pdf

SIGN MOUNTING POST-MOUNTED SIGNS SHALL BE INSTALLED WITH A VERTICAL CLEARANCE OF 1' (+-3") BETWEEN THE BOTTOM OF THE SIGN TO THE GROUND LINE. IF MORE THAN ONE SIGN IS REQUIRED FOR THE ACCESSIBLE PARKING SPACE, ALL

ACCESSIBLE PARKING SPACES AND ACCESS AISLES SHALL BE LOCATED ON A SURFACE WITH A SLOPE NOT TO EXCEED I UNIT VERTICAL IN 50 UNITS HORIZONTAL (2%) IN ALL DIRECTIONS.

SIGNS SHALL BE MOUNTED ON A SINGLE POST EXCEPT FOR THE "ACCESS AISLE NO PARKING" AND ARROW SIGNS. WHEN SIGNS ARE MOUNTED ON BUILDINGS OR PIERS, A VERTICAL CLEARANCE OF 5' MINIMUM SHALL BE MAINTAINED BETWEEN THE BOTTOM OF THE SIGN AND THE FLOOR OF THE PARKING SPACE.

CURB RAMP OR DROPPED CURB SEE PLAN SIGN 5'-0" MAX RISE R7-8 NO PARKING SIGN SIGN R7-9 R7-8P VAN ACCESSIBLE SIGN R7-8c (If req'd) 1:10 ACCESSIBLE CCESSIBLE % ROUTE Sian CURB RAMP location SHALL NOT EXTEND INTO THE ACCESS WHEEL AISLE STOP TYP. \mathcal{P} LENGHT -4" WIDE ANGLE ORIENTATION LINES TYP FOR FIELD LAYOUT 6' min OREGON) at typ. accessible parking stall - PAVEMENT 8' min. at van accessible PAVEMENT MARKING 9'-0" MIN. MARKING SEE SEE FIG. 7 parking stall FIG. 6 SINGLE-ACCESSIBLE PARKING SPACE

VAN-ACCESSIBLE DESIGNATION REQUIRED

7'-6" 1 1/2" TO 2 1/4" SCHEDULE 40 STEEL PIPE MINIMUM SIZE HARD SURFACE STEEL PIPE 2" X 1" SCHEDULE 40 RECTANGULAR STEEL TUBING MOUNTING RAILS 24" 36" CLR MIN PLAN VIEW - MULTIPLE "U" 1) BIKE RACKS SHALL HAVE A GLOSS BLACK POLYESTER POWDER COAT FINISH WIDTH 2) MOUNTING RAILS SHALL BE FURNISHED WITH MOUNTING HOLES AND VANDAL RESISTENT CONCRETE ANCHOR MOUNTING HARDWARE. 4'-@" ACCESS AISLE 1 3) EACH "U" SHALL BE WELDED OR MOUNTED TO RAILS OR PLATES WITH VANDAL RESISTANT OR HIDDEN FASTENERS. 4) FOR SINGLE "U" INSTALLATION, EACH MOUNTING PLATE WILL BE EQUIPPED WITH TWO ANCHOR BOLT HOLES EACH. 5) Short-term bicycle parking. Short-term bicycle parking shall be located outside a building within a convenient distance of, and clearly visible from, the primary building entrance. In no event shall bicycle parking be located more than 50 feet from the primary building entrance, as measured along a direct pedestrian access

18" SIDE VIEW SINGLE HOOP (2) BIKE SPACES PROVIDED FOR PHASE 1 DOUBLE HOOP PER DETAIL 2/SPR5 (4) BICYCLE PARKING FOR PHASE 2

Plan Review airground 2410 Site

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Class

DATE: 8.23.22 DRAWN: KDG JOB NO. 2261

SPR

BICYCLE PARKING RACK DETAIL

M:/02SITEWK/600PIPNG/02600 BIKE RACI

PER TABLE 806-10

SCALE: 1"=1'-0"

SCALE: 1/8" = 1'-0'

M:/025ITEWK/580PVMRK/02580 HC-SGL

