LAND USE SUBMISSION

08.08.22




CDP SALEM - PHASE 2 BUILDING I

PARCEL 3 & PARCEL 4
BATTLE CREEK SE
SALEM, OR

THESE DRAWINGS ARE THE ORIGINAL UNPUBLISHED WO	OF THE ARCHITECT AND MAY NOT BE DUPLICATED OR US	WITHOUT THE WRITTEN CONSENT OF THE ARCHITECT.
THESE DRAWI	OF THE ARCHI	WITHOUT THE

GENERAL PROJECT NOTES	PROJEC	T TEAM	PROJECT SUM	MMARY	SHEET IND	EX
REFER TO OWNER-CONTRACTOR AGREEMENT FOR GENERAL CONDITIONS. WHERE THERE IS A CONFLICT BETWEEN THE CONTRACT AND NOTES HEREIN, THE CONTRACT TAKES PRECEDENCE.	OWNER	CDP OREGON LLC 126 NE ALBERTA ST #202 PORTLAND, OR 97211	PROJECT DESCRIPTION:	3-STORY WOOD FRAMED MULTIFAMILY BUILDING FEATURING 16 RESIDENTIAL UNITS AND FIRE RISER ROOM.	SHEET#	SHEET NAME
GENERAL CONTRACTOR IS RESPONSIBLE FOR THE FULL SET OF CONSTRUCTION DOCUMENTS, INCLUDING BUT NOT LIMITED TO DRAWINGS, SPECIFICATIONS, AND ADDENDA. THE CONTRACTOR SHALL FIELD VERIFY ALL CONDITIONS AND DIMENSIONS PRIOR TO	CONTRACTOR	TEL: 971.533.7466 FAX: N/A CONTACT: THOMAS ELDRIDGE EMAIL: THOMAS@COMMUNITYDEVPARTNERS.COM	PROJECT ADDRESS:	GROSS AREA: 16,414 SF 5205 BATTLE CREEK ROAD SE SALEM, OR 97306	GENERAL G0.01 G1.01	GENERAL PROJECT INFORMATION CODE SUMMARY
ANY WORK AND SHALL BE RESPONSIBLE FOR ALL WORK AND MATERIALS INCLUDING THOSE FURNISHED BY SUBCONTRACTORS. 3. DIMENSIONS TAKE PRECEDENCE OVER DRAWINGS: DO NOT SCALE DRAWINGS TO DETERMINE ANY LOCATIONS. THE ARCHITECT SHALL BE NOTIFIED OF ANY DISCREPANCY PRIOR TO CONTINUING WITH WORK.	CONTRACTOR	200 SW AIRPORT AVENUE CORVALLIS, OR 97333 TEL: 541.753.2012 FAX: 541.754.6654 CONTACT: RYAN MCALISTER	LEGAL DESCRIPTION: ZONING:	083W14 LOT 300 AND LOT 118 RM-II	ARCHITECTURAL A0.01 A0.10 A0.20	ARCHITECTURAL GENERAL NOTES AND DIAGRAMS GENERAL DIAGRAMS ASSEMBLIES
 GENERAL CONTRACTOR SHALL KEEP THE CONSTRUCTION SITE IN A BROOM CLEAN CONDITION AT ALL TIMES DURING THE PROJECT. THE CONTRACTOR SHALL REPORT TO THE ARCHITECT ANY ERRORS, INCONSISTENCIES OR OMISSIONS HE OR SHE MAY DISCOVER. BRING UNFORSEEN CONDITIONS TO ATTENTION OF ARCHITECT UPON DISCOVERY AT ANY POINT. THE MEANS OF CORRECTING ANY ERROR OR UNFORSEEN CONDITION SHALL FIRST BE APPROVED BY THE ARCHITECT. 	ARCHITECT	EMAIL: RYANM@GERDINGBUILDERS.COM SCOTT EDWARDS ARCHITECTURE, LLP 2525 E. BURNSIDE STREET PORTLAND, OREGON 97214 TEL: 503.226.3617 FAX: 503.226.3715			A2.11 A2.12 A3.01 A3.10	FIRST FLOOR AND SECOND FLOOR PLANS THIRD FLOOR AND ROOF PLAN EXTERIOR ELEVATIONS RENDERINGS
 ALL REQUIRED CITY AND/OR COUNTY LICENSE SHALL BE ACQUIRED AND PAID FOR BY THE INDIVIDUAL TRADE. THE ARCHITECT WILL REVIEW SHOP DRAWINGS AND SAMPLES FOR CONFORMANCE WITH THE DESIGN CONCEPT OF THE PROJECT. THE ARCHITECT'S REVIEW OF A SEPARATE ITEM SHALL NOT INDICATE APPROVAL OF AN ASSEMBLY IN WHICH THE ITEM FUNCTIONS. 	CIVIL ENGINEER	CONTACT: DAVE MOJICA EMAIL: DMOJICA@SEALLP.COM HHPR 530 CENTER ST NE SUITE 240 SALEM, OREGON 97301			A5.01 A7.01	WALL SECTIONS EXTERIOR DETAILS
8. IT SHALL BE THE RESPONSIBILITY OF THE CONTRACTOR TO VERIFY LOCATION OF ALL EXISTING UTILITIES WHETHER SHOWN HEREIN OR NOT AND TO PROTECT THEM FROM DAMAGE. THE CONTRACTOR SHALL BEAR ALL EXPENSES OF REPAIR OR REPLACEMENT OF UTILITIES OR OTHER PROPERTY DAMAGED BY OPERATIONS IN CONJUNCTION WITH THE EXECUTION OF THE WORK. 9. CITY APPROVED PLANS SHALL BE KEPT IN A SECURE PLACE AND SHALL NOT BE USED	LANDSCAPE	TEL: 503.365.1131 FAX: N/A CONTACT: BEAU BRAMAN EMAIL: BEAUB@HHPR.COM	OFDADATE DE			
BY WORKERS. THE CONTRACTOR SHALL BE RESPONSIBLE THAT ALL SUBCONTRACTORS' CONSTRUCTION SETS REFLECT THE SAME INFORMATION. THE CONTRACTOR SHALL ALSO MAINTAIN, IN GOOD CONDITION, ONE COMPLETE SET OF STAMPED CITY APPROVED PLANS WITH ALL REVISIONS, ADDENDUMS, AND CHANGE ORDERS ON THE PREMISES AT ALL TIMES. THESE ARE TO BE UNDER THE CARE OF THE JOB SUPERINTENDENT AND MUST BE MADE AVAILABLE TO BUILDING AND FIRE INSPECTIONS FOR REFERENCE DURING CONSTRUCTION.	ARCHITECT	735 NW 18TH AVENUE PORTLAND, OR 97209 TEL: 503 334 2080 FAX: N/A CONTACT: MAURICIO VILLARREAL EMAIL: MAURICIO.VILLARREAL	CONTRACTOR SHALL PROV	/IDE DESIGN, ENGINEERING, FURNISHING AND INSTALLATION OF A		
 THE CONTRACTOR SHALL BE RESPONSIBLE FOR THE COMPLETE SECURITY OF THE SITE WHILE THE JOB IS IN PROGRESS AND UNTIL JOB COMPLETION. THE CONTRACTOR SHALL TAKE ALL NECESSARY PRECAUTIONS TO ENSURE THE SAFETY OF THE OCCUPANTS AND WORKERS AT ALL TIMES. THE CONTRACTOR IS SOLELY RESPONSIBLE FOR ALL CONSTRUCTION MEANS AND METHODS AND SHALL MAINTAIN THE STRUCTURAL INTEGRITY OF ANY CONSTRUCTION. THE CONTRACTOR SHALL BE RESPONSIBLE FOR AND SHALL REPLACE OR REMEDY ANY 	STRUCTURAL ENGINEER	STONEWOOD STRUCTURAL ENGINEERS, INC 2001 NW 19TH SUITE 103A PORTLAND, OR 97209 TEL: 360.216.1704 FAX: N/A CONTACT: D. SCOTT NYSETH	ARCHITECTURAL DRAWING CODE. THE CONTRACTOR AND FIXTURES TO ENSURE CONTRACTOR SHALL PROV	SYSTEM(S) BASED ON THE SCHEMATIC LAYOUT SHOWN ON THE SS, DESCRIBED HEREIN AND IN COMPLIANCE WITH PREVAILING SHALL BE RESPONSIBLE FOR FINAL ORDERING OF ALL DEVICES PROPER OPTIONS, ACCESSORIES AND CONFIGURATIONS. VIDE COMPLETE DESIGN AND DOCUMENTATION AS REQUIRED FOR ROVAL OF ARCHITECT, OWNER, AND GOVERNING BUILDING		
FAULTY, IMPROPER, OR INFERIOR MATERIALS OR WORKMANSHIP WHICH SHALL APPEAR WITHIN ONE (1) YEAR AFTER THE COMPLETION AND ACCEPTANCE OF THE WORK UNDER THIS CONTRACT. 14. CONTRACTOR TO PROVIDE BACKING OR BLOCKING AS REQUIRED FOR MOUNTING ALL WALL MOUNTED SHELVES, EQUIPMENT, ACCESSORIES, CABINETS, ETC. 15. CONTRACTOR TO PROTECT ALL TREES AND ROOTS NOT SLATED FOR REMOVAL	MEP & FIRE PROTECTION ENGINEER	EMAIL: SCOTT.NYSETH@STONEWOODSTRUCTURAL.COM INTERFACE	CONTRACTOR SHALL BE RE	VIEW BY THE ARCHITECT OR ENGINEER OF RECORD, THE ESPONSIBLE FOR ROUTING DOCUMENTS TO PERMIT AGENCY FOR G ANY PLANS CHECK AND PERMIT FEES.		
DURING CONSTRUCTION. 16. GENERAL CONTRACTOR RESPONSIBLE FOR MAINTENANCE OF STAGING AREA AND TO ENSURE THAT MATERIALS DELIVERY AND STORAGE DOES NOT INTERFERE WITH DAILY OPERATION OF ADJACENT PROPERTIES OR PUBLIC RIGHT OF WAY. 17. GENERAL CONTRACTOR RESPONSIBLE FOR CONSTRUCTION STAKING.		FAX: 503.382.2262 CONTACT: KIM WALL EMAIL: KIMW@INTERFACEENG.COM	1. FIRE SYSTEMS - ALARM 2. FIRE SYSTEMS - SPRINI 3. SIGNAGE DEFERRED SUBMITTALS:			
			 MEP EQUIPMENT BRAC ROOF TRUSSES STOREFRONT, WINDOV SOFFITS AND SUSPEND ROOFTOP ANCHORAGE GUARDRAILS AND HANI 	VS, LOUVERS, AND THEIR CONNECTIONS TO STRUCTURE DED CEILINGS		
			SEE SPECIFICATIONS FOR A BIDDER DESIGN ITEMS.	ADDITIONAL REQUIREMENTS NOT LISTED HERE AND ADDITIONAL		
	VICINITY	MAP				
	KUEF					
		PROJECT SITE				
		NORT	ГН			
	传展社会会					

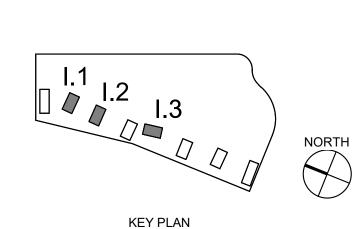





CDP SALEM -PHASE 2 **BUILDING I**

Job Number:

PARCEL 3 & PARCEL 4 BATTLE CREEK SE SALEM, OR



LAND USE SUBMISSION ISSUE

Drawing:

GENERAL PROJECT INFORMATION

08.08.22

2019 OREGON STRUCTURAL SPECIALTY CODE

TYPE V-B, SPRINKLERED PER

CHAPTER 10: MEANS	S OF EGRESS	
SECTION 1004	OCCUPANT LOAD (OL)	SEE OCCUPANT LOAD TABLE
SECTION 1005.3.1	STAIRWAY EGRESS CAPACITY FACTOR	0.3
SECTION 1005.3.2	OTHER EGRESS CAPACITY FACTOR	0.2
TABLE 1006.2.1	MAX OCCUPANT LOAD FOR ONE EXIT MAX COMMON PATH OF EGRESS TRAVEL	20 OCCUPANTS 125 FT
TABLE 1006.3.2	MAX OCCUPANT LOAD PER STORY MIN NUMBER OF EXITS FOR STORY	500 2 *SEE 1003.3 EXCEPTIONS
TABLE 1006.3.3(1)	STORIES WITH ONE EXIT FOR R-2	4 UNITS / 125 FT TRAVEL DISTANCE / UP TO 3 STORIES EMERGENCY ESCAPE AND RESCUE OPENINGS PER 1030 REQUIRED FOR STORIES WITH ONE EXIT
TABLE 1017.2	EXIT ACCESS TRAVEL DISTANCE	250 FT
TABLE 1020.1	CORRIDOR FIRE-RESISTANCE RATING	0.5 HR
TABLE 1020.2	MINIMUM CORRIDOR WIDTH	44 INCHES * 36 INCHES WITHIN DWELLING UNIT OR WHER OCCUPANT LOAD <50
SECTION 1020.4	DEAD ENDS	20 FEET *LENGTH IS NOT LIMITED WHERE LENGTH < 2.5x WIDTH
SECTION 1023.2	INTERIOR EXIT STAIRWAY FIRE- RESISTANCE RATING	1 HR CONNECTING < 4 STORIES

SECTION 1106.2	R-2 OCCUPANCIES WITH ACCESSIBLE, TYPE A C PROVIDED SHALL BE ACCESSIBLE	OR TYPE B UNITS, AT LEAST 2% OF EACH TYPE OF PARKING
	TOTAL SPACES PROVIDED:	43
	ACCESSIBLE SPACES REQUIRED:	43 x 2% = 1
	ACCESSIBLE SPACES PROVIDED:	5
SECTION 1107.6.2.2.1		ELLING UNITS SHALL PROVIDE MINIMUM 2% TYPE A UNITS. AD DETERMINE TOTAL NUMBER OF UNITS AND REQUIRED
	TYPE A UNITS REQUIRED (TOTAL FOR	SITE): 129 x 2% = 3 UNITS
	TYPE A UNITS PROVIDED (TOTAL FOR	•
	TYPE A UNITS PROVIDED (THIS BUILDIN	,
SECTION 1107.6.2.2.2	WHERE THERE ARE FOUR OR MORE DWELLING	UNITS, ALL UNITS SHALL BE TYPE B UNITS AT A MINIMUM
EXCEPTION:	THE NUMBER OF TYPE A AND TYPE B UNITS IS F SECTION 1107.7	PERMITTED TO BE REDUCED IN ACCORDANCE WITH
	1107.7.1.1, STRUCTURES WITHOUT ELE	EVATOR SERVICE, ONE STORY WITH TYPE B UNITS REQUIRE


ADDITIONAL ACCESSIBILITY REQUIREMENTS				
APPLICABLE STANDAR	ine.			
•	ANSI ICC A117.1 - 2009			
2	2010 ADA STANDARDS FOR ACCESSIBLE DESIGN - TI	TLE II		
S	SECTION 504			
F	FAIR HOUSING ACCESSIBILITY GUIDELINES			
	FHA SAFE HARBOR DESIGN DOCUMENT: IBC 2	018		
C	OHCS CORE DEVELOPMENT MANUAL			
	SHOO CORE DEVELOT MENT MANOAL			
ACCESSIBLE UNITS				
5	5% OF UNITS WITH MOBILITY FEATURES	129 x 5% = 7 UNITS		
2	2% OF UNITS WITH COMMUNICATION FEATURES	129 x 2% = 3 UNITS		


OPAQUE ELEMENTS		REQU			PRO	VIDED	
	ASSEMBL	Y MAX.	MIN. R-VA	MIN. R-VALUE			
ROOFS			T		_		
INSULATION ENTIRELY ABOVE DECK	N	I/A	N/A				
METAL BUILDINGS	N	I/A	N/A				
ATTIC AND OTHER	U-0	.021	R-49		R	R-49	
WALLS (ABOVE GRADE)							
MASS	U-0	.104	R-11.4 (CI	R-1	1.4 CI	
METAL BUILDINGS	N	I/A	N/A				
STEEL-FRAMED	N	I/A	N/A				
WOOD-FRAMED / OTHER	U-0	.064	R-20		R	-23	
WALLS (BELOW GRADE)	C-0	.119	R-10 C	R-10 CI			
FLOORS							
MASS	N	N/A N/A					
STEEL JOIST	N/A		N/A				
WOOD FRAMED / OTHER	U-0.033		R-30		R-30		
SLAB-ON-GRADE FLOORS							
HEATED	N/A		N/A				
UNHEATED	F-0.520		R-15 FOR 24"		R-15		
OPAQUE DOORS							
SWINGING	U-0.37				-0.	.37	
NON-SWINGING							
FENESTRATION		REQUIRED			PROVIDED		
	MAX U	MAX SHGC	MIN VTI/SHGC	MAX U	MAX SHGC	MIN VTI/SHGC	
VERTICAL (0% - 40% OF WALL ALLOWE	ED)	•			1	•	
FIXED	0.36	0.36	1.10	0.36	0.36	1.10	
OPERABLE	0.45	0.33	1.10	0.45	0.33	1.10	
ENTRANCE DOOR	0.63	0.33	1.10	0.63	0.33	1.10	
SKYLIGHT (0% - 3% OF ROOF ALLOWE	D)						
CI = CONTINUOUS INSULATION FC = FILLED CAVITY NR = NO REQUIREMENT NA = NOT APPLICABLE							

CHAPTER 29: PLUM	BING FIXTURES	
	TOTAL UNITS	
R-2	16	1 WC / LAV / Tub or Shower per unit required and provided


EXIT ACCESS TRAVEL DISTANCE			
EGRESS PATH NAME	EGRESS PATH LENGTH		
FIRST FLOOR	24' - 11"		
SECOND FLOOR	86' - 1"		
THIRD FLOOR	134' - 1"		

	LIFE SAFET	Y OCCUPANT LOAD S	SCHEDULE	
		TABLE 10	04.1.2	
		FUNCTION OF	OCCUPANT	OCCUPANT
AREA NAME	AREA (SF)	SPACE	LOAD FACTOR	LOAD
FIRST FLOOR	5292 SF	Residential	200	27
SECOND FLOOR	5291 SF	Residential	200	27
THIRD FLOOR	5308 SF	Residential	200	27

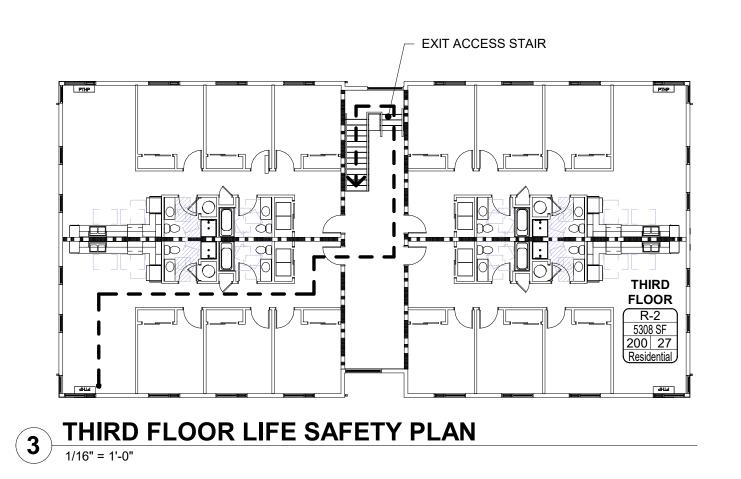


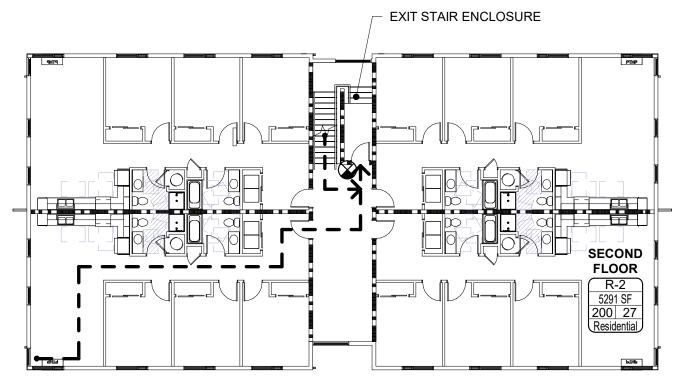



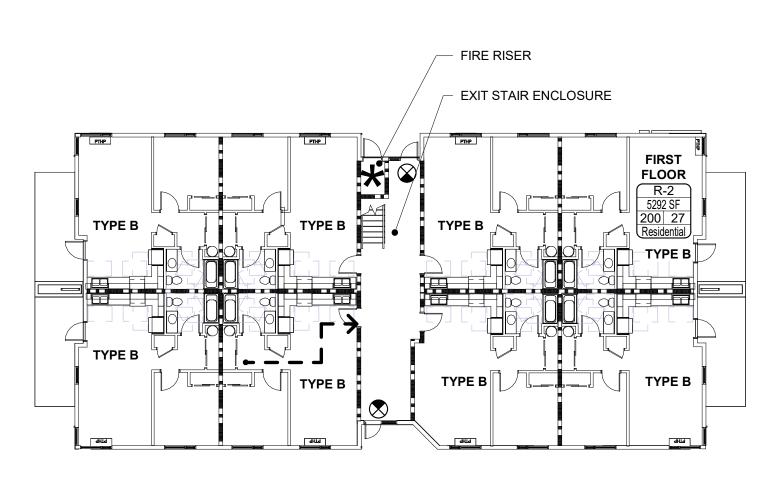

FIRST FLOOR LIFE SAFETY PLAN

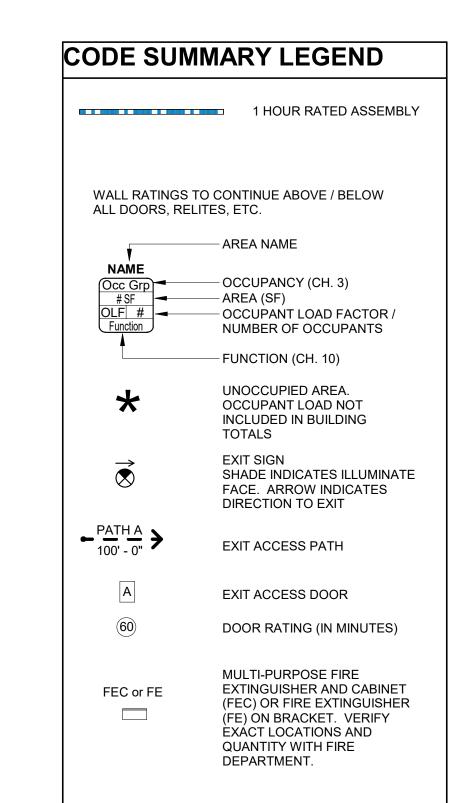






SITE PLAN - ZONING DIAGRAM

PROPERTY LINE

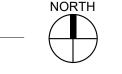

702.020 MULTIPLE FAMILY DESIGN REVIEW STANDARDS

CITY OF SALEM UNIFIED DEVELOPMENT CODE - TITLE X

SECTION	REQUIREMENT MET OR ADJUSTMENT REQUESTED	SHEET NUMBER
SITE SAFETY & SEC	CURITY	
702.020.c.1	REQUIREMENT MET	A2.11-A2.12
702.020.c.2	REQUIREMENT MET	A3.01
FACADE & BUILDIN	G DESIGN	
702.020.e.1	REQUIREMENT MET	A2.11-A2.12
702.020.e.8	REQUIREMENT MET	A3.01
702.020.e.9	ADJUSTMENT REQUESTED	A3.01
702.020.e.10	REQUIREMENT MET	A3.01

CDP SALEM -PHASE 2 **BUILDING I Job Number:** PARCEL 3 & PARCEL 4

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BATTLE CREEK SE SALEM, OR




LAND USE SUBMISSION ISSUE Drawing:

08.08.22


DATE

CODE SUMMARY

Sheet No:

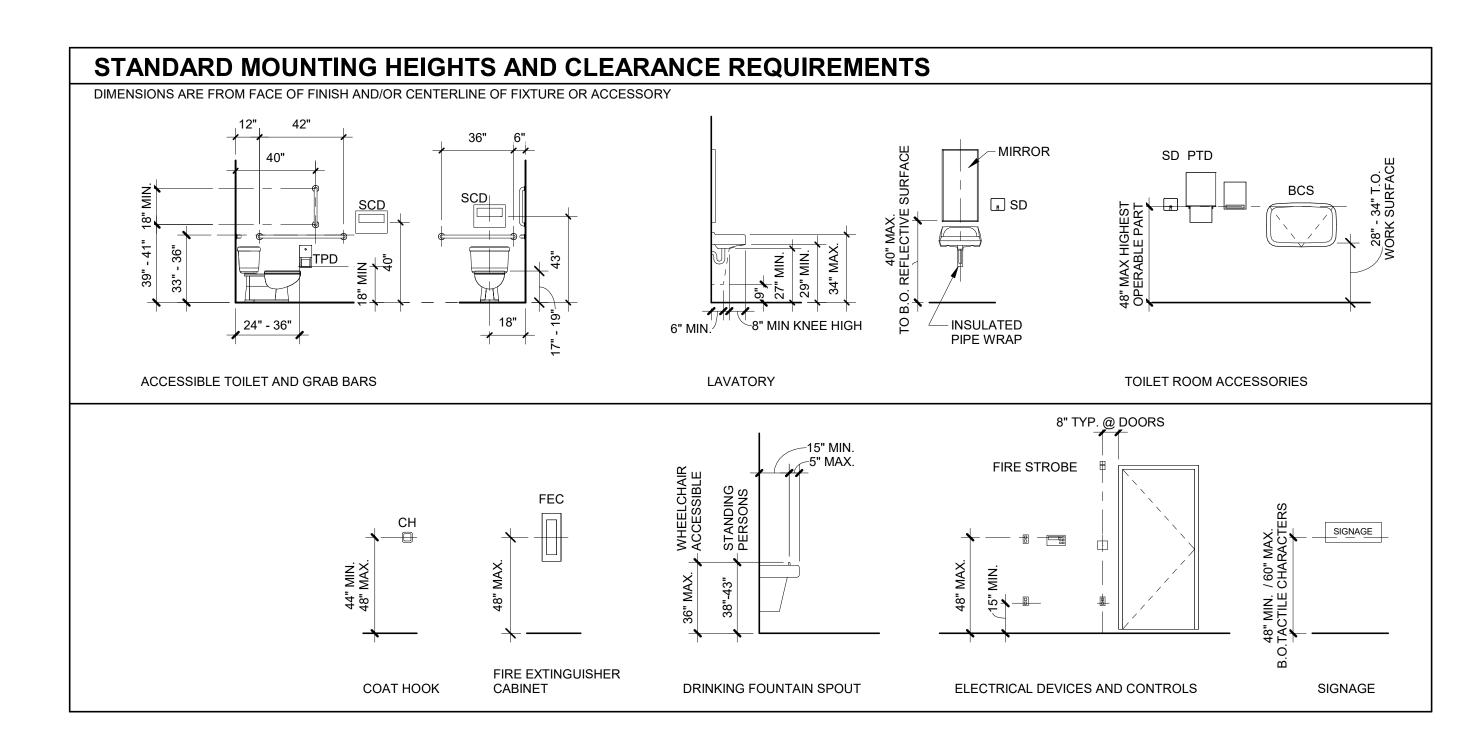

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CDP SALEM -PHASE 2 **BUILDING I Job Number:**

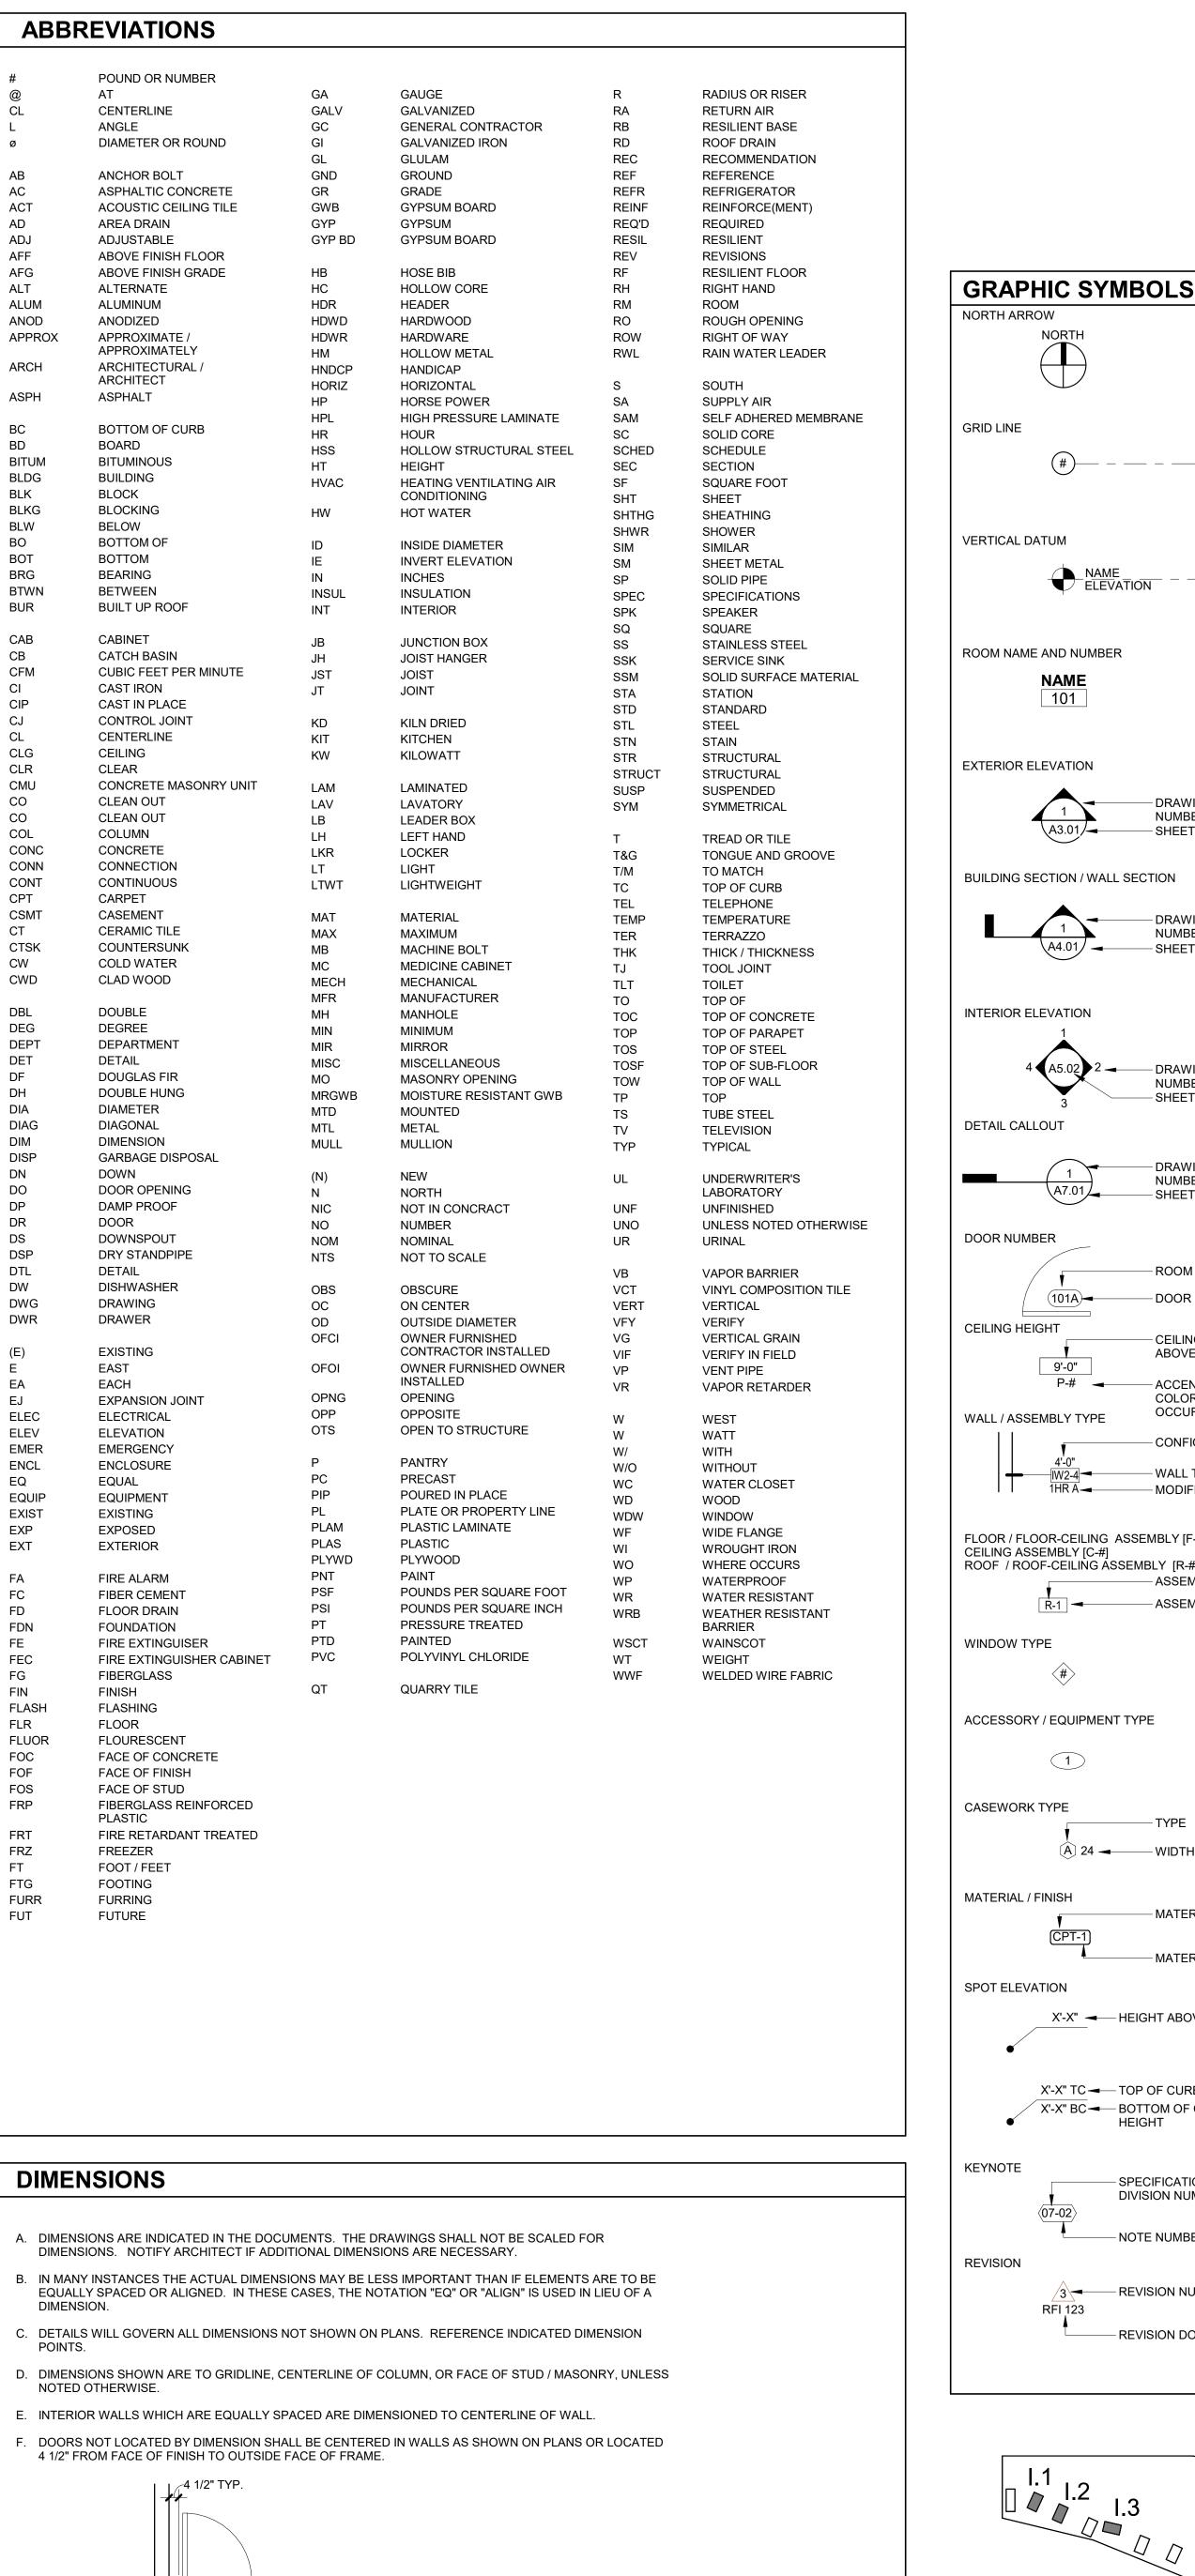PARCEL 3 & PARCEL 4 **BATTLE CREEK SE** SALEM, OR

ROOM NAME AND NUMBER

(#)-----

NAME_ ELEVATION - -

101 **EXTERIOR ELEVATION**

— SHEET NUMBER BUILDING SECTION / WALL SECTION

- DRAWING

NUMBER

NUMBER

2 → DRAWING

NUMBER

DRAWING

A4.01/ ← SHEET NUMBER INTERIOR ELEVATION

SHEET NUMBER DETAIL CALLOUT - DRAWING NUMBER

- SHEET NUMBER DOOR NUMBER - ROOM NUMBER

- DOOR **CEILING HEIGHT** - CEILING HEIGHT ABOVE LEVEL 9'-0" - ACCENT PAINT **COLOR WHERE** OCCURS WALL / ASSEMBLY TYPE

- CONFIGURATION ----- WALL TYPE 1HR A ← MODIFIERS

FLOOR / FLOOR-CEILING ASSEMBLY [F-#] CEILING ASSEMBLY [C-#] ROOF / ROOF-CEILING ASSEMBLY [R-#] - ASSEMBLY CATEGORY - ASSEMBLY NUMBER

WINDOW TYPE

ACCESSORY / EQUIPMENT TYPE **CASEWORK TYPE**


(A) 24 → WIDTH MATERIAL / FINISH

- MATERIAL TYPE - MATERIAL NUMBER SPOT ELEVATION

X'-X" TC ─ TOP OF CURB HEIGHT X'-X" BC ■ BOTTOM OF CURB

KEYNOTE - SPECIFICATION **DIVISION NUMBER** - NOTE NUMBER REVISION

√3 ← REVISION NUMBER - REVISION DOCUMENT

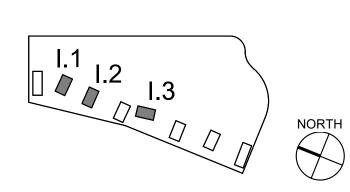



LAND USE 08.08.22 SUBMISSION ISSUE DATE Drawing:

ARCHITECTURAL **GENERAL NOTES AND DIAGRAMS**

Sheet No:



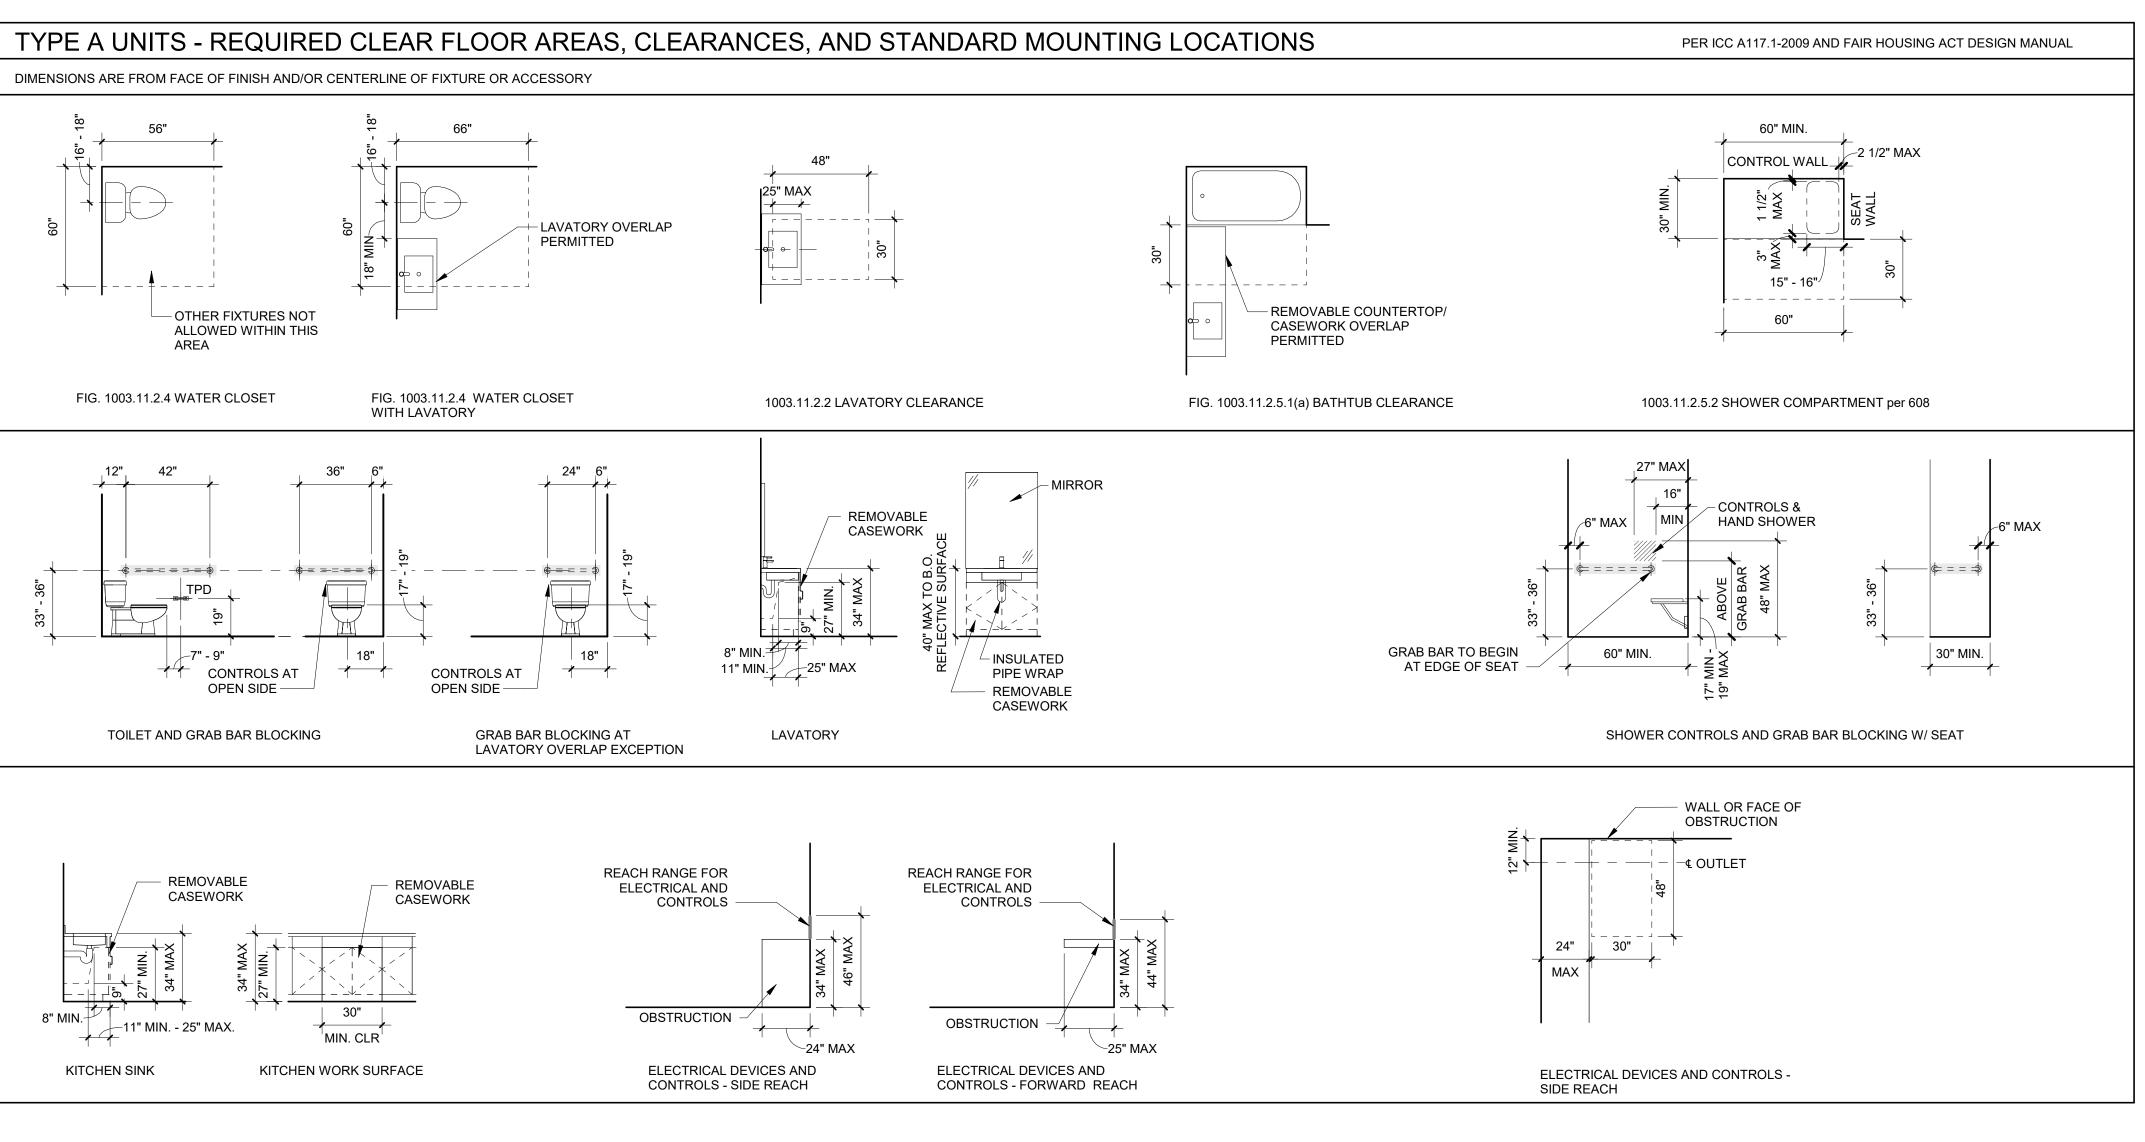

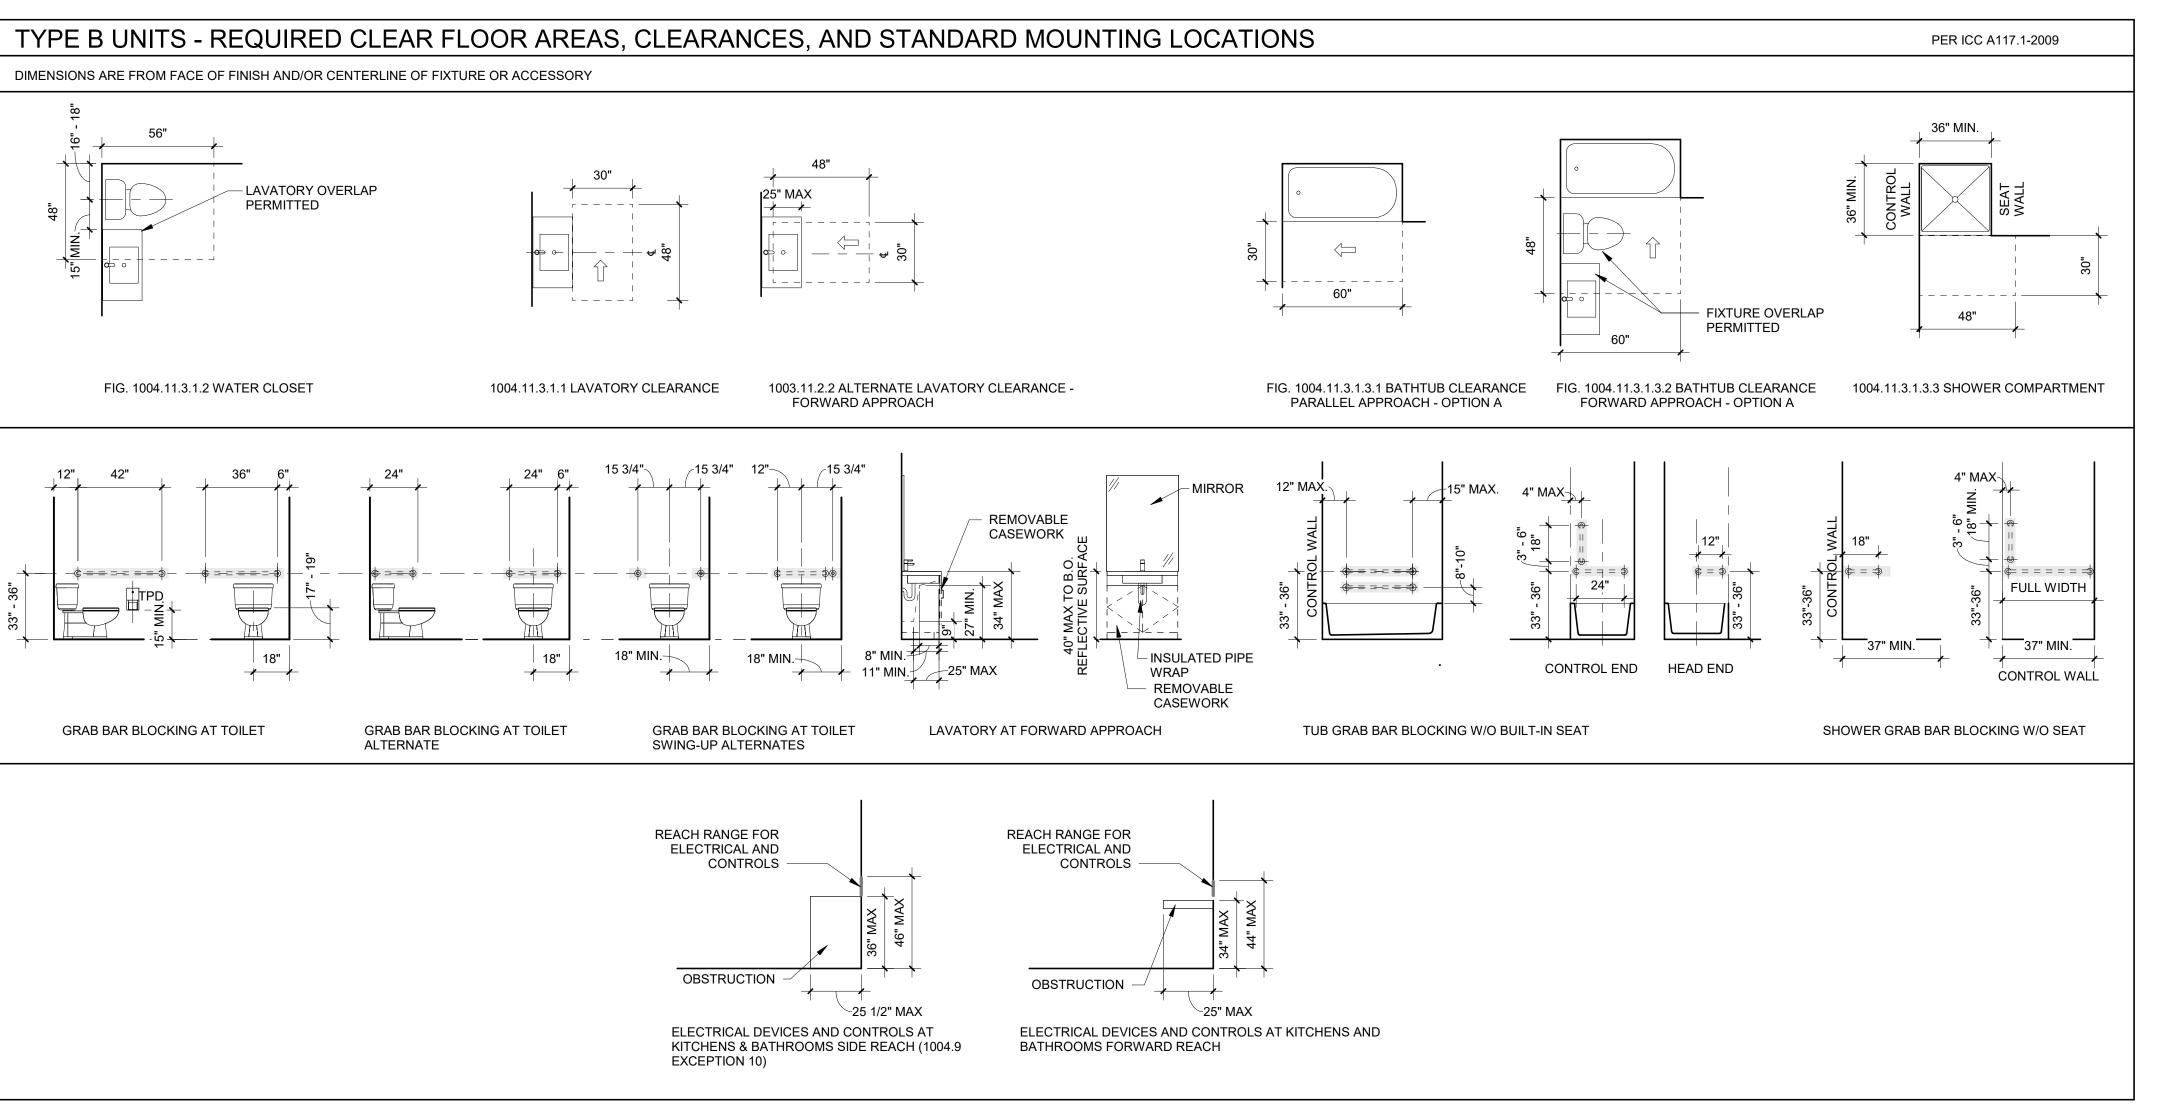



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CDP SALEM -PHASE 2 **BUILDING I**

Job Number: PARCEL 3 & PARCEL 4 **BATTLE CREEK SE** SALEM, OR




LAND USE SUBMISSION


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GENERAL DIAGRAMS

08.08.22



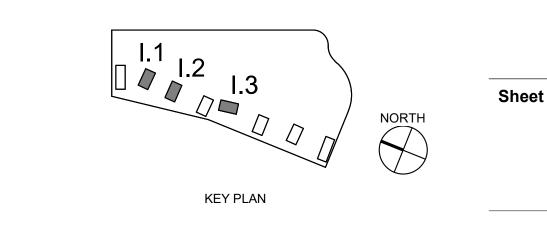



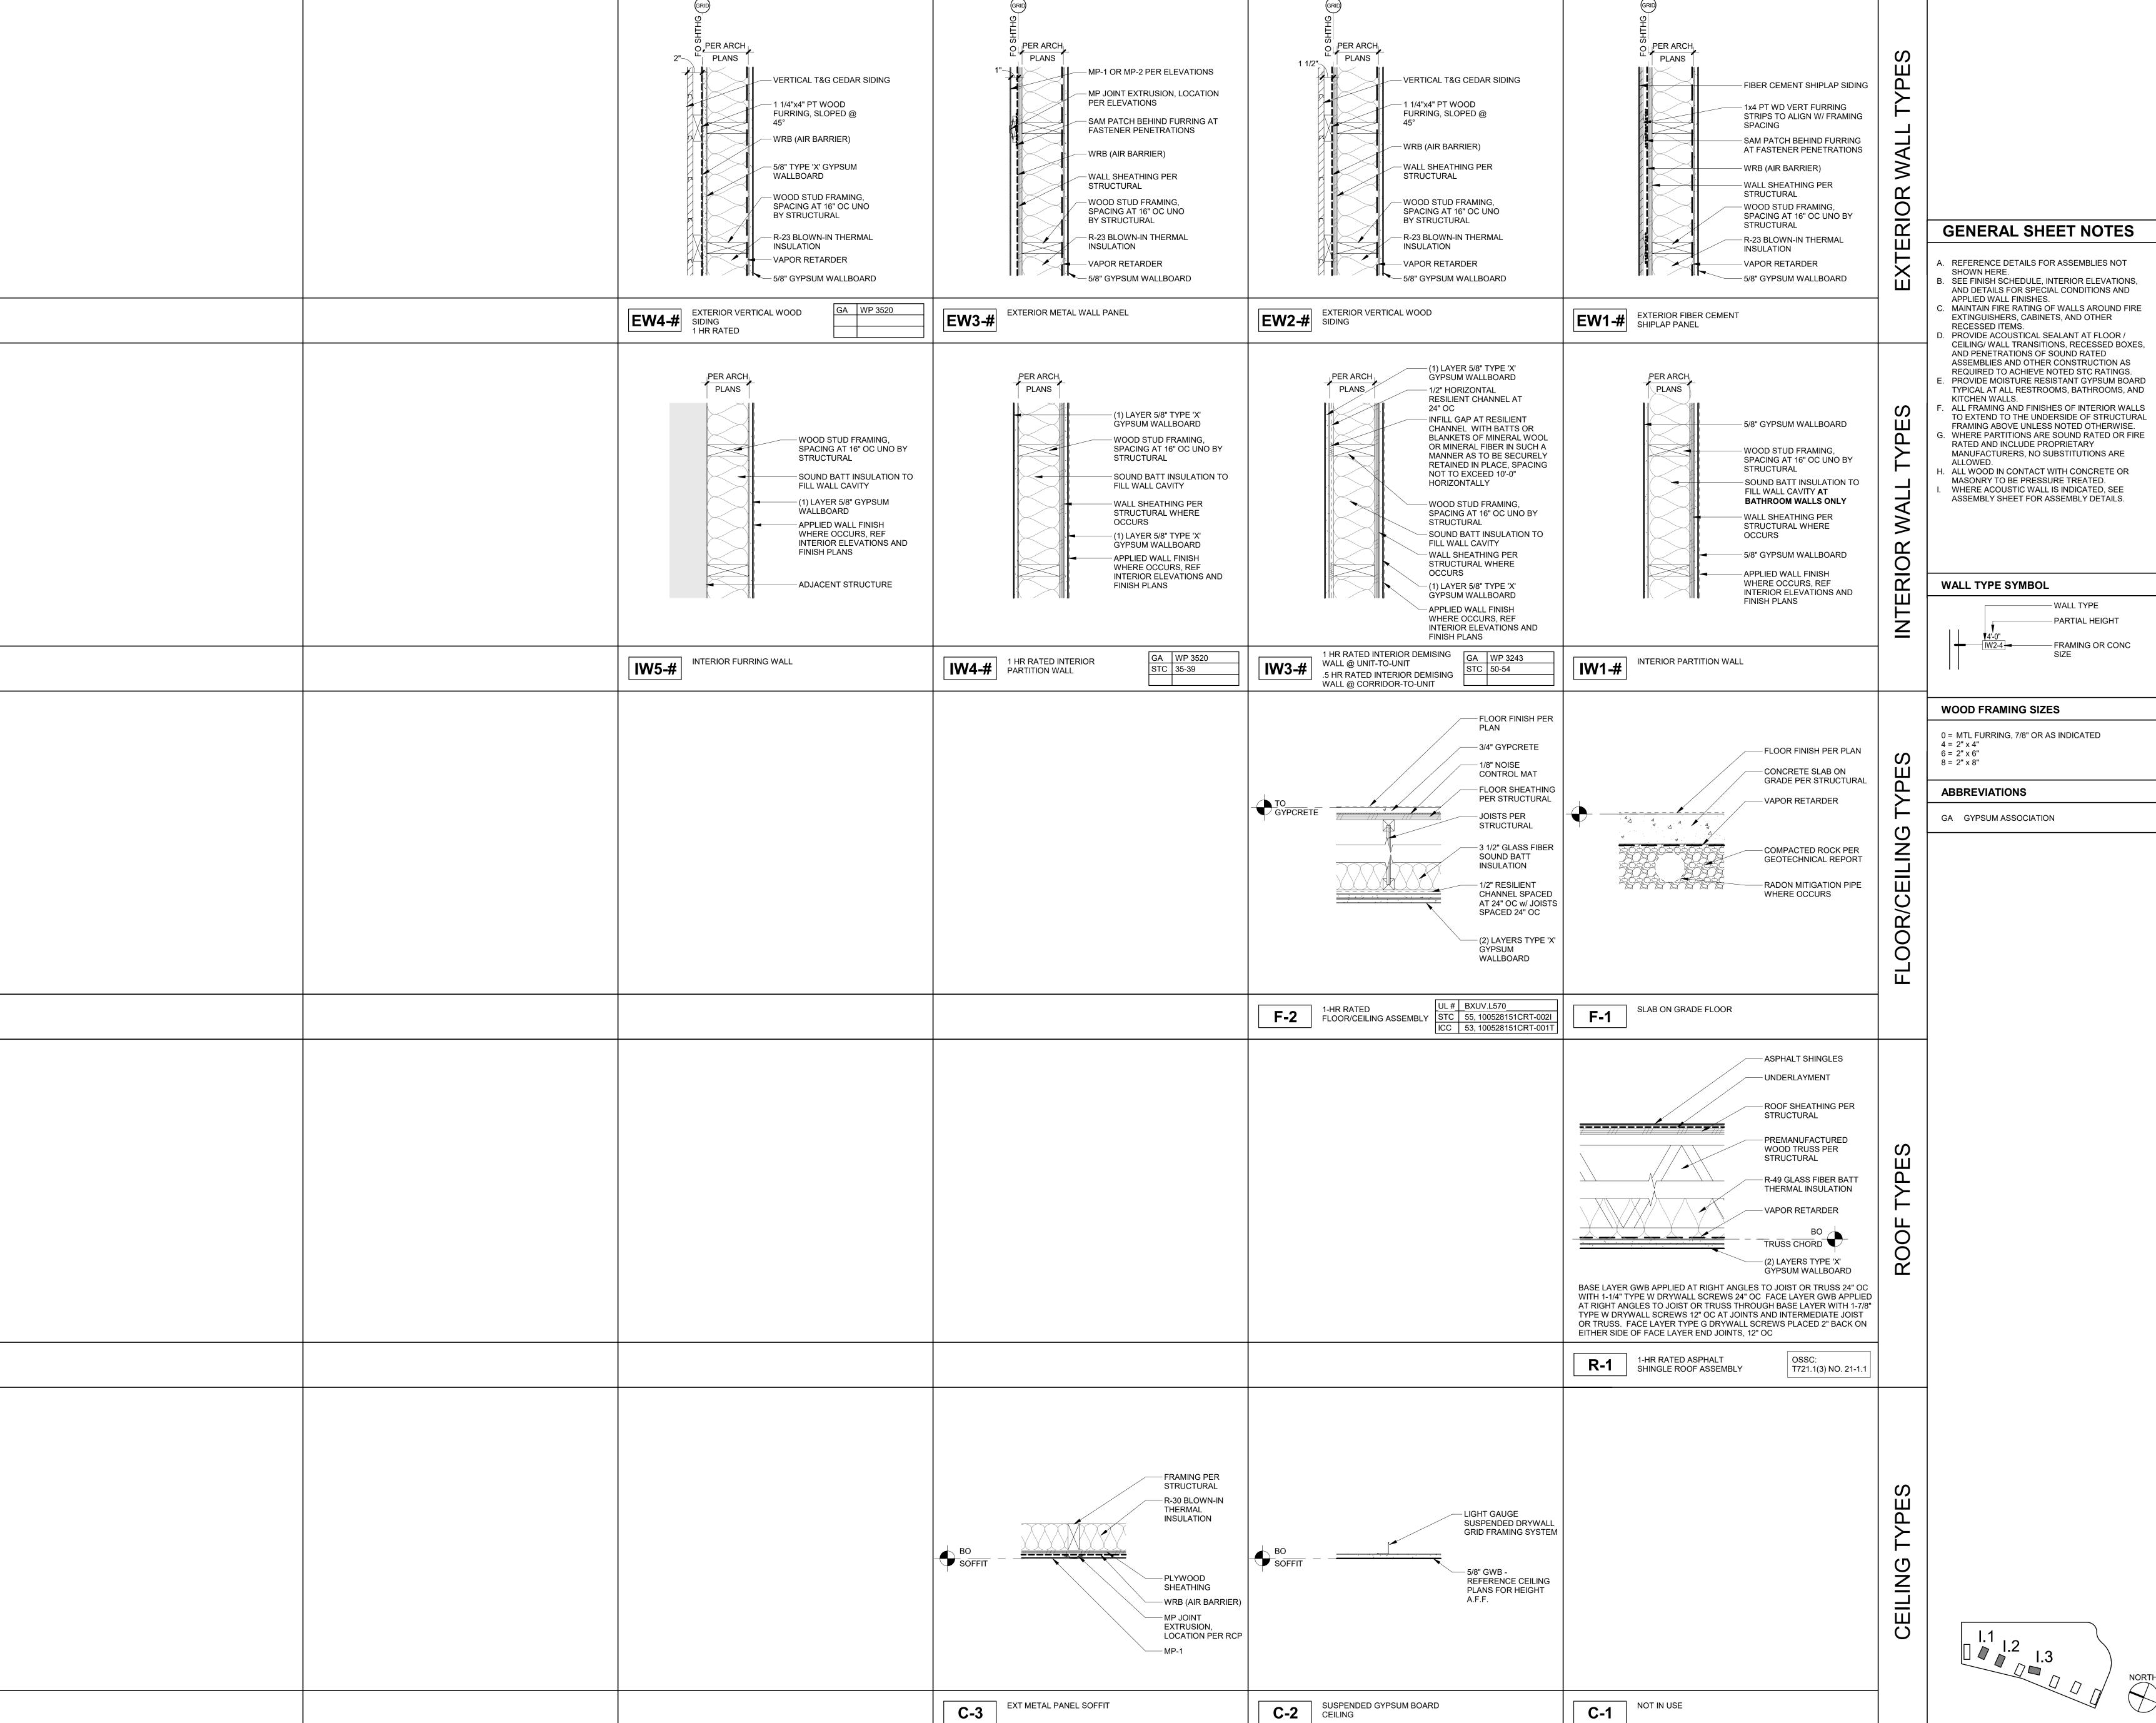

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CDP SALEM -PHASE 2

Job Number: PARCEL 3 & PARCEL 4 **BATTLE CREEK SE** SALEM, OR

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CDP SALEM -

PHASE 2

Job Number:

SALEM, OR

BUILDING I

PARCEL 3 & PARCEL 4

BATTLE CREEK SE

GENERAL SHEET NOTES

- A. WALL DIMENSIONS ARE FROM FACE OF STUD OR CL OF COLUMN UNO
- TO FACE OF STUD UNO C. ALL DOOR AND WINDOW DIMENSIONS ARE TO CL OF OVERALL UNIT. REFERENCE SCHEDULES AND
- WIRE SHELVING IN ALL BEDROOM CLOSETS . MEP INFORMATION PROVIDED FOR REFERENCE
- ALL GROUND FLOOR UNIT RESTROOMS WHERE GRAB BARS ARE NOT SHOWN IN PLAN, REF ACCESSIBILITY DIAGRAMS FOR LOCATIONS H. FIRE EXTINGUISHER TO BE PLACED UNDER SINK IN
- DOWNSPOUTS PAINTED IN FIELD, RECTANGLE

B. ALL EXTERIOR GRID LINES SHOWN ARE TO FACE OF SHEATHING UNO ALL INTERIOR GRID LINES ARE


DOOR AND WINDOW TYPES


D. REFERENCE STRUCTURAL DRAWINGS FOR GENERAL CONTROL JOINTS @ SLAB. COORDINATE FINAL LOCATIONS WITH ARCHITECT FOR COMPATIBILITY WITH FLOOR FINISHES

- ONLY, SEE MEP DRAWINGS G. PROVIDE BLOCKING FOR FUTURE GRAB BARS AT
- ALL UNITS. SEE CODE DIAGRAMS FOR COMMON
- SHAPE AND SIZE PER PLUMBING AND CIVIL J. UNIT DEMISING WALLS TYPE IW3-6, UNO K. UNIT INTERIOR WALLS TYPE IW1-4 UNO

Development

Partners

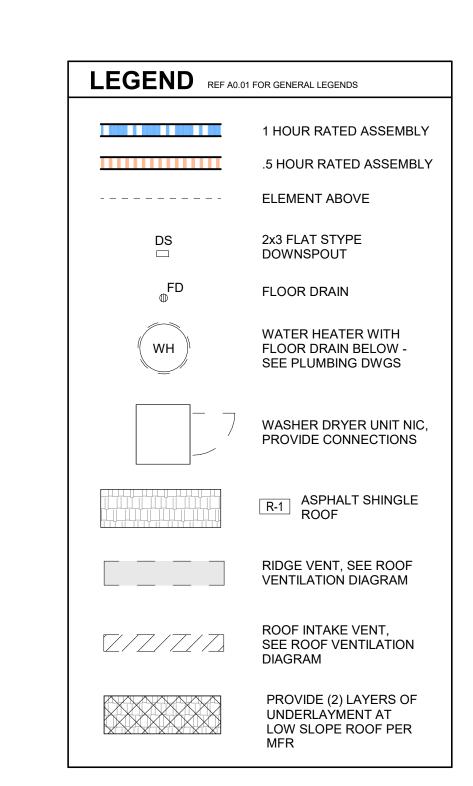

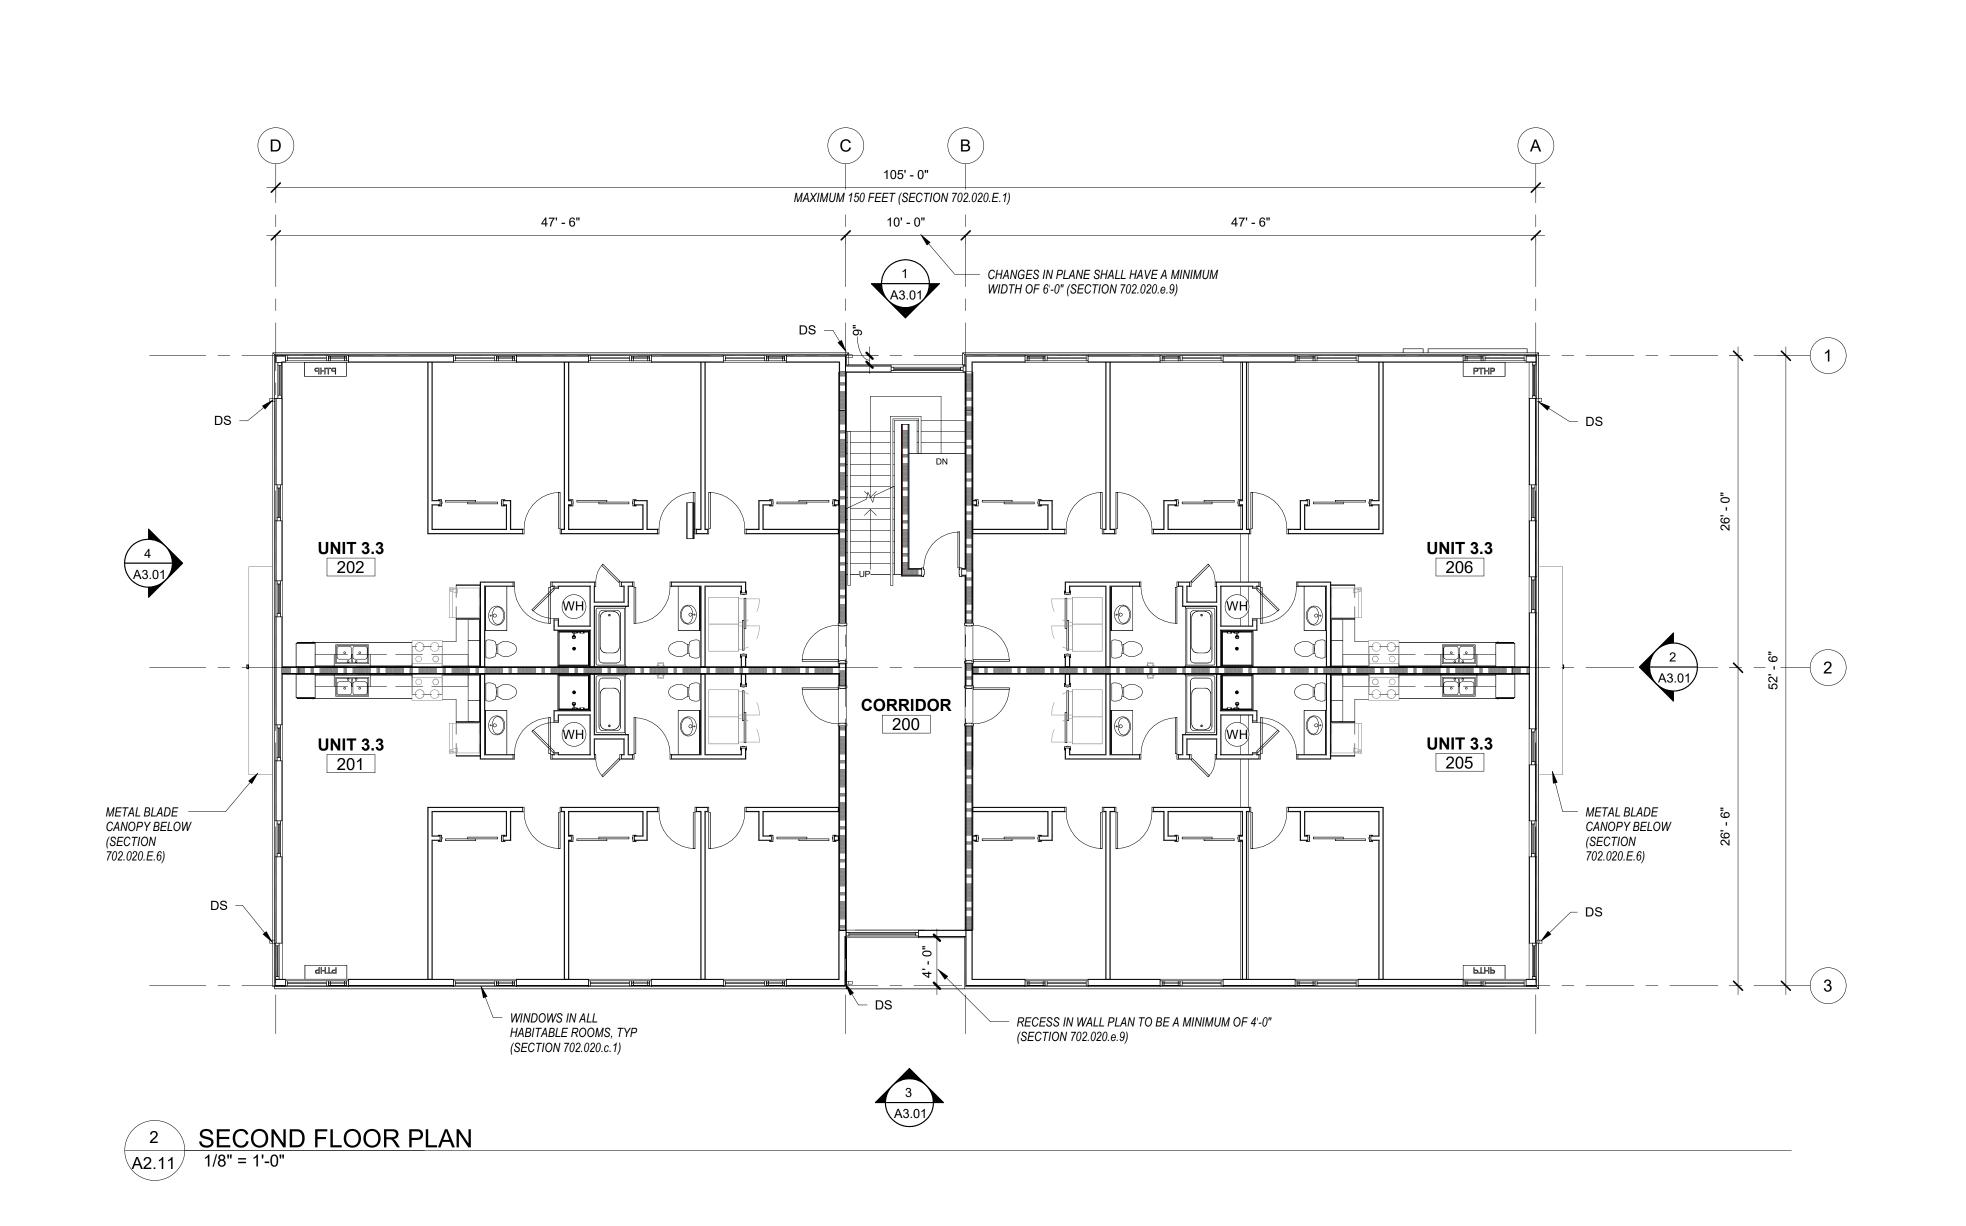

105' - 0" MAXIMUM 150 FEET (SECTION 702.020.E.1)

10' - 0"

STAIR

47' - 6"

CHANGES IN PLANE SHALL HAVE A MINIMUM

WIDTH OF 6'-0" (SECTION 702.020.e.9)

PTHP

UNIT 1.1

106

105

RECESS IN WALL PLAN TO BE A MINIMUM OF 4'-0"

(SECTION 702.020.e.9)

- WALL-MOUNTED

ELECTRICAL EQUIPMENT

- METAL BLADE

CANOPY ABOVE (SECTION 702.020.E.6)

47' - 6"

- WINDOWS IN ALL HABITABLE ROOMS, TYP

(SECTION 702.020.c.1)

PTHP

UNIT 1.3

UNIT 1.3

1 FIRST FLOOR PLAN
A2.11 1/8" = 1'-0"

METAL BLADE CANOPY ABOVE (SECTION 702.020.E.6)

RECESS IN WALL PLAN TO BE A

PTHP

UNIT 1.1

dHLd

MINIMUM OF 4'-0"


(SECTION 702.020.e.9)


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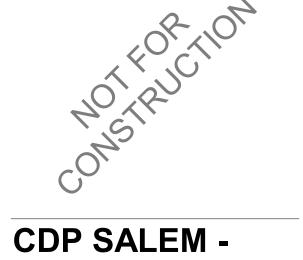
FIRST FLOOR AND SECOND FLOOR **PLANS**

08.08.22





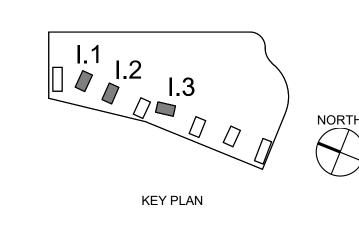

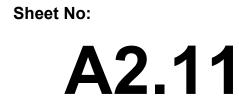

PHASE 2

Job Number:

SALEM, OR

BUILDING I

PARCEL 3 & PARCEL 4

BATTLE CREEK SE


GENERAL SHEET NOTES

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- ALL UNITS. SEE CODE DIAGRAMS FOR COMMON
- DOWNSPOUTS PAINTED IN FIELD, RECTANGLE SHAPE AND SIZE PER PLUMBING AND CIVIL . UNIT DEMISING WALLS TYPE IW3-6, UNO

K. UNIT INTERIOR WALLS TYPE IW1-4 UNO

- GRAB BARS ARE NOT SHOWN IN PLAN, REF ACCESSIBILITY DIAGRAMS FOR LOCATIONS H. FIRE EXTINGUISHER TO BE PLACED UNDER SINK IN
 - Partners

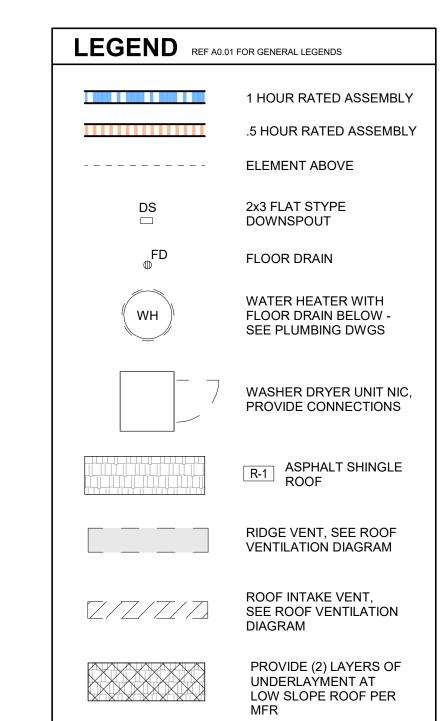



LAND USE SUBMISSION ISSUE

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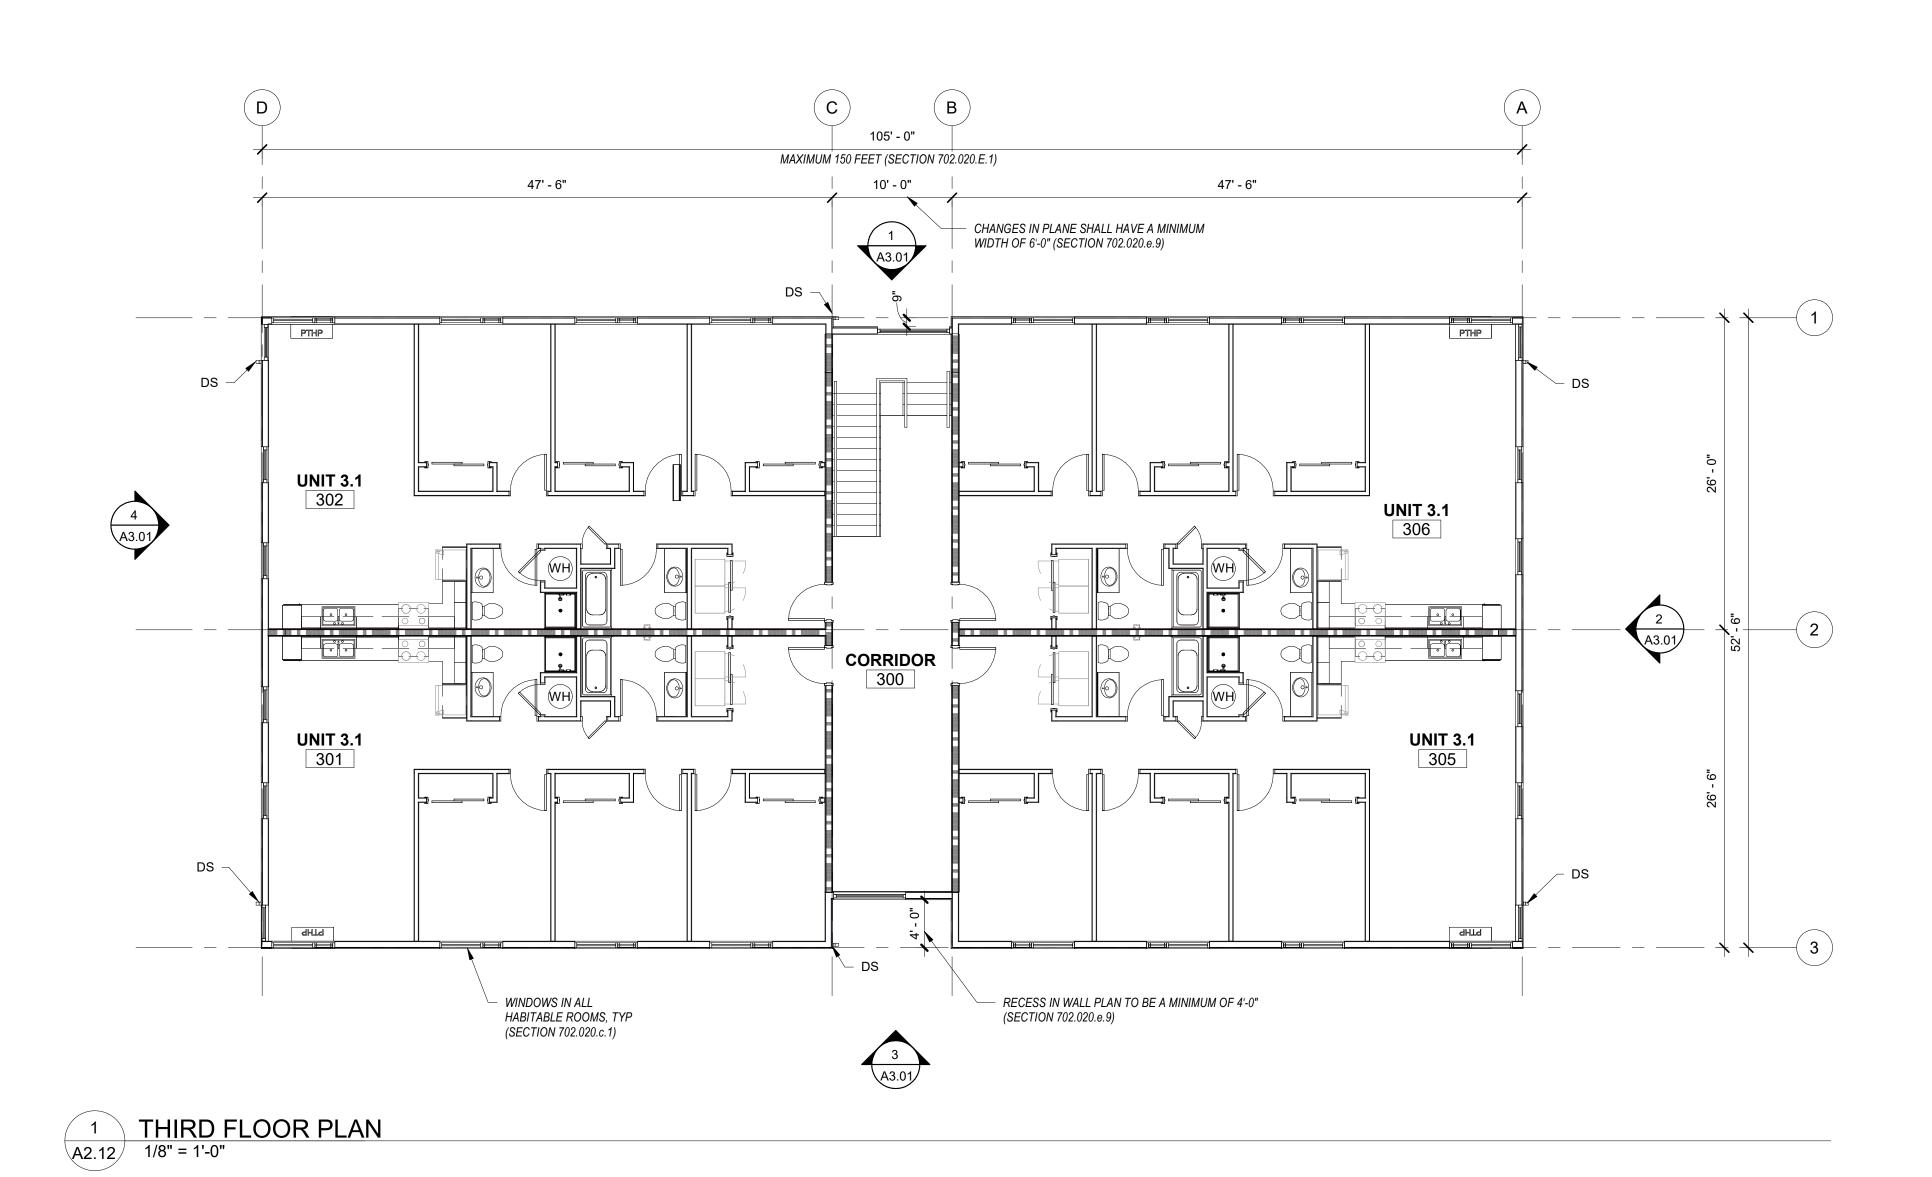
THIRD FLOOR AND ROOF PLAN


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(C) HORIZONTALLY-

DISTINGUISHING TRANSITION -

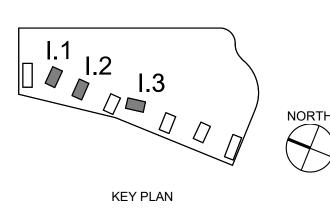PIECE (SECTION 702.020.e.9)

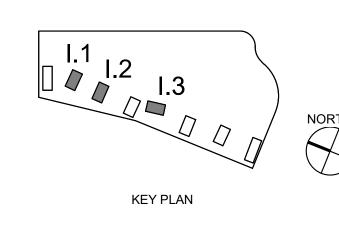PATIO PER — LANDSCAPE

WALL-MOUNTED ELECTRICAL EQUIPMENT

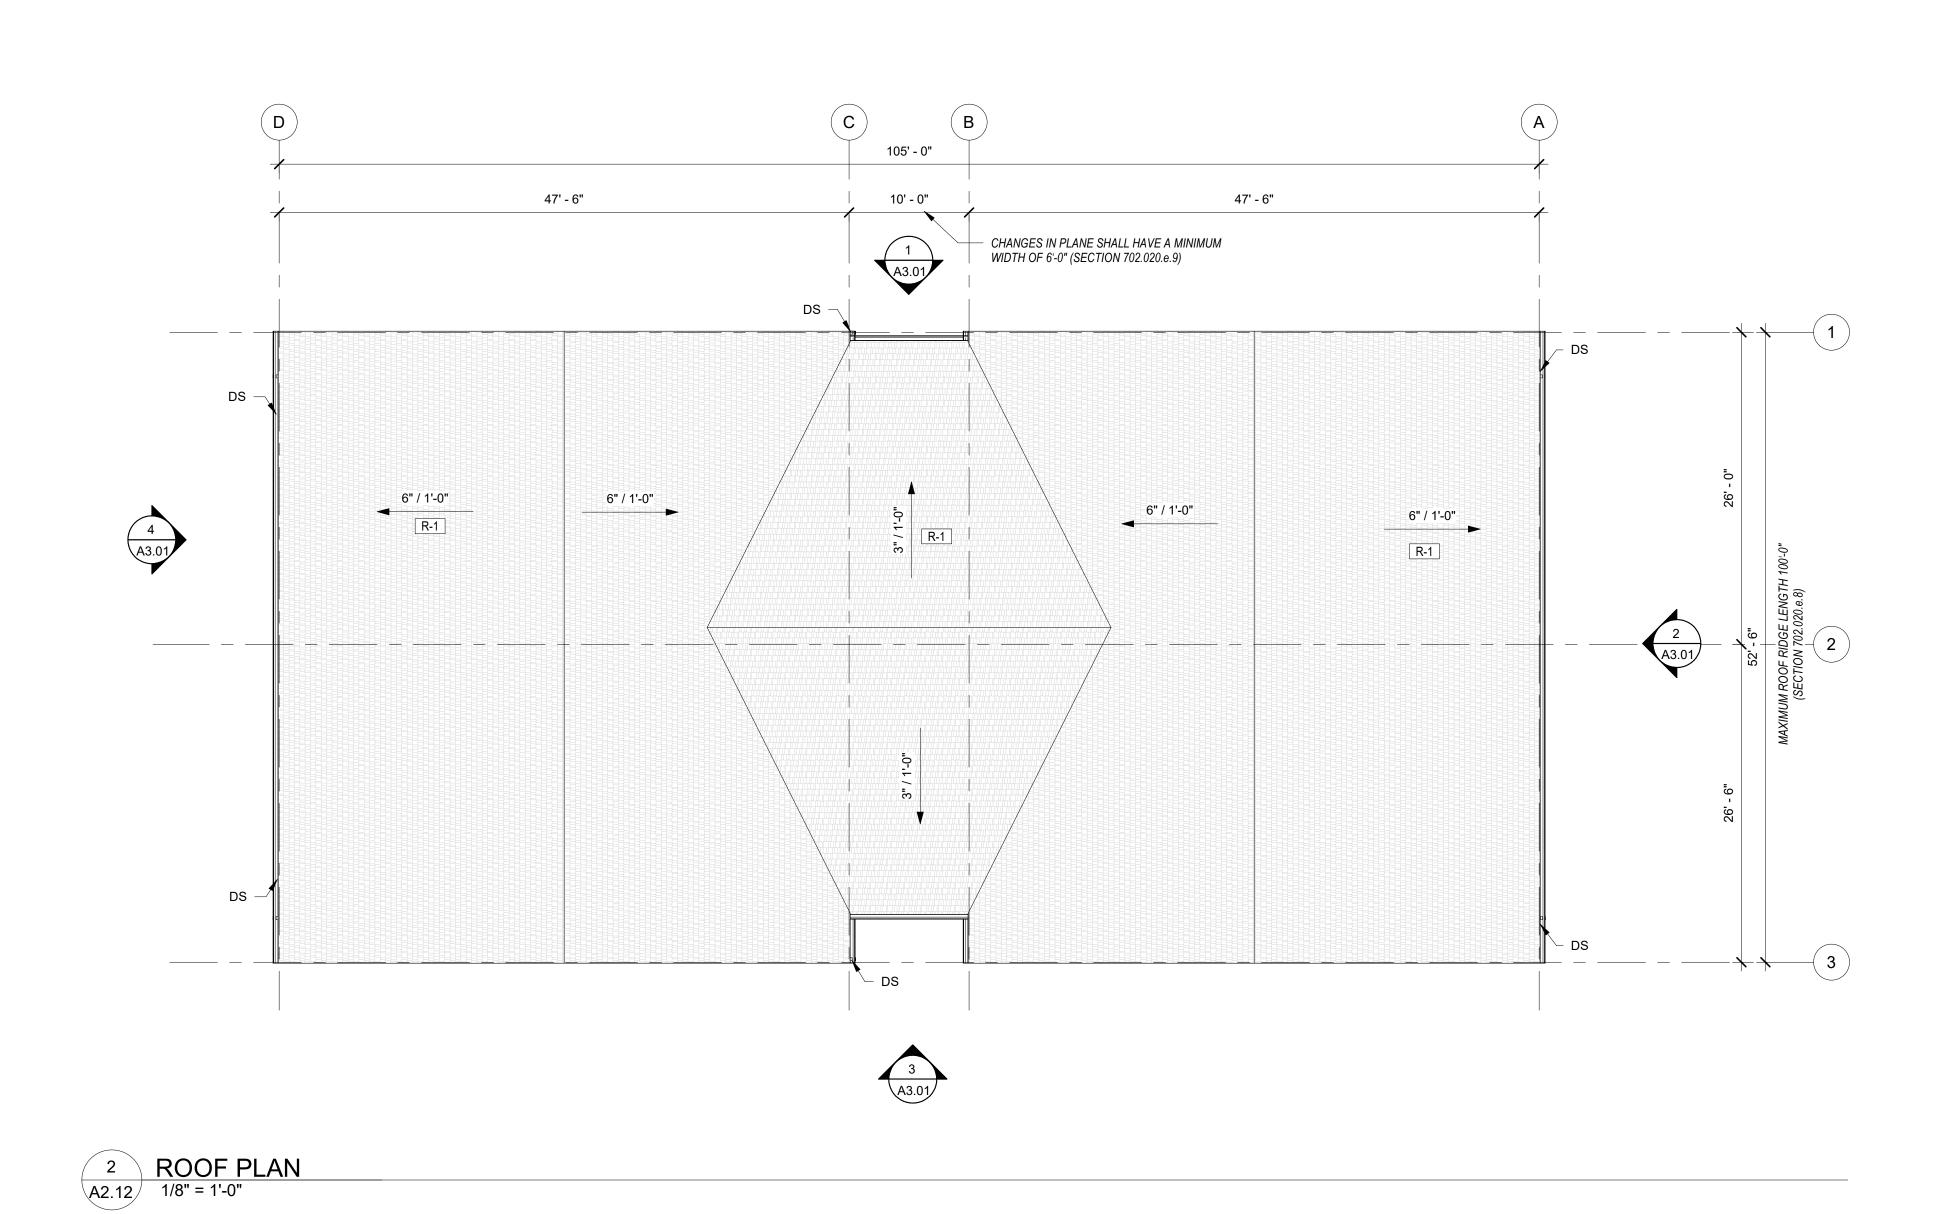1 BUILDING ELEVATION
A3.01 1/8" = 1'-0"

(C) HORIZONTALLY-DISTINGUISHING TRANSITION PIECE (SECTION 702.020.e.9)

PATIO PER – LANDSCAPE




CDP SALEM -PHASE 2 **BUILDING I**

Job Number: PARCEL 3 & PARCEL 4 BATTLE CREEK SE


SALEM, OR


Development


Partners

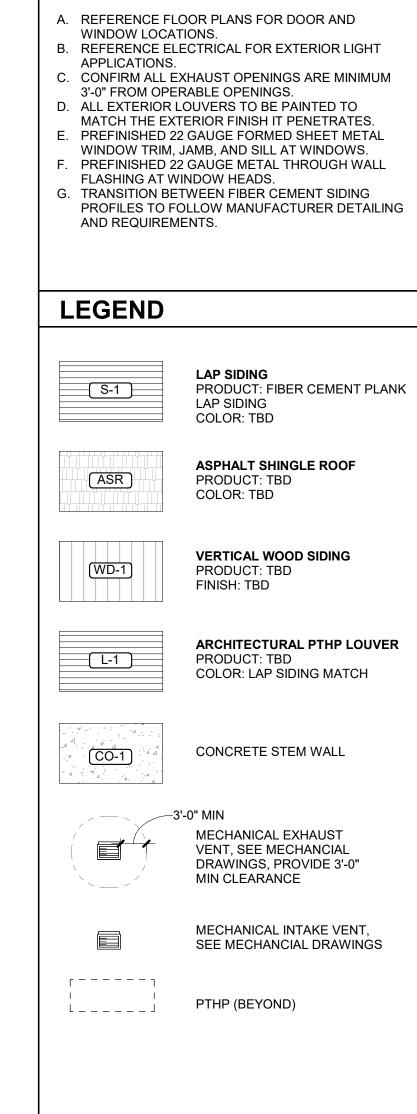

GENERAL SHEET NOTES

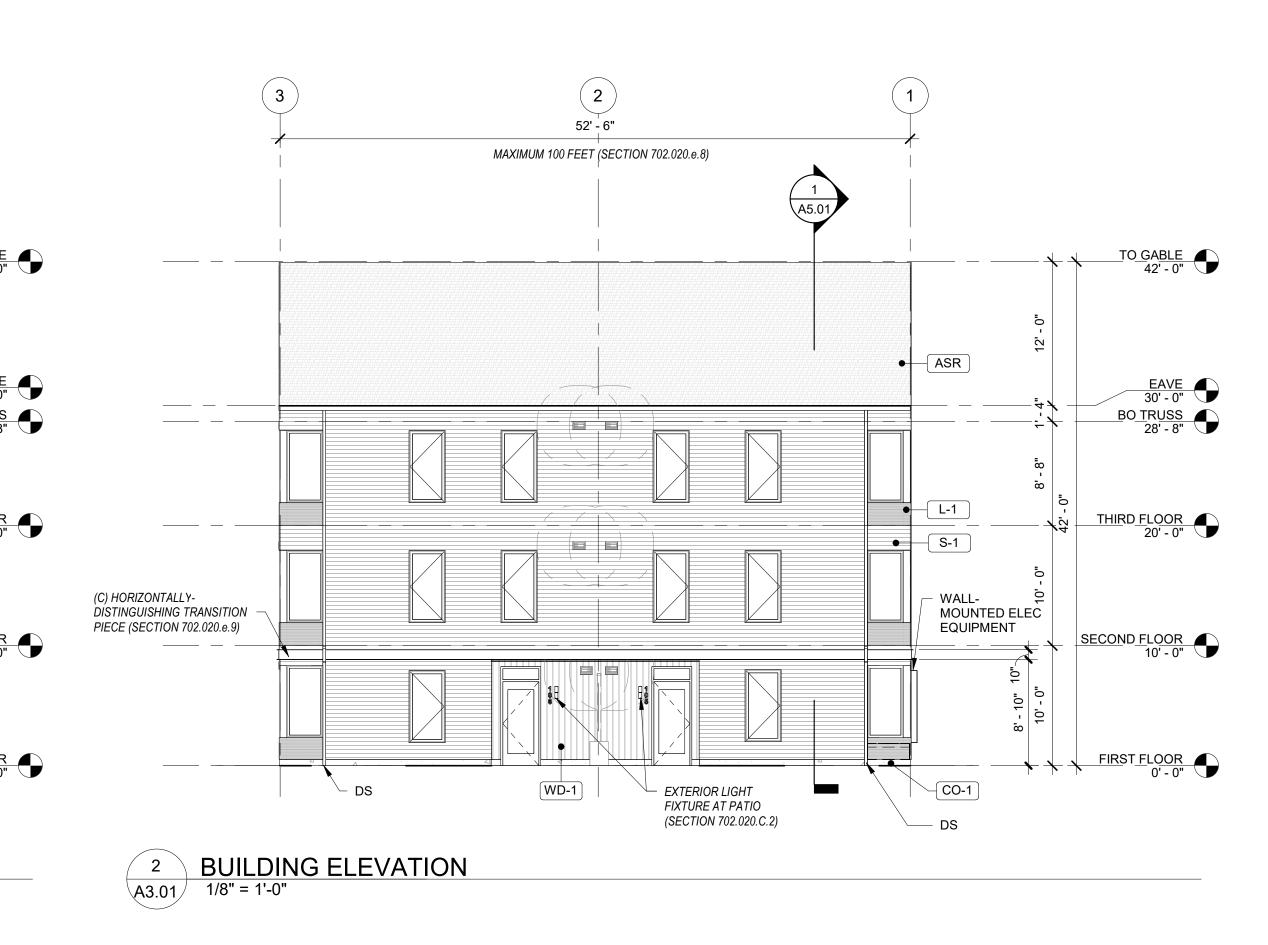

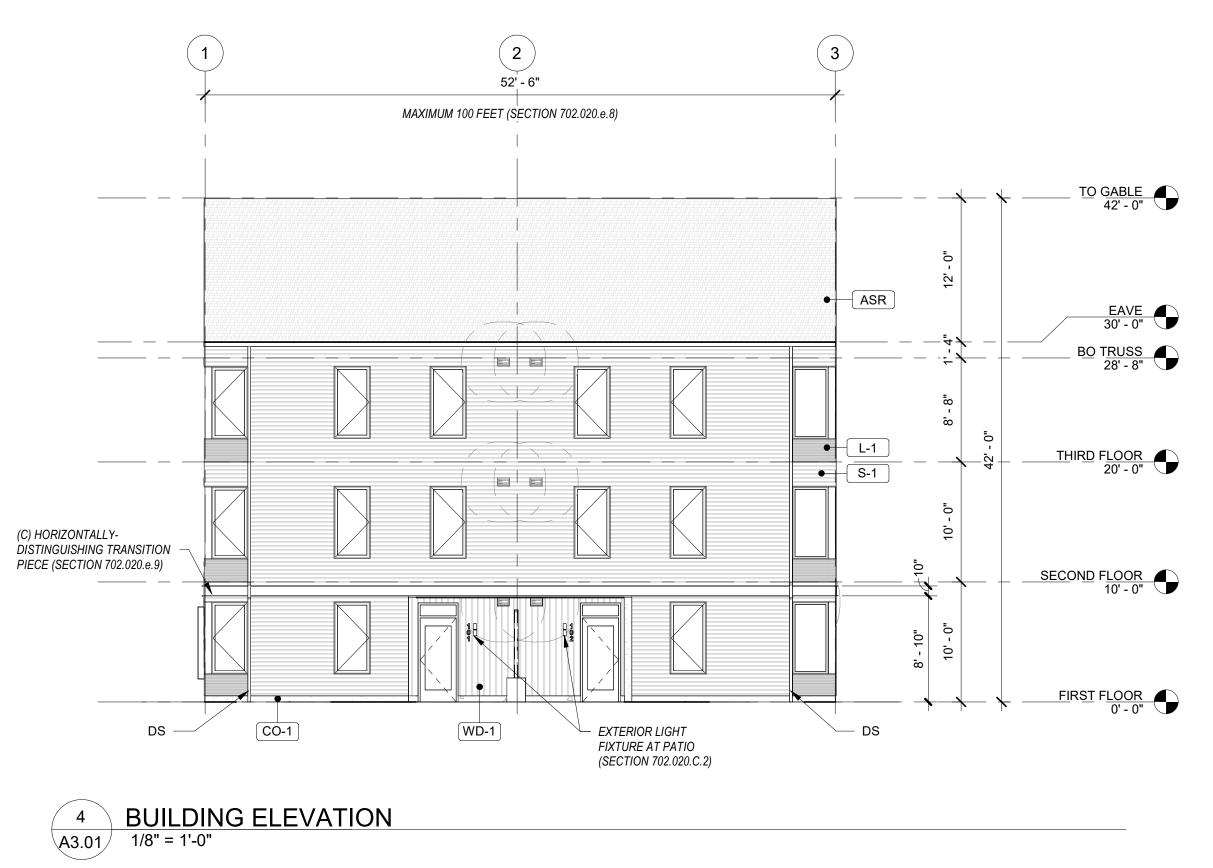

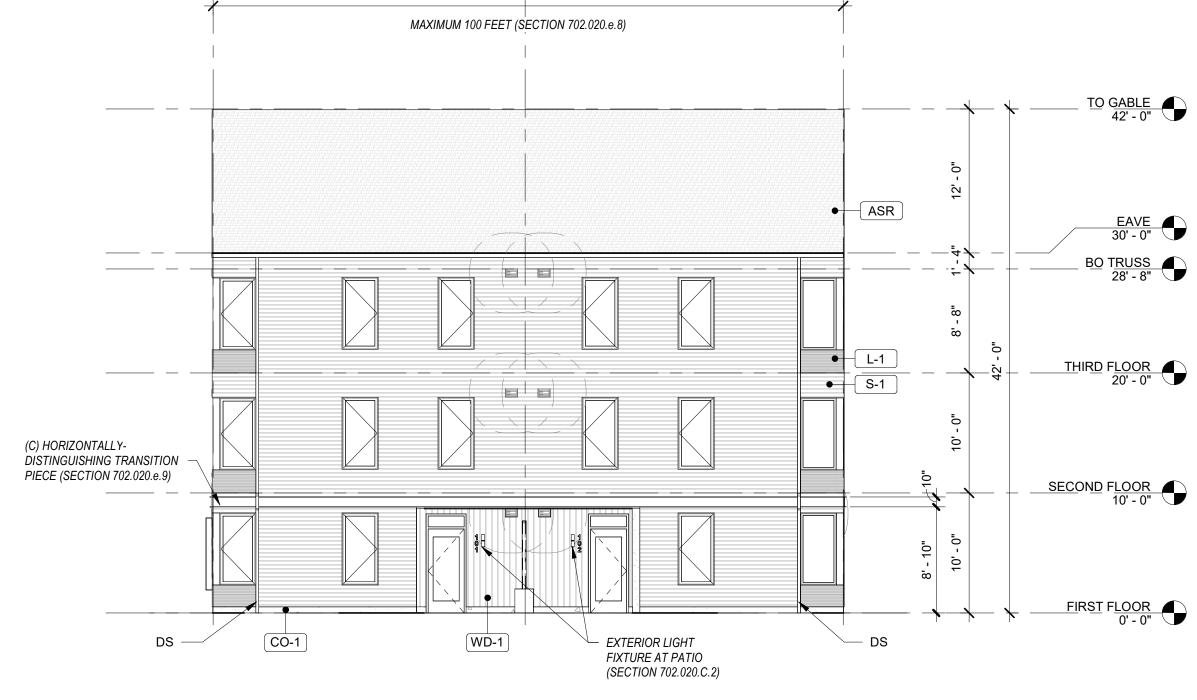

3 BUILDING ELEVATION
A3.01 1/8" = 1'-0"

BUILDING LENGTH EXCEEDS 80 FEET

(SECTION 702.020.e.9)

10' - 0"

MP-1

105' - 0"

BUILDING LENGTH EXCEEDS 80 FEET (SECTION 702.020.e.9) 10' - 0"

ASR

47' - 6"

MAXIMUM 80 FEET

(SECTION 702.020.e.9)

CO-1

MAXIMUM 80 FEET

(SECTION 702.020.e.9)

CO-1

PTHP —

____ S-1

L-1

TO GABLE 42' - 0"

47' - 6"

MAXIMUM 80 FEET

(SECTION 702.020.e.9)

47' - 6"


MAXIMUM 80 FEET

(SECTION 702.020.e.9)

LAND USE SUBMISSION

Drawing:

EXTERIOR ELEVATIONS 08.08.22

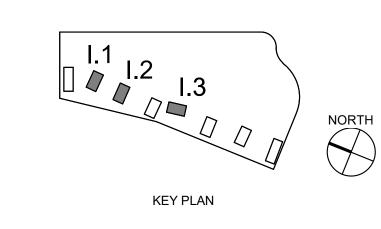





BUILDING FROM SALAL LOOKING NORTH



BUILDING FROM PARKING LOT


BUILDING PATIOS



MATERIALS



VERTICAL WOOD SIDING
PRODUCT: T&G SIDING, 1x6
WESTERN RED CEDAR
FINISH: TRANSPARENT

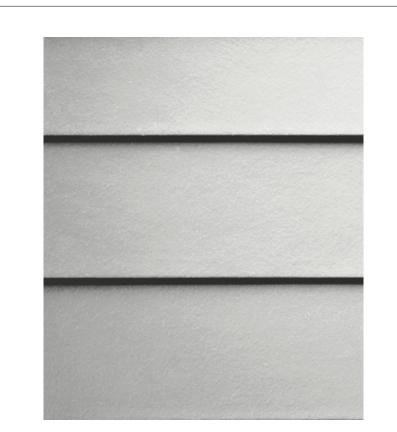


LAP SIDING
PRODUCT: FIBER CEMENT
PLANK LAP SIDING,
STRAIGHT EDGE PANEL
FINISH: PAINT, DARK



ASPHALT SHINGLE ROOF PRODUCT: THREE-TAB-STRIP ASPHALT SHINGLES FINISH: DARK



FLAT METAL PANEL PRODUCT: TBD FINISH: DARK

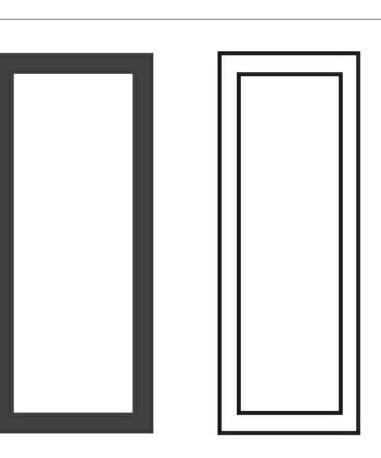

VINYL WINDOWS
PRODUCT: TBD
FINISH: BLACK & WHITE

LAND USE
SUBMISSION
ISSUE
Drawing:

RENDERINGS

08.08.22


DATE

CDP SALEM -

PHASE 2

BUILDING I

PARCEL 3 & PARCEL 4 BATTLE CREEK SE SALEM, OR

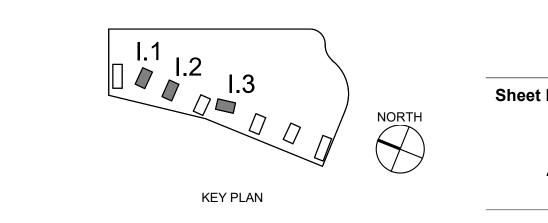

^{*} SITE AND LANDSCAPING SHOWN FOR REFERENCE ONLY. SEE CIVIL AND LANDSCAPE DRAWINGS FOR FULL DESIGN.

Community Development Partners

Drawing:


WALL SECTIONS

08.08.22

DATE

I.1 I.2 I.3

KEY PLAN

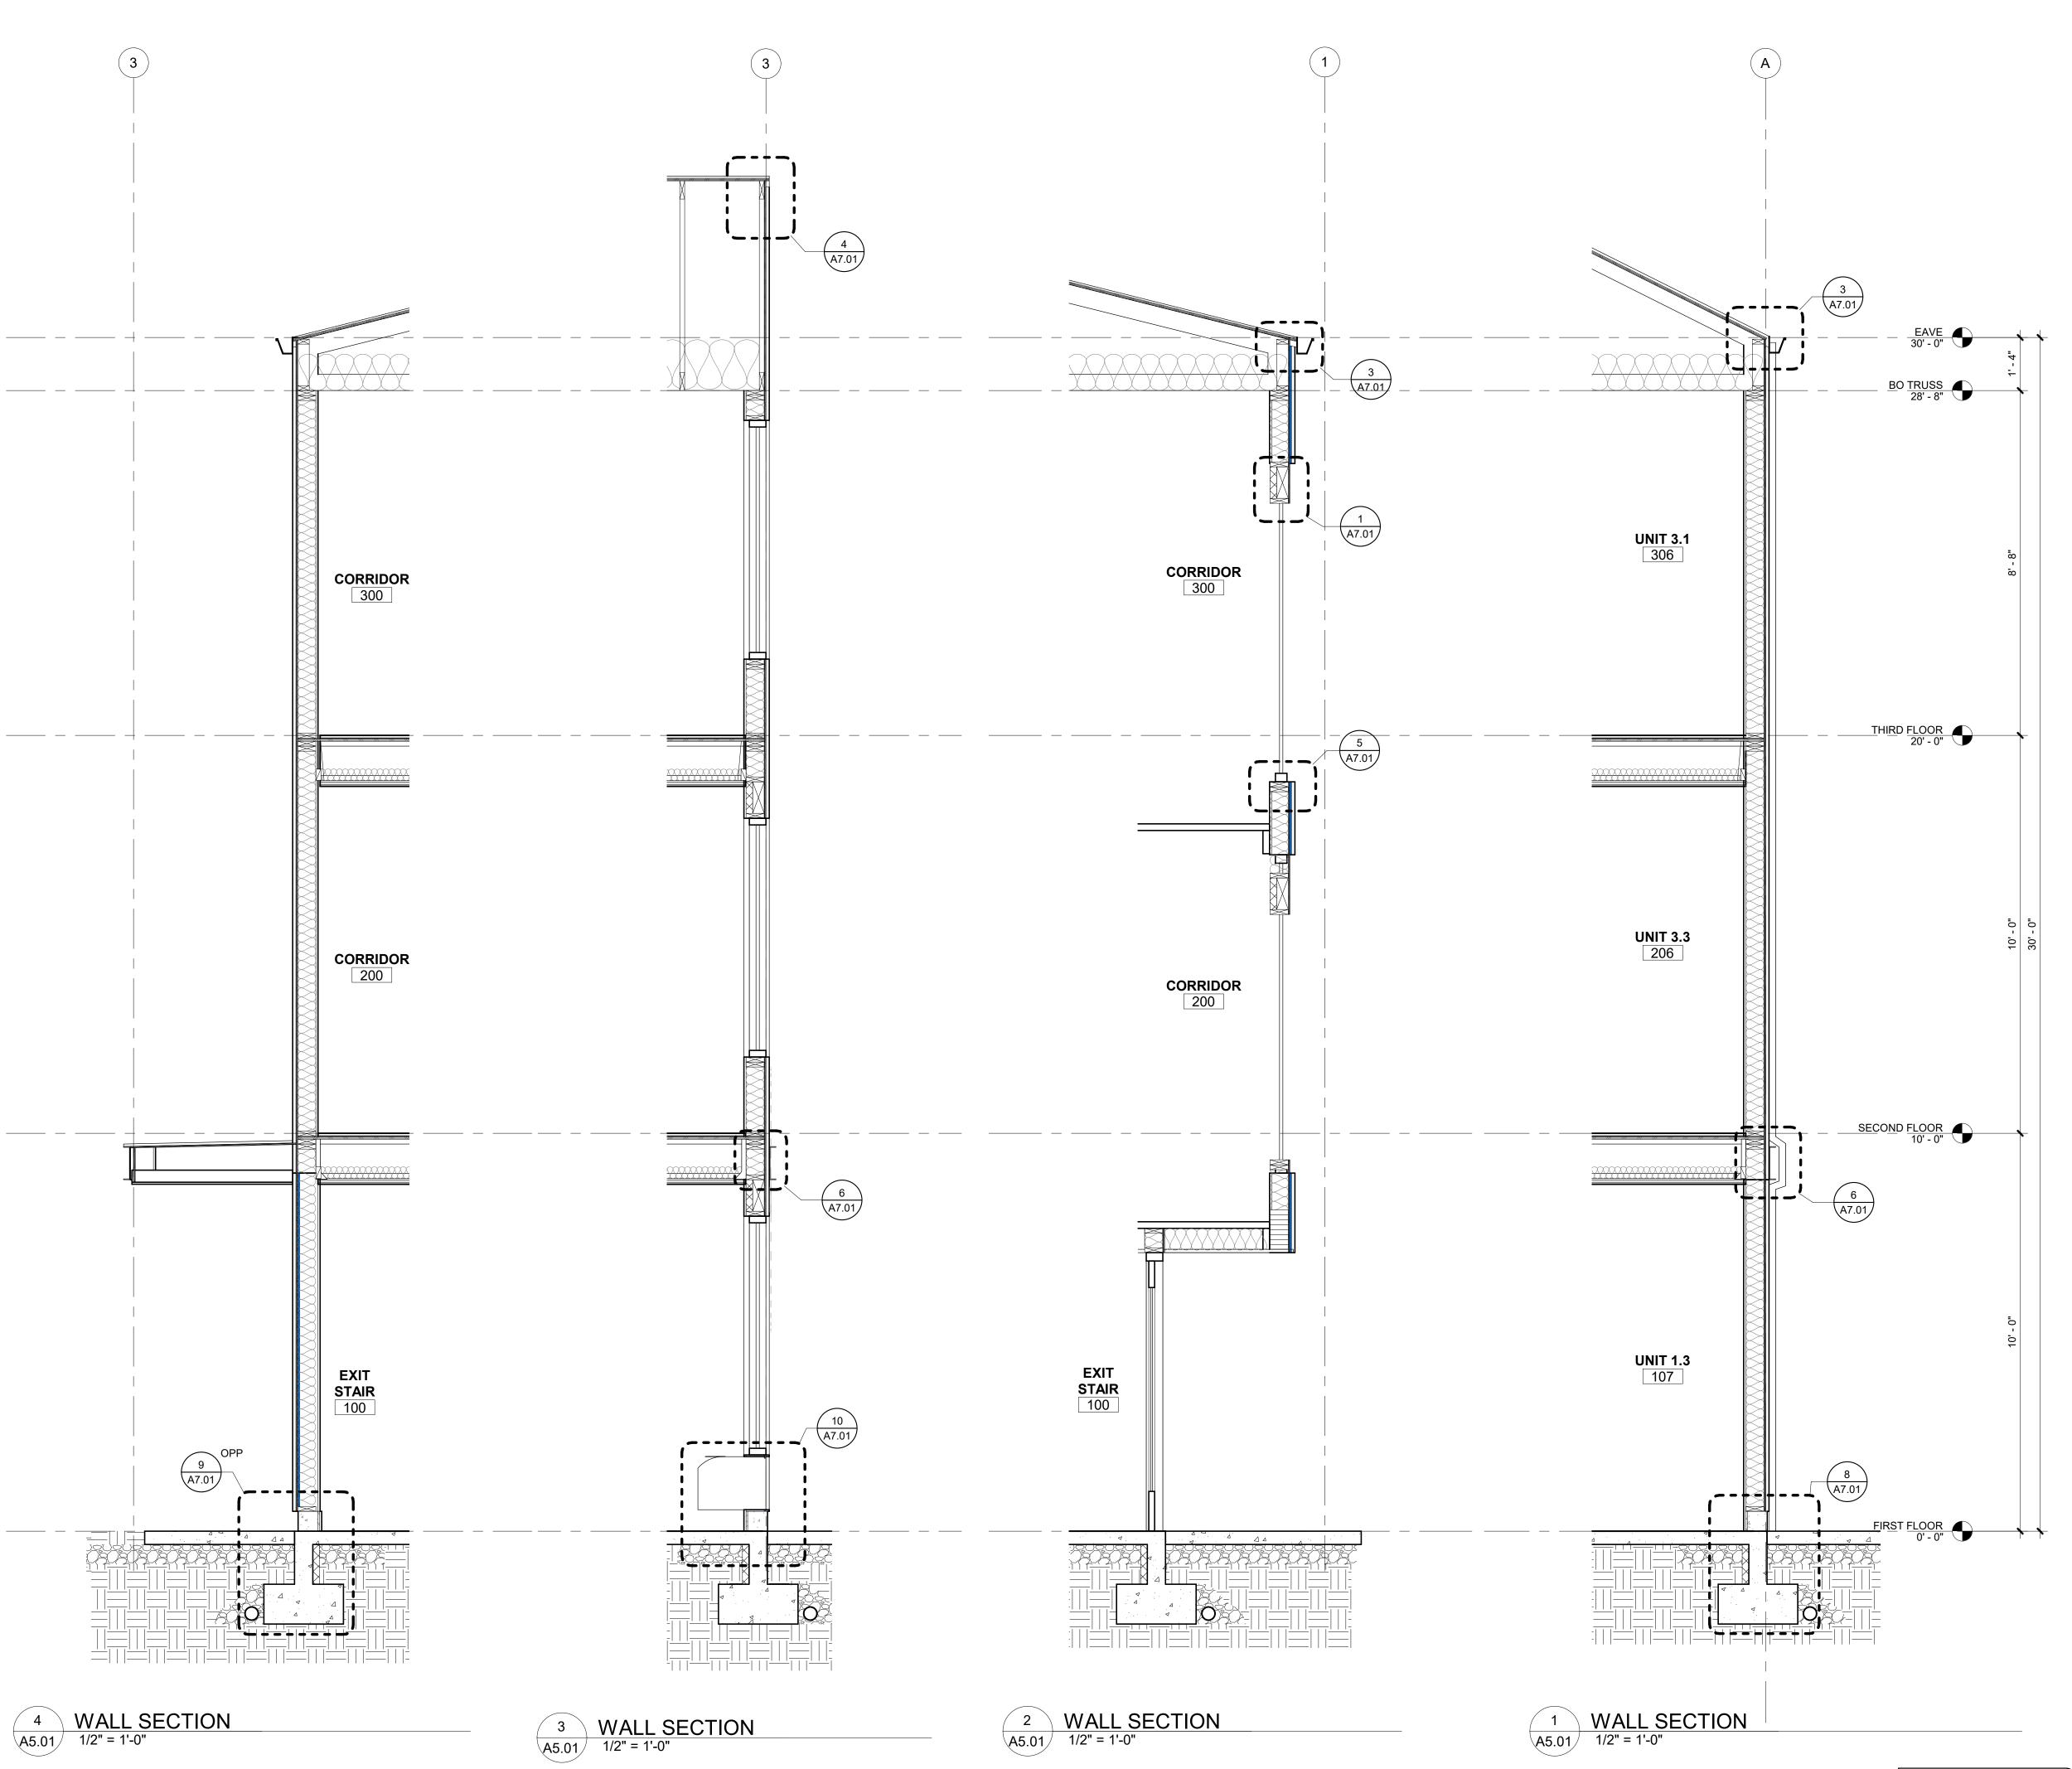

Sheet No: A5.01

