

# LAND USE SUBMISSION

08.08.22




## CDP SALEM - PHASE 2 - BUILDING G1


PARCEL 3 & PARCEL 4  
BATTLE CREEK SE  
SALEM, OR



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GENERAL PROJECT NOTES	PROJECT TEAM	PROJECT SUMMARY	SHEET INDEX																												
<p>REFER TO OWNER-CONTRACTOR AGREEMENT FOR GENERAL CONDITIONS. WHERE THERE IS A CONFLICT BETWEEN THE CONTRACT AND NOTES HEREIN, THE CONTRACT TAKES PRECEDENCE.</p> <p>1. GENERAL CONTRACTOR IS RESPONSIBLE FOR THE FULL SET OF CONSTRUCTION DOCUMENTS, INCLUDING BUT NOT LIMITED TO DRAWINGS, SPECIFICATIONS, AND ADDENDA.</p> <p>2. THE CONTRACTOR SHALL FIELD VERIFY ALL CONDITIONS AND DIMENSIONS PRIOR TO ANY WORK AND SHALL BE RESPONSIBLE FOR ALL WORK AND MATERIALS INCLUDING THOSE FURNISHED BY SUBCONTRACTORS.</p> <p>3. DIMENSIONS TAKE PRECEDENCE OVER DRAWINGS; DO NOT SCALE DRAWINGS TO DETERMINE ANY LOCATIONS. THE ARCHITECT SHALL BE NOTIFIED OF ANY DISCREPANCY PRIOR TO CONTINUING WITH WORK.</p> <p>4. GENERAL CONTRACTOR SHALL KEEP THE CONSTRUCTION SITE IN A BROOM CLEAN CONDITION AT ALL TIMES DURING THE PROJECT.</p> <p>5. THE CONTRACTOR SHALL REPORT TO THE ARCHITECT ANY ERRORS, INCONSISTENCIES OR OMISSIONS HE OR SHE MAY DISCOVER. BRING UNFORSEEN CONDITIONS TO ATTENTION OF ARCHITECT UPON DISCOVERY AT ANY POINT. THE MEANS OF CORRECTING ANY ERROR OR UNFORSEEN CONDITION SHALL FIRST BE APPROVED BY THE ARCHITECT.</p> <p>6. ALL REQUIRED CITY AND/OR COUNTY LICENSE SHALL BE ACQUIRED AND PAID FOR BY THE INDIVIDUAL TRADE.</p> <p>7. THE ARCHITECT WILL REVIEW SHOP DRAWINGS AND SAMPLES FOR CONFORMANCE WITH THE DESIGN CONCEPT OF THE PROJECT. THE ARCHITECT'S REVIEW OF A SEPARATE ITEM SHALL NOT INDICATE APPROVAL OF AN ASSEMBLY IN WHICH THE ITEM FUNCTIONS.</p> <p>8. IT SHALL BE THE RESPONSIBILITY OF THE CONTRACTOR TO VERIFY LOCATION OF ALL EXISTING UTILITIES WHETHER SHOWN HEREIN OR NOT AND TO PROTECT THEM FROM DAMAGE. THE CONTRACTOR SHALL BEAR ALL EXPENSES OF REPAIR OR REPLACEMENT OF UTILITIES OR OTHER PROPERTY DAMAGED BY OPERATIONS IN CONJUNCTION WITH THE EXECUTION OF THE WORK.</p> <p>9. CITY APPROVED PLANS SHALL BE KEPT IN A SECURE PLACE AND SHALL NOT BE USED BY WORKERS. THE CONTRACTOR SHALL BE RESPONSIBLE THAT ALL SUBCONTRACTORS' CONSTRUCTION SETS REFLECT THE SAME INFORMATION. THE CONTRACTOR SHALL ALSO MAINTAIN, IN GOOD CONDITION, ONE COMPLETE SET OF STAMPED CITY APPROVED PLANS WITH ALL REVISIONS, ADDENDUMS, AND CHANGE ORDERS ON THE PREMISES AT ALL TIMES. THESE ARE TO BE UNDER THE CARE OF THE JOB SUPERINTENDENT AND MUST BE MADE AVAILABLE TO BUILDING AND FIRE INSPECTIONS FOR REFERENCE DURING CONSTRUCTION.</p> <p>10. THE CONTRACTOR SHALL BE RESPONSIBLE FOR THE COMPLETE SECURITY OF THE SITE WHILE THE JOB IS IN PROGRESS AND UNTIL JOB COMPLETION.</p> <p>11. THE CONTRACTOR SHALL TAKE ALL NECESSARY PRECAUTIONS TO ENSURE THE SAFETY OF THE OCCUPANTS AND WORKERS AT ALL TIMES.</p> <p>12. THE CONTRACTOR IS SOLELY RESPONSIBLE FOR ALL CONSTRUCTION MEANS AND METHODS AND SHALL MAINTAIN THE STRUCTURAL INTEGRITY OF ANY CONSTRUCTION.</p> <p>13. THE CONTRACTOR SHALL BE RESPONSIBLE FOR AND SHALL REPLACE OR REMEDY ANY FAULTY, IMPROPER, OR INFERIOR MATERIALS OR WORKMANSHIP WHICH SHALL APPEAR WITHIN ONE (1) YEAR AFTER THE COMPLETION AND ACCEPTANCE OF THE WORK UNDER THIS CONTRACT.</p> <p>14. CONTRACTOR TO PROVIDE BACKING OR BLOCKING AS REQUIRED FOR MOUNTING ALL WALL MOUNTED SHELVES, EQUIPMENT, ACCESSORIES, CABINETS, ETC.</p> <p>15. CONTRACTOR TO PROTECT ALL TREES AND ROOTS NOT SLATED FOR REMOVAL DURING CONSTRUCTION.</p> <p>16. GENERAL CONTRACTOR RESPONSIBLE FOR MAINTENANCE OF STAGING AREA AND TO ENSURE THAT MATERIALS DELIVERY AND STORAGE DOES NOT INTERFERE WITH DAILY OPERATION OF ADJACENT PROPERTIES OR PUBLIC RIGHT OF WAY.</p> <p>17. GENERAL CONTRACTOR RESPONSIBLE FOR CONSTRUCTION STAKING.</p>	<p><b>OWNER</b></p> <p>CDP OREGON LLC 126 NE ALBERTA ST #202 PORTLAND, OR 97211 TEL: 971.533.7466 FAX: N/A CONTACT: THOMAS ELDRIDGE EMAIL: THOMAS@COMMUNITYDEVPARTNERS.COM</p> <p><b>CONTRACTOR</b></p> <p>GERDING BUILDERS 200 SW AIRPORT AVENUE CORVALLIS, OR 97333 TEL: 541.753.2012 FAX: 541.754.6654 CONTACT: RYAN MCALISTER EMAIL: RYANM@GERDINGBUILDERS.COM</p> <p><b>ARCHITECT</b></p> <p>SCOTT   EDWARDS ARCHITECTS, LLP 2525 E BURNSIDE STREET PORTLAND, OREGON 97214 TEL: 503.226.3617 FAX: 503.226.3715 CONTACT: DAVE MOJICA EMAIL: DMOJICA@SEALLP.COM</p> <p><b>CIVIL ENGINEER</b></p> <p>HHPR 205 SE SPOKANE ST, SUITE 200 PORTLAND, OREGON 97202 TEL: 503.365.1131 FAX: N/A CONTACT: BEAU BRAMAN EMAIL: BEAUB@HHPR.COM</p> <p><b>LANDSCAPE ARCHITECT</b></p> <p>PLACE 735 NW 18TH AVENUE PORTLAND, OR 97209 TEL: 503.334.2080 FAX: N/A CONTACT: TORI HALLIGAN EMAIL: TORI.HALLIGAN@PLACE.LA</p> <p><b>STRUCTURAL ENGINEER</b></p> <p>STONEWOOD STRUCTURAL ENGINEERS, INC 2001 NW 19TH SUITE 103A PORTLAND, OR 97209 TEL: 360.216.1704 FAX: N/A CONTACT: D. SCOTT NYSETH EMAIL: SCOTT.NYSETH@STONEWOODSTRUCTURAL.COM</p> <p><b>MEP &amp; FIRE PROTECTION ENGINEER</b></p> <p>INTERFACE 100 SW MAIN STREET, SUITE 1600 PORTLAND, OR 97204 TEL: 503.382.2266 FAX: 503.382.2262 CONTACT: KIM WALL EMAIL: KIMW@INTERFACEENG.COM</p>	<p>PROJECT DESCRIPTION: 3-STORY WOOD FRAMED MULTIFAMILY BUILDING FEATURING 18 RESIDENTIAL UNITS, LAUNDRY ROOM AND FIRE RISER ROOM.</p> <p>GROSS AREA: 19,226 SF</p> <p>PROJECT ADDRESS: 5205 BATTLE CREEK RD SE SALEM, OR 97306</p> <p>LEGAL DESCRIPTION: 083W14/ 118 AND 300</p> <p>ZONING: RM-II</p>	<table><tr><th>SHEET #</th><th>SHEET NAME</th></tr><tr><td colspan="2">GENERAL</td></tr><tr><td>G0.01</td><td>GENERAL PROJECT INFORMATION</td></tr><tr><td>G1.01</td><td>CODE SUMMARY</td></tr><tr><td colspan="2">ARCHITECTURAL</td></tr><tr><td>A0.01</td><td>ARCHITECTURAL GENERAL NOTES AND DIAGRAMS</td></tr><tr><td>A0.10</td><td>ACCESSIBILITY DIAGRAMS - RESIDENTIAL</td></tr><tr><td>A0.20</td><td>ASSEMBLIES</td></tr><tr><td>A2.11</td><td>FIRST FLOOR AND SECOND FLOOR PLAN</td></tr><tr><td>A2.12</td><td>THIRD FLOOR AND ROOF PLAN</td></tr><tr><td>A3.01</td><td>EXTERIOR ELEVATIONS</td></tr><tr><td>A3.10</td><td>RENDERINGS</td></tr><tr><td>A5.01</td><td>WALL SECTIONS</td></tr><tr><td>A7.01</td><td>EXTERIOR DETAILS</td></tr></table>	SHEET #	SHEET NAME	GENERAL		G0.01	GENERAL PROJECT INFORMATION	G1.01	CODE SUMMARY	ARCHITECTURAL		A0.01	ARCHITECTURAL GENERAL NOTES AND DIAGRAMS	A0.10	ACCESSIBILITY DIAGRAMS - RESIDENTIAL	A0.20	ASSEMBLIES	A2.11	FIRST FLOOR AND SECOND FLOOR PLAN	A2.12	THIRD FLOOR AND ROOF PLAN	A3.01	EXTERIOR ELEVATIONS	A3.10	RENDERINGS	A5.01	WALL SECTIONS	A7.01	EXTERIOR DETAILS
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		<p><b>SEPARATE PERMITS AND DEFERRED SUBMITTAL BIDDER DESIGN ITEMS</b></p> <p>CONTRACTOR SHALL PROVIDE DESIGN, ENGINEERING, FURNISHING AND INSTALLATION OF A COMPLETE, FUNCTIONING SYSTEM(S) BASED ON THE SCHEMATIC LAYOUT SHOWN ON THE ARCHITECTURAL DRAWINGS, DESCRIBED HEREIN AND IN COMPLIANCE WITH PREVAILING CODE. THE CONTRACTOR SHALL BE RESPONSIBLE FOR FINAL ORDERING OF ALL DEVICES AND FIXTURES TO ENSURE PROPER OPTIONS, ACCESSORIES AND CONFIGURATIONS. CONTRACTOR SHALL PROVIDE COMPLETE DESIGN AND DOCUMENTATION AS REQUIRED FOR SUBMISSION TO, AND APPROVAL OF ARCHITECT, OWNER, AND GOVERNING BUILDING DEPARTMENT.</p> <p>UPON COMPLETION OF REVIEW BY THE ARCHITECT OR ENGINEER OF RECORD, THE CONTRACTOR SHALL BE RESPONSIBLE FOR ROUTING DOCUMENTS TO PERMIT AGENCY FOR PLANS REVIEW AND PAYING ANY PLANS CHECK AND PERMIT FEES.</p> <p><u>SEPARATE PERMITS:</u></p> <p>1. FIRE SYSTEMS - ALARM 2. FIRE SYSTEMS - SPRINKLERS 3. SIGNAGE</p> <p><u>DEFERRED SUBMITTALS:</u></p> <p>1. MEP EQUIPMENT BRACING 2. ROOF TRUSSES 3. STOREFRONT, WINDOWS, LOUVERS, AND THEIR CONNECTIONS TO STRUCTURE 4. SOFFITS AND SUSPENDED CEILINGS 5. ROOFTOP ANCHORAGE 6. GUARDRAILS AND HANDRAILS</p> <p>SEE SPECIFICATIONS FOR ADDITIONAL REQUIREMENTS NOT LISTED HERE AND ADDITIONAL BIDDER DESIGN ITEMS.</p>																													
<p><b>VICINITY MAP</b></p> 																															



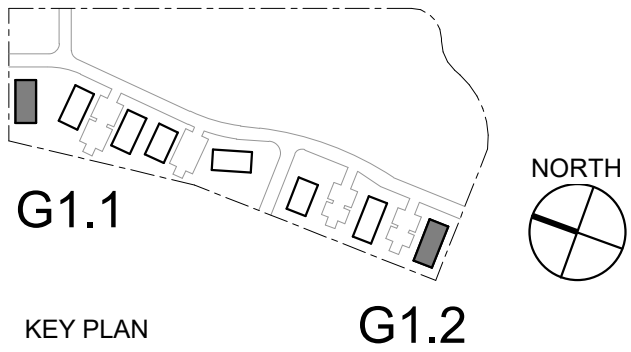

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BUILDING CODE SUMMARY			2019 OREGON STRUCTURAL SPECIALTY CODE														
OCCUPANCY		R-2															
CONSTRUCTION TYPE		TYPE V-B, SPRINKLERED PER NFPA 13R															
CHAPTER 4: SPECIAL DETAILED REQUIREMENTS BASED ON OCCUPANCY AND USE																	
OSSC REFERENCE																	
SECTION 420.2	SEPARATION WALLS	WALLS SEPARATING DWELLING OR SLEEPING UNITS FROM EACH OTHER OR OTHER OCCUPANCIES SHALL BE CONSTRUCTED AS FIRE PARTITIONS IN ACCORDANCE WITH SECTION 708.															
SECTION 420.3	HORIZONTAL SEPARATION	FLOOR ASSEMBLIES SEPARATING DWELLING OR SLEEPING UNITS FROM EACH OTHER OR OTHER OCCUPANCIES SHALL BE CONSTRUCTED AS HORIZONTAL ASSEMBLIES IN ACCORDANCE WITH SECTION 711.															
SECTION 420.4	SPRINKLER SYSTEM	GROUP R OCCUPANCIES, REQUIRED PER 903.2.8															
SECTION 420.5	FIRE & SMOKE ALARMS	GROUP R-2, FIRE ALARM SYSTEMS REQUIRED PER SECTION 907.2.9 SMOKE ALARMS REQUIRED PER 907.2.10.2															
CHAPTER 5: GENERAL BUILDING HEIGHTS AND AREAS																	
TABLE 504.3 TABLE 504.4 TABLE 506.2	HEIGHT / STORIES / AREA FACTOR	Primary Building Occupancy: 60 FT / 3 STORY / 7000 SF															
MODIFICATIONS																	
SECTION 506.2.3 SINGLE-OCCUPANCY, MULTISTORY BUILDING EQUATION 5-2	BUILDING AREA	Aa = [A1 + (NS x If)] x Sa = [7000 SF + (7000 SF x 0.75)] x 3 = 12250 SF x 3 = 36750 SF															
SECTION 506.3	FRONTAGE INCREASE	If = [F/P - 0.25] x W/30 If = [1/1 - 0.25] x 30/30 = 0.75															
	ACTUAL HEIGHT / STORIES	35' - 0" / 3 Story															
<table><tr><th colspan="2">BUILDING AREA</th></tr><tr><th>FLOOR LEVEL</th><th>AREA (SF)</th></tr><tr><td>FIRST FLOOR</td><td>6368 SF</td></tr><tr><td>SECOND FLOOR</td><td>6397 SF</td></tr><tr><td>THIRD FLOOR</td><td>6244 SF</td></tr><tr><td></td><td>19010 SF</td></tr></table>						BUILDING AREA		FLOOR LEVEL	AREA (SF)	FIRST FLOOR	6368 SF	SECOND FLOOR	6397 SF	THIRD FLOOR	6244 SF		19010 SF
BUILDING AREA																	
FLOOR LEVEL	AREA (SF)																
FIRST FLOOR	6368 SF																
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THIRD FLOOR	6244 SF																
	19010 SF																
SECTION 508.2	ACCESSORY OCCUPANCY	N/A															
SECTION 508.3 / 508.4	MIXED OCCUPANCY	N/A															
TABLE 509	INCIDENTAL USES																
	LAUNDRY ROOMS OVER 100 SF	SPRINKLERED, NO SEPARATION REQUIRED															
	TRASH ROOMS OVER 100 SF	SPRINKLERED, NO SEPARATION REQUIRED															
CHAPTER 6: TYPES OF CONSTRUCTION / CONSTRUCTION CLASSIFICATION																	
TABLE 601	FIRE RESISTANCE RATING REQUIREMENTS FOR BUILDING ELEMENTS																
	BUILDING ELEMENT	FIRE RATING *															
	PRIMARY STRUCTURAL FRAME	0 HOUR															
	BEARING WALLS																
	EXTERIOR	0 HOUR															
	INTERIOR	0 HOUR															
	NON BEARING WALLS AND PARTITIONS - EXTERIOR	PER TABLE 602															
	NON BEARING WALLS AND PARTITIONS - INTERIOR	0 HOUR															
	FLOOR CONSTRUCTION AND SECONDARY MEMBERS	0 HOUR															
	ROOF CONSTRUCTION AND SECONDARY MEMBERS	0 HOUR															
	* UNLESS OTHERWISE REQUIRED BY THIS CODE																
TABLE 602	FIRE RESISTANCE RATING REQUIREMENTS FOR EXTERIOR WALLS BASED ON FIRE SEPARATION DISTANCE																
	FIRE SEPARATION DISTANCE	FIRE RATING															
	X < 5'	1 HOUR															
	5' <= X < 10'	1 HOUR															
	10' <= X < 30'	0 HOUR															
	X >= 30'	0 HOUR															
CHAPTER 7: FIRE AND SMOKE PROTECTION FEATURES																	
TABLE 705.2	MINIMUM DISTANCE OF PROJECTION	40 INCHES															
TABLE 705.6	MAXIMUM AREA OF WALL OPENINGS BASED ON FSD AND OPENING PROTECTION																
	UNPROTECTED, NON-SPRINKLERED	PROTECTED															
	NOT PERMITTED	NOT PERMITTED															
	0 TO LESS THAN 3'	15%															
	3 TO LESS THAN 5'	15%															
	5 TO LESS THAN 10'	15%															
	10 TO LESS THAN 15'	45%															
	15 TO LESS THAN 20'	75%															
	20 TO LESS THAN 25'	45%															
	25 TO LESS THAN 30'	70%															
	30' OR GREATER	NO LIMIT															
705.8.1	ALLOWABLE AREA OF OPENINGS	EXCEPTION 2: BUILDINGS WHOSE EXTERIOR BEARING WALLS, EXTERIOR NONBEARING WALLS AND EXTERIOR PRIMARY STRUCTURAL FRAME ARE NOT REQUIRED TO BE FIRE-RESISTANCE RATED SHALL BE PERMITTED TO HAVE UNLIMITED UNPROTECTED OPENINGS.															
705.11	PARAPETS	EXCEPTION 1: WALL NOT REQUIRED TO BE FIRE-RESISTANCE RATED IN ACCORDANCE WITH TABLE 602 BECAUSE OF FIRE SEPARATION DISTANCE.															
TABLE 706.4	FIRE WALL FIRE RESISTANCE	N/A															
TABLE 707.3.10	FIRE BARRIER ASSEMBLIES AND HORIZONTAL ASSEMBLIES BTWN FIRE AREAS	N/A															
SECTION 708	FIRE PARTITIONS	1 HOUR EXCEPTION 1: 1/2 HOUR AT GROUP R-2 CORRIDORS PER TABLE 1020.1															
SECTION 709	SMOKE BARRIERS	NOT REQUIRED															
SECTION 711	FLOOR AND ROOF ASSEMBLIES SUPPORTING CONSTRUCTION PER 711.2.3																
711.2.4.1	SEPARATING MIXED OCCUPANCIES	N/A															
711.2.4.2	SEPARATING FIRE AREAS	N/A															
711.2.4.3	DWELLING / SLEEPING UNITS	1 HOUR															
711.2.4.4	SEPARATING SMOKE COMPARTMENTS	N/A															
711.2.4.5	SEPARATING INCIDENTAL USES	PER TABLE 509															
711.2.4.6	OTHER SEPARATIONS	N/A															
SECTION 713	SHAFT ENCLOSURES	NOT LESS THAN 1 HOUR CONNECTING LESS THAN 4 STORIES NOT LESS THAN 2 HOUR CONNECTING 4 STORIES OR MORE															
CHAPTER 8: INTERIOR FINISHES																	
TABLE 803.13	INTERIOR WALL AND CEILING FINISH REQUIREMENTS (FLAME SPREAD RATING)																
	INTERIOR EXIT STAIRWAYS AND RAMPS AND EXIT PASSAGEWAYS	C															
	CORRIDORS AND ENCLOSURES FOR EXIT ACCESS STAIRWAYS AND RAMPS	C															
	ROOMS AND ENCLOSED SPACES	C															
CHAPTER 9: FIRE PROTECTION SYSTEMS																	
SPRINKLERED PER NFPA 13R																	

## CHAPTER 10: MEANS OF EGRESS

SECTION 1004	OCCUPANT LOAD (OL)	SEE OCCUPANT LOAD TABLE	
SECTION 1005.3.1	STAIRWAY EGRESS CAPACITY FACTOR	0.3	
SECTION 1005.3.2	OTHER EGRESS CAPACITY FACTOR	0.2	
TABLE 1006.2.1	MAX OCCUPANT LOAD FOR ONE EXIT MAX COMMON PATH OF EGRESS TRAVEL	20 OCCUPANTS 125 FT	
TABLE 1006.3.2	MAX OCCUPANT LOAD PER STORY MIN NUMBER OF EXITS FOR STORY	500 2 *SEE 1003.3 EXCEPTIONS	
TABLE 1006.3.3(1)	STORIES WITH ONE EXIT FOR R-2	4 UNITS / 125 FT TRAVEL DISTANCE / UP TO 3 STORIES EMERGENCY ESCAPE AND RESCUE OPENINGS PER 1030 REQUIRED FOR STORIES WITH ONE EXIT	
TABLE 1017.2	EXIT ACCESS TRAVEL DISTANCE	250 FT	
TABLE 1020.1	CORRIDOR FIRE-RESISTANCE RATING	0.5 HR	
TABLE 1020.2	MINIMUM CORRIDOR WIDTH	44 INCHES * 36 INCHES WITHIN DWELLING UNIT OR WHERE OCCUPANT LOAD <50	
SECTION 1020.4	DEAD ENDS	20 FEET *LENGTH IS NOT LIMITED WHERE LENGTH < 2.5x WIDTH	
SECTION 1023.2	INTERIOR EXIT STAIRWAY FIRE-RESISTANCE RATING	1 HR CONNECTING < 4 STORIES	

## CHAPTER 11: ACCESSIBILITY

SECTION 1106.2	R-2 OCCUPANCIES WITH ACCESSIBLE, TYPE A OR TYPE B UNITS, AT LEAST 2% OF EACH TYPE OF PARKING PROVIDED SHALL BE ACCESSIBLE		
	TOTAL SPACES PROVIDED:	43	
	ACCESSIBLE SPACES REQUIRED:	43 x 2% = 1	
	ACCESSIBLE SPACES PROVIDED:	5	
SECTION 1107.6.2.2.1	R-2 OCCUPANCIES WITH GREATER THAN 20 DWELLING UNITS SHALL PROVIDE MINIMUM 2% TYPE A UNITS. ALL R-2 UNITS ON A SITE SHALL BE CONSIDERED TO DETERMINE TOTAL NUMBER OF UNITS AND REQUIRED NUMBER OF TYPE A UNITS		
	TYPE A UNITS REQUIRED (TOTAL FOR SITE):	129 x 2% = 3 UNITS	
	TYPE A UNITS PROVIDED (TOTAL FOR SITE):	7 UNITS	
	TYPE A UNITS PROVIDED (THIS BUILDING):		
SECTION 1107.6.2.2.2	WHERE THERE ARE FOUR OR MORE DWELLING UNITS, ALL UNITS SHALL BE TYPE B UNITS AT A MINIMUM		
EXCEPTION:	THE NUMBER OF TYPE A AND TYPE B UNITS IS PERMITTED TO BE REDUCED IN ACCORDANCE WITH SECTION 1107.7		
	1107.7.1.1, STRUCTURES WITHOUT ELEVATOR SERVICE, ONE STORY WITH TYPE B UNITS REQUIRED		

## ADDITIONAL ACCESSIBILITY REQUIREMENTS

APPLICABLE STANDARDS		
ANSI ICC A117.1 - 2009		
2010 ADA STANDARDS FOR ACCESSIBLE DESIGN - TITLE II		
SECTION 504		
FAIR HOUSING ACCESSIBILITY GUIDELINES		
FHA SAFE HARBOR DESIGN DOCUMENT: IBC 2018		
OHCS CORE DEVELOPMENT MANUAL		
ACCESSIBLE UNITS		
5% OF UNITS WITH MOBILITY FEATURES	129 x 5% = 7 UNITS	
2% OF UNITS WITH COMMUNICATION FEATURES	129 x 2% = 3 UNITS	

## CHAPTER 13: ENERGY EFFICIENCY 2021 OREGON ENERGY EFFICIENCY SPECIALTY CODE (OEESC)


CLIMATE ZONE 4C				
OPAQUE ELEMENTS	REQUIRED		PROVIDED	
	ASSEMBLY MAX.	MIN. R-VALUE		
ROOFS				
INSULATION ENTIRELY ABOVE DECK	N/A	N/A		
METAL BUILDINGS	N/A	N/A		
ATTIC AND OTHER	U-0.021	R-49		R-49
WALLS (ABOVE GRADE)				
MASS	U-0.104	R-11.4 CI		R-11.4 CI
METAL BUILDINGS	N/A	N/A		
STEEL-FRAMED	N/A	N/A		
WOOD-FRAMED / OTHER	U-0.064	R-20		R-23
WALLS (BELOW GRADE)	C-0.119	R-10 CI		
FLOORS				
MASS	N/A	N/A		
STEEL JOIST	N/A	N/A		
WOOD FRAMED / OTHER	U-0.033	R-30		R-30
SLAB-ON-GRADE FLOORS				
HEATED	N/A	N/A		
UNHEATED	F-0.520	R-15 FOR 24"		R-15
OPAQUE DOORS				
SWINGING	U-0.37			-0.37
NON-SWINGING				
FENESTRATION				
	REQUIRED		PROVIDED	
	MAX U	MAX SHGC	MAX U	MAX SHGC
VERTICAL (0% - 40% OF WALL ALLOWED)				
FIXED	0.36	0.36	1.10	0.36
OPERABLE	0.45	0.33	1.10	0.33
ENTRANCE DOOR	0.63	0.33	1.10	0.33
SKYLIGHT (0% - 3% OF ROOF ALLOWED)				
CI = CONTINUOUS INSULATION FC = FILLED CAVITY NR = NO REQUIREMENT NA = NOT APPLICABLE				

## CHAPTER 29: PLUMBING FIXTURES


R-2	TOTAL UNITS	
	18	1 WC / LAV / Tub or Shower per unit required and provided

EXIT ACCESS TRAVEL DISTANCE		
EGRESS PATH NAME	EGRESS PATH LENGTH	
FIRST FLOOR	32' - 8"	
SECOND FLOOR	53' - 5"	
THIRD FLOOR	52' - 11"	


LIFE SAFETY OCCUPANT LOAD SCHEDULE				
AREA NAME	AREA (SF)	TABLE 1004.1.2		OCCUPANT LOAD
		FUNCTION OF SPACE	OCCUPANT LOAD FACTOR	
FIRST FLOOR	6113 SF	Residential	200	31
SECOND FLOOR	6235 SF	Residential	200	32
THIRD FLOOR	6215 SF	Residential	200	32
				95

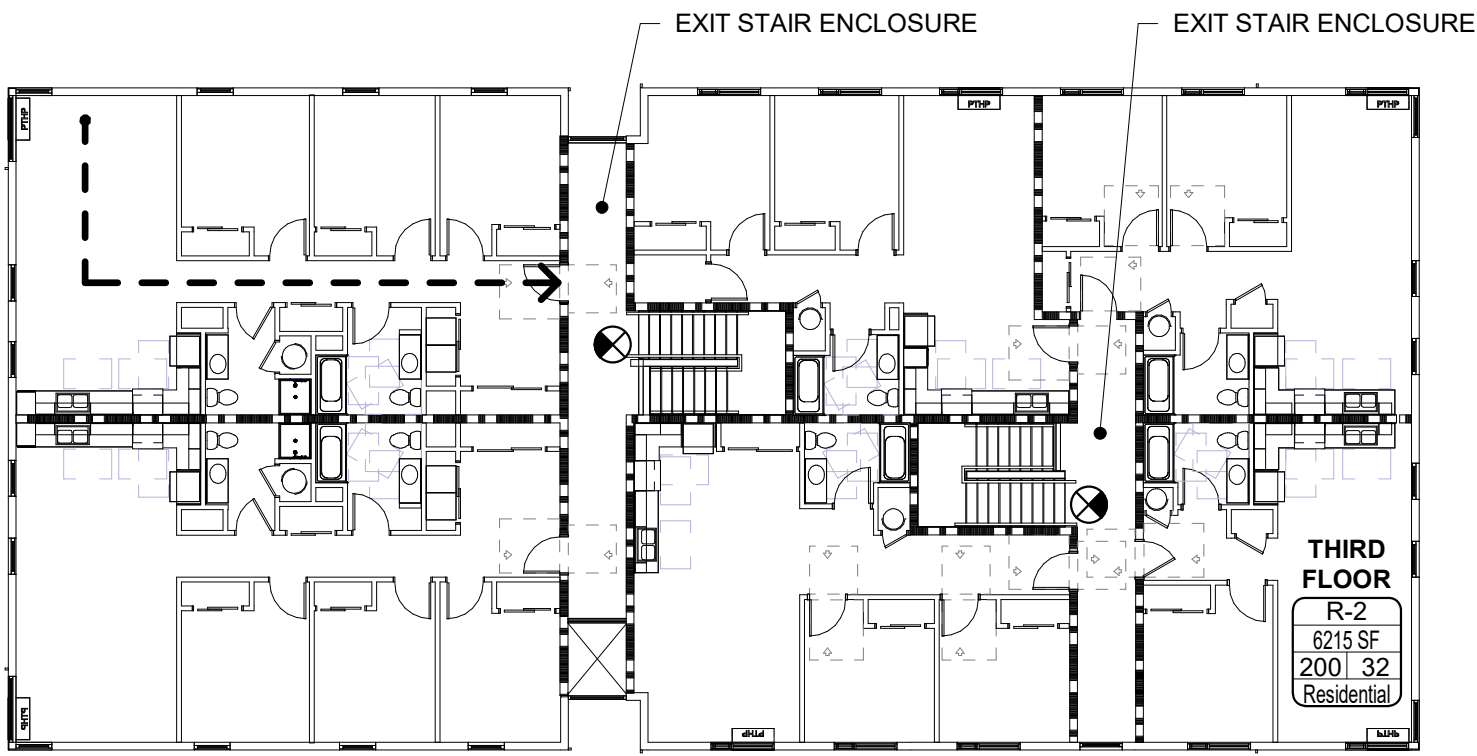

3 THIRD FLOOR LIFE SAFETY PLAN  
1/16" = 1'-0"

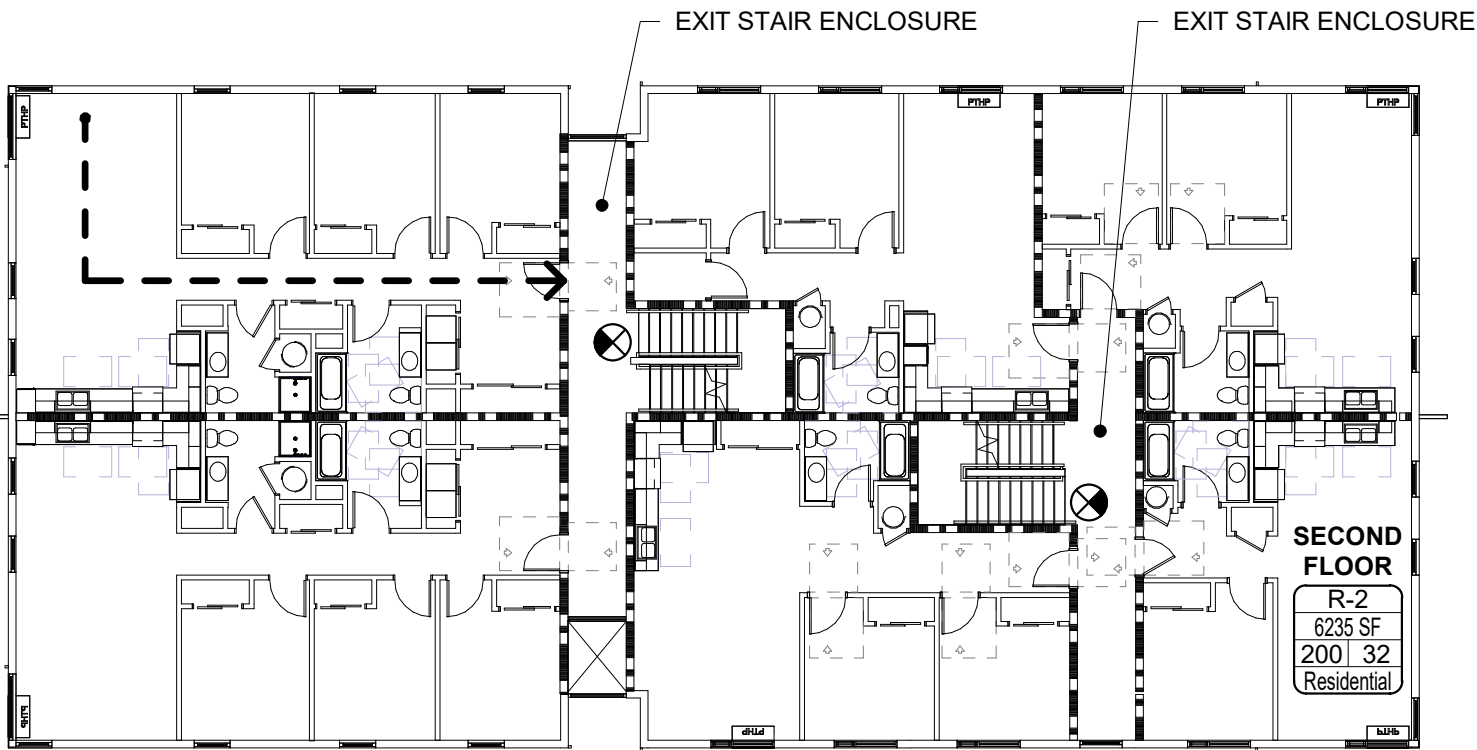

2 SECOND FLOOR LIFE SAFETY PLAN  
1/16" = 1'-0"

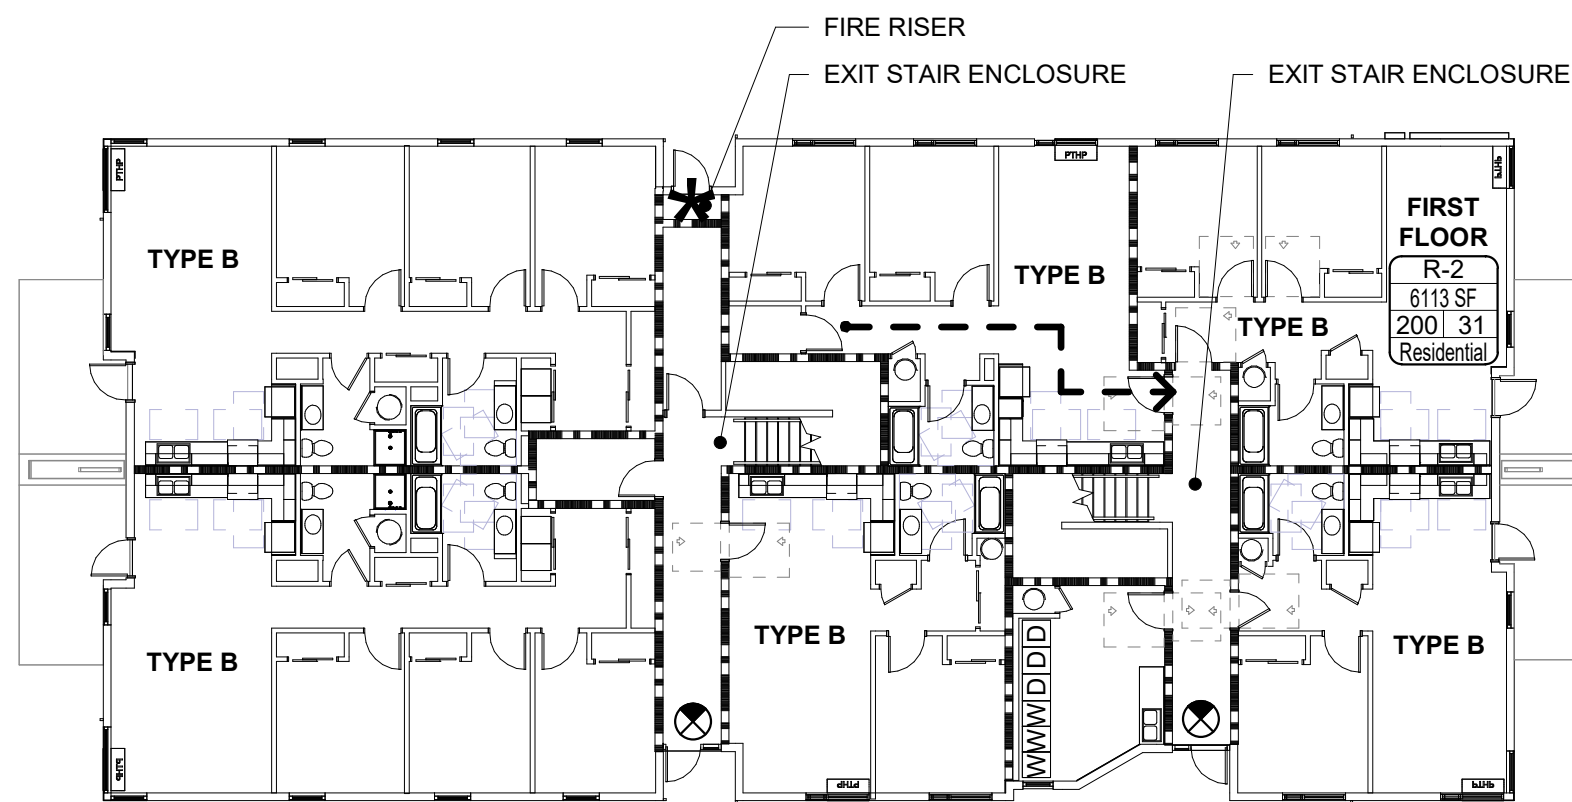

1 FIRST FLOOR - FIRE LIFE SAFETY PLAN  
1/16" = 1'-0"

## CODE SUMMARY LEGEND

1 1/2" x 1/2" x 1/2" x 1/2" x 1/2"	1 HOUR RATED ASSEMBLY
WALL RATINGS TO CONTINUE ABOVE / BELOW ALL DOORS, RELITES, ETC.	
AREA NAME	
NAME	
Occ. Grp	OCCUPANCY (CH. 3)
# SF	AREA (SF)
OLF #	OCCUPANT LOAD FACTOR / NUMBER OF OCCUPANTS
Engrn	FUNCTION (CH. 10)
*	UNOCCUPIED AREA, OCCUPANT LOAD NOT INCLUDED IN BUILDING TOTALS
EXIT SIGN	EXIT SIGN
SHADE INDICATES ILLUMINATE FACE. ARROW INDICATES DIRECTION TO EXIT	
PATH A	EXIT ACCESS PATH
100' - 0"	
A	EXIT ACCESS DOOR
60	DOOR RATING (IN MINUTES)
FEC or FE	MULTI-PURPOSE FIRE EXTINGUISHER AND CABINET (FEC) OR FIRE EXTINGUISHER (FE) ON BRACKET. VERIFY EXACT LOCATIONS AND QUANTITY WITH FIRE DEPARTMENT.

## 702.020 MULTIPLE FAMILY DESIGN REVIEW STANDARDS

CITY OF SALEM UNIFIED DEVELOPMENT CODE - TITLE X

SECTION	REQUIREMENT MET OR ADJUSTMENT REQUESTED	SHEET NUMBER
SITE SAFETY & SECURITY		
702.020.c.1	REQUIREMENT MET	A2.11-A3.01
702.020.c.2	REQUIREMENT MET	A3.01
FACADE & BUILDING DESIGN		
702.020.e.1	REQUIREMENT MET	A2.11-A2.12
702.020.e.8	REQUIREMENT MET	A3.01
702.020.e.9	REQUIREMENT MET	A2.11-A3.01
702.020.e.10	REQUIREMENT MET	A3.01

NOT FOR CONSTRUCTION

## CDP SALEM - PHASE 2 - BUILDING G1

Job Number: 22047

PARCEL 3 & PARCEL 4  
BATTLE CREEK SE  
SALEM, OR

## SITE PLAN - ZONING DIAGRAM



FILE PATH: C:\Revit\_Local\22047\_CDP Salem Gateway Phase II\_Walk Up Building G1.22\_mculbertsonPX8RT.rvt

THESE DRAWINGS ARE THE ORIGINAL UNPUBLISHED WORK OF THE ARCHITECT AND MAY NOT BE DUPLICATED OR USED WITHOUT THE WRITTEN CONSENT OF THE ARCHITECT.

## REQUIRED CLEAR FLOOR AREAS

PER ICC A117.1-2009



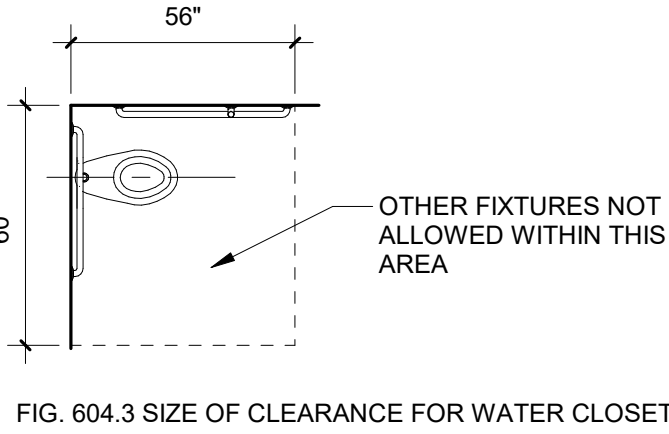


FIG. 604.3 SIZE OF CLEARANCE FOR WATER CLOSET

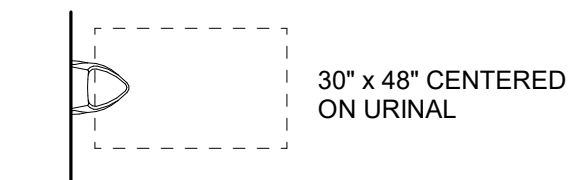


605.3 SIZE OF CLEARANCE FOR URINAL

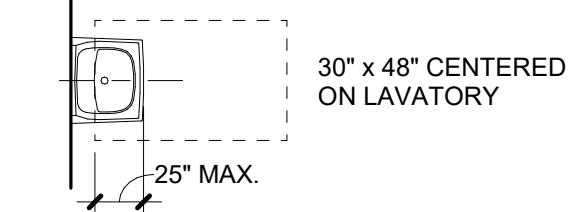

SIZE OF CLEARANCE FOR LAVATORY


## PROTRUDING OBJECTS

PER ICC A117.1-2009 FIG. 307.2

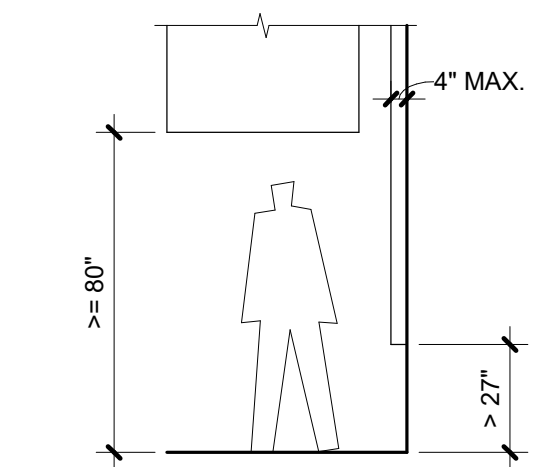


## MANEUVERING CLEARANCES AT MANUAL SWINGING DOORS


PER ICC A117.1-2009, FIG. 404.2.3.2

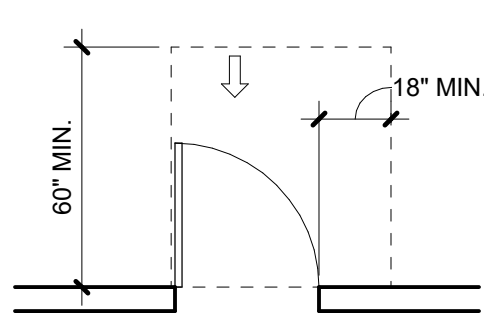


(a) FRONT APPROACH PULL SIDE

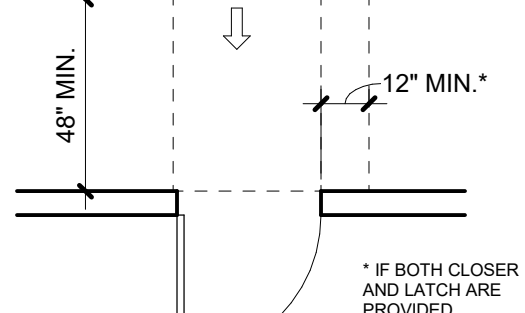


(b) FRONT APPROACH PUSH SIDE

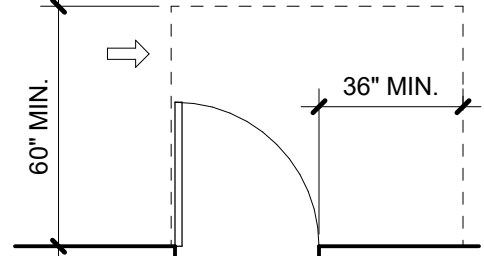


(c) HINGE APPROACH PULL SIDE

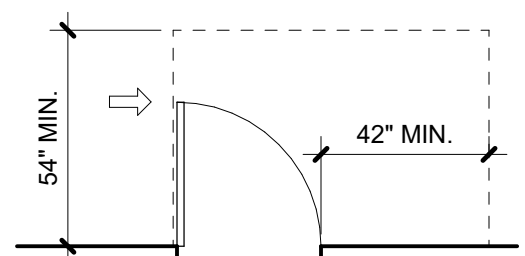


(d) HINGE APPROACH PUSH SIDE

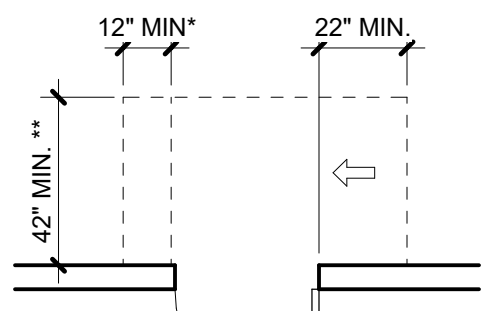

(e) HINGE APPROACH PULL SIDE

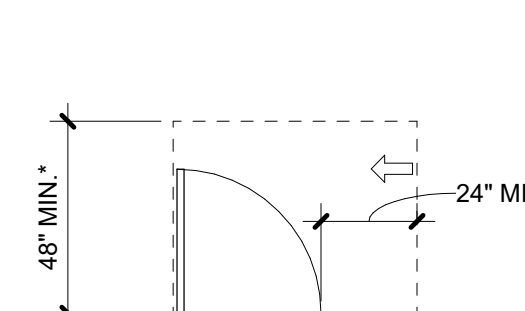


(f) LATCH APPROACH PULL SIDE

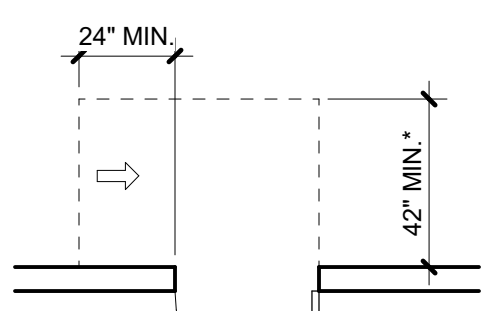

(g) LATCH APPROACH PUSH SIDE

- A. VERIFY ALL ACCESSIBILITY REQUIREMENTS WITH CURRENT CODE AND LOCAL JURISDICTION.
- B. DIAGRAMS ARE INCLUDED AS A CONVENIENCE ONLY AND ARE NOT ALL INCLUSIVE. REFERENCE CURRENT CODE AND PROJECT DOCUMENTS FOR ADDITIONAL REQUIREMENTS.
- C. NOTIFY ARCHITECT OF ANY DISCREPANCIES BETWEEN DIMENSIONS SHOWN HERE AND PROPOSED WORK.

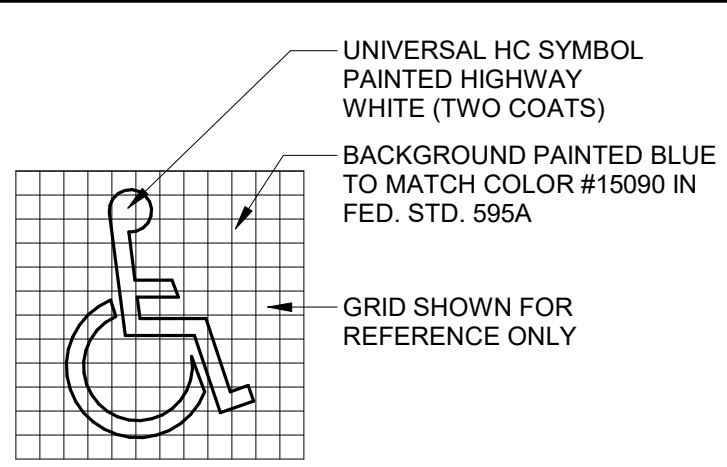


## ABBREVIATIONS

#	POUND OR NUMBER	GA	GAUGE	R	RADIUS OR RISER
@	AT	GALV	GALVANIZED	RA	RETURN AIR
CL	CENTERLINE	GC	GENERAL CONTRACTOR	RB	RESILIENT BASE
L	ANGLE	GI	GALVANIZED IRON	RD	ROOF DRAIN
ø	DIAMETER OR ROUND	GL	GLULAM	REC	RECOMMENDATION
AB	ANCHOR BOLT	GND	GROUND	REF	REFERENCE
AC	ASPHALTIC CONCRETE	GR	GRADE	REFR	REFRIGERATOR
ACT	ACOUSTIC CEILING TILE	GWB	GYP SUM BOARD	REINF	REINFORCE(MENT)
AD	AREA DRAIN	GYP	GYP SUM	REQD	REQUIRED
ADJ	ADJUSTABLE	GYP BD	GYP SUM BOARD	RESIL	RESILIENT
AF	ABOVE FINISH FLOOR			REV	REVISIONS
AFG	ABOVE FINISH GRADE	HB	HOSE BIB	RF	RESILIENT FLOOR
ALT	ALTERNATE	HC	HOLLOW CORE	RH	RIGHT HAND
ALUM	ALUMINUM	HDR	HEADER	RM	ROOM
ANOD	ANODIZED	HOWD	HARDWOOD	RO	ROUGH OPENING
APPROX	APPROXIMATE / APPROXIMATELY	HOWR	HARDWARE	ROW	RIGHT OF WAY
ARCH	ARCHITECTURAL / ARCHITECT	HM	HOLLOW METAL	RWL	RAIN WATER LEADER
ASPH	ASPHALT	HNDPCP	HORIZONTAL	S	SOUTH
BC	BOTTOM OF CURB	HORIZ	HORIZONTAL	SA	SUPPLY AIR
BD	BOARD	HP	HORSE POWER	SAH	SELF ADHERED MEMBRANE
BITUM	BITUMINOUS	HPL	HIGH PRESSURE LAMINATE	SC	SOLID CORE
BLDG	BUILDING	HR	HOUR	SCHED	SCHEDULE
BLK	BLOCK	HSS	HOLLOW STRUCTURAL STEEL	SEC	SECTION
BLKG	BLOCKING	HT	HEIGHT	SF	SQUARE FOOT
BLW	BELOW	HVAC	HEATING VENTILATING AIR CONDITIONING	SHT	SHEET
BO	BOTTOM OF	HW	HOT WATER	SHTHG	SHEATHING
BOT	BOTTOM	ID	INSIDE DIAMETER	SHWR	SHOWER
BRG	BEARING	IE	INVERT ELEVATION	SIM	SIMILAR
BTWN	BETWEEN	IN	INCHES	SIM	SHEET METAL
BUR	BUILT UP ROOF	INSUL	INSULATION	SP	SOLID PIPE
CAB	CABINET	INT	INTERIOR	SPEC	SPECIFICATIONS
CB	CATCH BASIN	JB	JUNCTION BOX	SPK	SPEAKER
CFM	CUBIC FEET PER MINUTE	JH	JOIST HANGER	SQ	SQUARE
CI	CAST IRON	JST	JOIST	SS	STAINLESS STEEL
CIP	CAST IN PLACE	JT	JOINT	SSK	SERVICE SINK
CJ	CONTROL JOINT	KD	KILN DRIED	SSM	SOLID SURFACE MATERIAL
CL	CENTERLINE	KIT	KITCHEN	STA	STATION
CLG	CEILING	KW	KILOWATT	STD	STANDARD
CLR	CLEAR	LAM	LAMINATED	STL	STEEL
CMU	CONCRETE MASONRY UNIT	LAV	LAVATORY	STN	STAIN
CO	CLEAN OUT	LB	LEADER BOX	STR	STRUCTURAL
CO	CLEAN OUT	LH	LEFT HAND	SUSP	SUSPENDED
COL	COLUMN	LKR	LOCKER	SYM	SYMMETRICAL
CONC	CONCRETE	LT	LIGHT	T	TREAD OR TILE
CONC	CONCRETE	LTWT	LIGHTWEIGHT	T&G	TONGUE AND GROOVE
CONC	CONCRETE	MAT	MATERIAL	TM	TO MATCH
CONC	CONCRETE	MAX	MAXIMUM	TC	TOP OF CURB
CONC	CONCRETE	MB	MACHINE BOLT	TEL	TELEPHONE
CONC	CONCRETE	MC	MEDICINE CABINET	TEMP	TEMPERATURE
CONC	CONCRETE	MECH	MECHANICAL	TER	TERRAZZO
CONC	CONCRETE	MFR	MANUFACTURER	THK	THICK / THICKNESS
CONC	CONCRETE	MH	MANHOLE	TJ	TOOL JOINT
CONC	CONCRETE	MIN	MINIMUM	TLT	TOILET
CONC	CONCRETE	MIR	MIRROR	TO	TOP OF
CONC	CONCRETE	MISC	MISCELLANEOUS	TOC	TOP OF CONCRETE
CONC	CONCRETE	MO	MASONRY OPENING	TOP	TOP OF PARAPET
CONC	CONCRETE	MRSWB	MOISTURE RESISTANT GWB	TOS	TOP OF STEEL
CONC	CONCRETE	MTD	MOUNTED	TOSF	TOP OF SUB-FLOOR
CONC	CONCRETE	MTL	METAL	TOW	TOP OF WALL
CONC	CONCRETE	MULL	MULLION	TP	TOP
CONC	CONCRETE	NEW	NEW	TS	TUBE STEEL
CONC	CONCRETE	N	NORTH	TV	TELEVISION
CONC	CONCRETE	NIC	NOT IN CONCRAC	TYP	TYPICAL
CONC	CONCRETE	NO	NUMBER	UL	UNDERWRITER'S
CONC	CONCRETE	NOM	NOMINAL	UNF	UNFINISHED
CONC	CONCRETE	NTS	NOT TO SCALE	UNO	UNLESS NOTED OTHERWISE
CONC	CONCRETE	OBS	OBSOLETE	UR	URINAL
CONC	CONCRETE	OC	ON CENTER	VB	VAPOR BARRIER
CONC	CONCRETE	OD	OUTSIDE DIAMETER	VCT	VINYL COMPOSITION TILE
CONC	CONCRETE	OF	OWNER FURNISHED	VERT	VERTICAL
CONC	CONCRETE	OFI	OWNER FURNISHED OWNER INSTALLED	VFY	VERIFY
CONC	CONCRETE	OPNG	OPENING	VG	VERTICAL GRAIN
CONC	CONCRETE	OPP	OPPOSITE	VIF	VERIFY IN FIELD
CONC	CONCRETE	OTS	OPEN TO STRUCTURE	VP	VENT PIPE
CONC	CONCRETE	P	PANTRY	VR	VAPOR RETARDER
CONC	CONCRETE	PC	PRECAST	W	WEST
CONC	CONCRETE	PIP	POURED IN PLACE	W	WATT
CONC	CONCRETE	PL	PLATE OR PROPERTY LINE	W	WITH
CONC	CONCRETE	PLAM	PLASTIC LAMINATE	W/O	WITHOUT
CONC	CONCRETE	PLAS	PLASTIC	WC	WATER CLOSET
CONC	CONCRETE	PLYWD	PLYWOOD	WD	WOOD
CONC	CONCRETE	PNT	PAINT	WDW	WINDOW
CONC	CONCRETE	PSF	POUNDS PER SQUARE FOOT	WF	WIDE FLANGE
CONC	CONCRETE	PSI	POUNDS PER SQUARE INCH	WI	WROUGHT IRON
CONC	CONCRETE	PT	PRESSURE TREATED	WO	WHERE OCCURS
CONC	CONCRETE	PTD	PAINTED	WP	WATERPROOF
CONC	CONCRETE	PVC	POLYVINYL CHLORIDE	WR	WATER RESISTANT
CONC	CONCRETE	QT	QUARRY TILE	WRB	WEATHER RESISTANT
CONC	CONCRETE			WST	WAINSCOT
CONC	CONCRETE			WT	WEIGHT
CONC	CONCRETE			WWF	WELDED WIRE FABRIC

## DIMENSIONS

- A. DIMENSIONS ARE INDICATED IN THE DOCUMENTS. THE DRAWINGS SHALL NOT BE SCALED FOR DIMENSIONS. NOTIFY ARCHITECT IF ADDITIONAL DIMENSIONS ARE NECESSARY.
- B. IN MANY INSTANCES THE ACTUAL DIMENSIONS MAY BE LESS IMPORTANT THAN IF ELEMENTS ARE TO BE EQUALLY SPACED OR ALIGNED. IN THESE CASES, THE NOTATION "EQ" OR "ALIGN" IS USED IN LIEU OF A DIMENSION.
- C. DETAILS WILL GOVERN ALL DIMENSIONS NOT SHOWN ON PLANS. REFERENCE INDICATED DIMENSION POINTS.
- D. DIMENSIONS SHOWN ARE TO GRIDLINE, CENTERLINE OF COLUMN, OR FACE OF STUD / MASONRY, UNLESS NOTED OTHERWISE.
- E. INTERIOR WALLS WHICH ARE EQUALLY SPACED ARE DIMENSIONED TO CENTERLINE OF WALL.
- F. DOORS NOT LOCATED BY DIMENSION SHALL BE CENTERED IN WALLS AS SHOWN ON PLANS OR LOCATED 4 1/2" FROM FACE OF FINISH TO OUTSIDE FACE OF FRAME.

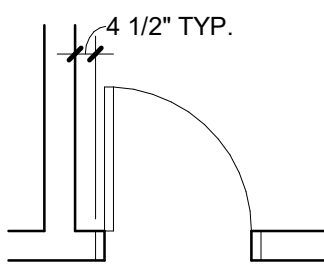

## GRAPHIC SYMBOLS

NORTH ARROW



GRID LINE




VERTICAL DATUM



ROOM NAME AND NUMBER



EXTERIOR ELEVATION

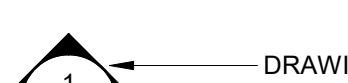

BUILDING SECTION / WALL SECTION



INTERIOR ELEVATION



DETAIL CALLOUT



DOOR NUMBER




CEILING HEIGHT



WALL / ASSEMBLY TYPE



FLOOR / FLOOR-CEILING ASSEMBLY [F-#]

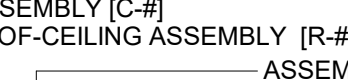

WINDOW TYPE



ACCESSORY / EQUIPMENT TYPE




CASEWORK TYPE




MATERIAL / FINISH




SPOT ELEVATION

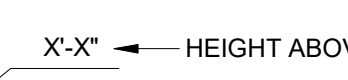

KEYNOTE

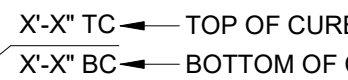

REVISION

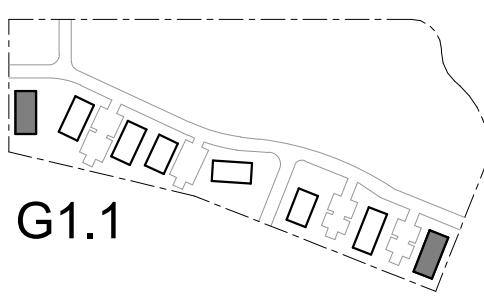

KEY PLAN

G1.2

## CDP SALEM - PHASE 2 - BUILDING G1




Job Number: 22047

PARCEL 3 & PARCEL 4 BATTLE CREEK SE SALEM, OR



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CONSTRUCTION

CDP SALEM -  
PHASE 2 -  
BUILDING G1

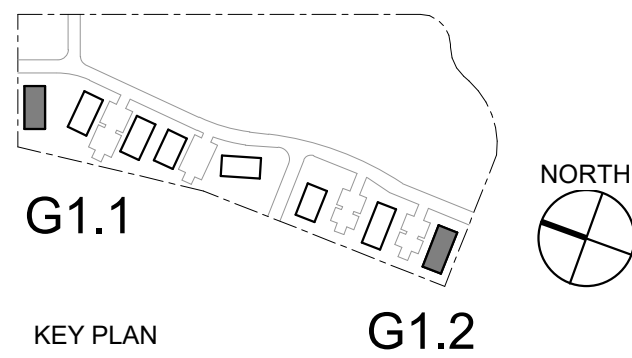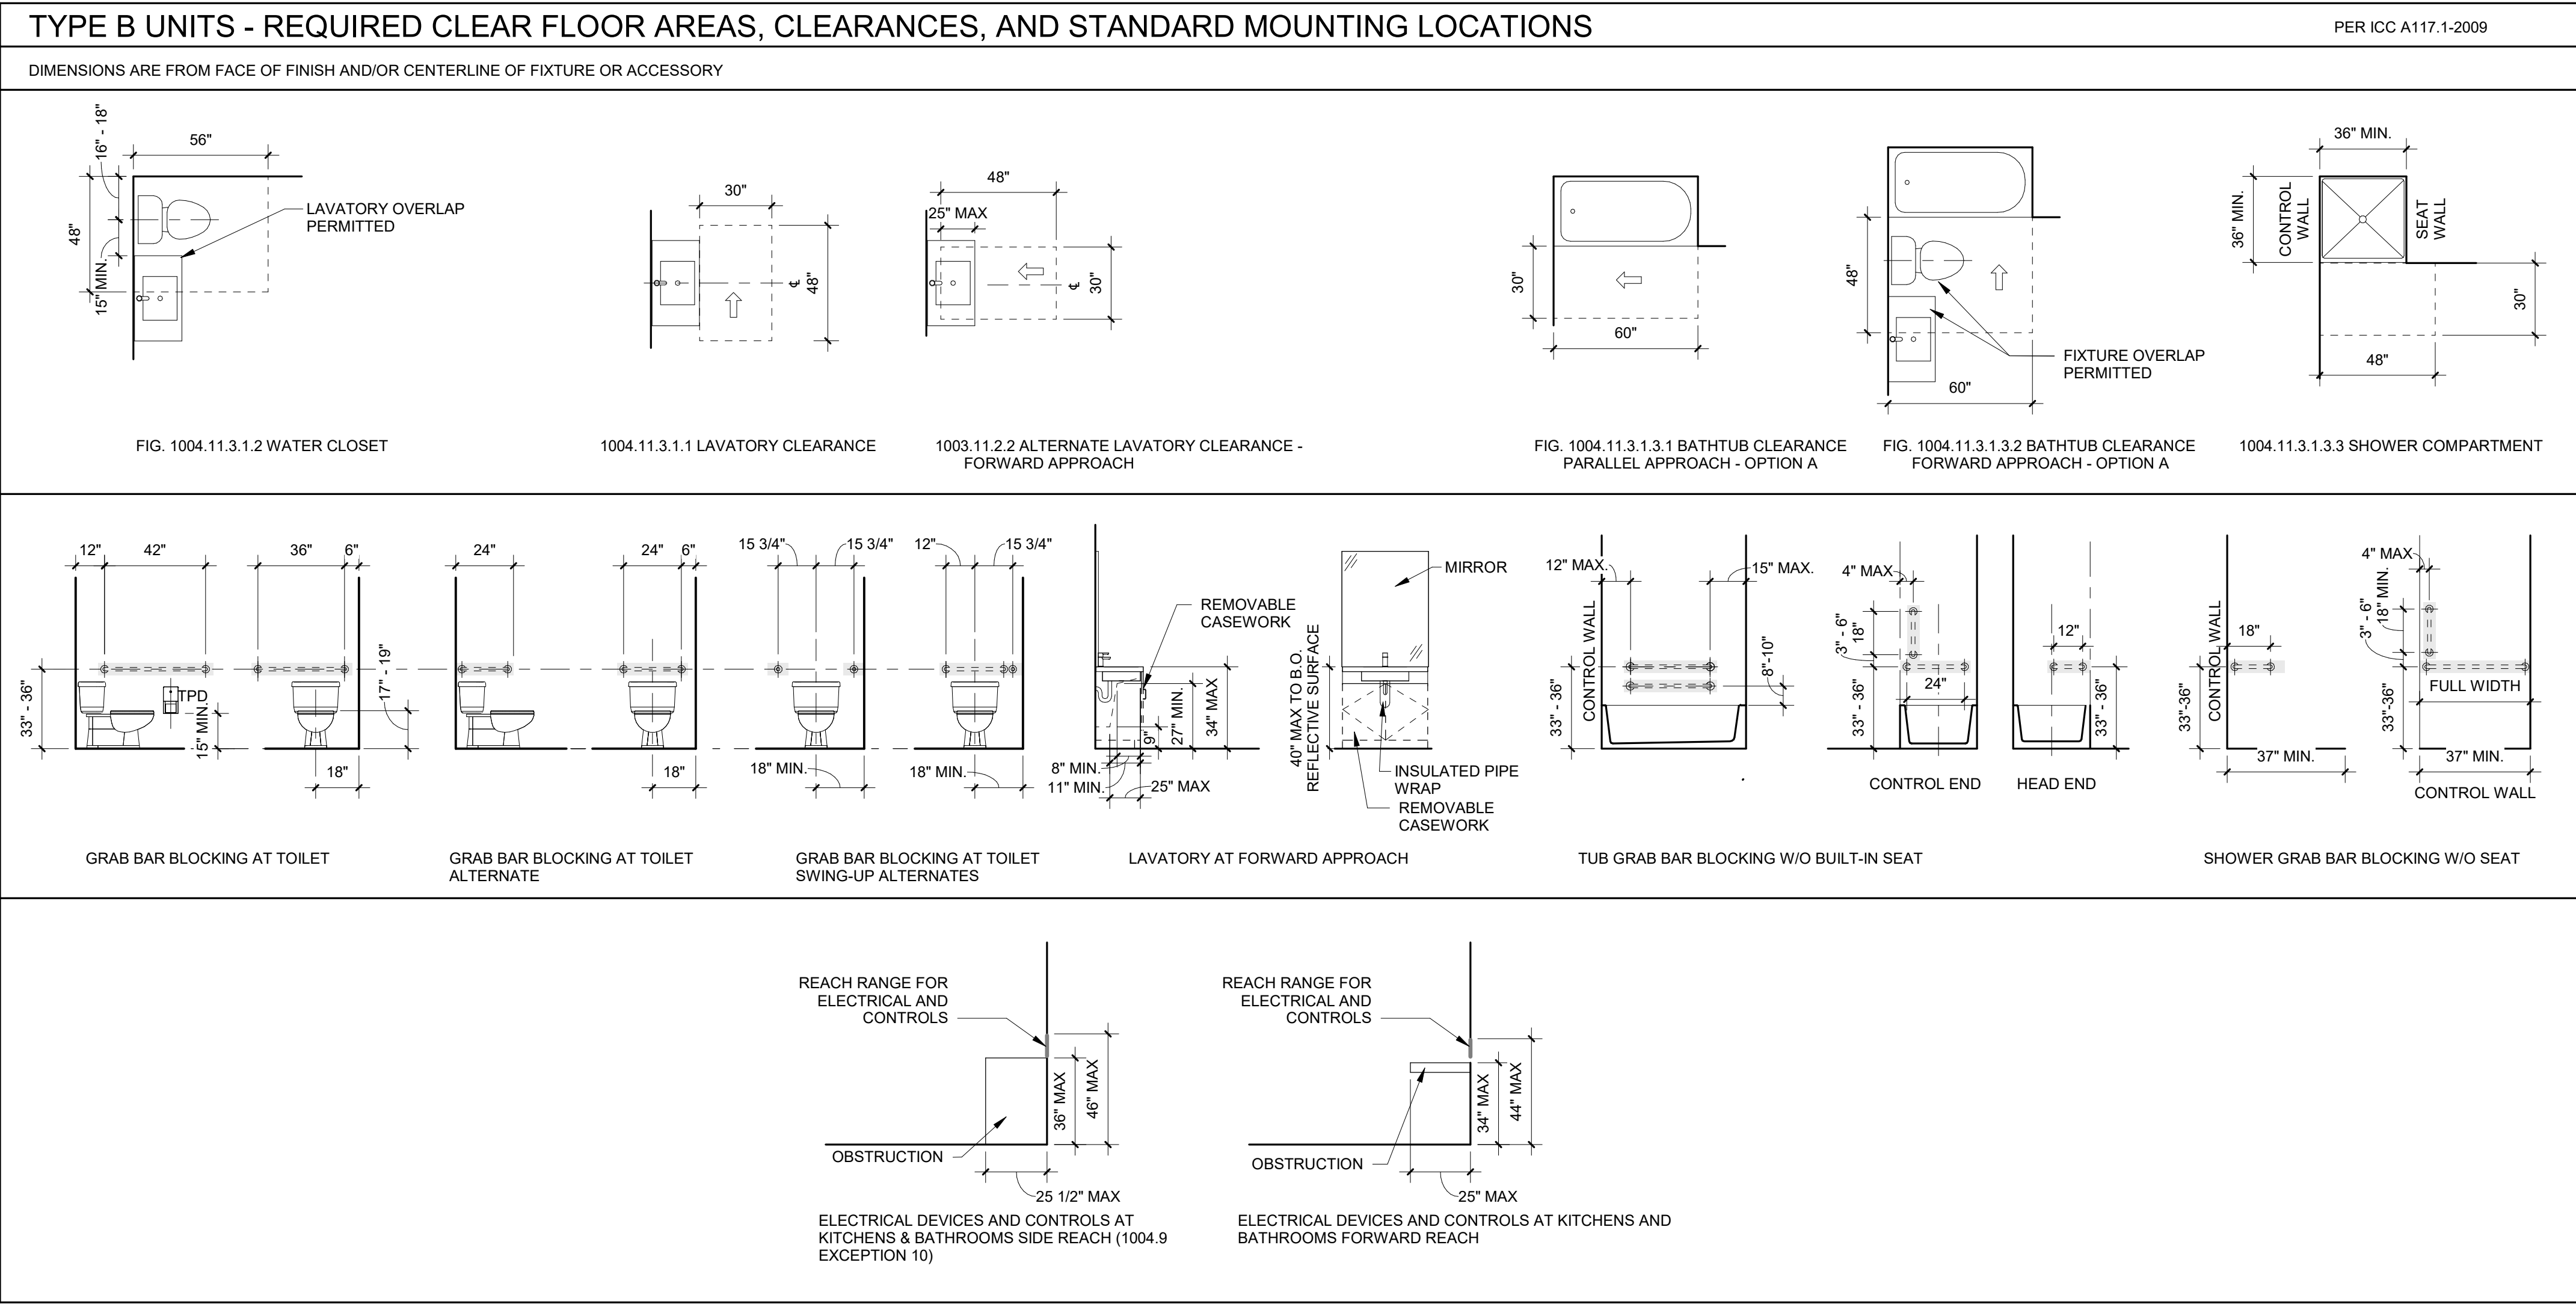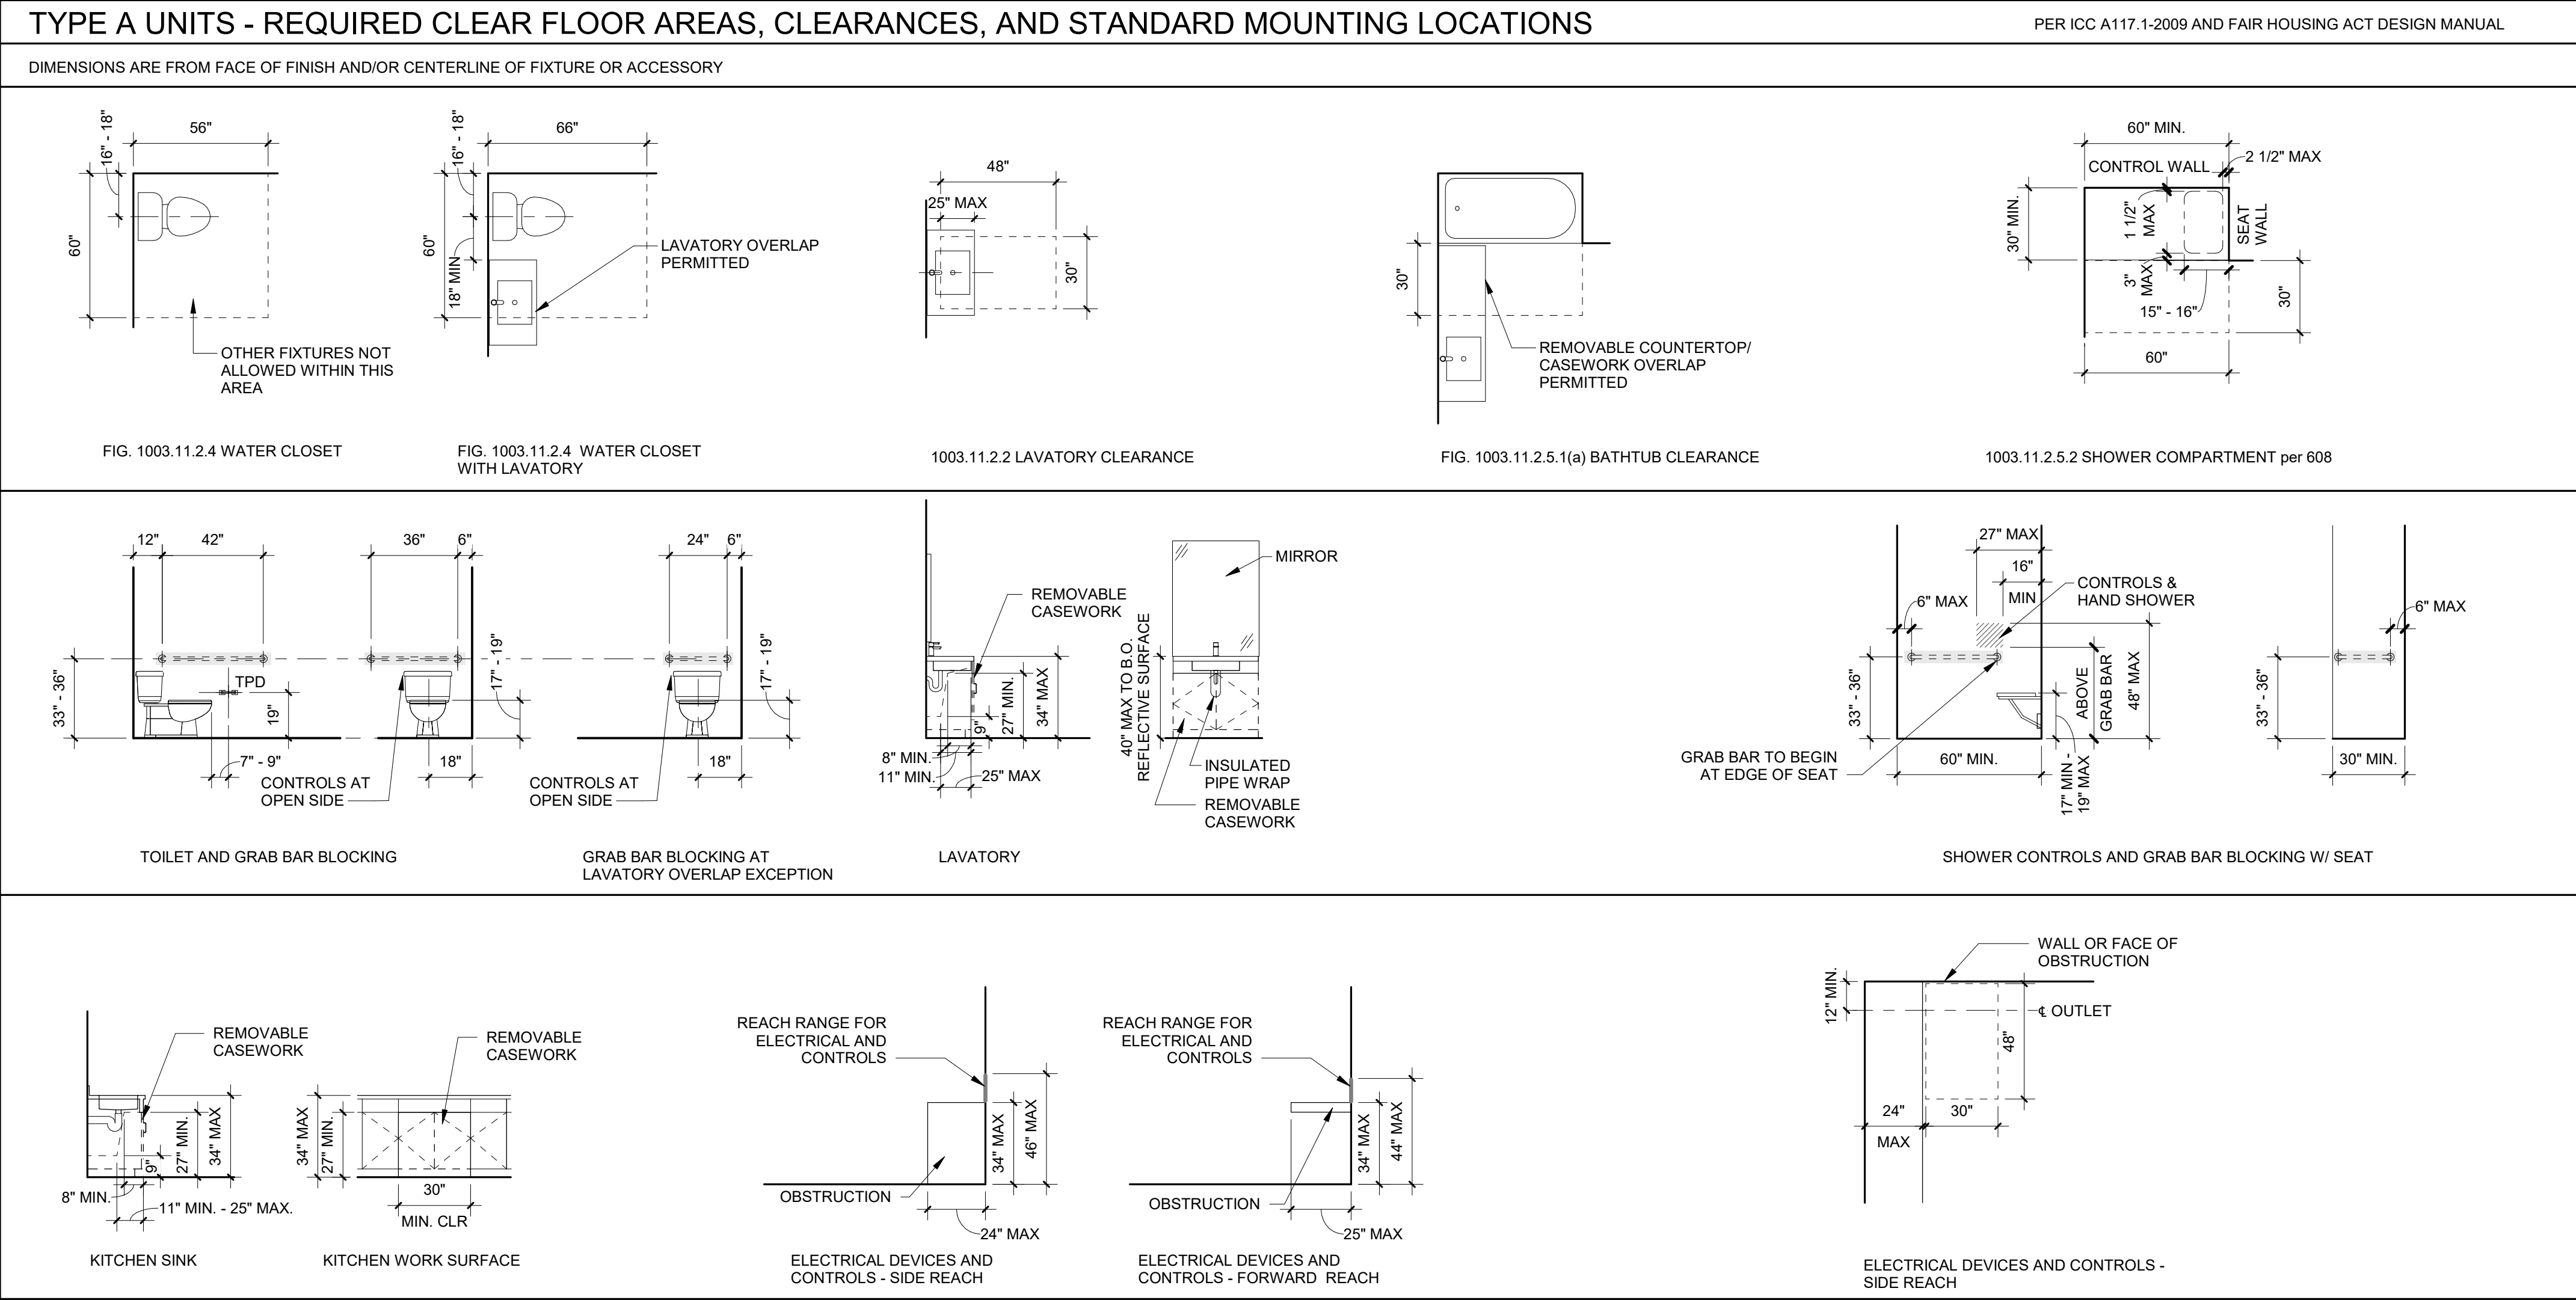
Job Number: 22047

PARCEL 3 & PARCEL 4  
BATTLE CREEK SE  
SALEM, OR




- GENERAL SHEET NOTES**
- A. WALL DIMENSIONS ARE FROM FACE OF STUD OR CL OF COLUMN UNO
- B. ALL EXTERIOR GRID LINES SHOWN ARE TO FACE OF SHEATHING UNO ALL INTERIOR GRID LINES ARE TO FACE OF STUD UNO
- C. ALL DOOR AND WINDOW DIMENSIONS ARE TO CL OF OVERALL UNIT. REFERENCE SCHEDULES AND DOOR AND WINDOW TYPES
- D. REFERENCE STRUCTURAL DRAWINGS FOR GENERAL CONTROL JOINTS @ SLAB. COORDINATE FINAL LOCATIONS WITH ARCHITECT FOR COMPATIBILITY WITH FLOOR FINISHES
- E. WIRE SHELVING IN ALL BEDROOM CLOSETS
- F. MEP INFORMATION PROVIDED FOR REFERENCE ONLY. SEE MEP DRAWINGS
- G. PROVIDE BLOCKING FOR FUTURE GRAB BARS AT ALL GROUND FLOOR UNIT RESTROOMS WHERE GRAB BARS ARE NOT SHOWN IN PLAN. REF ACCESSIBILITY DIAGRAMS FOR LOCATIONS
- H. FIRE EXTINGUISHER TO BE PLACED IN PANTRY IN ALL UNITS
- I. DOWNSPOUTS PAINTED IN FIELD, RECTANGLE SHAPE AND SIZE PER PLUMBING AND CIVIL
- J. UNIT DEMISING WALLS TYPE IW3-6, UNO
- K. UNIT INTERIOR WALLS TYPE IW1-4 UNO


LEGEND	
	1 HOUR RATED ASSEMBLY
	.5 HOUR RATED ASSEMBLY
	ELEMENT ABOVE
	R-1 ASPHALT SHINGLE ROOF
	DS 2x3 FLAT STYPE DOWNSPOUT
	FD FLOOR DRAIN
	WH WATER HEATER WITH FLOOR DRAIN BELOW - SEE PLUMBING DWGS
	WASHER DRYER UNIT NIG, PROVIDE CONNECTIONS
	RIDGE VENT, SEE ROOF VENTILATION DIAGRAM
	ROOF INTAKE VENT, SEE ROOF VENTILATION DIAGRAM
	PROVIDE (2) LAYERS OF UNDERLAYMENT AT LOW SLOPE ROOF PER MFR

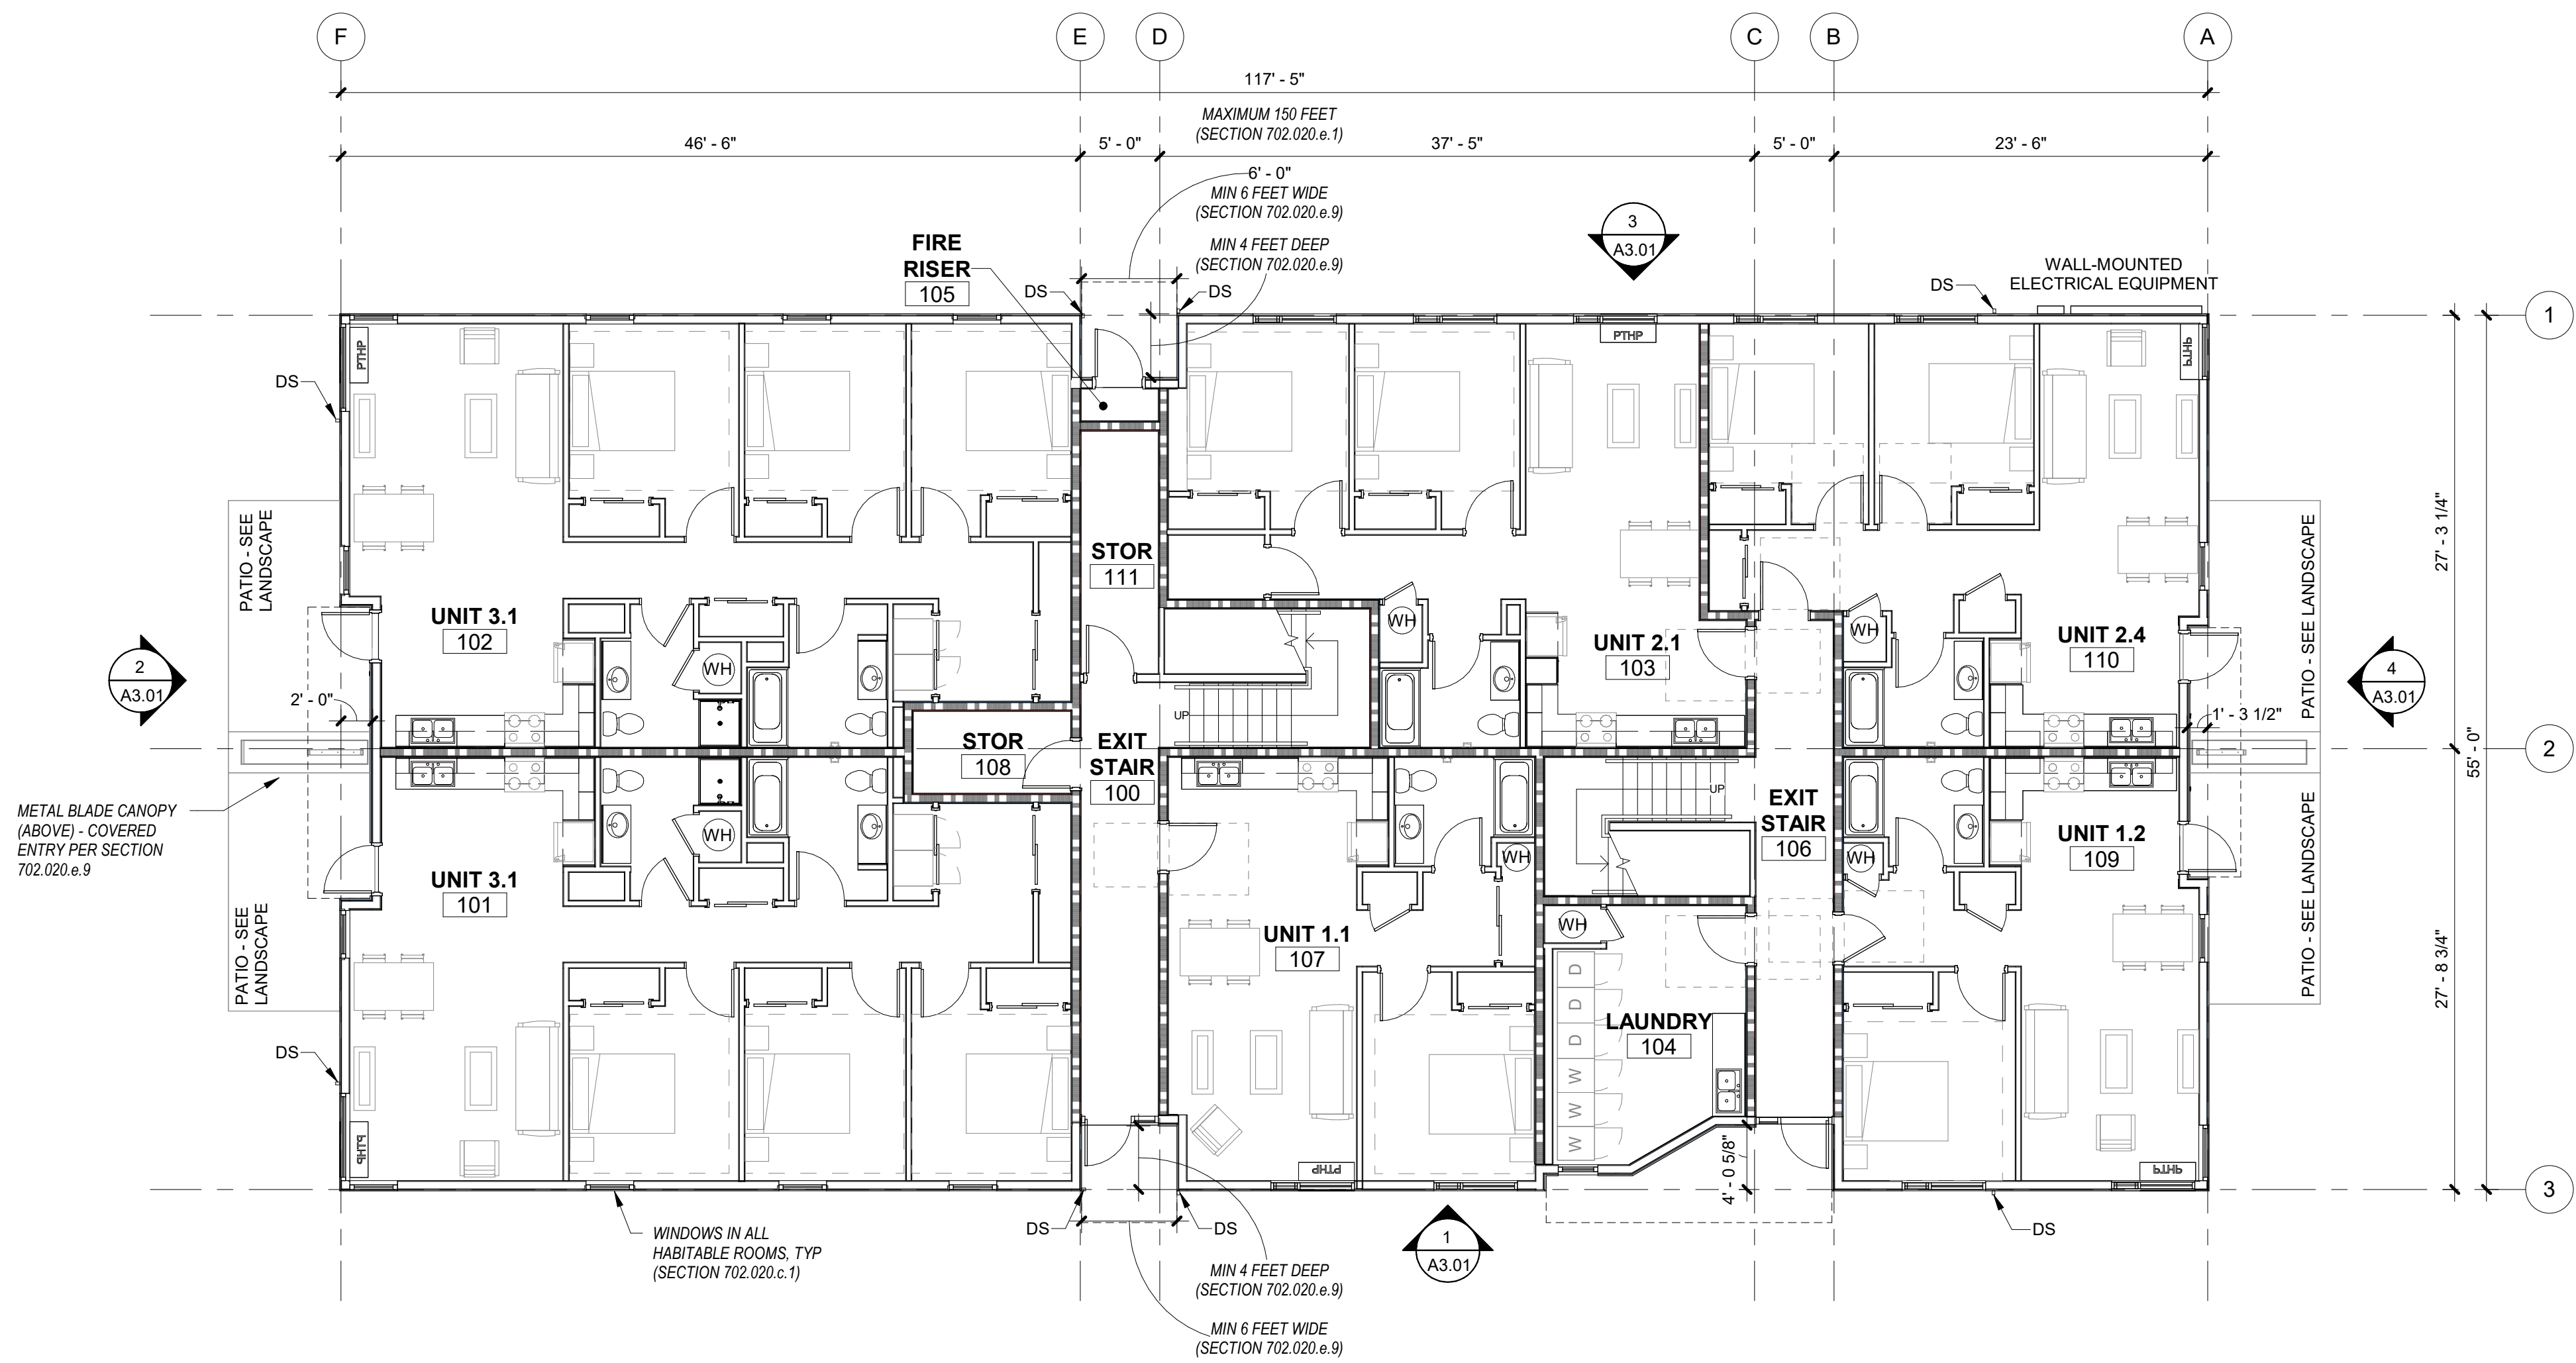

1 FIRST FLOOR PLAN  
1/8" = 1'-0"

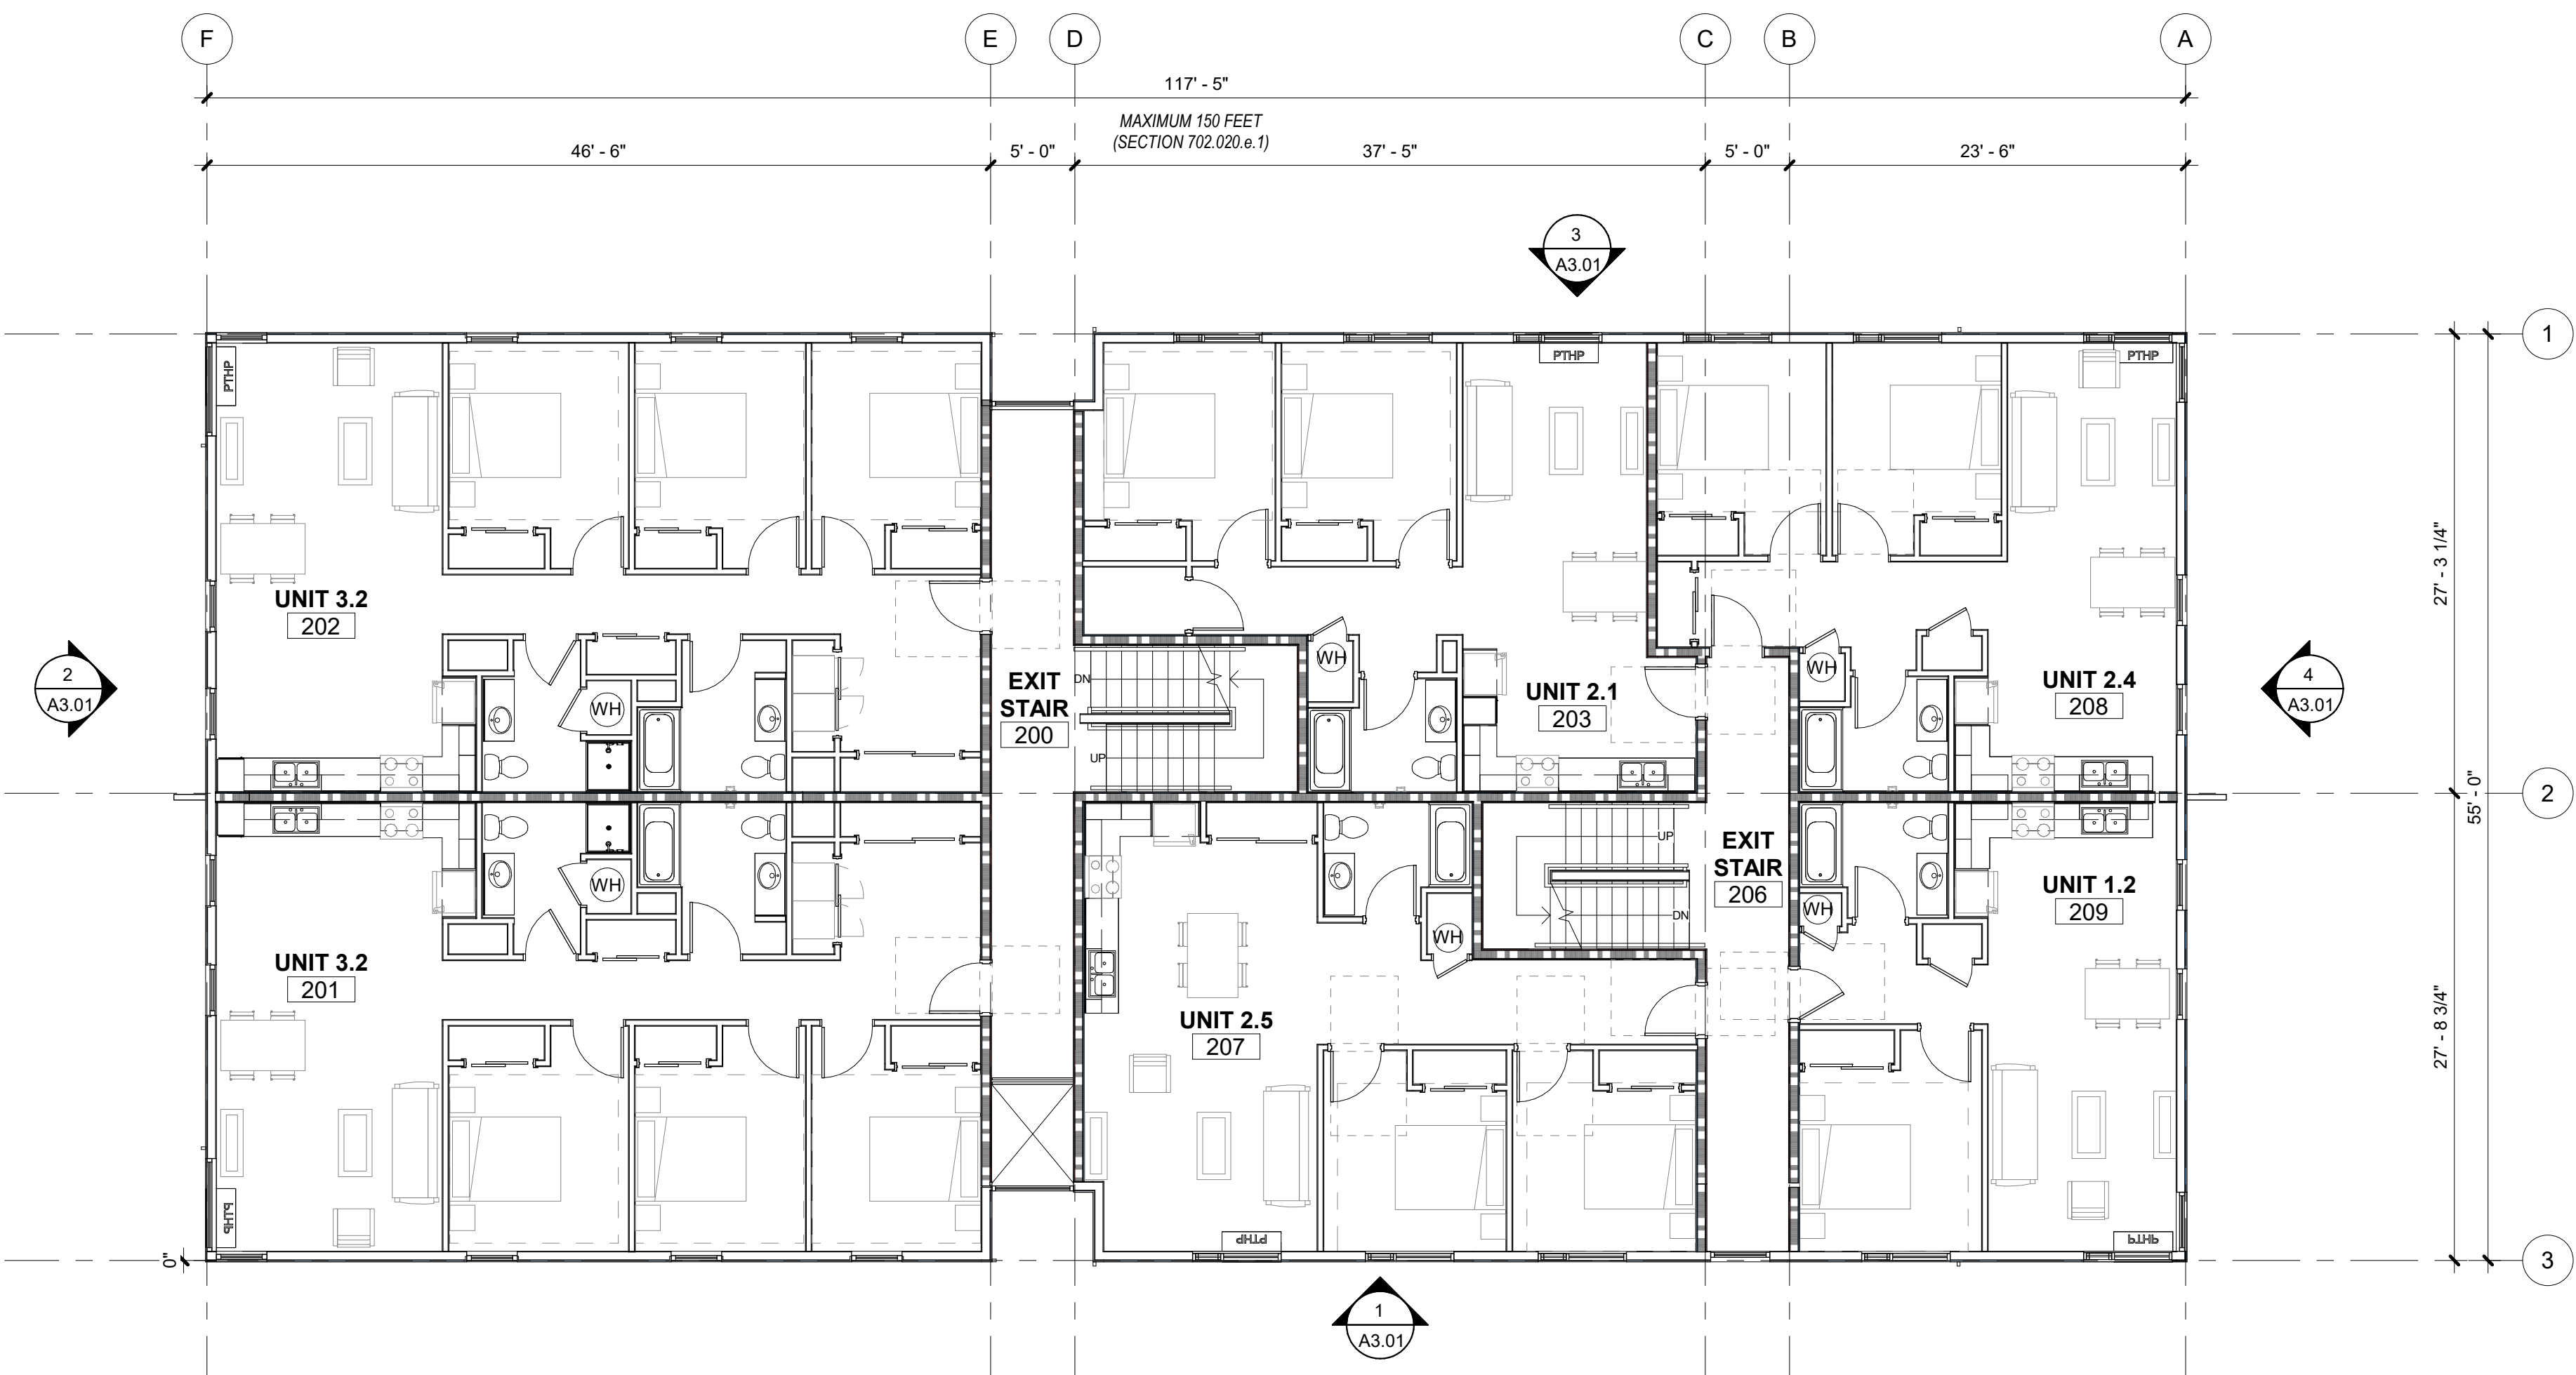

2 SECOND FLOOR PLAN  
1/8" = 1'-0"

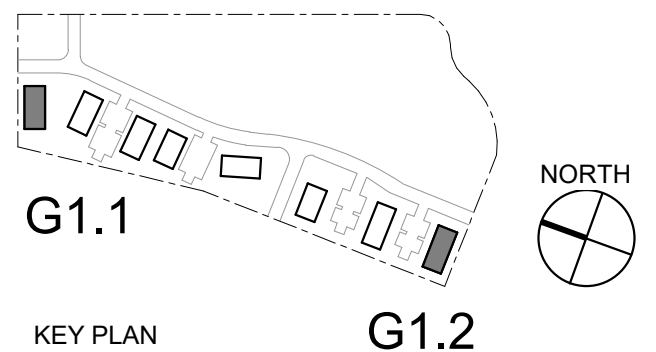

LAND USE SUBMISSION 08.08.22

ISSUE DATE

Drawing:  
FIRST FLOOR AND SECOND FLOOR PLAN

Sheet No:  
A2.11



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CONSTRUCTION

CDP SALEM -  
PHASE 2 -  
BUILDING G1

Job Number: 22047

PARCEL 3 & PARCEL 4  
BATTLE CREEK SE  
SALEM, OR



#### GENERAL SHEET NOTES

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- FIRE EXTINGUISHER TO BE PLACED IN PANTRY IN ALL UNITS
- DOWNSPOUTS PAINTED IN FIELD. RECTANGLE SHAPE AND SIZE PER PLUMBING AND CIVIL
- UNIT DEMISING WALLS TYPE IW3-6, UNO
- UNIT INTERIOR WALLS TYPE IW1-4 UNO

#### GENERAL SHEET NOTES


- REFERENCE MECHANICAL, PLUMBING, AND ELECTRICAL DRAWINGS FOR ADDITIONAL ROOF PENETRATIONS NOT SHOWN HERE
- REFERENCE SHEET A4 FOR TYPICAL ROOF DETAILS NOT FLAGGED HERE
- MINIMUM SLOPE OF CRICKETS TO BE 1/4" PER FT UNLESS NOTED OTHERWISE. CONTRACTOR TO PROVIDE ALL CRICKETS REQD TO PROVIDE POSITIVE DRAINAGE TO DRAINS

#### LEGEND

REF A0.01 FOR GENERAL LEGENDS

- |  |  |
|--|--|
|  | 1 HOUR RATED ASSEMBLY  |
|  | .5 HOUR RATED ASSEMBLY                                       |
|  | ELEMENT ABOVE  |
|  | ASPHALT SHINGLE ROOF   |
|  | 2x3 FLAT STYPE DOWNSPOUT                                     |
|  | FLOOR DRAIN  |
|  | WATER HEATER WITH FLOOR DRAIN BELOW - SEE PLUMBING DWGS      |
|  | WASHER DRYER UNIT N.C. PROVIDE CONNECTIONS                   |
|  | RIDGE VENT. SEE ROOF VENTILATION DIAGRAM                     |
|  | ROOF INTAKE VENT. SEE ROOF VENTILATION DIAGRAM               |
|  | PROVIDE (2) LAYERS OF UNDERLAYMENT AT LOW SLOPE ROOF PER MFR |

SEE MECHANICAL DRAWINGS FOR LOCATION OF MECHANICAL UNITS AND ROOF PENETRATIONS

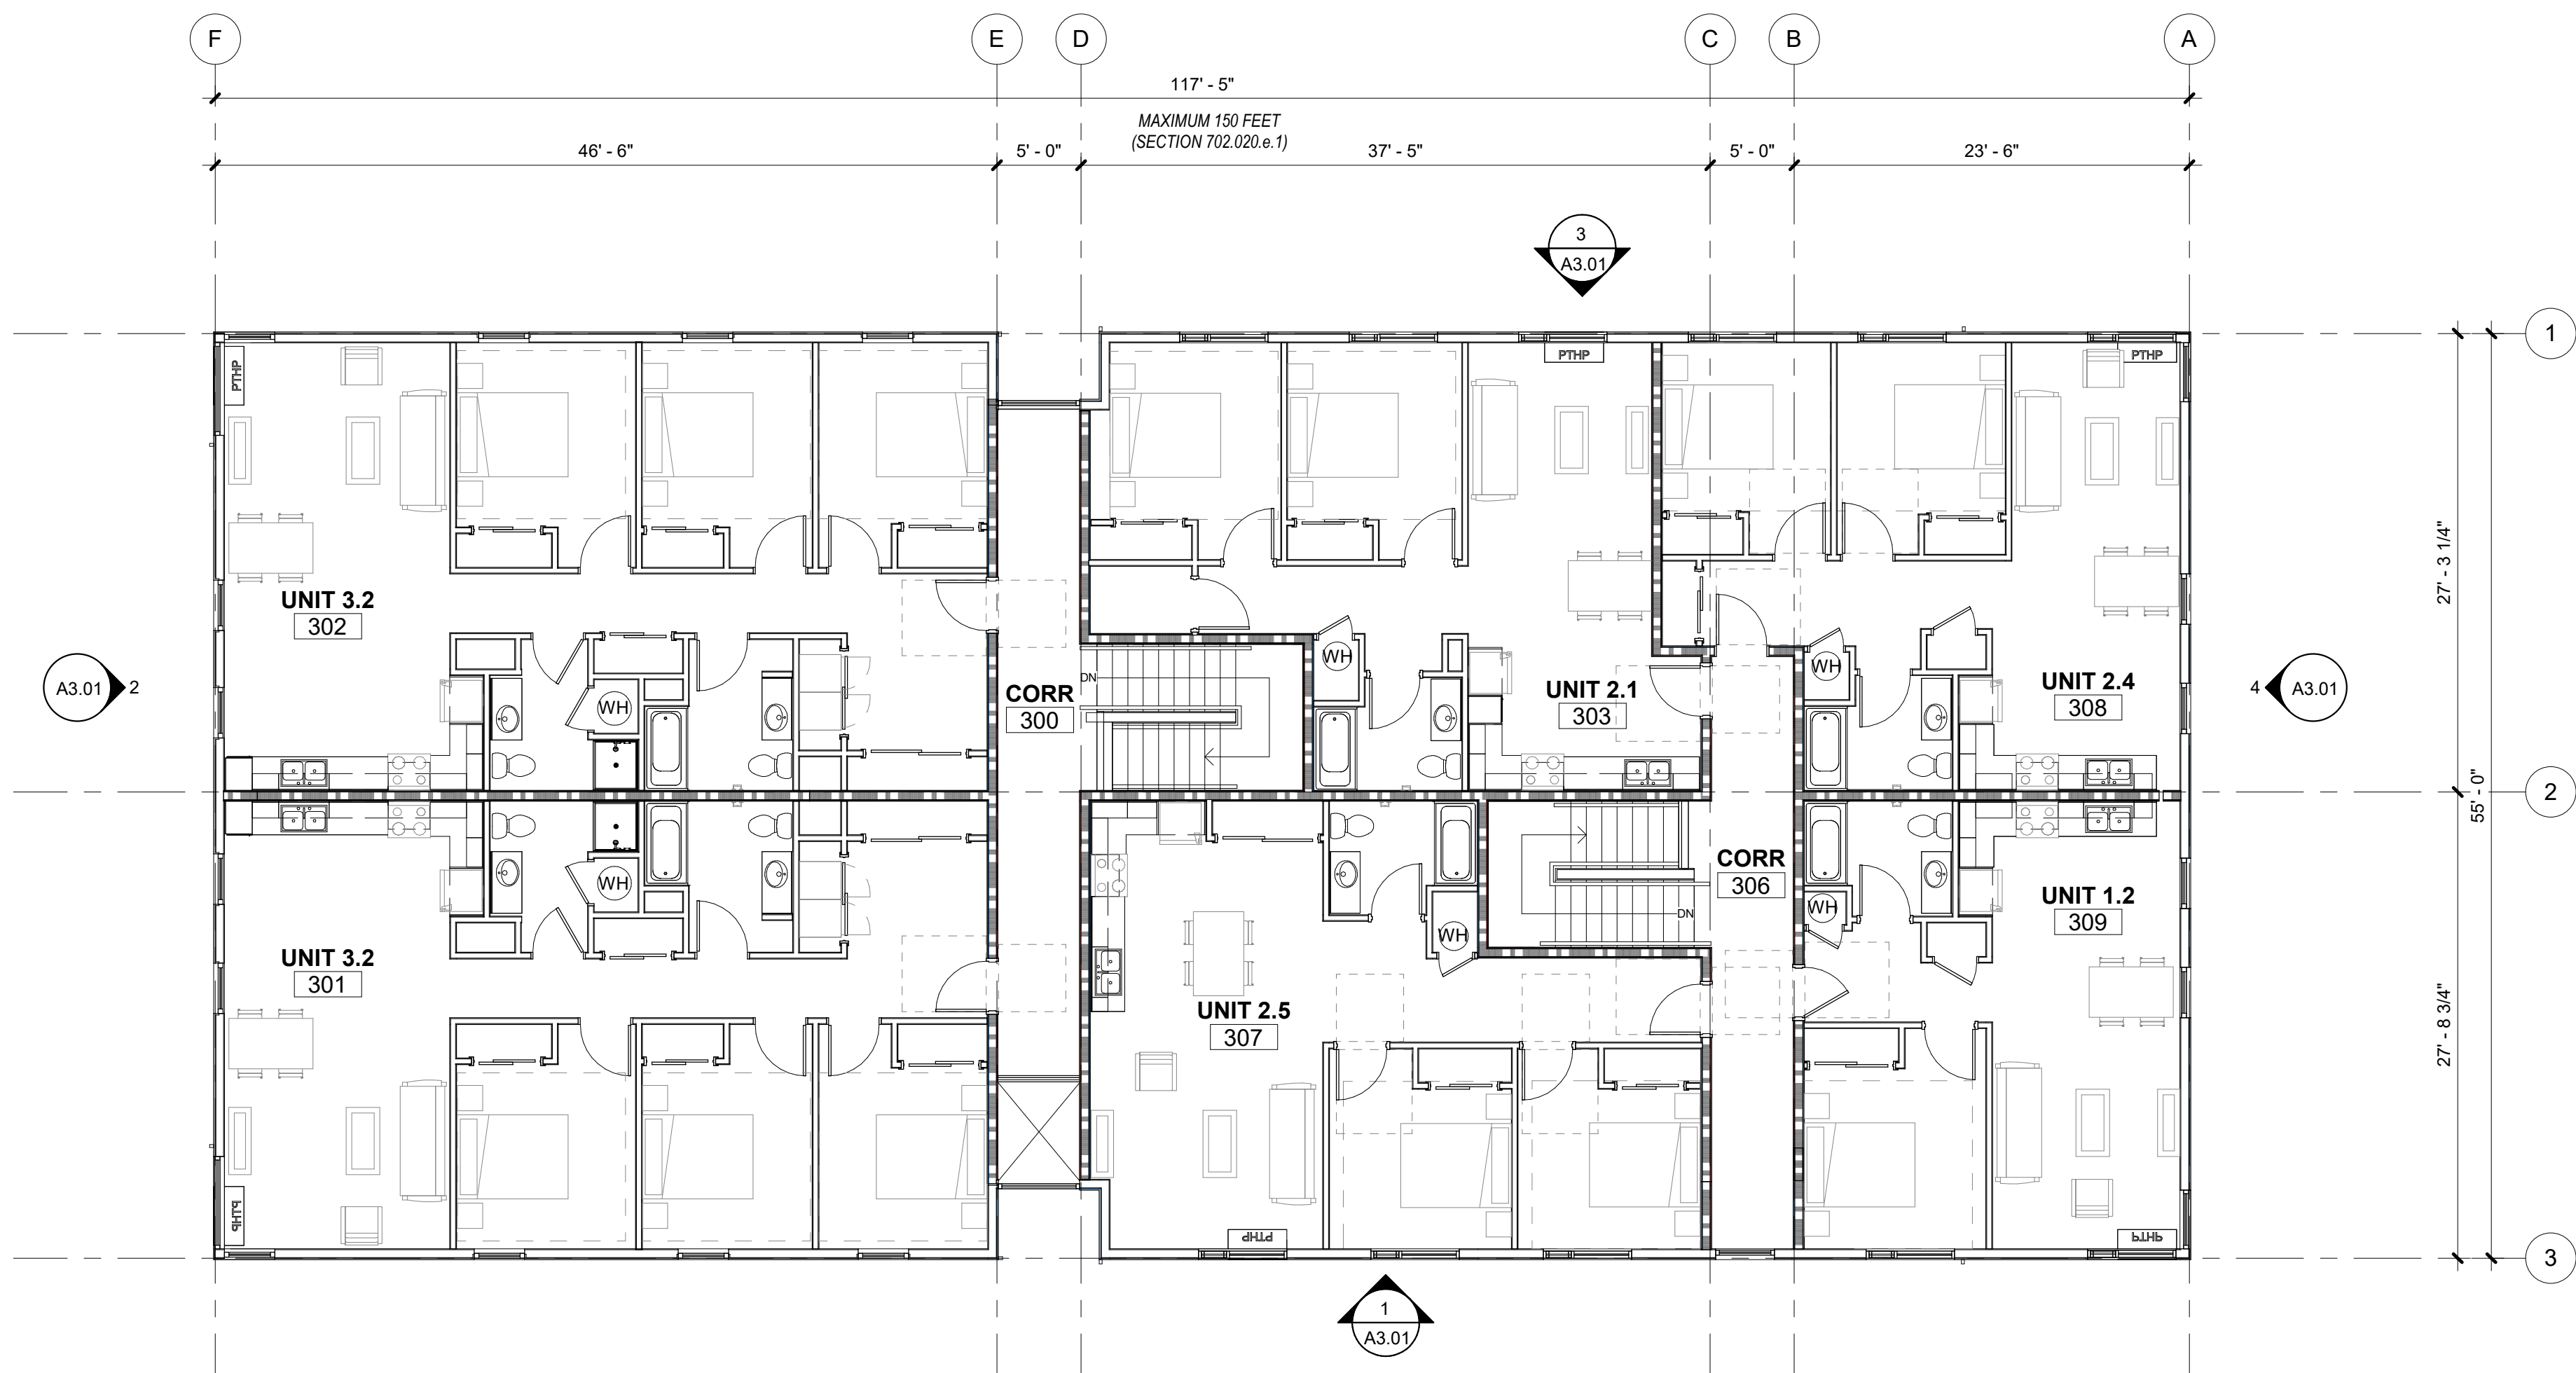



NOT FOR  
CONSTRUCTION

CDP SALEM -  
PHASE 2 -  
BUILDING G1

Job Number: 22047

PARCEL 3 & PARCEL 4  
BATTLE CREEK SE  
SALEM, OR




#### GENERAL SHEET NOTES


- REFERENCE FLOOR PLANS FOR DOOR AND WINDOW LOCATIONS.
- REFERENCE ELECTRICAL FOR EXTERIOR LIGHT APPLICATIONS.
- CONFIRM ALL EXHAUST OPENINGS ARE MINIMUM 3'-0" FROM OPERABLE OPENINGS.
- ALL EXTERIOR LOUVERS TO BE PAINTED TO MATCH THE EXTERIOR FINISH IT PENETRATES.
- PREFINISHED 22 GAUGE FORMED SHEET METAL WINDOW TRIM, JAMB, AND SILL AT WINDOWS.
- PREFINISHED 22 GAUGE METAL THROUGH WALL FLASHING AT WINDOW HEADS.
- TRANSITION BETWEEN FIBER CEMENT SIDING PROFILES TO FOLLOW MANUFACTURER DETAILING AND REQUIREMENTS.

#### LEGEND


- |  |  |
|--|--|
|  | <b>LAP SIDING LIGHT</b><br>PRODUCT: FIBER CEMENT SHIPLAP SIDING<br>COLOR: TBD              |
|  | <b>LAP SIDING DARK</b><br>PRODUCT: FIBER CEMENT SHIPLAP SIDING<br>COLOR: TBD               |
|  | <b>PANEL SIDING</b><br>PRODUCT: FIBER CEMENT PANEL<br>COLOR: TBD                           |
|  | <b>ASPHALT SHINGLE ROOF</b><br>PRODUCT: TBD<br>COLOR: TBD                                  |
|  | <b>VERTICAL WOOD SIDING</b><br>PRODUCT: TBD<br>FINISH: TBD                                 |
|  | <b>ARCH PTHP LOUVER LIGHT</b><br>PRODUCT: TBD<br>COLOR: MATCH S-1                          |
|  | <b>ARCH PTHP LOUVER DARK</b><br>PRODUCT: TBD<br>COLOR: MATCH S-2                           |
|  | <b>CONCRETE STEM WALL</b>  |
|  | 3'-0" MIN<br>MECHANICAL EXHAUST VENT. SEE MECHANICAL DRAWINGS. PROVIDE 3'-0" MIN CLEARANCE |
|  | MECHANICAL INTAKE VENT. SEE MECHANICAL DRAWINGS  |
|  | PTHP (BEYOND)  |

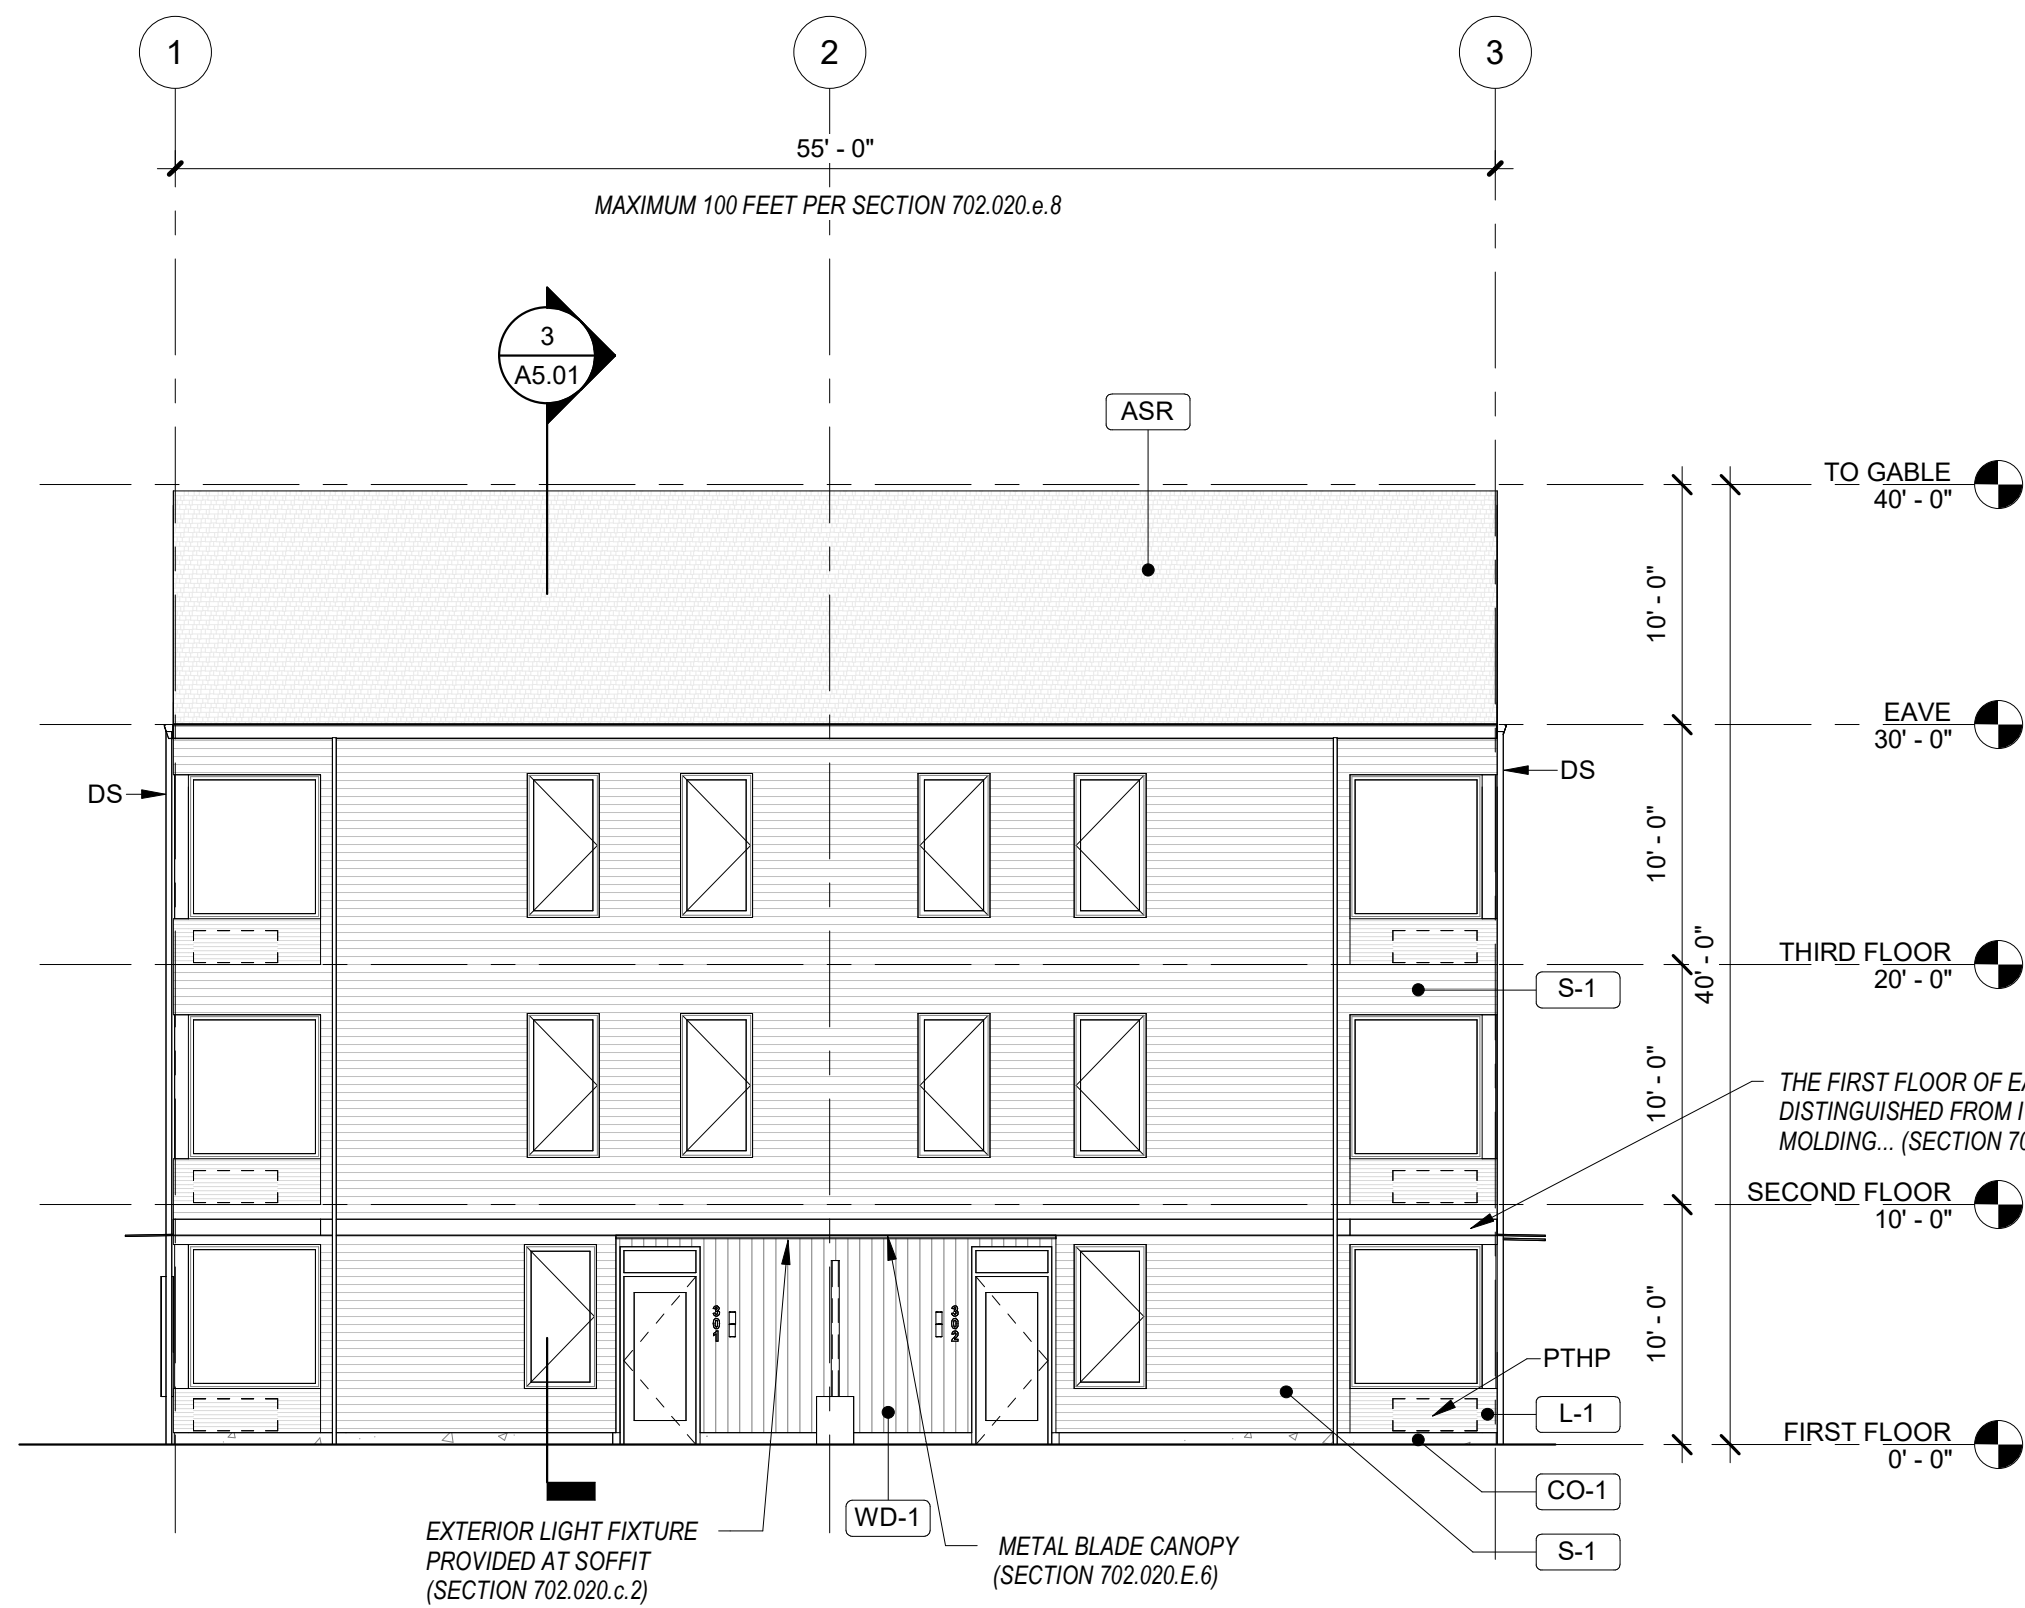


**ELEVATION 2**  
1/8" = 1'-0"

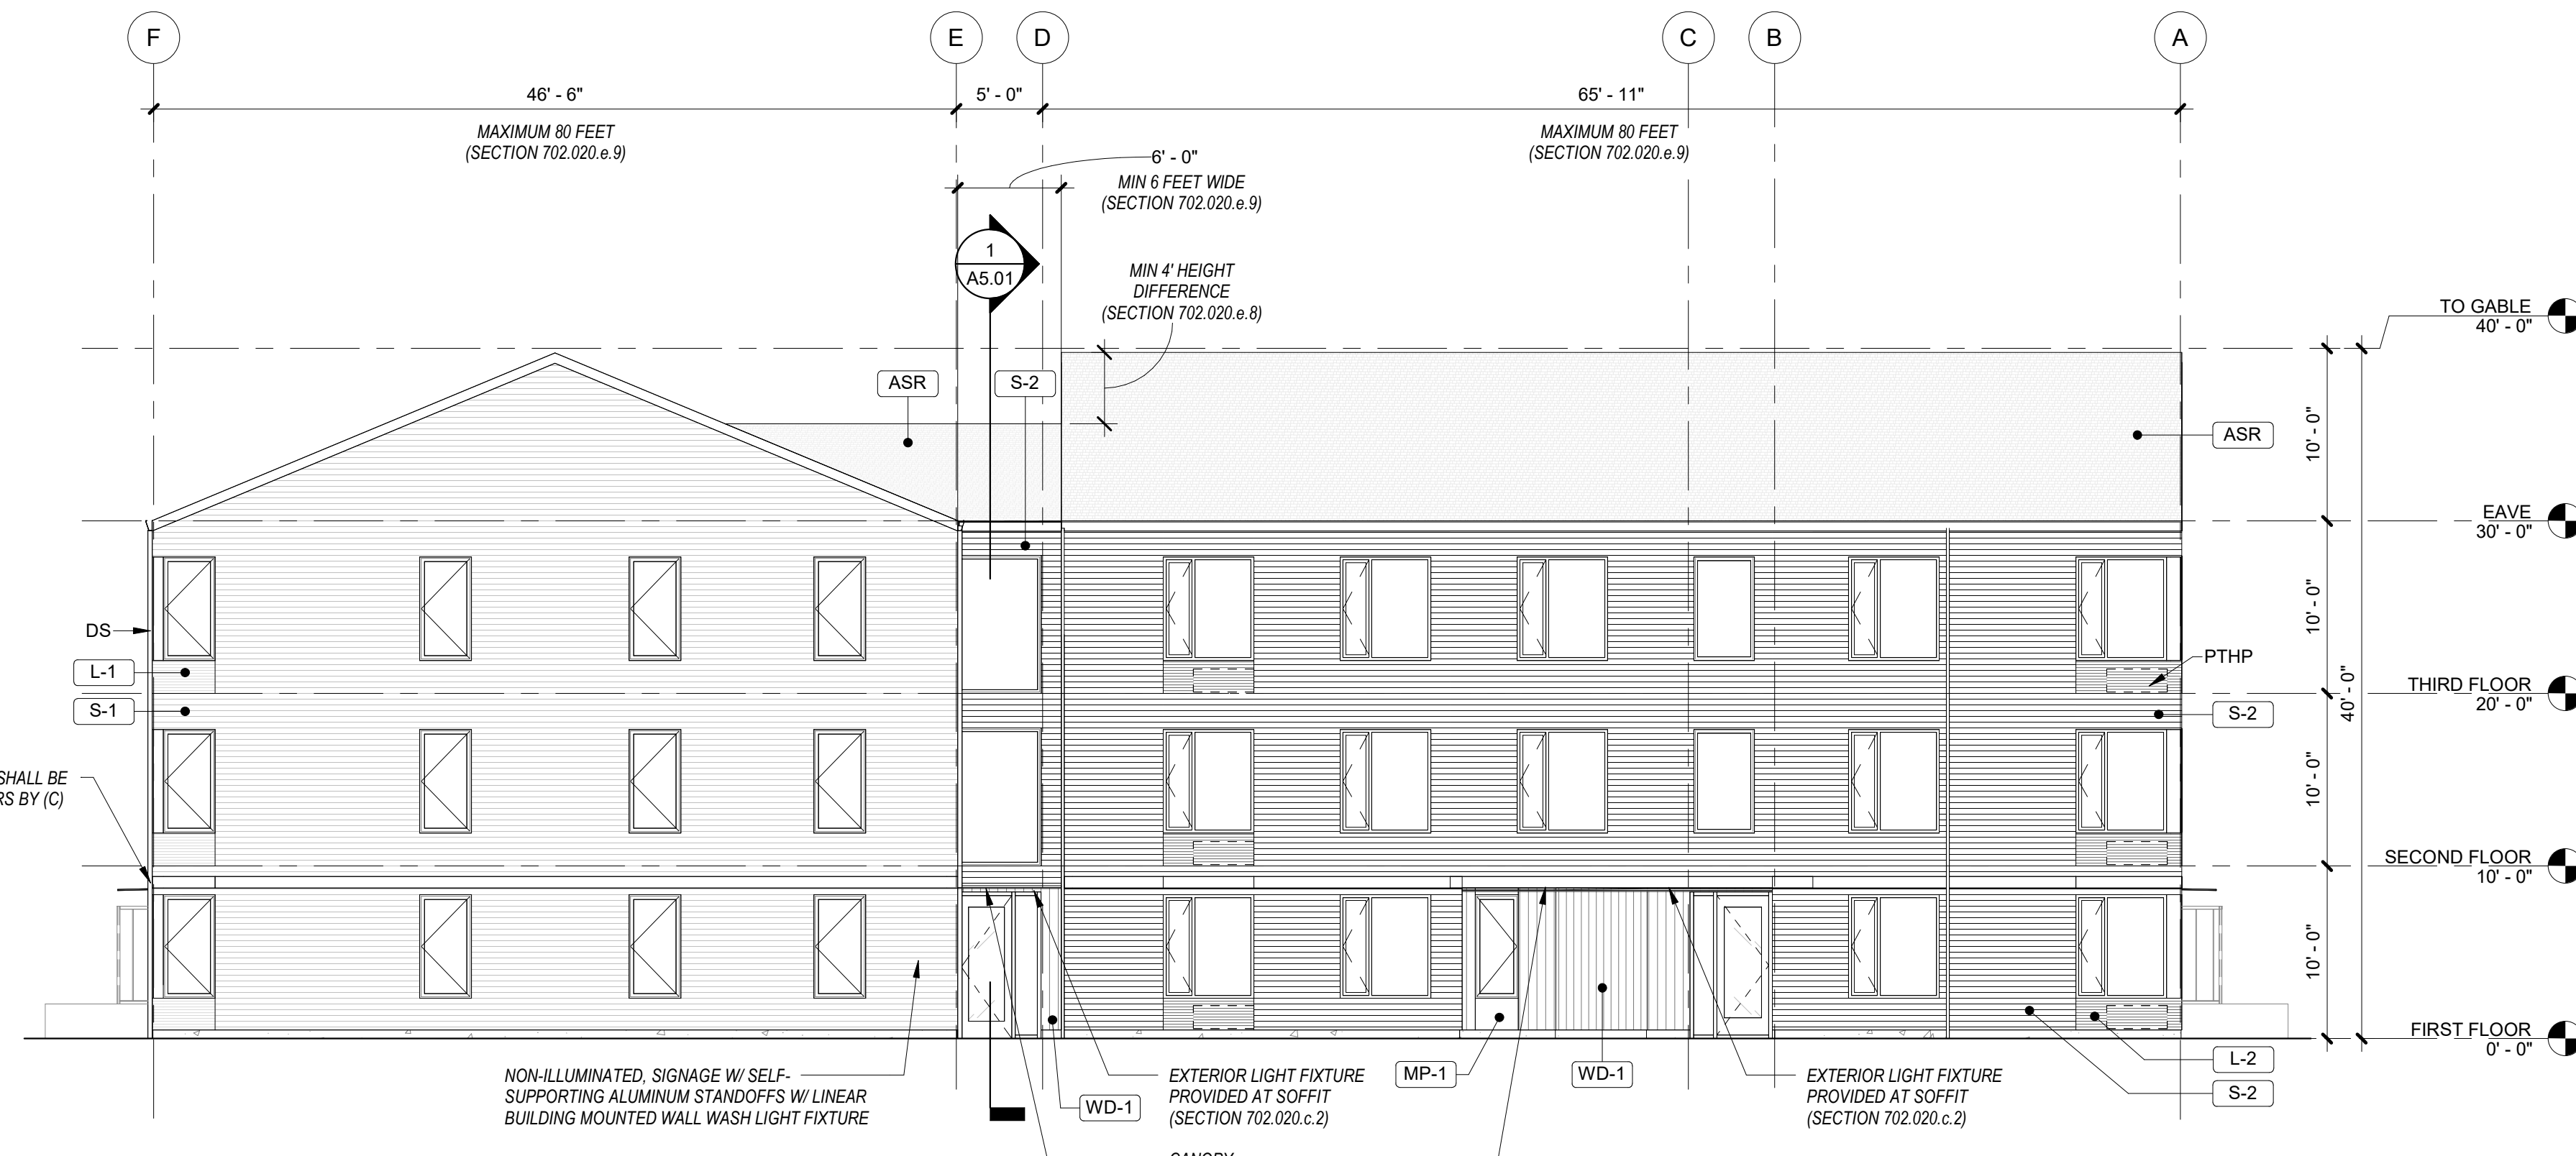

**ELEVATION 1**  
1/8" = 1'-0"

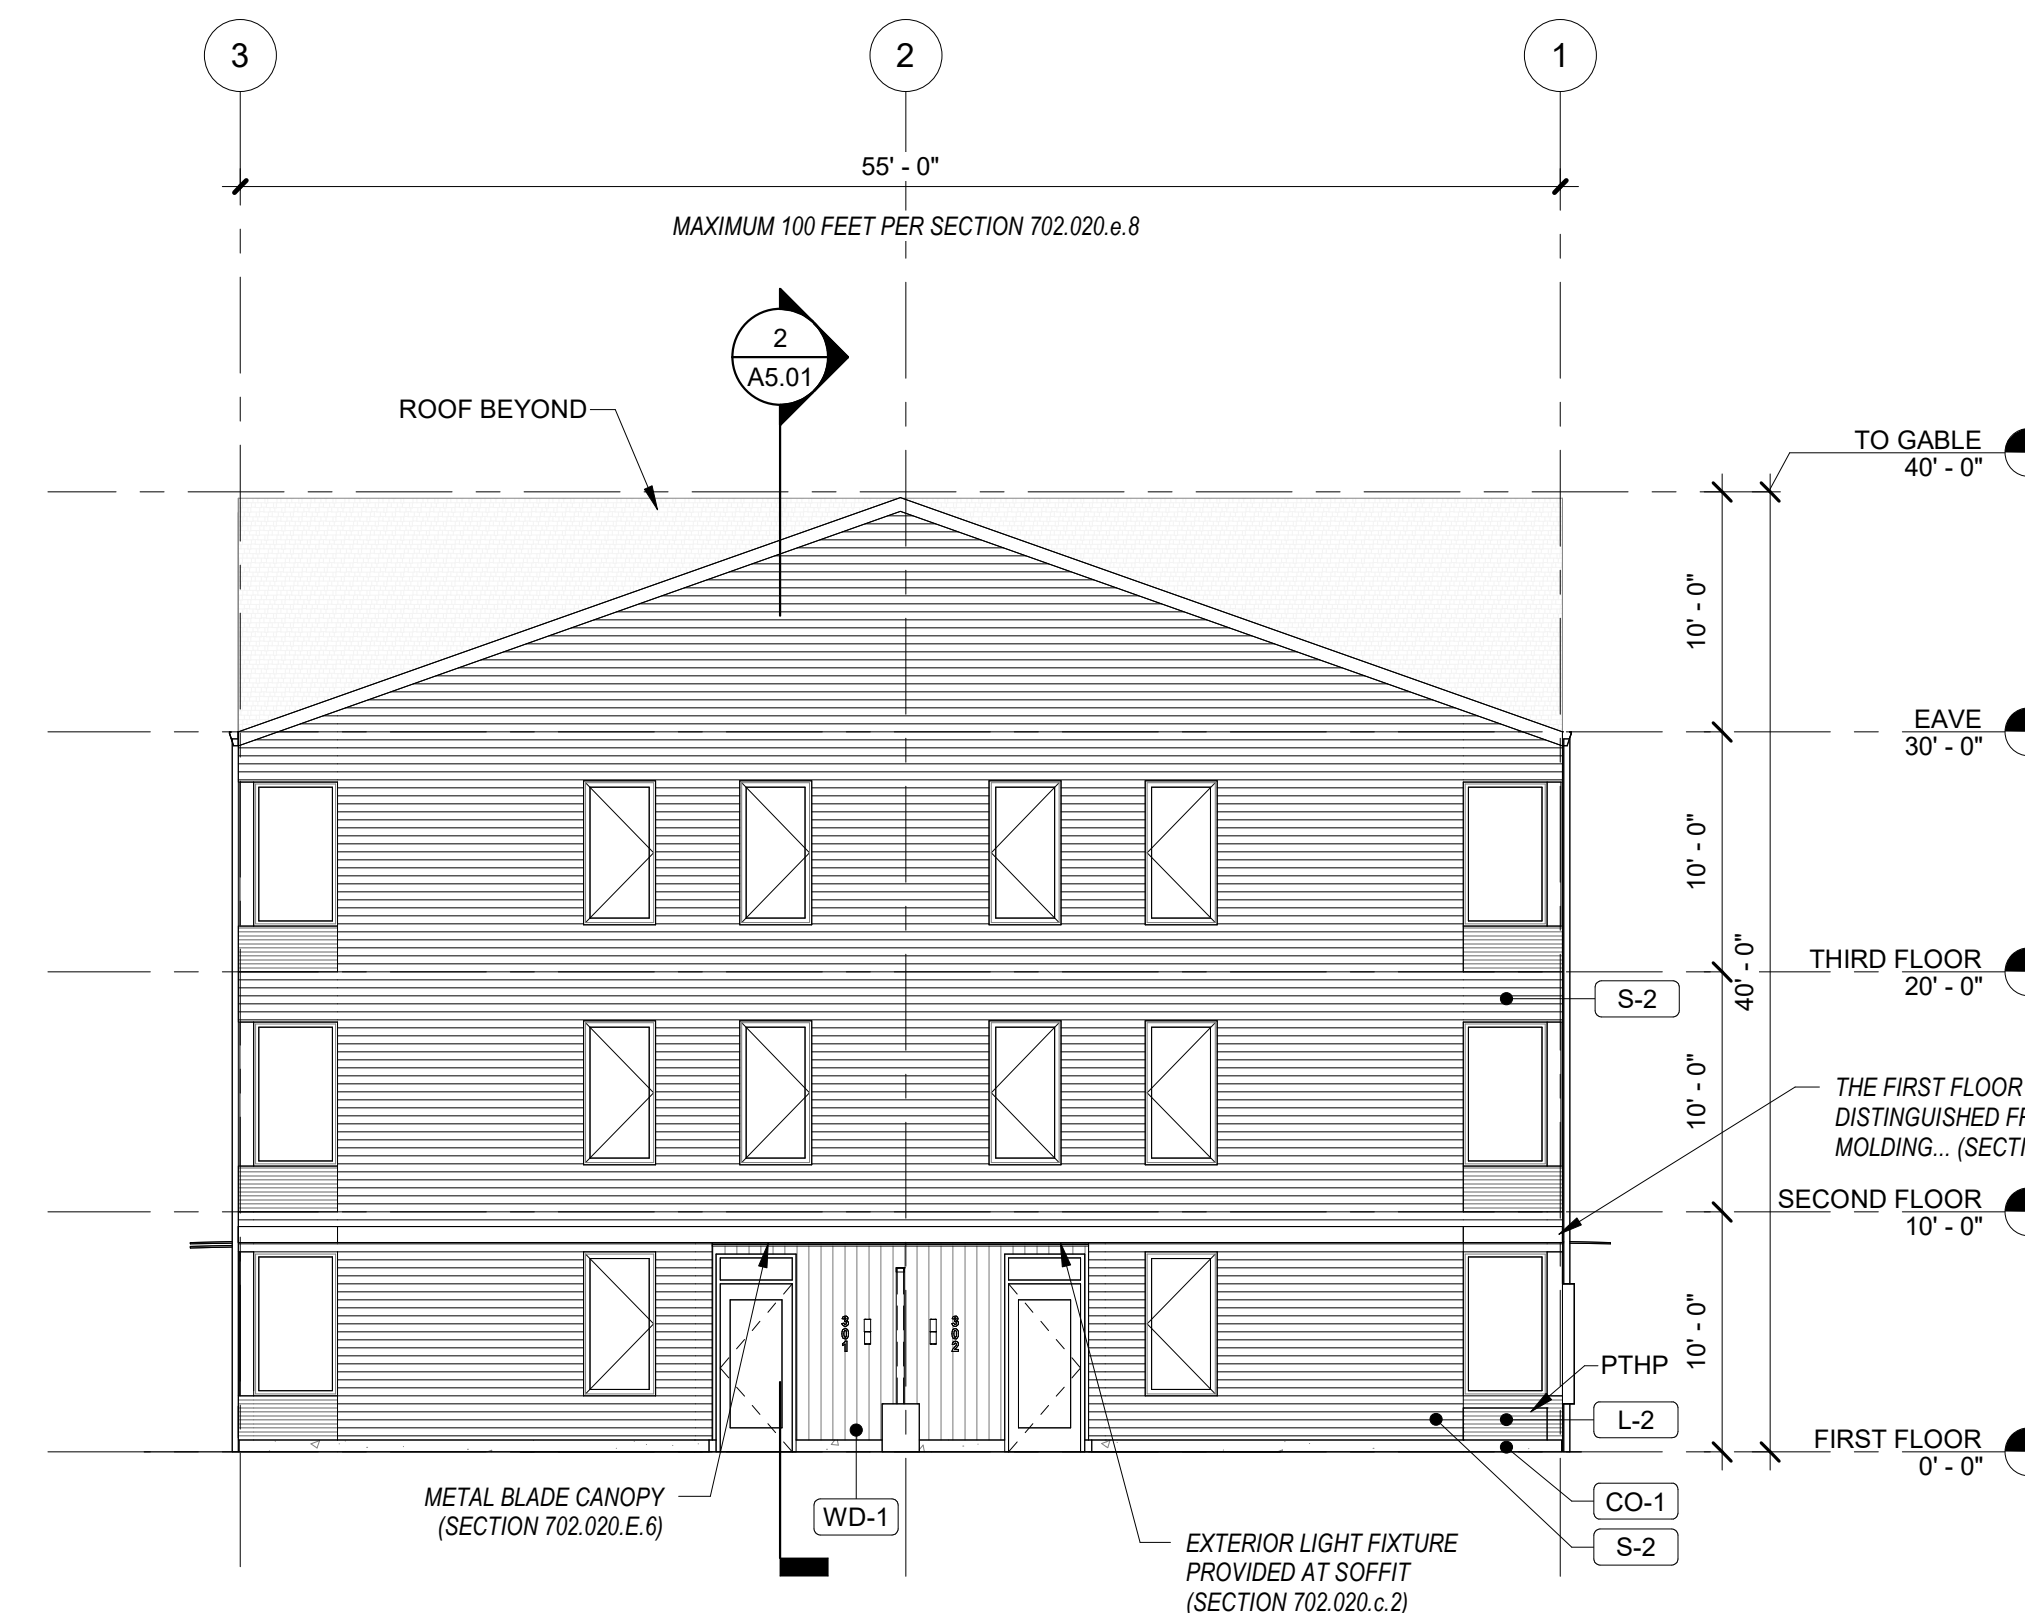

**ELEVATION 4**  
1/8" = 1'-0"

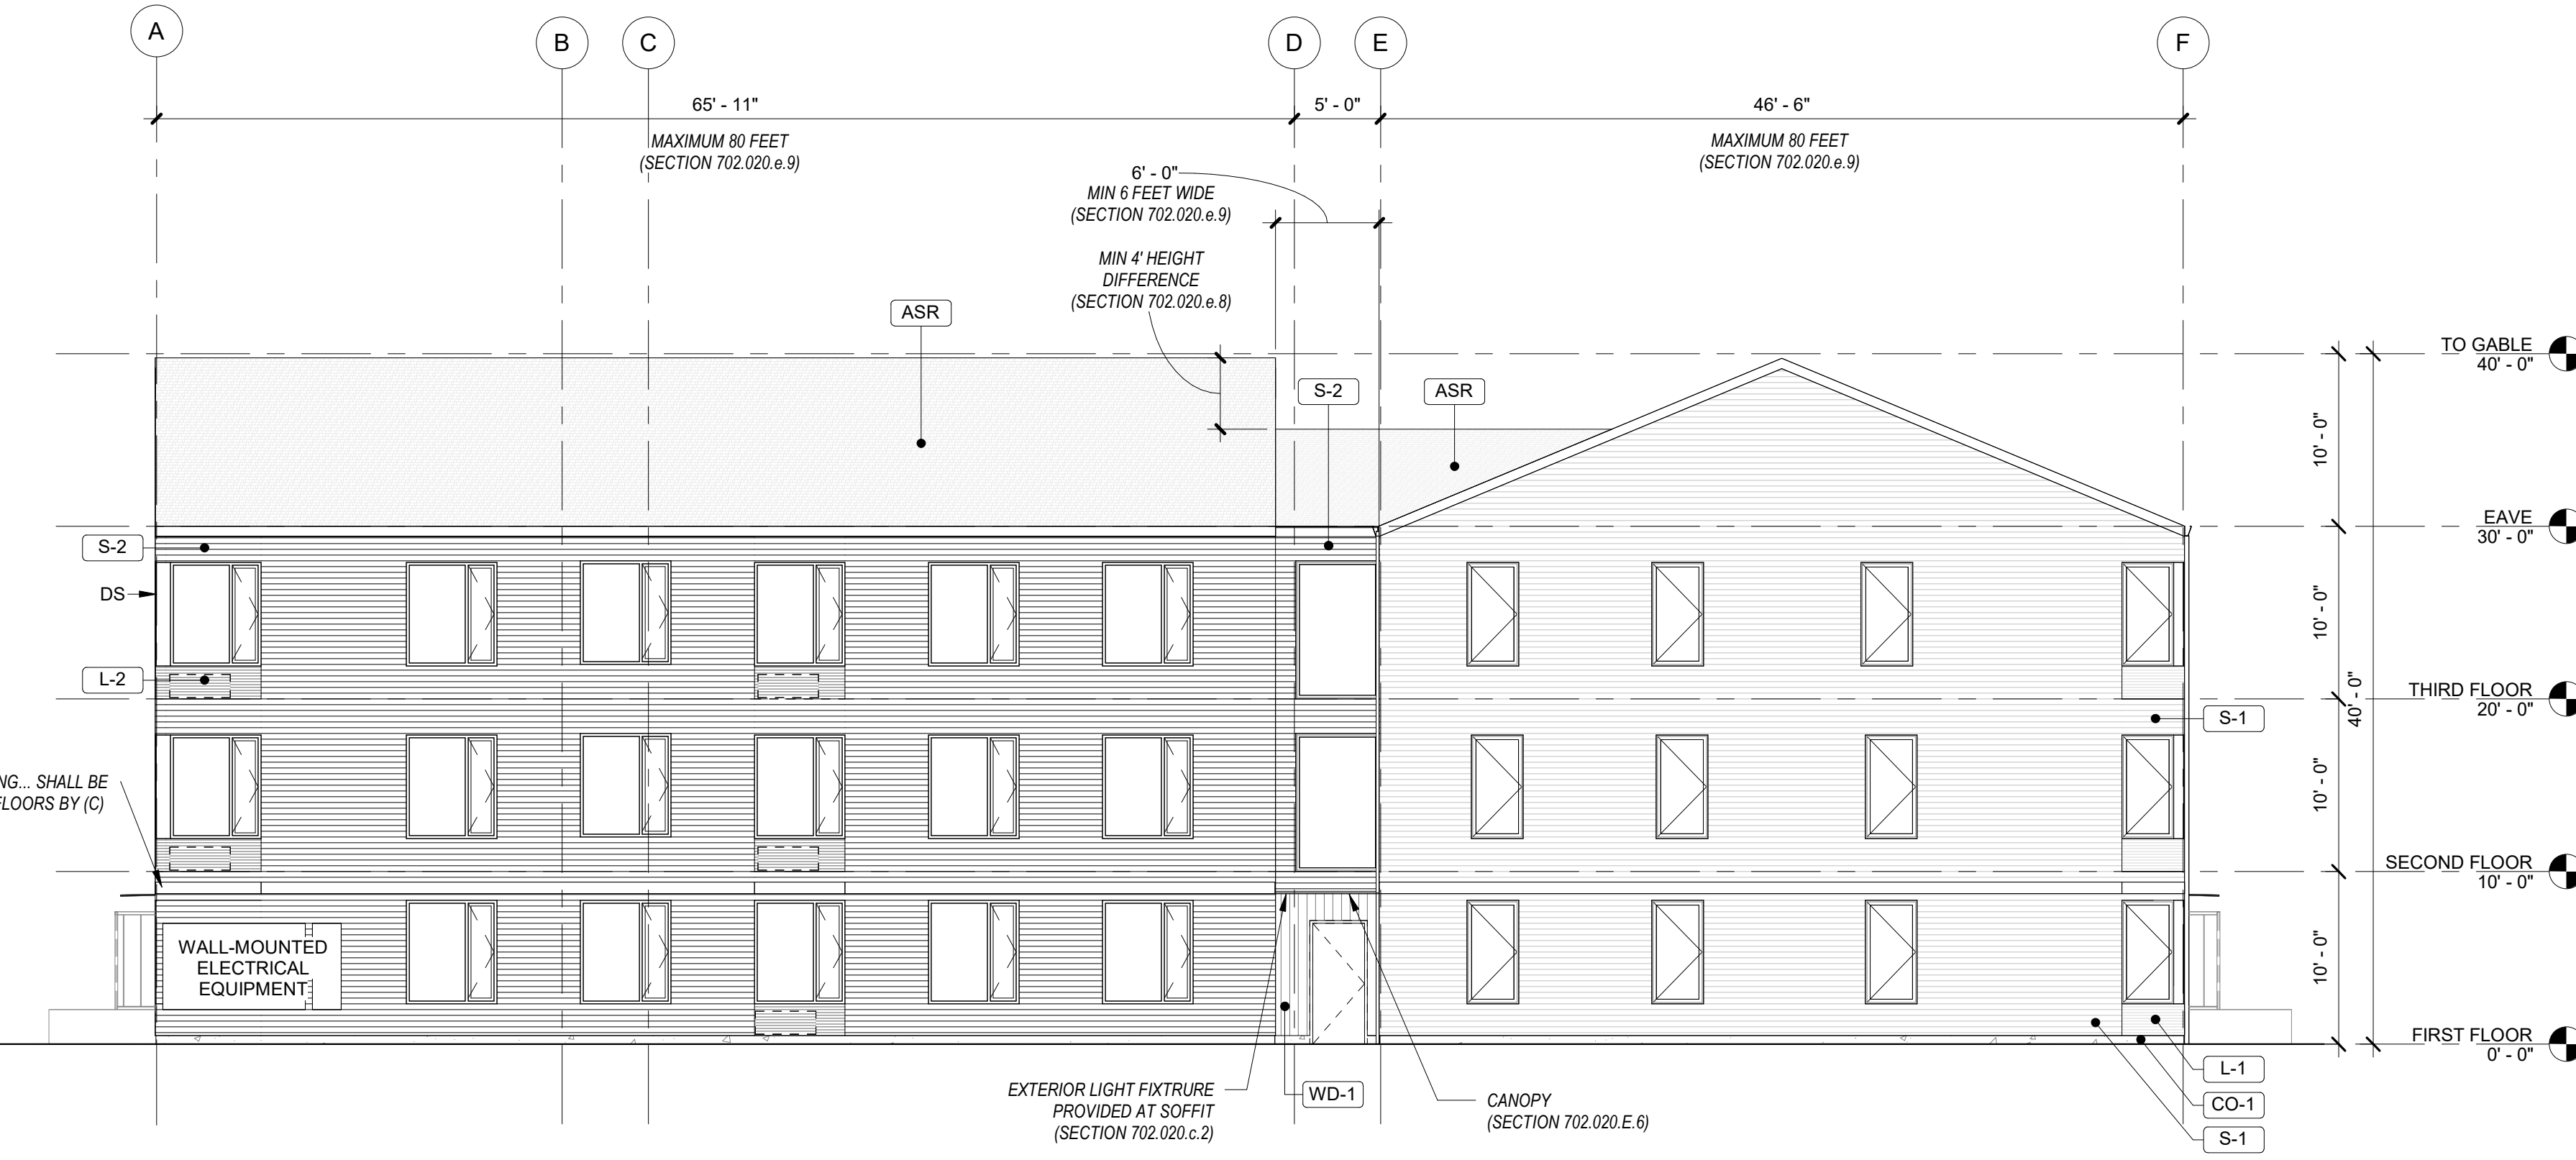

**ELEVATION 3**  
1/8" = 1'-0"

LAND USE SUBMISSION 08.08.22


ISSUE DATE

Drawing:

**EXTERIOR  
ELEVATIONS**

Sheet No:

**A3.01**

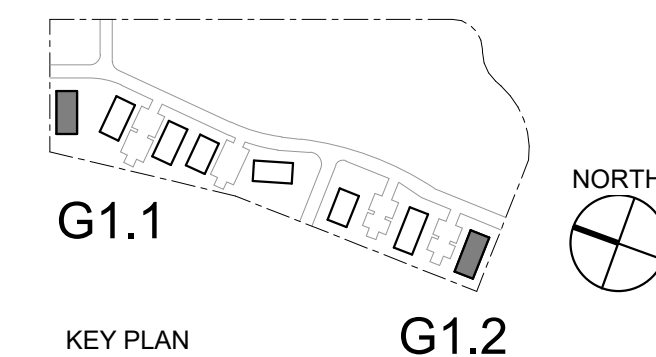

KEY PLAN

G1.2



G1.1

G1.2



NOT FOR  
CONSTRUCTION

CDP SALEM -  
PHASE 2 -  
BUILDING G1

Job Number: 22047

PARCEL 3 & PARCEL 4  
BATTLE CREEK SE  
SALEM, OR



BUILDING FROM SALAL LOOKING SOUTH



BUILDING FROM SALAL LOOKING NORTH




BUILDING PATIOS

MATERIALS



**VERTICAL WOOD SIDING**  
PRODUCT: T&G SIDING, 1x6  
WESTERN RED CEDAR  
FINISH: TRANSPARENT

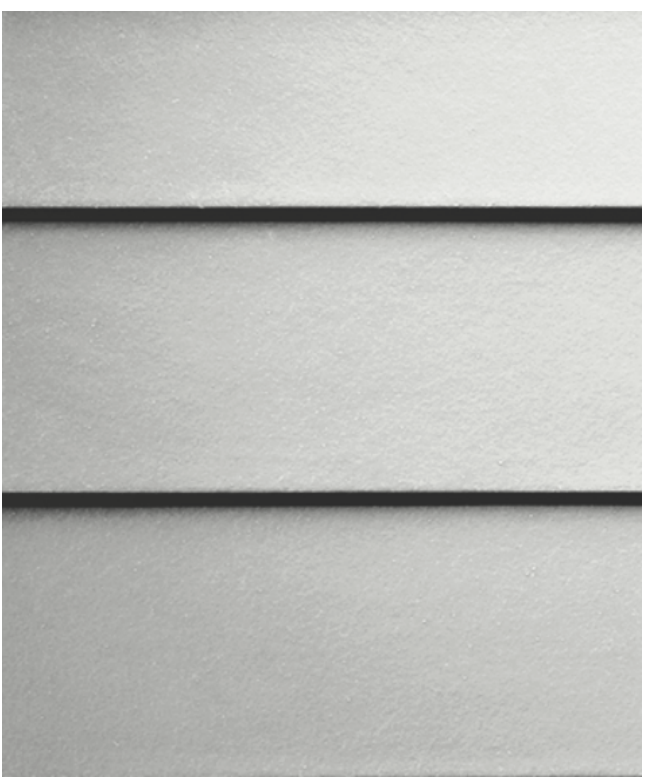


**LAP SIDING**  
PRODUCT: FIBER CEMENT  
PLANK LAP SIDING,  
STRAIGHT EDGE PANEL  
FINISH: PAINT, LIGHT &  
DARK



**ASPHALT SHINGLE ROOF**  
PRODUCT: THREE-TAB-STRIP  
ASPHALT SHINGLES  
FINISH: DARK



**FLAT METAL PANEL**  
PRODUCT: TBD  
FINISH: DARK

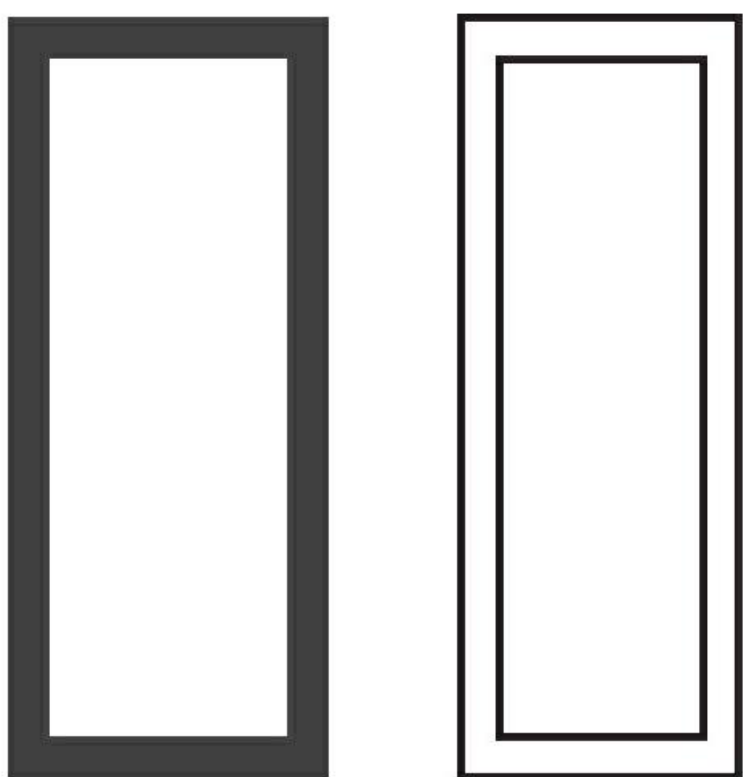

**VINYL WINDOWS**  
PRODUCT: TBD  
FINISH: BLACK & WHITE


\* SITE AND LANDSCAPING SHOWN FOR REFERENCE ONLY. SEE CIVIL AND LANDSCAPE DRAWINGS FOR FULL DESIGN.

LAND USE SUBMISSION 08.08.22

ISSUE DATE

Drawing:

RENDERINGS

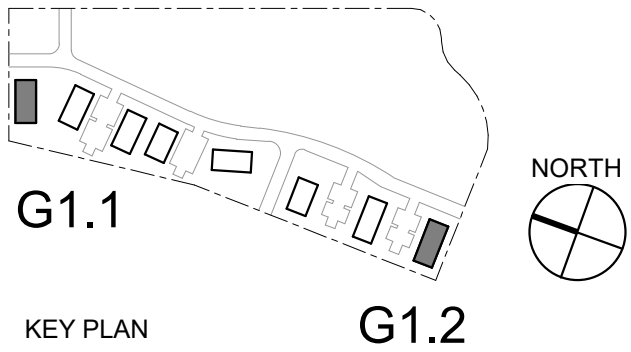

Sheet No:

A3.10

FILE PATH: C:\Revit\_Local\22047\_CDP Salem Gateway Phase II\_Walk Up Building G1\_22\_mculbertsonPX&RT.rvt

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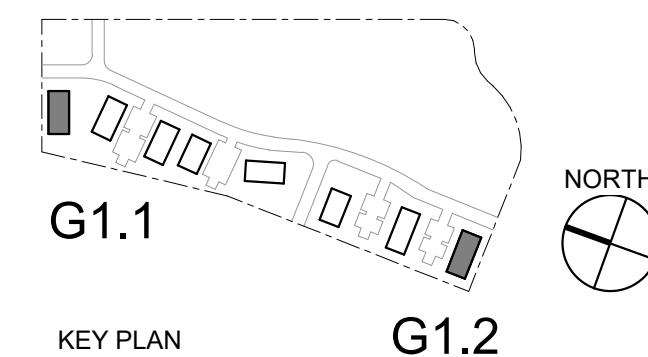
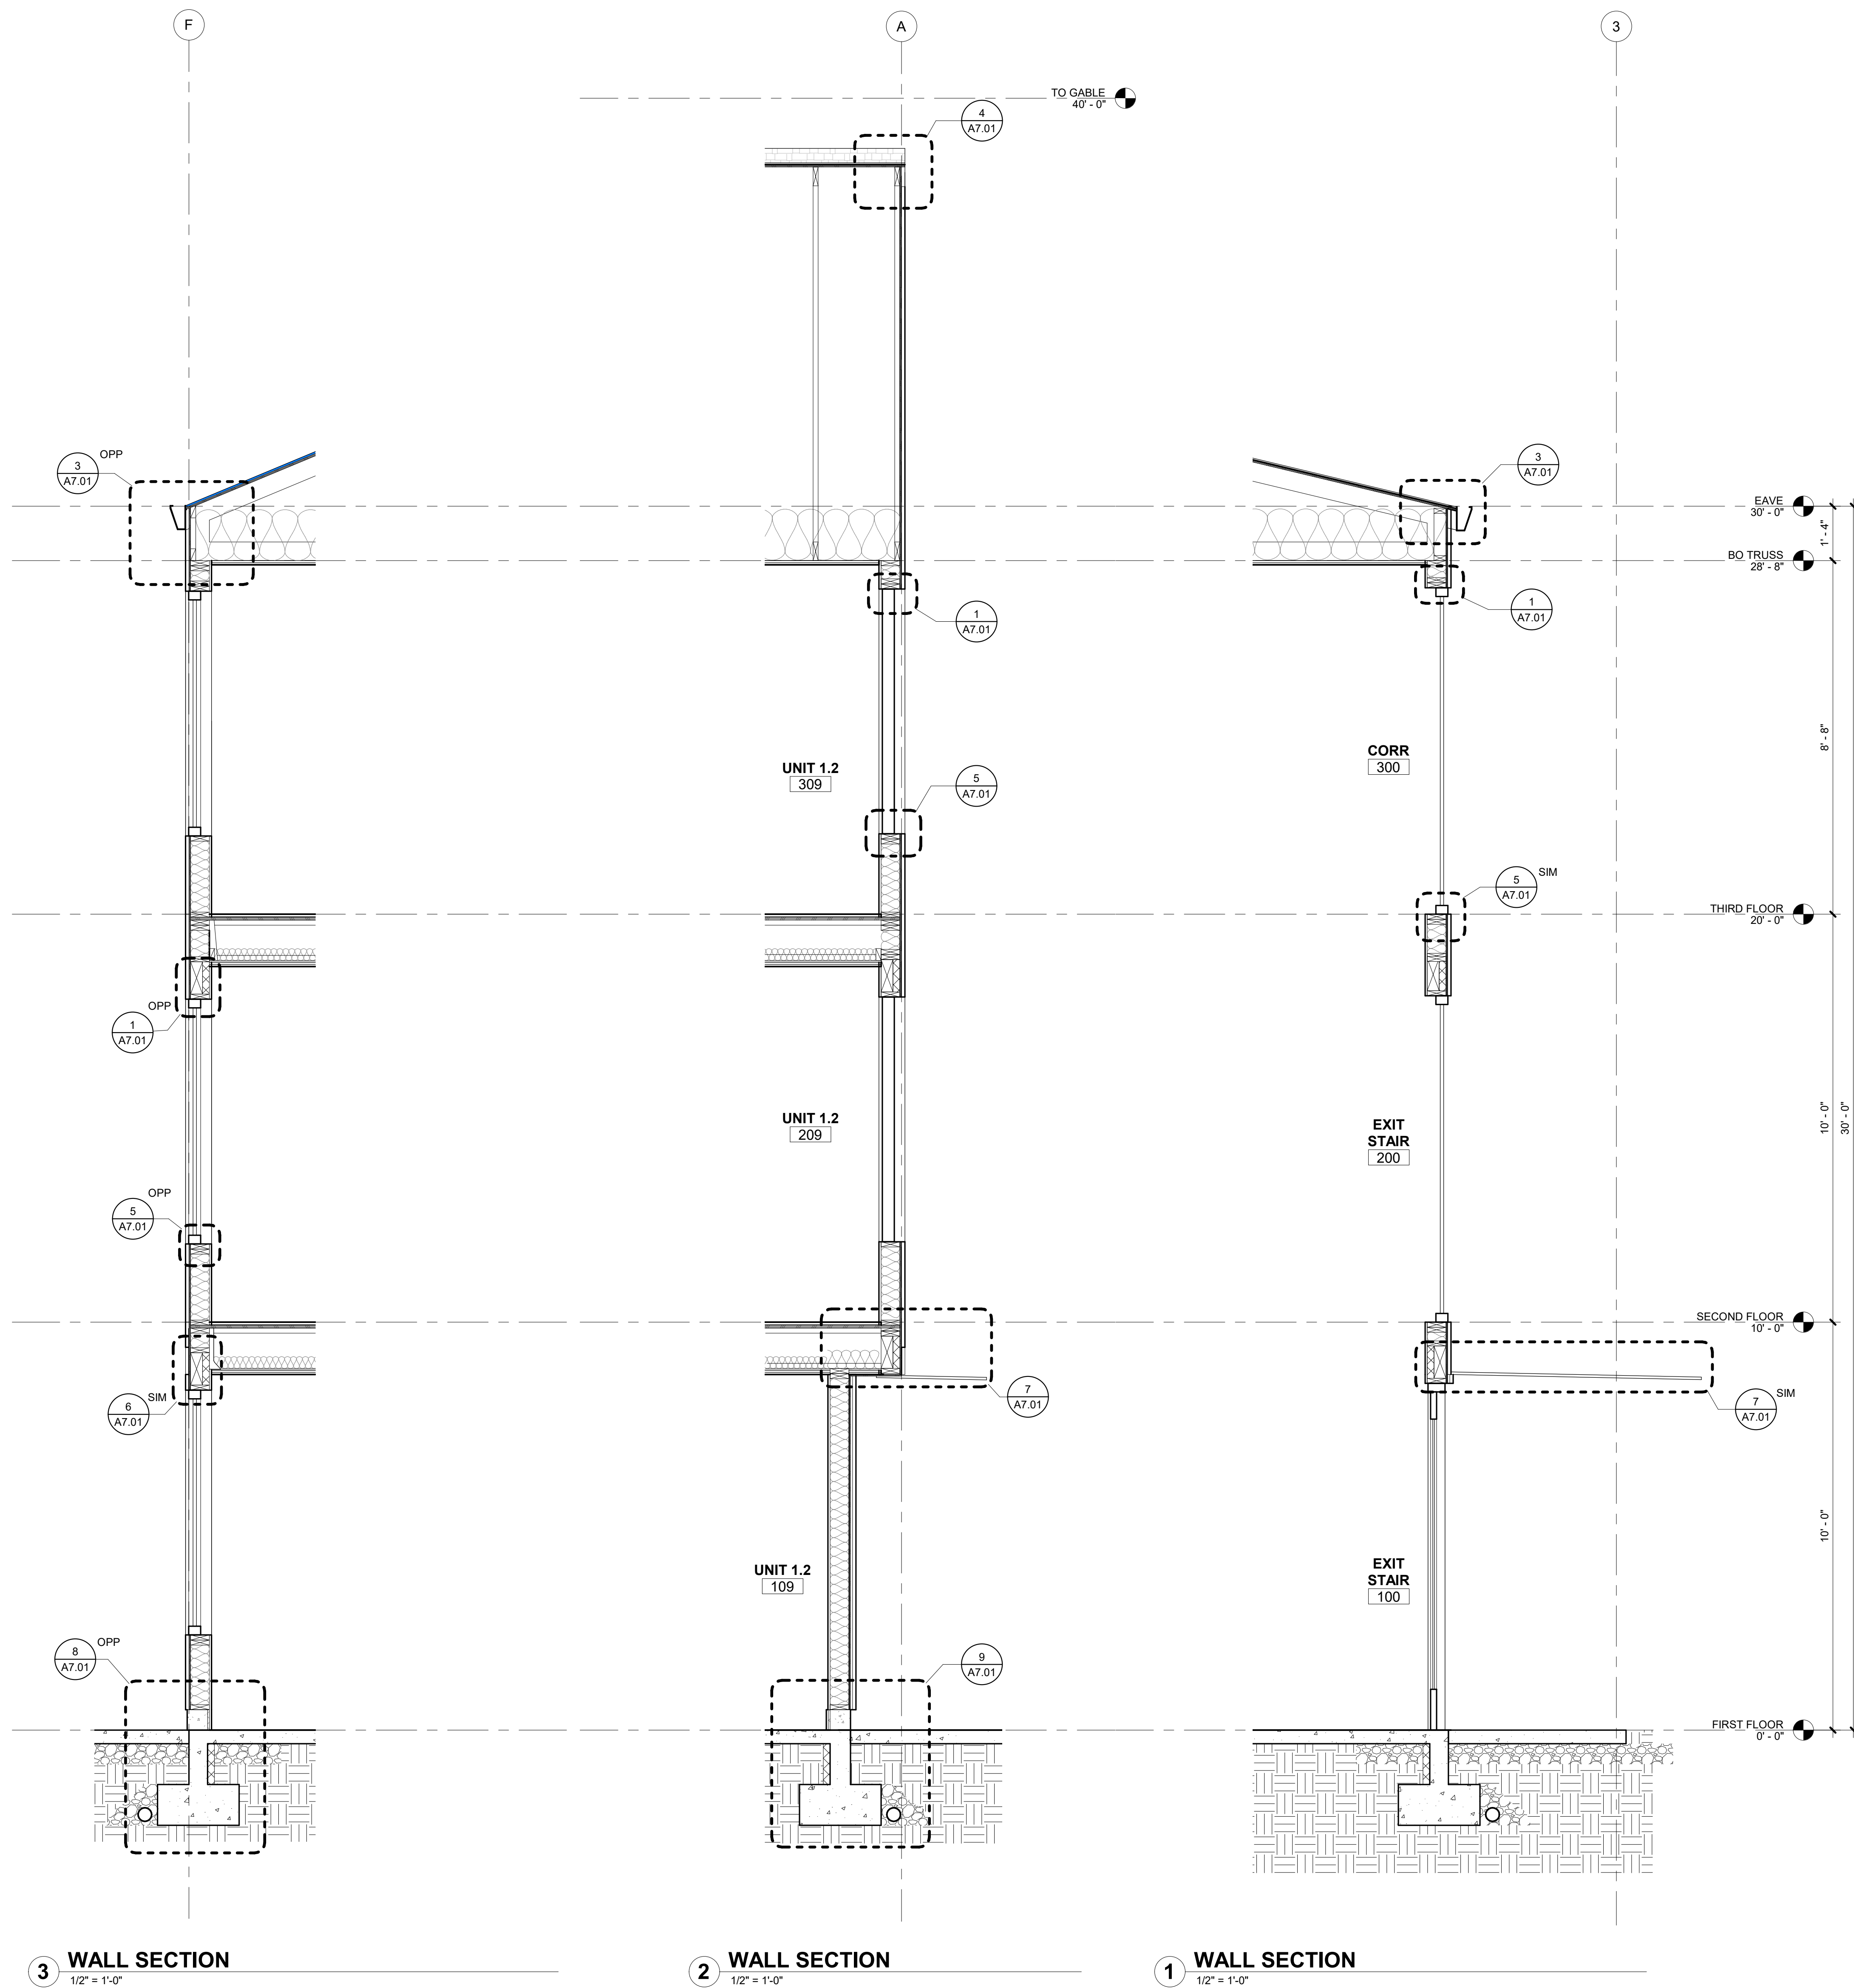


NOT FOR  
CONSTRUCTION

**CDP SALEM -  
PHASE 2 -  
BUILDING G1**

Job Number: 22047

PARCEL 3 & PARCEL 4  
BATTLE CREEK SE  
SALEM, OR



LAND USE  
SUBMISSION 08.08.22

ISSUE DATE

Drawing:

**WALL SECTIONS**

Sheet No:

**A5.01**

FILE PATH: C:\Revit\_Local\22047\_CDP Salem Gateway Phase II\_Walk Up Building  
G1\_22\_mculbertsonPX&RT.rvt

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NOT FOR  
CONSTRUCTION

CDP SALEM -  
PHASE 2 -  
BUILDING G1

Job Number: 22047

PARCEL 3 & PARCEL 4  
BATTLE CREEK SE  
SALEM, OR



LAND USE  
SUBMISSION 08.08.22

ISSUE DATE

Drawing:  
EXTERIOR DETAILS


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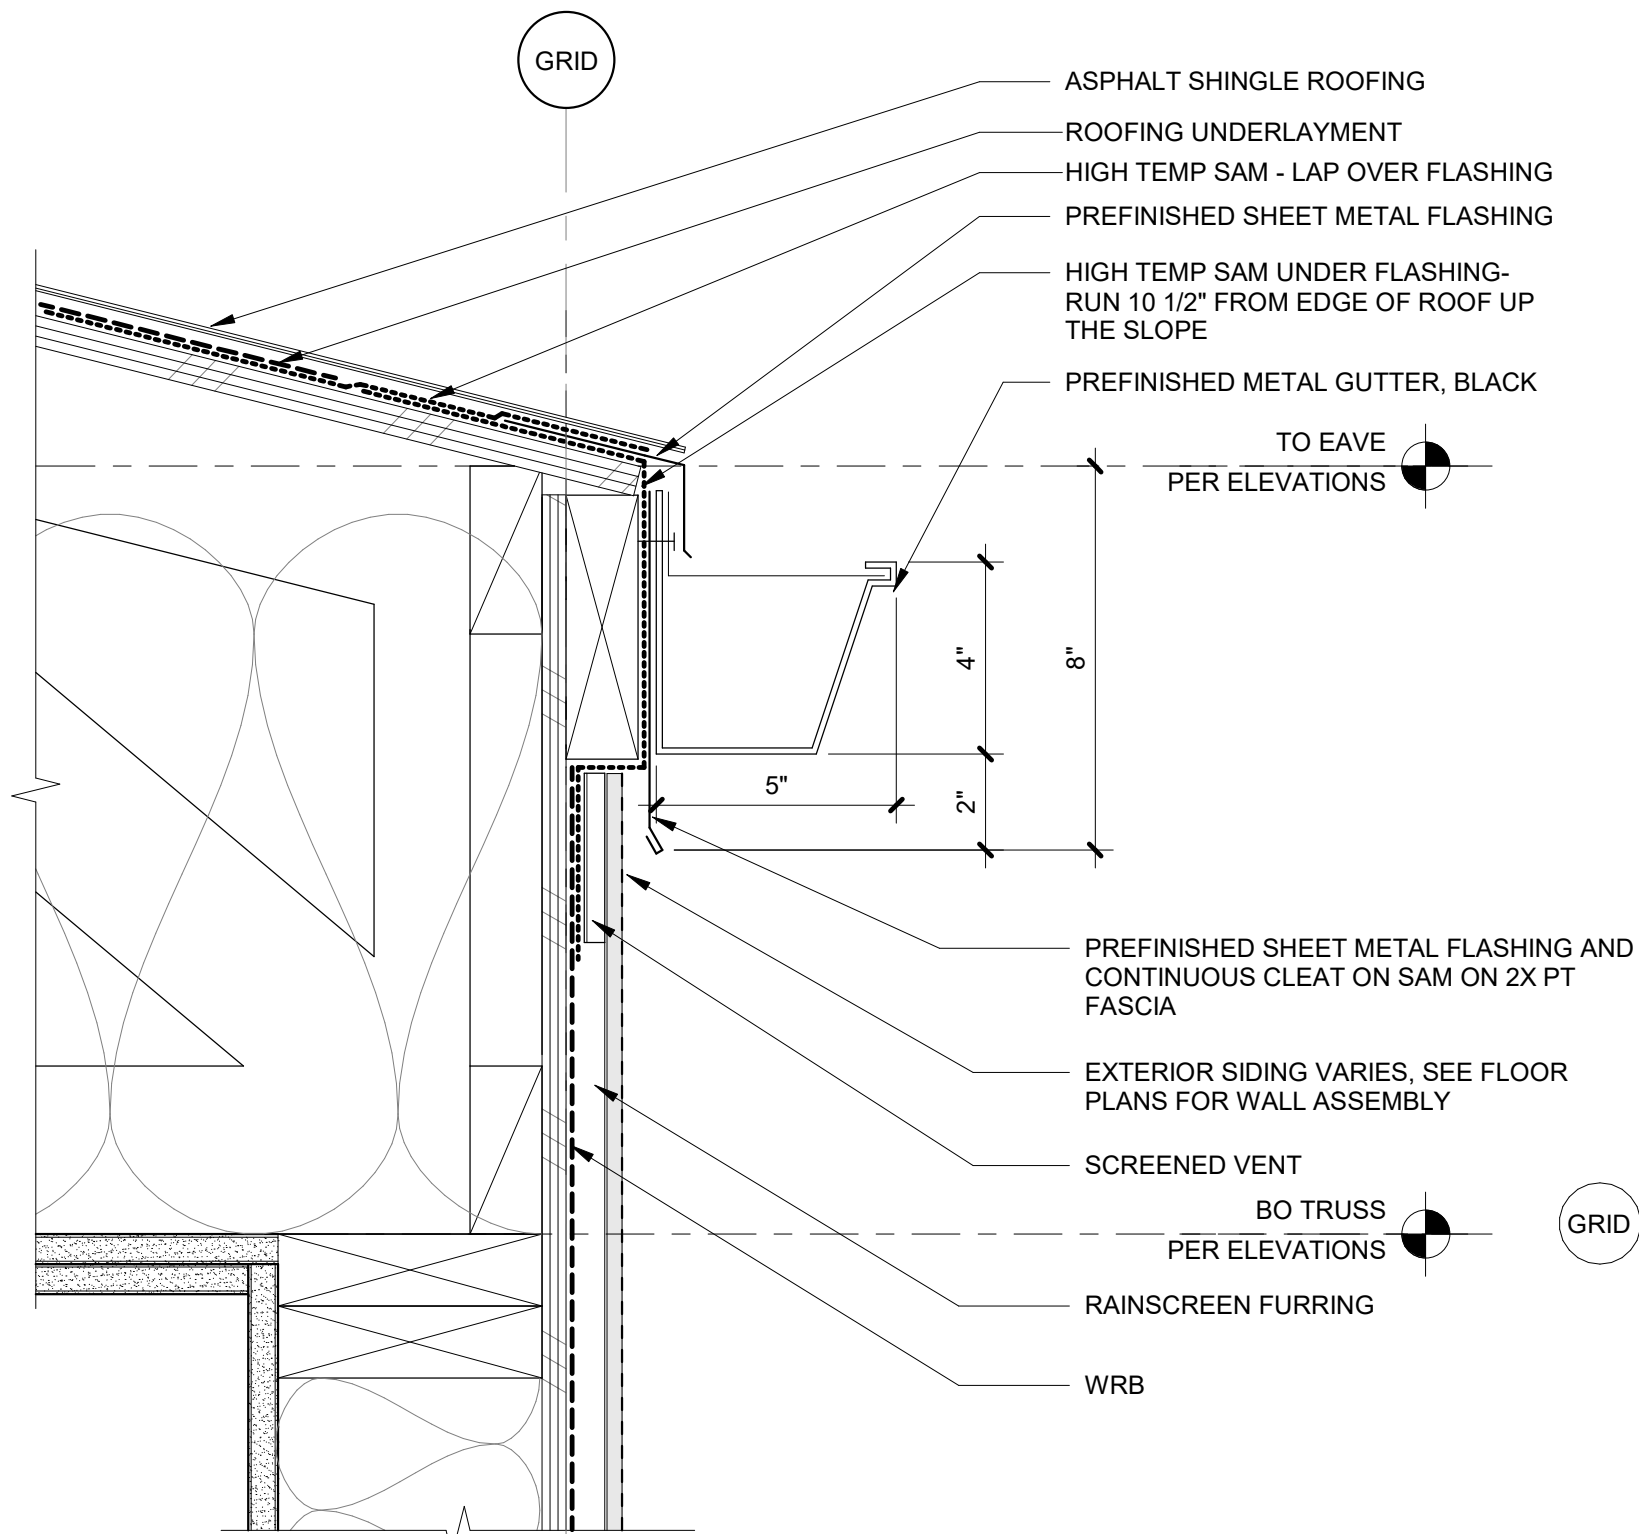
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G1\_22\_mclbertsonPX&RT.rvt

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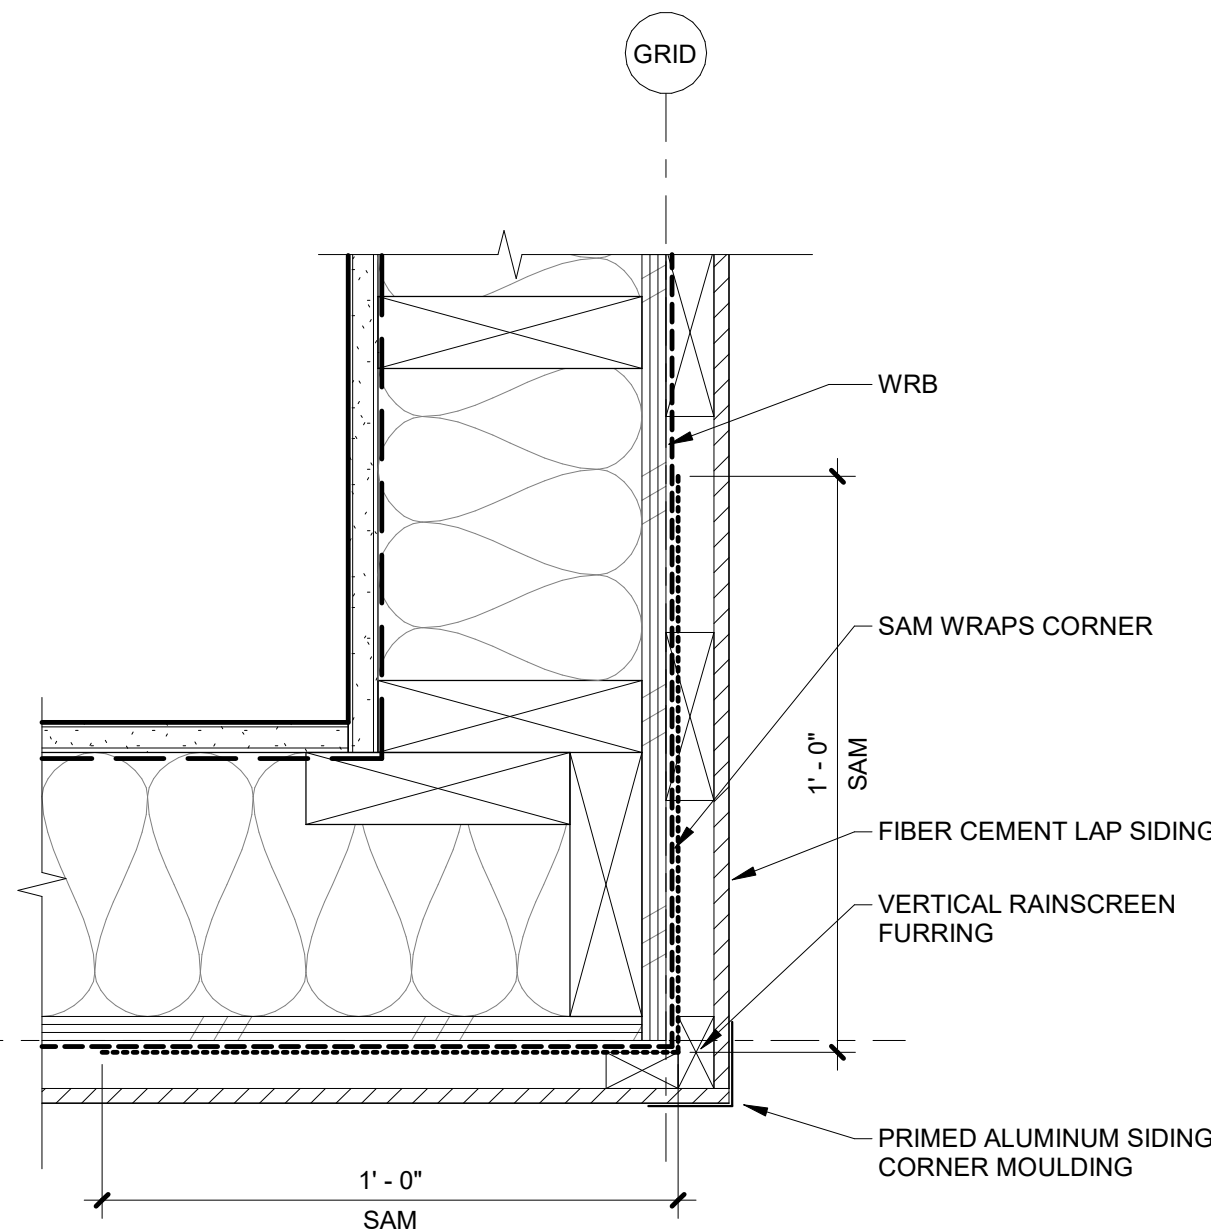
4 TYPICAL RAKE  
3" = 1'-0"




3 TYPICAL EAVE  
3" = 1'-0"

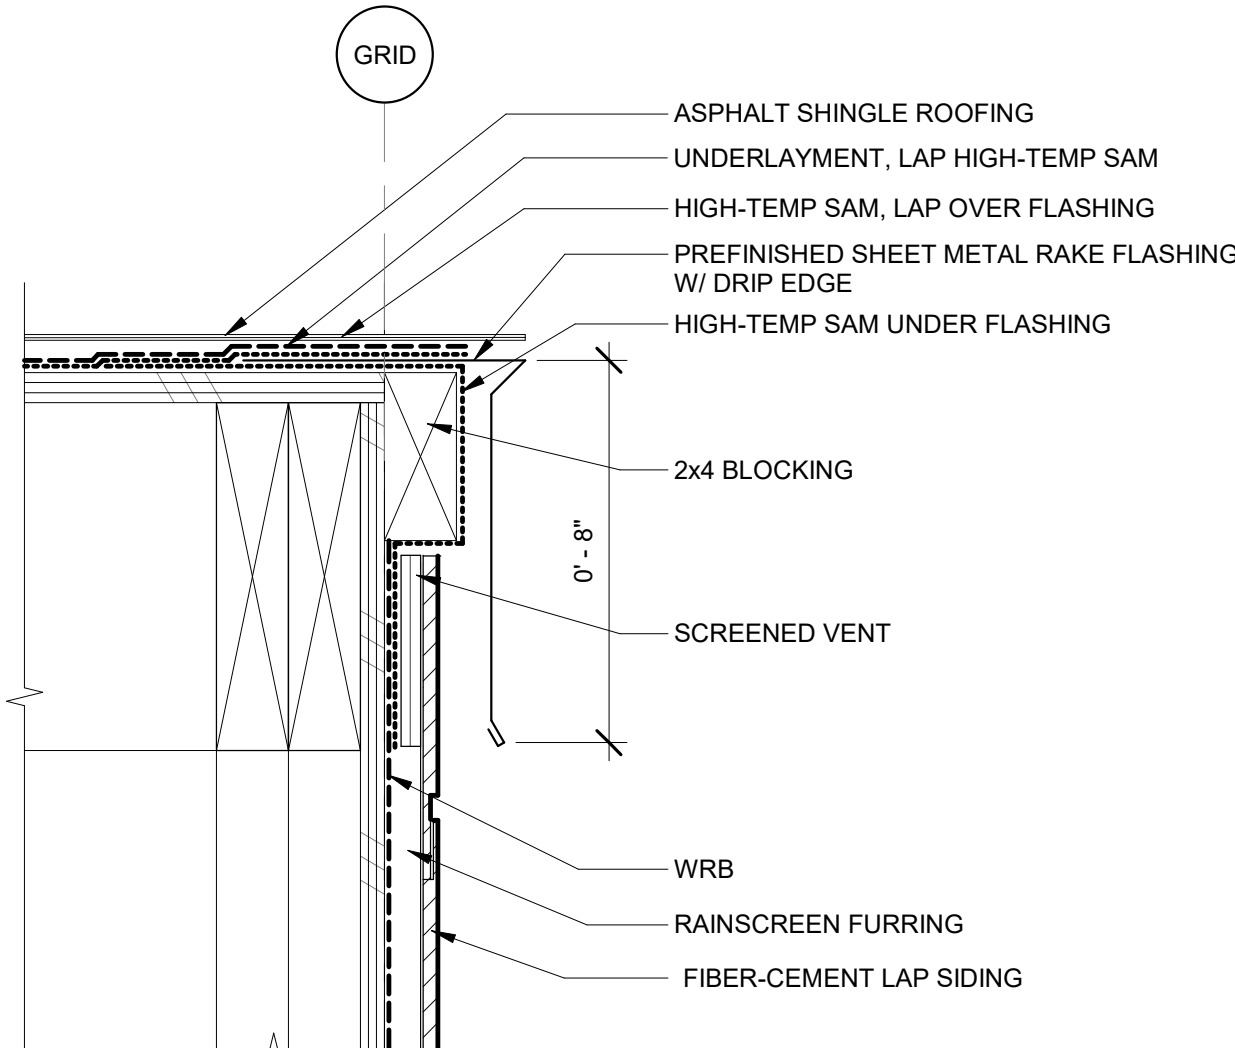


2 FIBER-CEMENT SIDING OUTSIDE CORNER  
3" = 1'-0"




1 WINDOW HEAD @ FIBER-CEMENT SIDING  
3" = 1'-0"

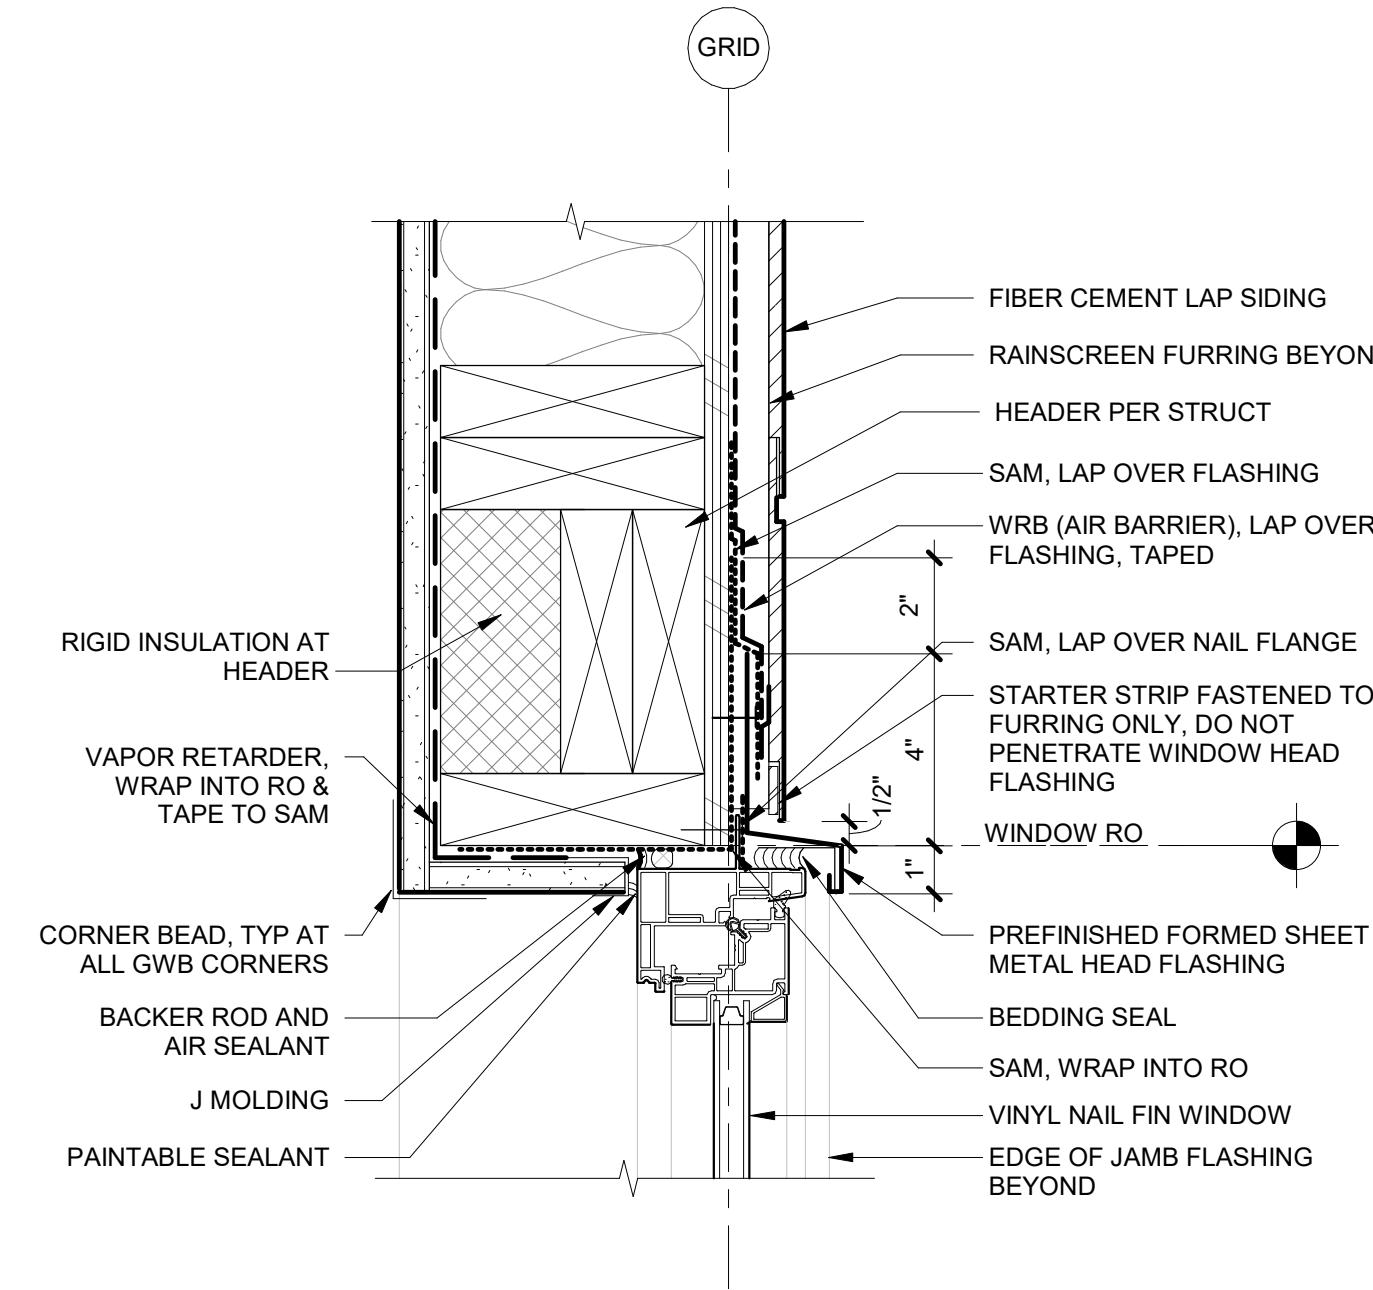


7 METAL BLADE CANOPY  
3" = 1'-0"

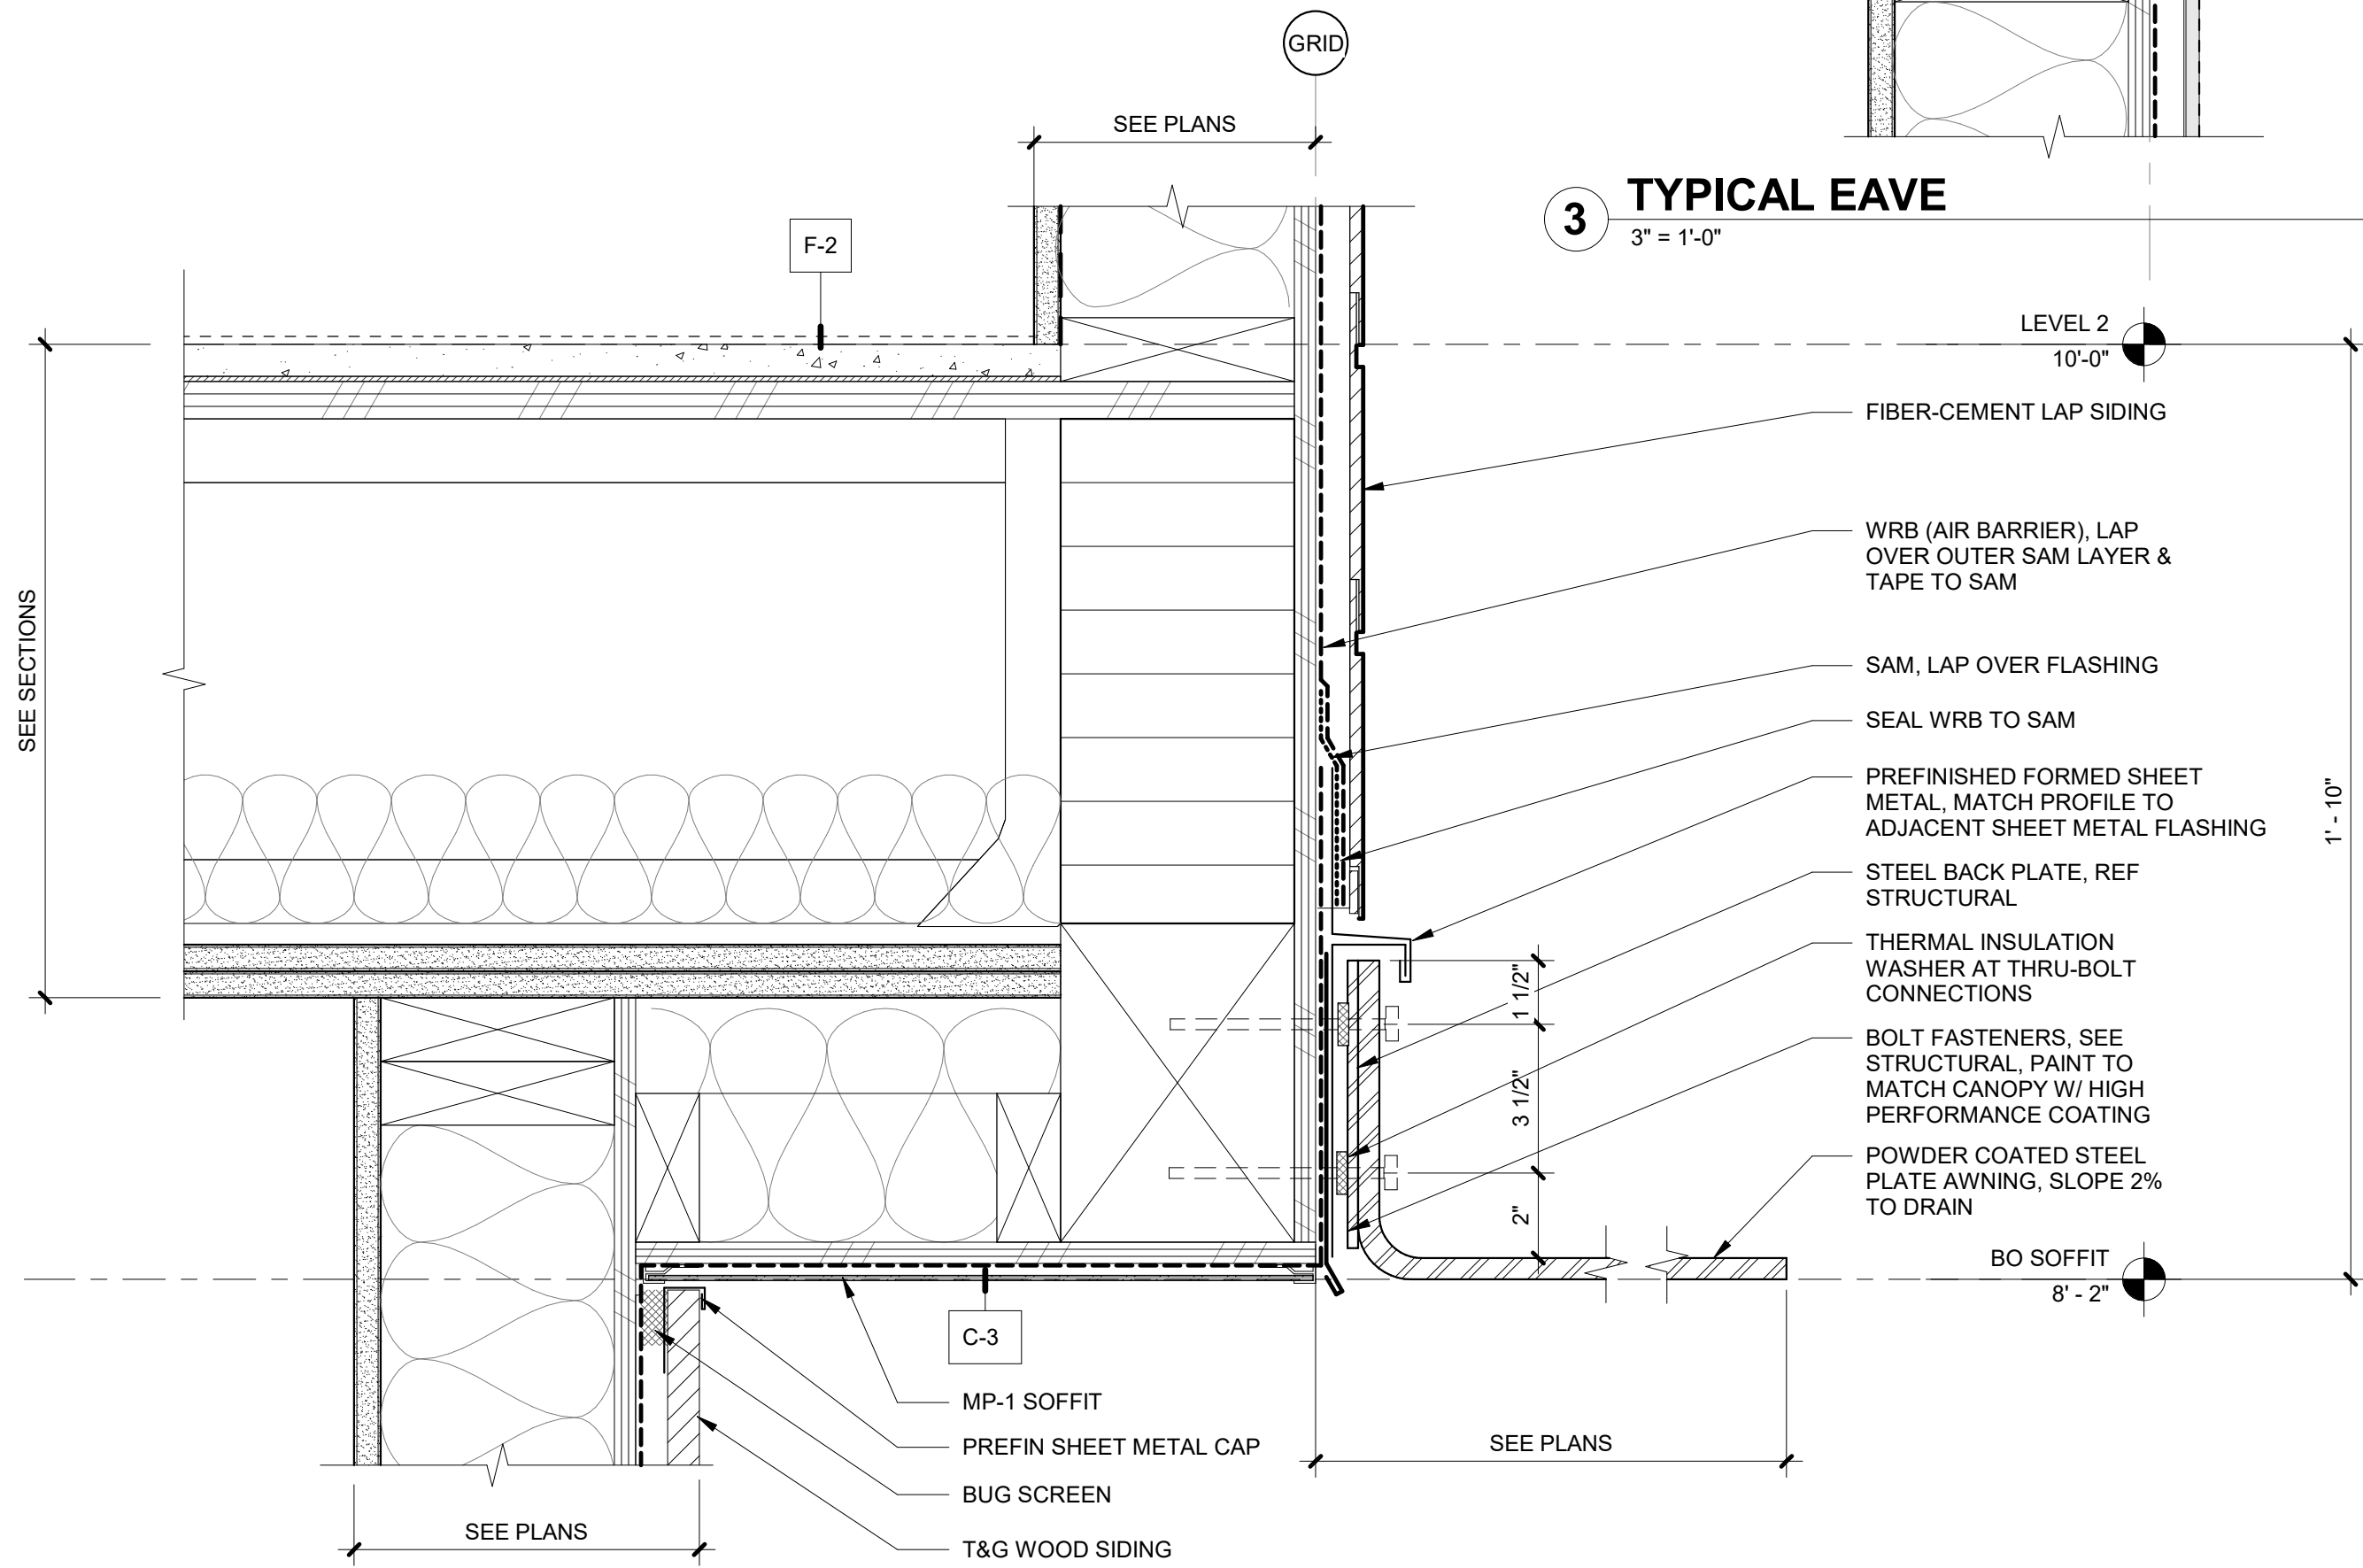


6 BELLY BAND AT FIBER-CEMENT SIDING  
3" = 1'-0"

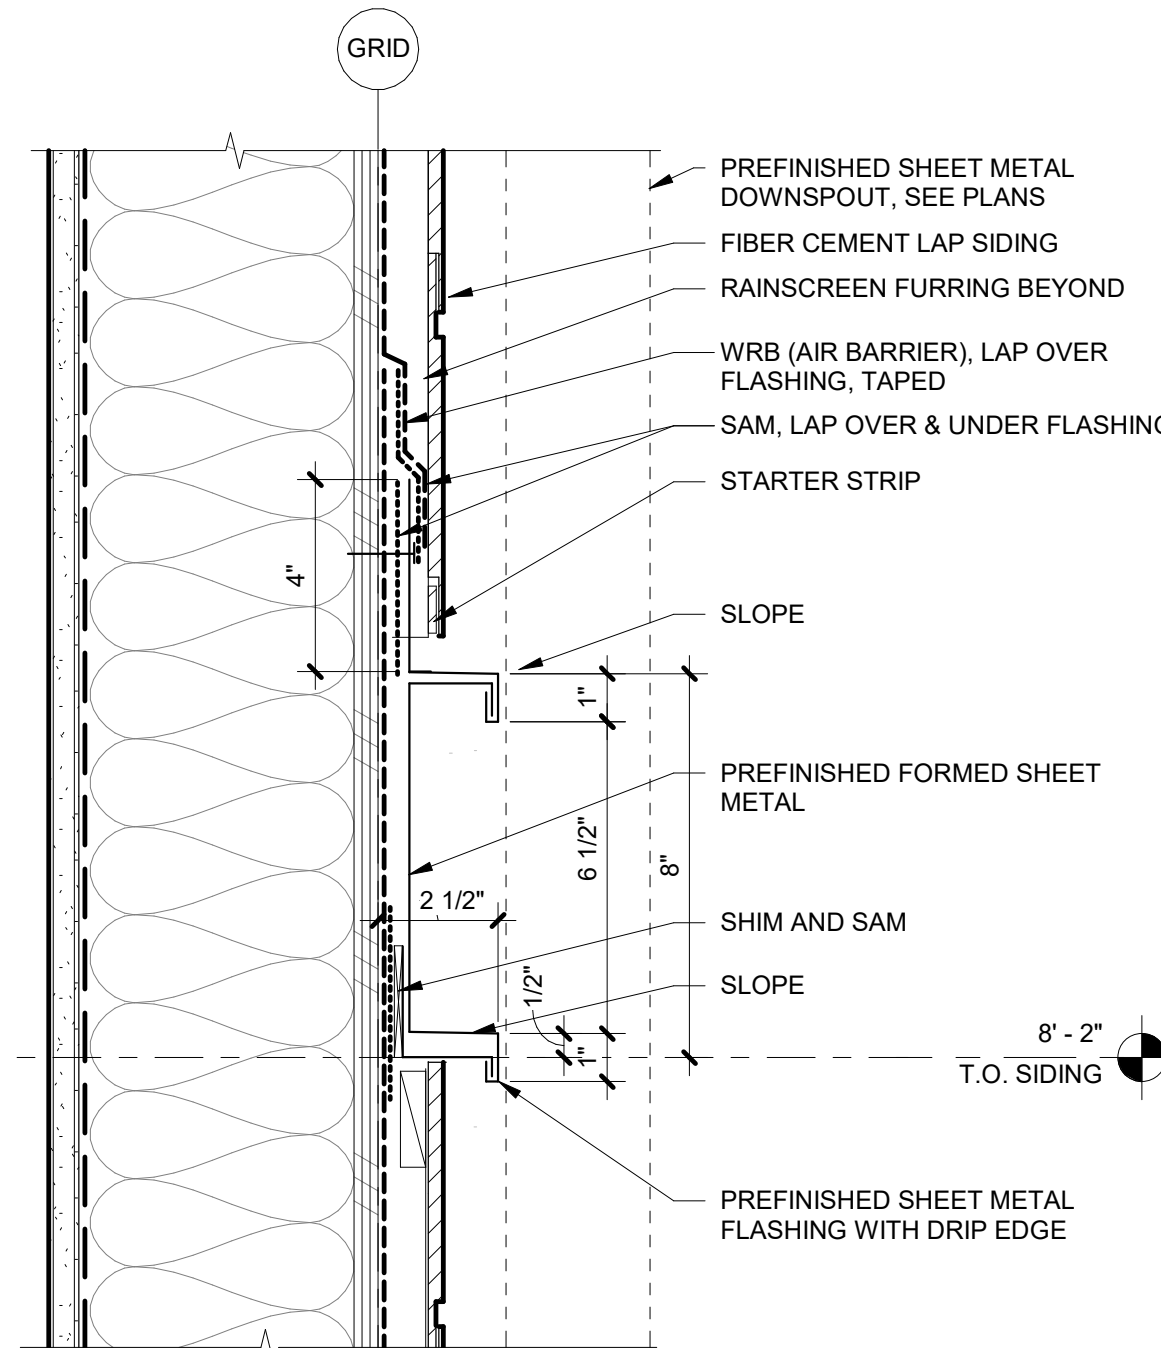


5 WINDOW SILL @ FIBER-CEMENT SIDING  
3" = 1'-0"

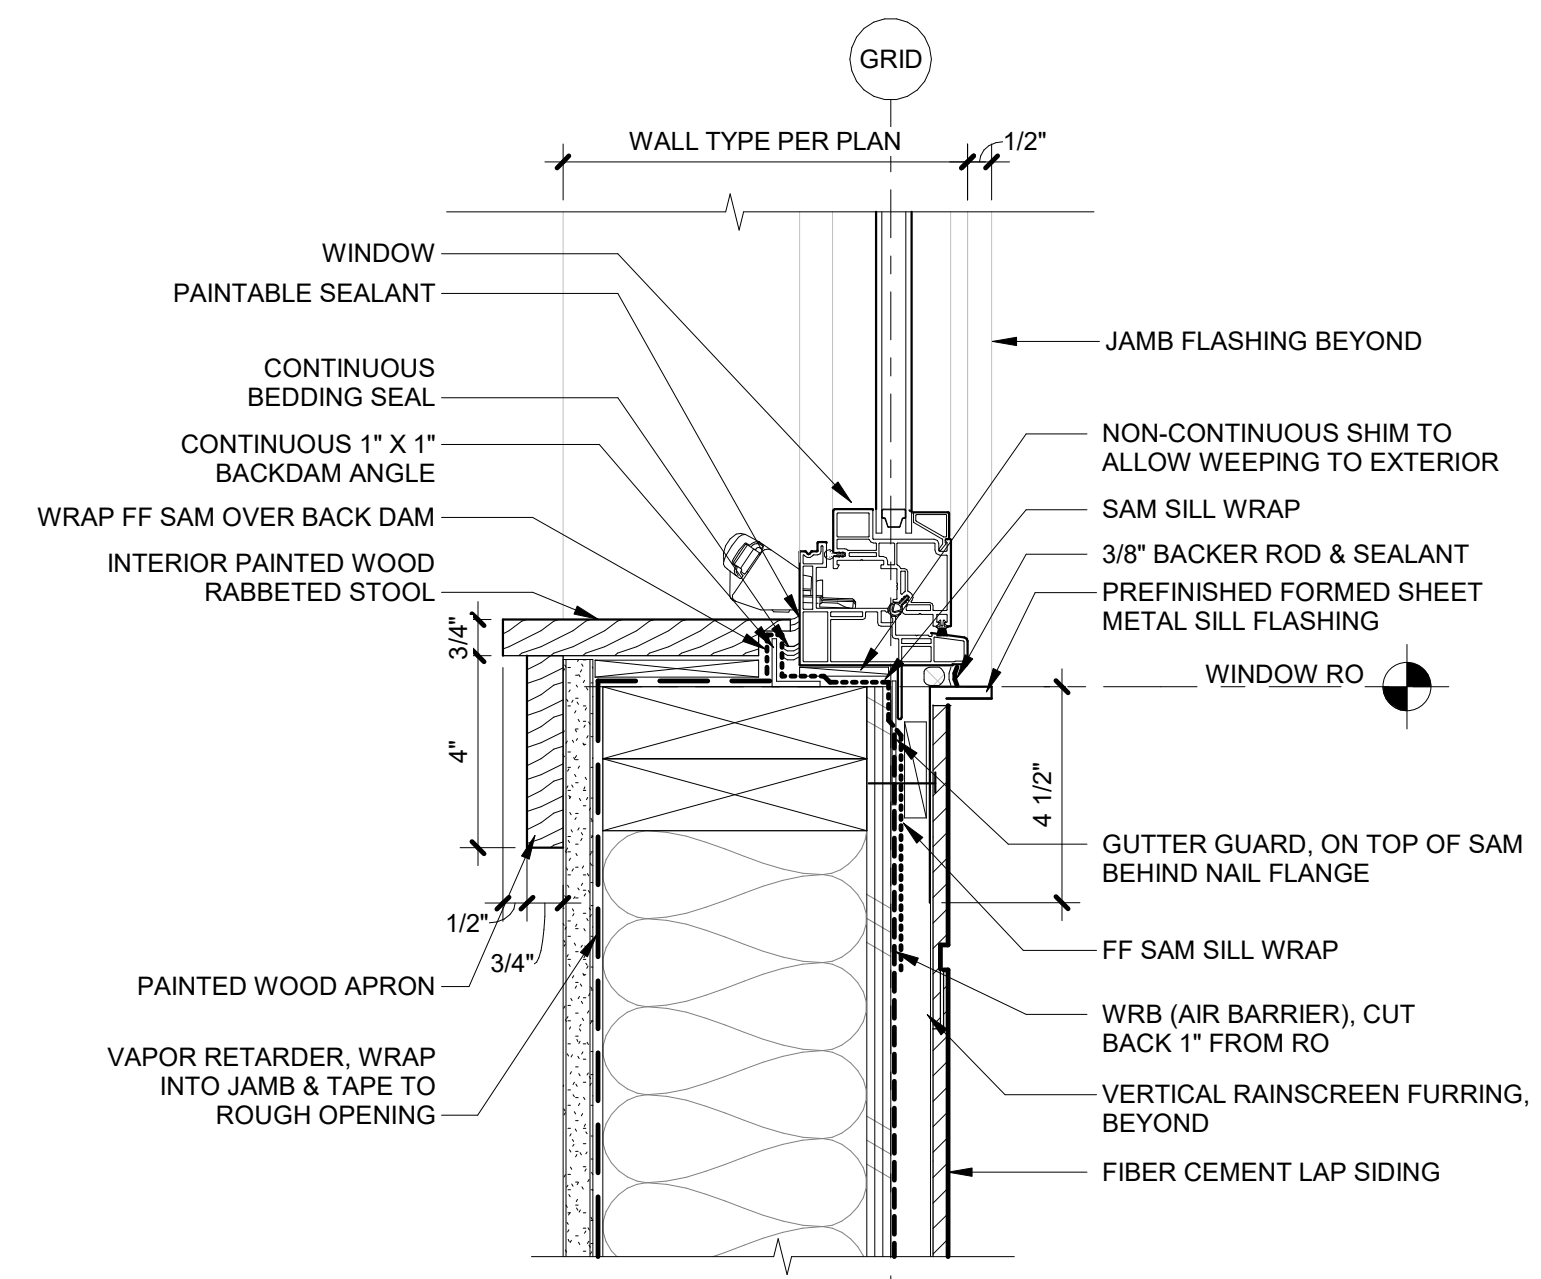

10 PTHP AT CONC CURB  
3" = 1'-0"

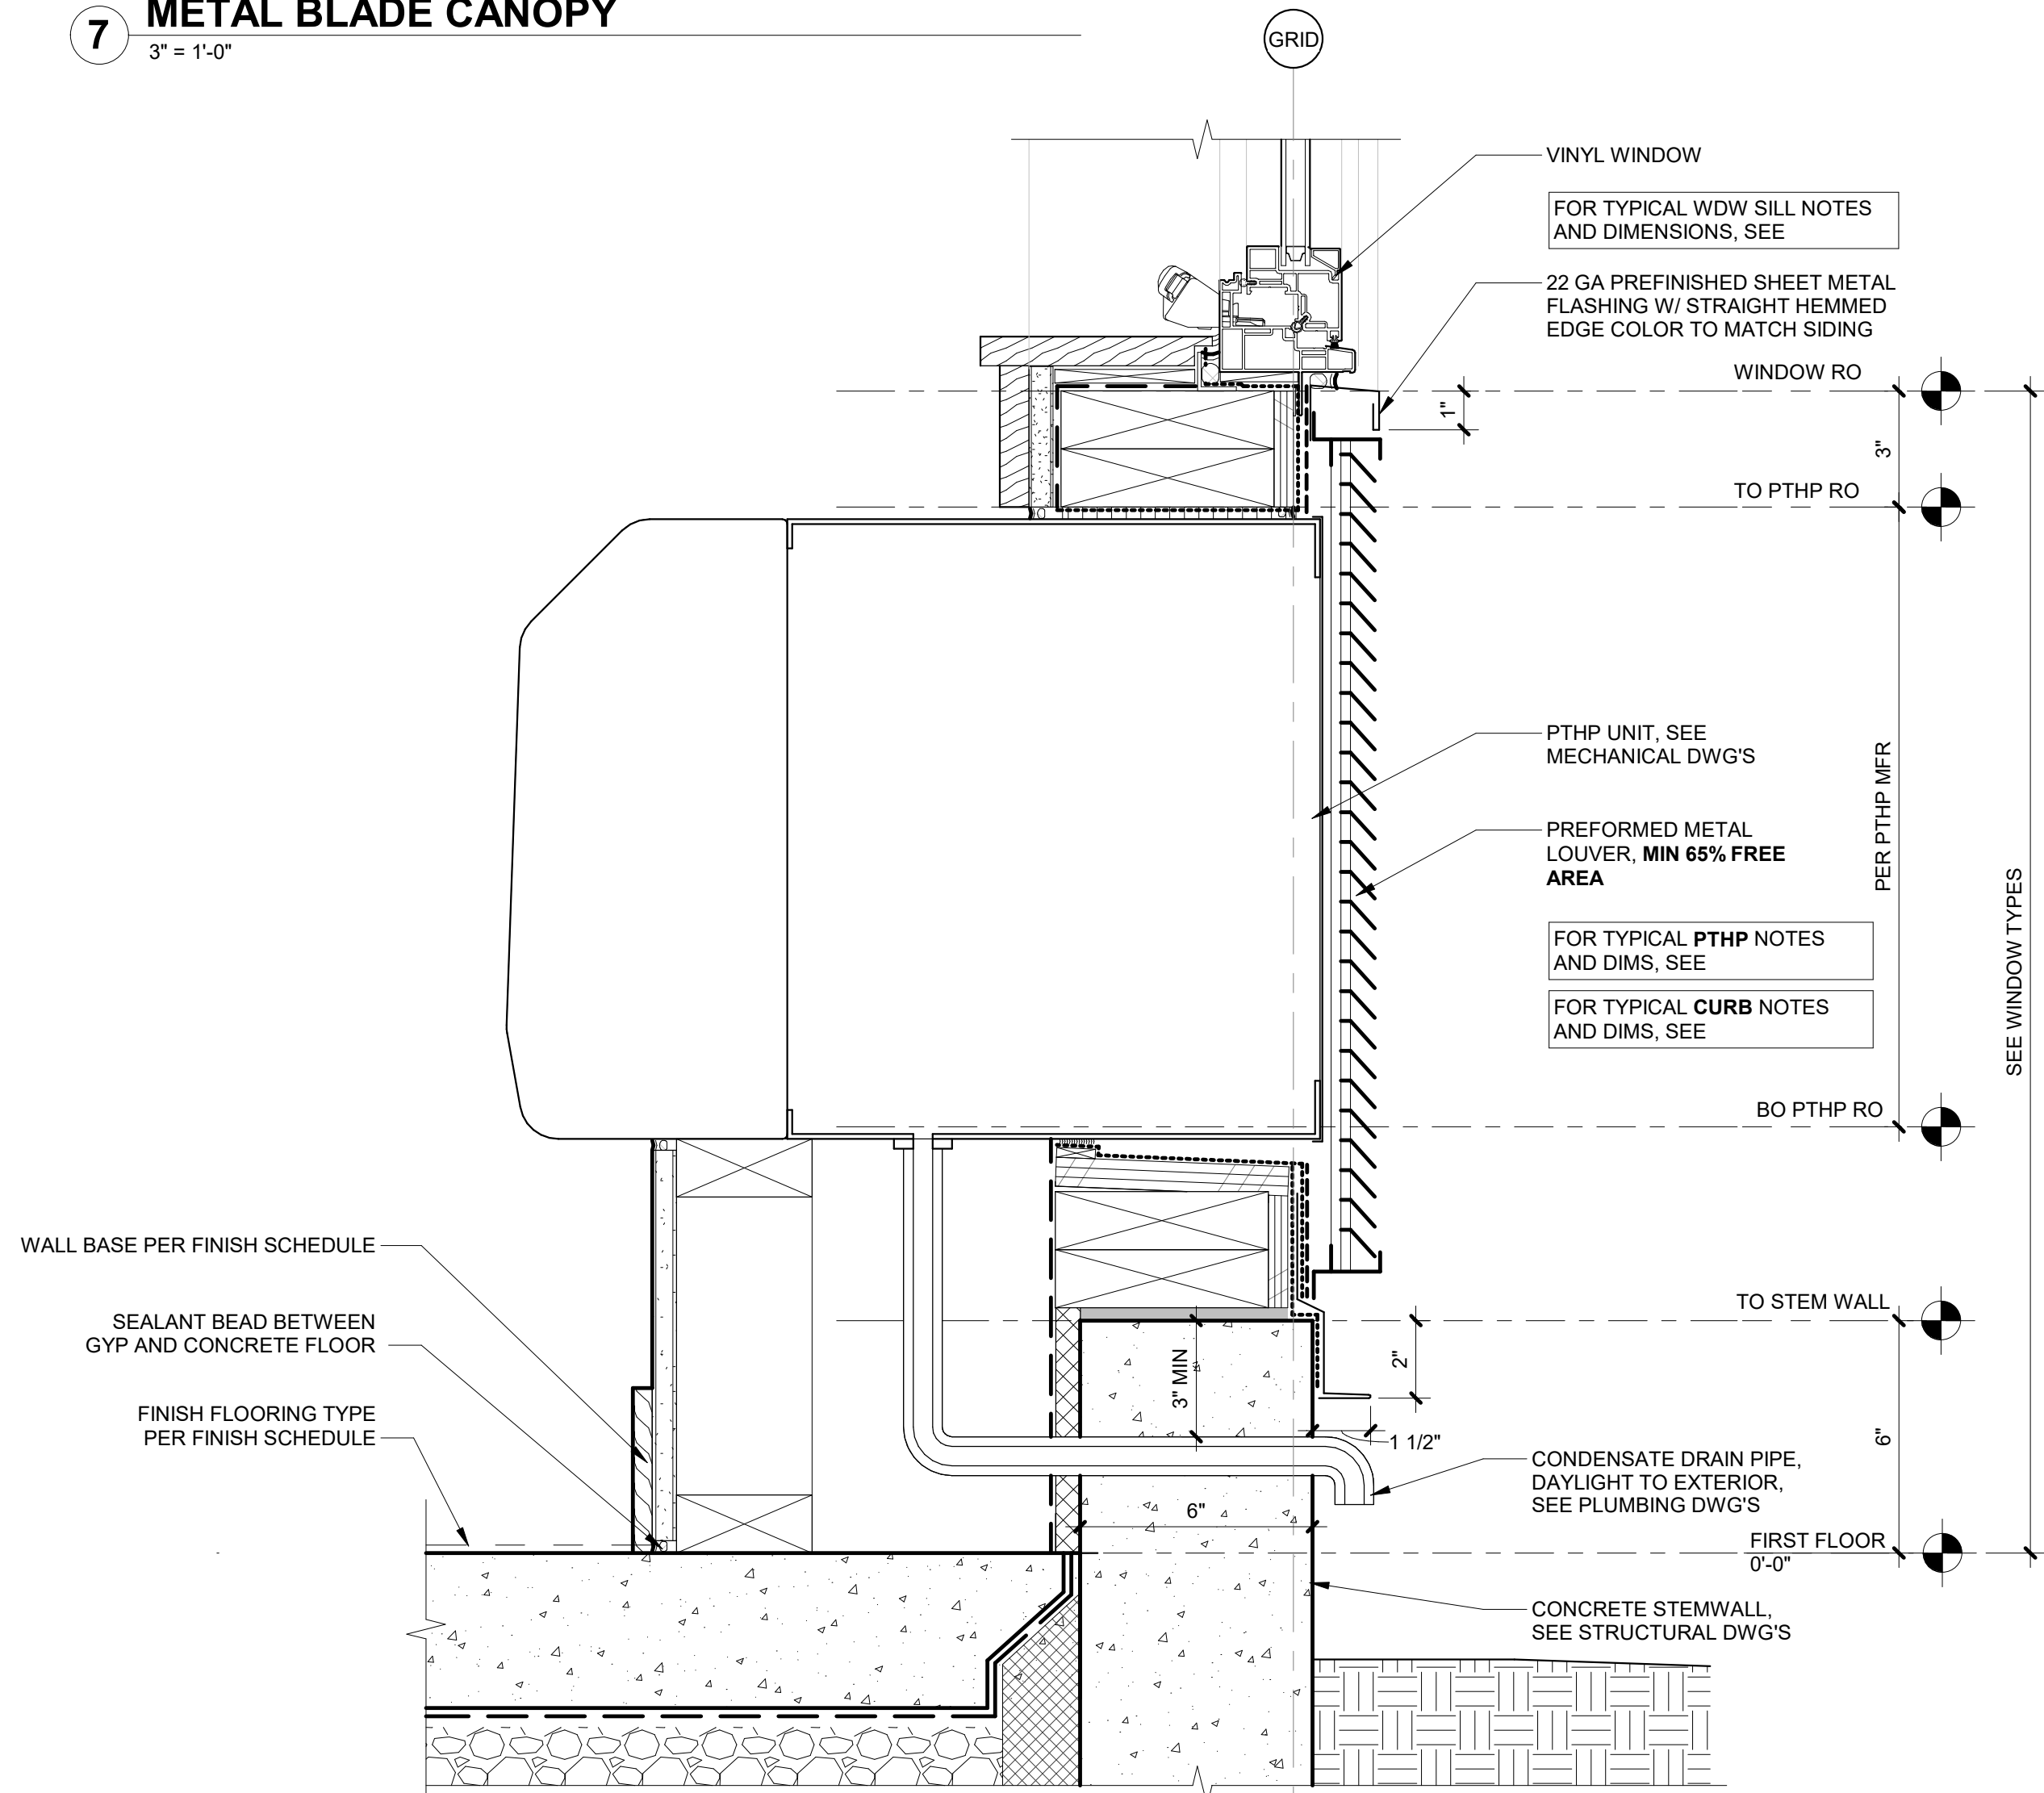

9 CURB AT WOOD SIDING  
3" = 1'-0"

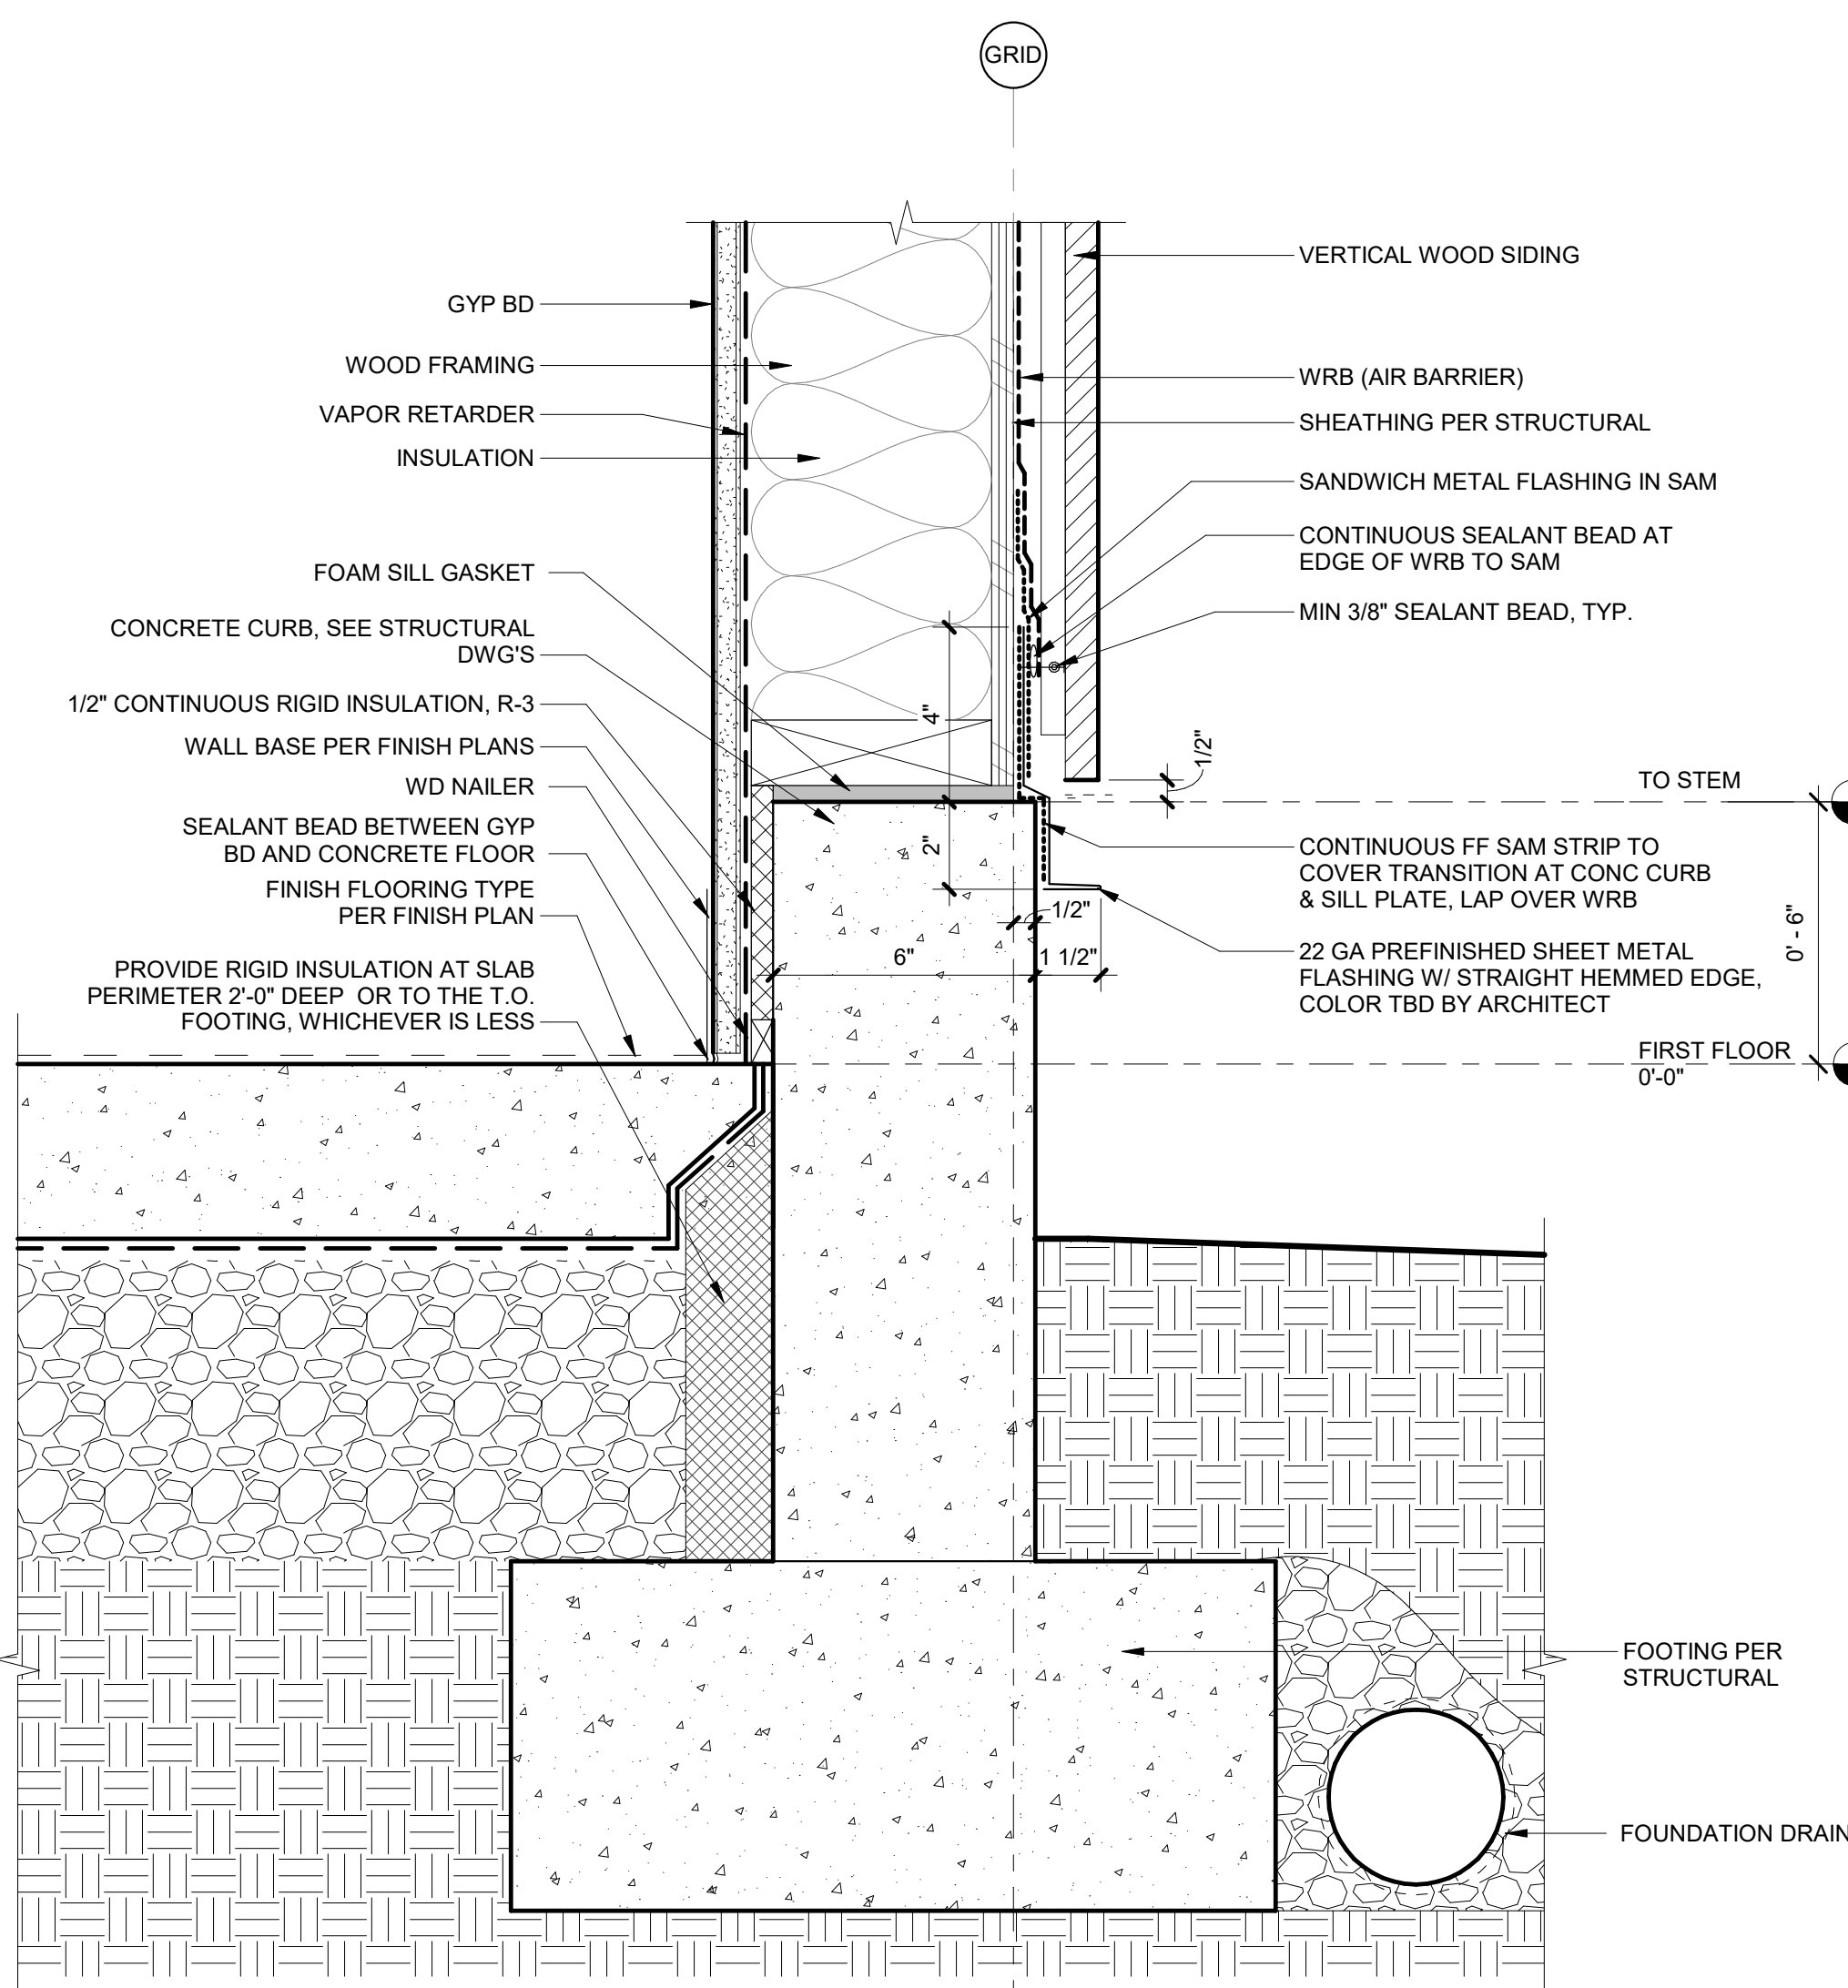

8 CURB AT FIBER-CEMENT SIDING  
3" = 1'-0"

