Tenant Improvement and change of occupancy from office space (B) to private restaurant with wine storage (A-2 & S-2). New interior partitions, doors, glazing, finishes. Exterior wall furring.

#### Second Floor Scope:

Add occupancy, finishes & office furniture to 2,550 sf vacant B occupancy office space. Remaining 6,238 sf will continue to be vacant. No new walls or doors. New finishes.

# Applicable Codes:

2019 Oregon Structural Specialty Code (OSSC)

2021 Oregon Energy Efficiency Specialty Code (OEESC)

2021 Oregon Electrical Specialty Code (OESC)

2019 Oregon Mechanical Specialty Code (OMSC)

2021 Oregon Plumbing Specialty Code (OPSC 2019 Oregon Fire Code

Comply with all applicable codes. Follow industry standards & manufacturer recommendations

### **SEPARATE PERMITS & DEFERRED SUBMITTALS**

Separate Permits: Plumbing, Mechanical, Electrical, Lighting, Fire sprinkler, Fire alarm. Deferred Submittal: Energy compliance forms

2017 Shell Permit: All public use areas made accessible per 2014 OSCC, ch.11, 2009 icc/ansi 117.1 2022 Current Permit: All new/altered spaces made accessible per 2019 OSCC, ch.11, 2009 icc/ansi 117.1

## **CHAPTER 3, OCCUPANCY**

Second Floor: Existing & Proposed: Business, B = Office

Basement: Existing: Business, B Proposed: Assembly, A-2 = Restaurant, bar, kitchen

### **CHAPTER 5, BUILDING HEIGHTS & AREAS**

TABLE 504.3, ALLOWABLE BLDG HT. ABOVE GRADE PLANE

Type III B. A, S and B occupancy = 75'

TABLE 504.4 ALLOWABLE NUMBER OF STORIES ABOVE GRADE PLANE

Type III B. A-2 occupancy (worst case) = 3 stories

TABLE 506.2 ALLOWABLE AREA FACTOR

Existing shell permit was designed to worse-case scenario of A1 occupancy

Basement = 12,085 sf (not included in calculation)

First Floor = 12,085 sf Second floor = 12,085 sf

Total Actual Area = 24,170 sf

Allowable area for A-2 (worse case), type III B, 2 stories + basement = 28,500 sf

# SECTION 508.3 NON SEPARATED USES

Non separated occupancies individually classified in accordance with 302.1. The most restrictive provisions of chapter 9 that apply to non separated occupancies shall apply to total nonseparated

# SECTION 508.4 REQUIRED SEPARATION OF OCCUPANICES

A & S-2 w/ sprinklers = 0 hr

B & S-2 = 0 hr

A & B w/ sprinklers = 1 hr (0 hr since non separated occupancies)

# **CHAPTER 6, TYPES OF CONSTRUCTION**

TABLE 601 FIRE RESISTANCE RATING REQUIREMENTS FOR BLG ELEMENTS

Primary Structural frame = 0 hr Bearing walls, exterior = 2 hr

Bearing walls, interior = 0 hr

Non bearing walls = 0 hr

Floor and Roof Construction = 0 hr

TABLE 602 FIRE RESISTANCE RATING REQUIREMENTS FOR EXT. WALLS BASED ON SEPARATION

Type III B:

Less than 5' = 1 hr (2 hr for F-1, M, S-1)Greater or equal to 5' less than 10' = 1 hr

Greater or equal to 10' less than 30' = 1 hr

Greater or equal to 30' = 0 hr

# **CHAPTER 7, FIRE AND SMOKE PROTECTION FEATURES**

# SECTION 707 FIRE BARRIERS

The fire resistance rating of the fire barrier separating building areas from an interior exit stairway or ramp The fire resistance rating of the fire barrier separating building areas from an exit access stairway shall

The fire resistance rating of the fire barrier separating building areas from shaft shall comply with 713.4

SECTION 713.4 SHAFT ENCLOSURES, FIRE RESISTIVE RATING 1 hr where connecting less than 4 stories.

TABLE 716.1 OPENING FIRE PROTECTION ASSEMBLIES

For 1 hr fire barrier:

Fire door or shutter = 1 hr Door vision panel = 100 sq. in. Sidelight = 1 hr Window assembly = fire rated glazing tested to ASTM E 119 or UL 263, per 716.1.2.3

## **CHAPTER 9, FIRE PROTECTION & LIFE SAFETY SYSTEMS**

Existing sprinklers and fire alarm (per NFPA 72) monitored by an approved supervising station. Modifications to fire protection systems submitted to fire marshal's office under separate permit. A-2 occupancy requires sprinklers, also a manual fire alarm system that activates the occupant notification system per Section 907.5

A manual fire alarm system is not required on the second floor since the B occupancies is less than 100 above the level of exit discharge. Manual fire alarm boxes are not required where the building is equipped throughout with automatic sprinkler system in accordance with 903.3.1.1 and occupant notification appliances will activate throughout the notification zones upon water flow.

#### **CHAPTER 10, MEANS OF EGRESS**

Exit access = Portion of means of egress system that leads from any occupied portion of building to an exit Means of egress = A cont. and unobstructed path of egress travel from any occupied portion of a building to a public way (3 parts: exit access, exit, exit discharge

Interior exit stair = an exit component that serves to meet one or more means of egress design requirements, such as required number of exits or exit access travel distance, and provides for a protected path of egress travel to the exit discharge or public way.

Exit access stairway = A stairway within the exit access portion of the means of egress system

1004.5 Areas without fixed seating, Exception: where approved by bldg. official, actual number of occupants, although less then determined by calculation, shall be permitted to be used.

## 1004.5 MAX FLOOR AREA ALLOWANCE PER OCC.

Accessory storage areas, mech equip rm 300 gross (using 200 net) Assembly without fixed seats, with tables and chairs 15 net Business Areas(not concentrated)150 gross (using 100 gross)

**BASEMENT:** (existing B / Office occupants @ 100 gsf / occ. = 55)

A-2, Restaurant, 15 sf / occ. = 229 occupants

A-2, Accessory Kitchen / Bar, 200 SF / occ. = 5.2 occupants S-2, Wine Storage, 200 SF / occ. = 19.3 occupants

B, Office, 100 sf / occ. = 1 occupant

A-2, Lobby, 15 sf / occ. = 32 occupantsTOTAL PROPOSED BASEMENT OCCUPANT LOAD = 287

## **FIRST FLOOR** (existing, no work on this floor):

TOTAL FIRST FLOOR OCCUPANT LOAD = 132

A-2, Restaurant (Chronic Taco) = 56 occupants B, Office, (Pacific Office Automation-POA) = 6,600 / 100 = 66 occupants.

**SECOND FLOOR (**existing and new occ. loads are equal): B. Office (vacant), 100 gsf / occ. = 62.4 occupants B, Open Office (POA), 100 gsf / occ. = 25.5 occupants

# **TOTAL BUILDING OCCUPANT LOAD = 510**

TOTAL SECOND FLOOR OCCUPANT LOAD = 91

Two exit doors from second floor = 78" & 42"

S-2, Utility Room, 300 sf / occ = 3 occupants

1005 MEANS OF EGRESS SIZING

Stairways = occ. load x .3

Other egress components: occ load x 0.2" (.15 w/sprinklers and emergency voice alarm) Each second floor exit stairway = 45.5 x .3 = 13.65". 44" & 50" width provided Each basement exit stairway = 143.5 x .3 = 43". 44" & 48" width provided

Each egress path from exit stair to exit = 189 x .2 = 37.8". greater than 44" provided First floor exterior exit door widths:

Two exit doors from basement & second floor = 36" and 42"

Distribution: the loss of any one exit shall not reduce the available capacity or width to less than 50% Doors when fully open shall not reduce required width by more than 7".

#### Doors in any position shall not reduce width by more than half. Handrail projections per 1014.8.

1006 NUMBER OF EXITS 2 exits or exit access doorways from any space shall be provided where the occupant load or common path of egress travel distance exceeds value in table 1006.2.1 (cumulative occupant load from adjacent rooms per 1004.2). Two exits required.

# 1006.2.1 SPACES WITH 1 EXIT OR EXIT ACCESS DOORWAY

A = 49 max occupants and 75' max common path of egress travel distance

 $B = 49 \text{ and } 100^{\circ}$ 

S = 29 and 100'

3 exits required if 501 to 1000 occupants

# 1006.3 EGRESS FROM STORIES

The means of egress system serving any story shall be provided with the number of separate and distinct exits or access to exits based on aggregate occ load served. Where stairs serve more than 1 story, only the occ load of each story considered individually shall be used in calculating required number of exits or access to exits serving that story.

# 1006.3.1 ADJACENT STORY

The path of egress travel to an exit shall not pass through more than one adjacent story

TABLE 1006.3.2 MINIMUM NUMBER OF EXITS OR ACCESS TO EXITS PER STORY 1-500 Occ load per story = 2 exits

# 1006.3.3(2) STORIES

A single exit or access to a single exit shall be permitted from any story where basement A, B, F occupancy = max 49 occ per story, max exit access travel distance = 75' S occupancy = 29 occ per story and 75' distance

# 1008.3 EMERGENCY POWER FOR ILLUMINATION

Stairs, ramps, aisles and lobbies and A2 assembly areas - see hatched area on floor plans

Exit access allowed through enclosed elevator lobby & if one space accessory to other.

1016.2 EGRESS THROUGH INTERVENING SPACE

1017.2 TRVAEL DISTANCE (w/sprinklers) A-2 = 250' B = 300' S-2 = 400'

# 1020 CORRIDORS

A, B & S occupancies = 0 fire rating

# **CHAPTER 29, PLUMBING FIXTURES**

**BASEMENT** Required: 1/75 occ. w.c.'s & 1/200 occ. lav's

287/2 = 144 M & 144 F = 2 lav's & 2 w.c.'s per gender Provided: Female: 3 w.c.'s & 2 lav's

Male: 2 w.c.'s, 1 urinal & 2 lav's

### SECOND FLOOR

Required WC's: 1/25 occ. for 1st 50, then 1/50 Required Lav's: 1/40 occ. for 1st 40, then 1/80 91/2 = 46 M & 46 F = 2 lav's & 2 w.c.'s per gender

Provided: Female: 2 w.c.'s & 2 lav's

Male: 1 w.c., 1 urinal & 2 lav's



# SITE INFORMATION


PROPERTY SIZE: 13,760 SF

ADDRESS: 260 LIBERTY STREET NE. SALEM OREGON 97301

ZONE: CB

ASSESSOR TAX LOT NUMBERS: TL 6900

# **VICINITY MAP**

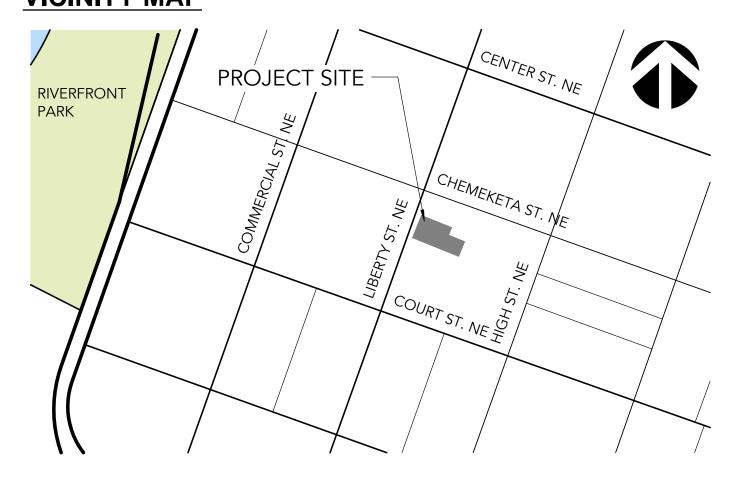

# SHEET INDEX

A0 COVER, SITE PLAN & CODE SUMMARY

A1 EXIST. BASEMENT FLOOR PLAN & RCP

A3 PROPOSED SECOND FLOOR PLAN

A4 EXISTING EXTERIOR ELEVATIONS

# A2 PROPOSED BASEMENT FLOOR PLAN

# A5 BUILDING SECTION, DETAILS & SCHEDULES

**ARCHITECT** 

Connect Architecture Laurie Simpson 503-367-8057


laurie@connectarchitecture.us 4072 N Williams Ave, Ste A

**OWNER** FT Development LLC Brian Jackson 503-641-2000 14747 NW Greenbrier Parkway Beaverton, OR 97006

Robert Hakes Construction LLC

Portland, OR 97212

CONTRACTOR 11515 ne 131st st. Vancouver, WA 98662

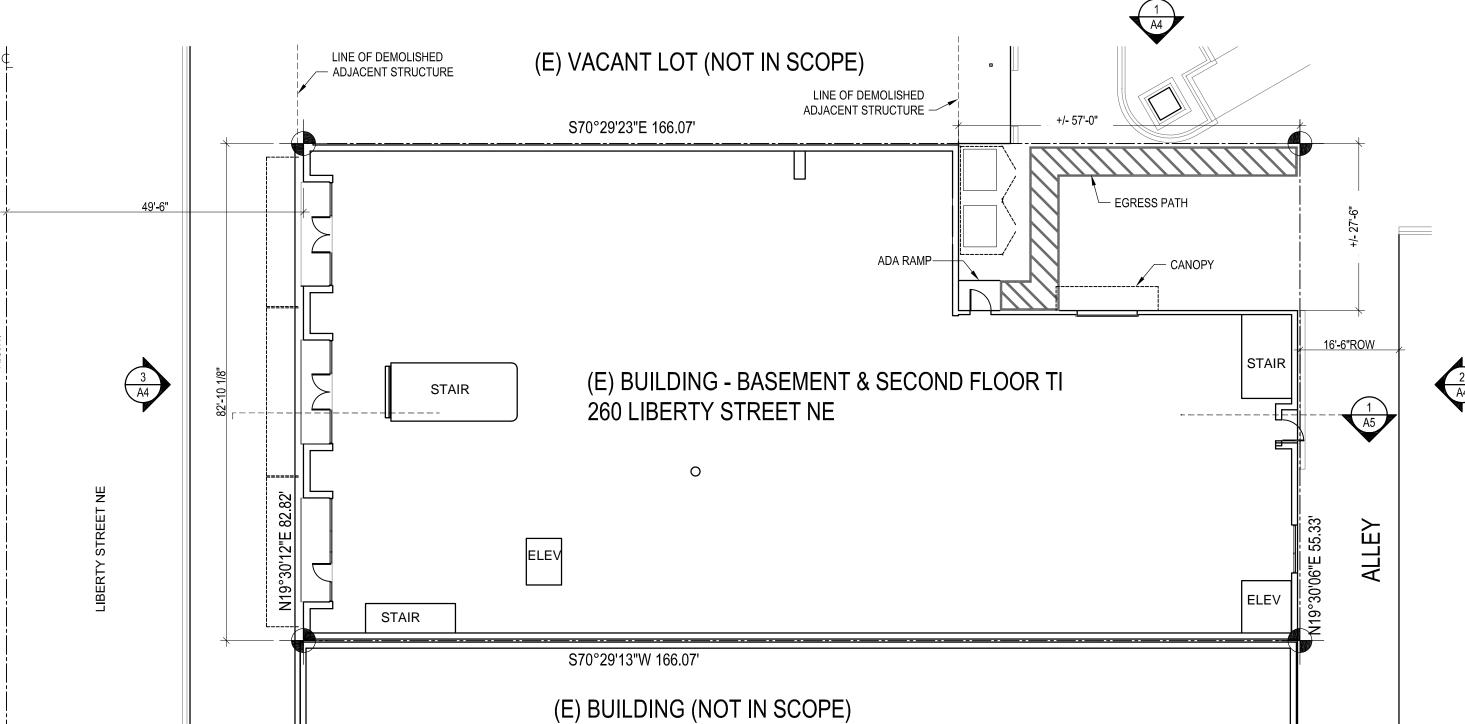

**EXISTING SITE PLAN - NO CHANGES PROPOSED** 

CONNE 4072 N. WILLI PORTLAND, C 503-367-8057

ARCHITECTURE S, SUITE A

**∞**ŏ

> DRAWING TITLE **COVER, SITE PLAN CODE SUMMARY** PROJECT NO. POA Salem 2101 ISSUE DATE REVISIONS **BUILDING PERMIT**

SUBMITTAL


CONNECT ARCHITECTURE
4072 N. WILLIAMS, SUITE A
PORTLAND, OREGON 97227

RESTAURANT & WINE STATE STREET NE

EXIST. BASEMENT FLOOR PLAN & RCP

PROJECT NO. POA S. ISSUE DATE 05.05.2 REVISIONS

SUBMITTAL

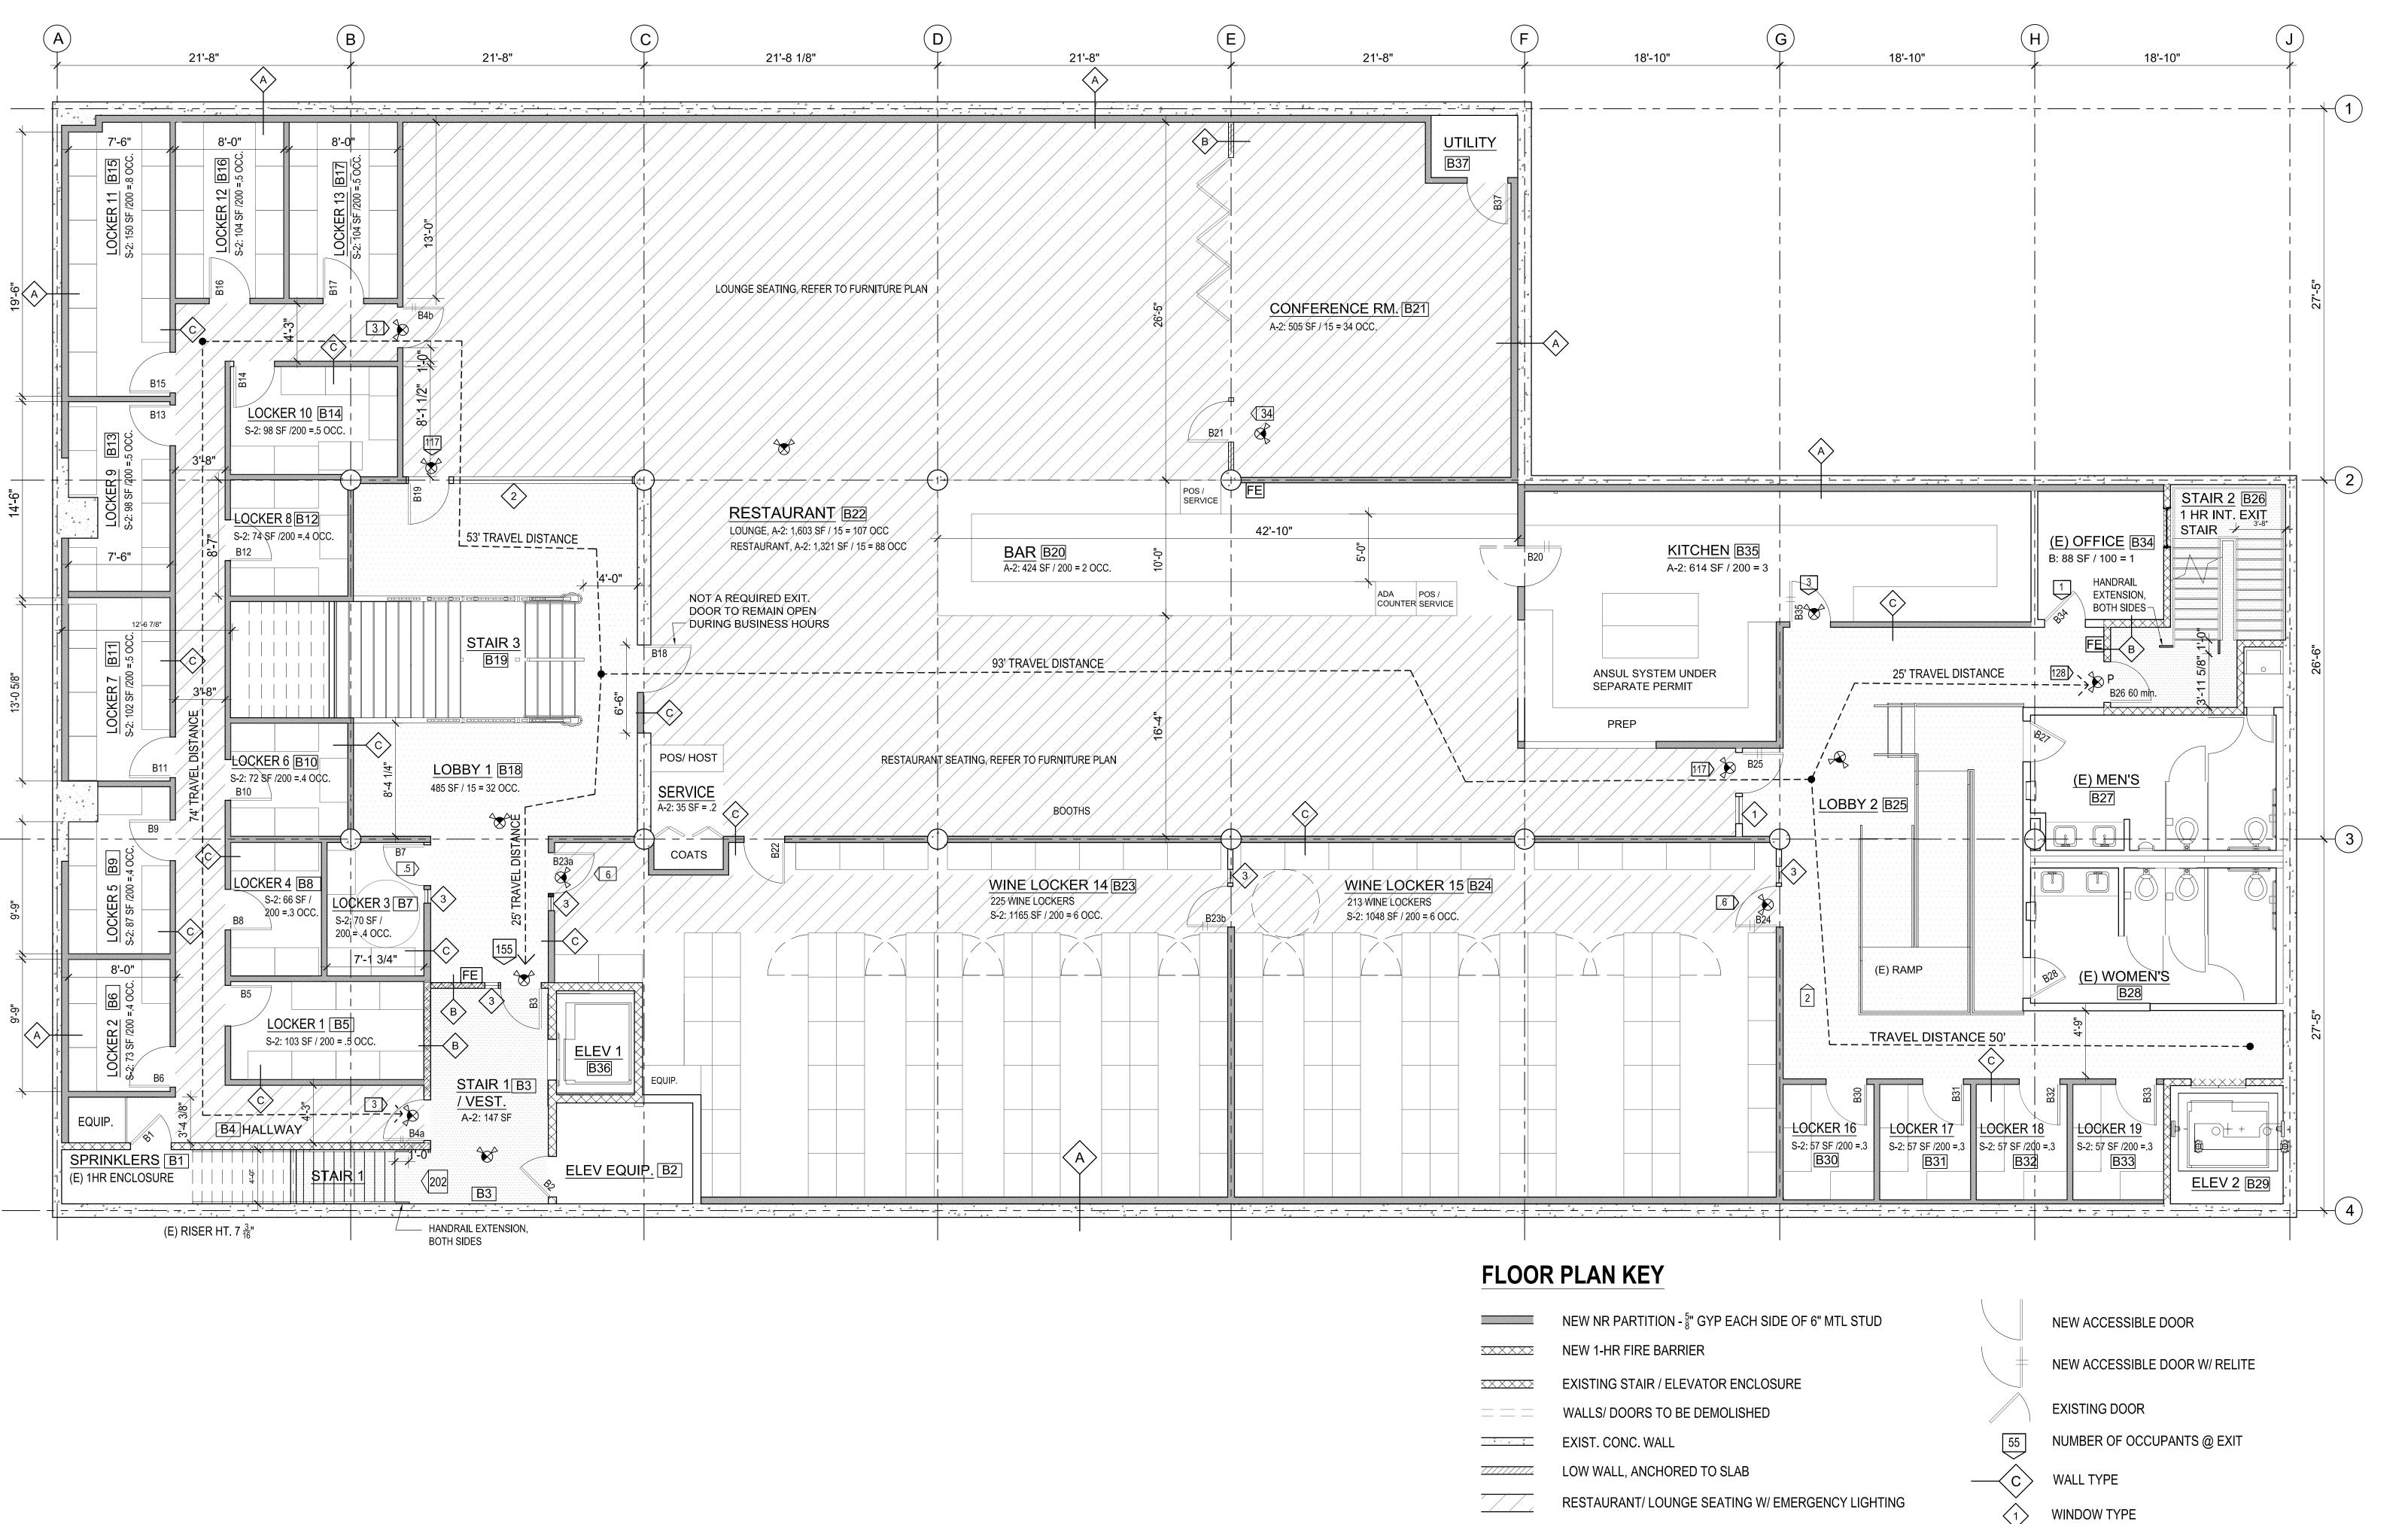

PROPOSED BASEMENT FLOOR PLAN

A2 3/16" = 1' - 0"

EXIT AREA W/ EMERGENCY LIGHTING

---→ PATH OF TRAVEL

EXIST. EXIT PASSAGEWAY W/ EMERGENCY LIGHTING

CONNECT ARCHITECTUR
4072 N. WILLIAMS, SUITE A

RESTAURANT & WIN 3460 LIBERTY STREET NE Salem, Oregon 97301

STORAGE

DRAWING TITLE

PROPOSED

BASEMENT FLOOR

PLAN

PROJECT NO. POA Salem

ISSUE DATE 06.13.22

BUILDING PERMIT
SUBMITTAL

REVISIONS


**ROOM NUMBER** 

FIRE EXTINGUISHER

EXIT SIGN, DIRECTION INDICATED

ELEV 2 ROOM NAME

**A2** 

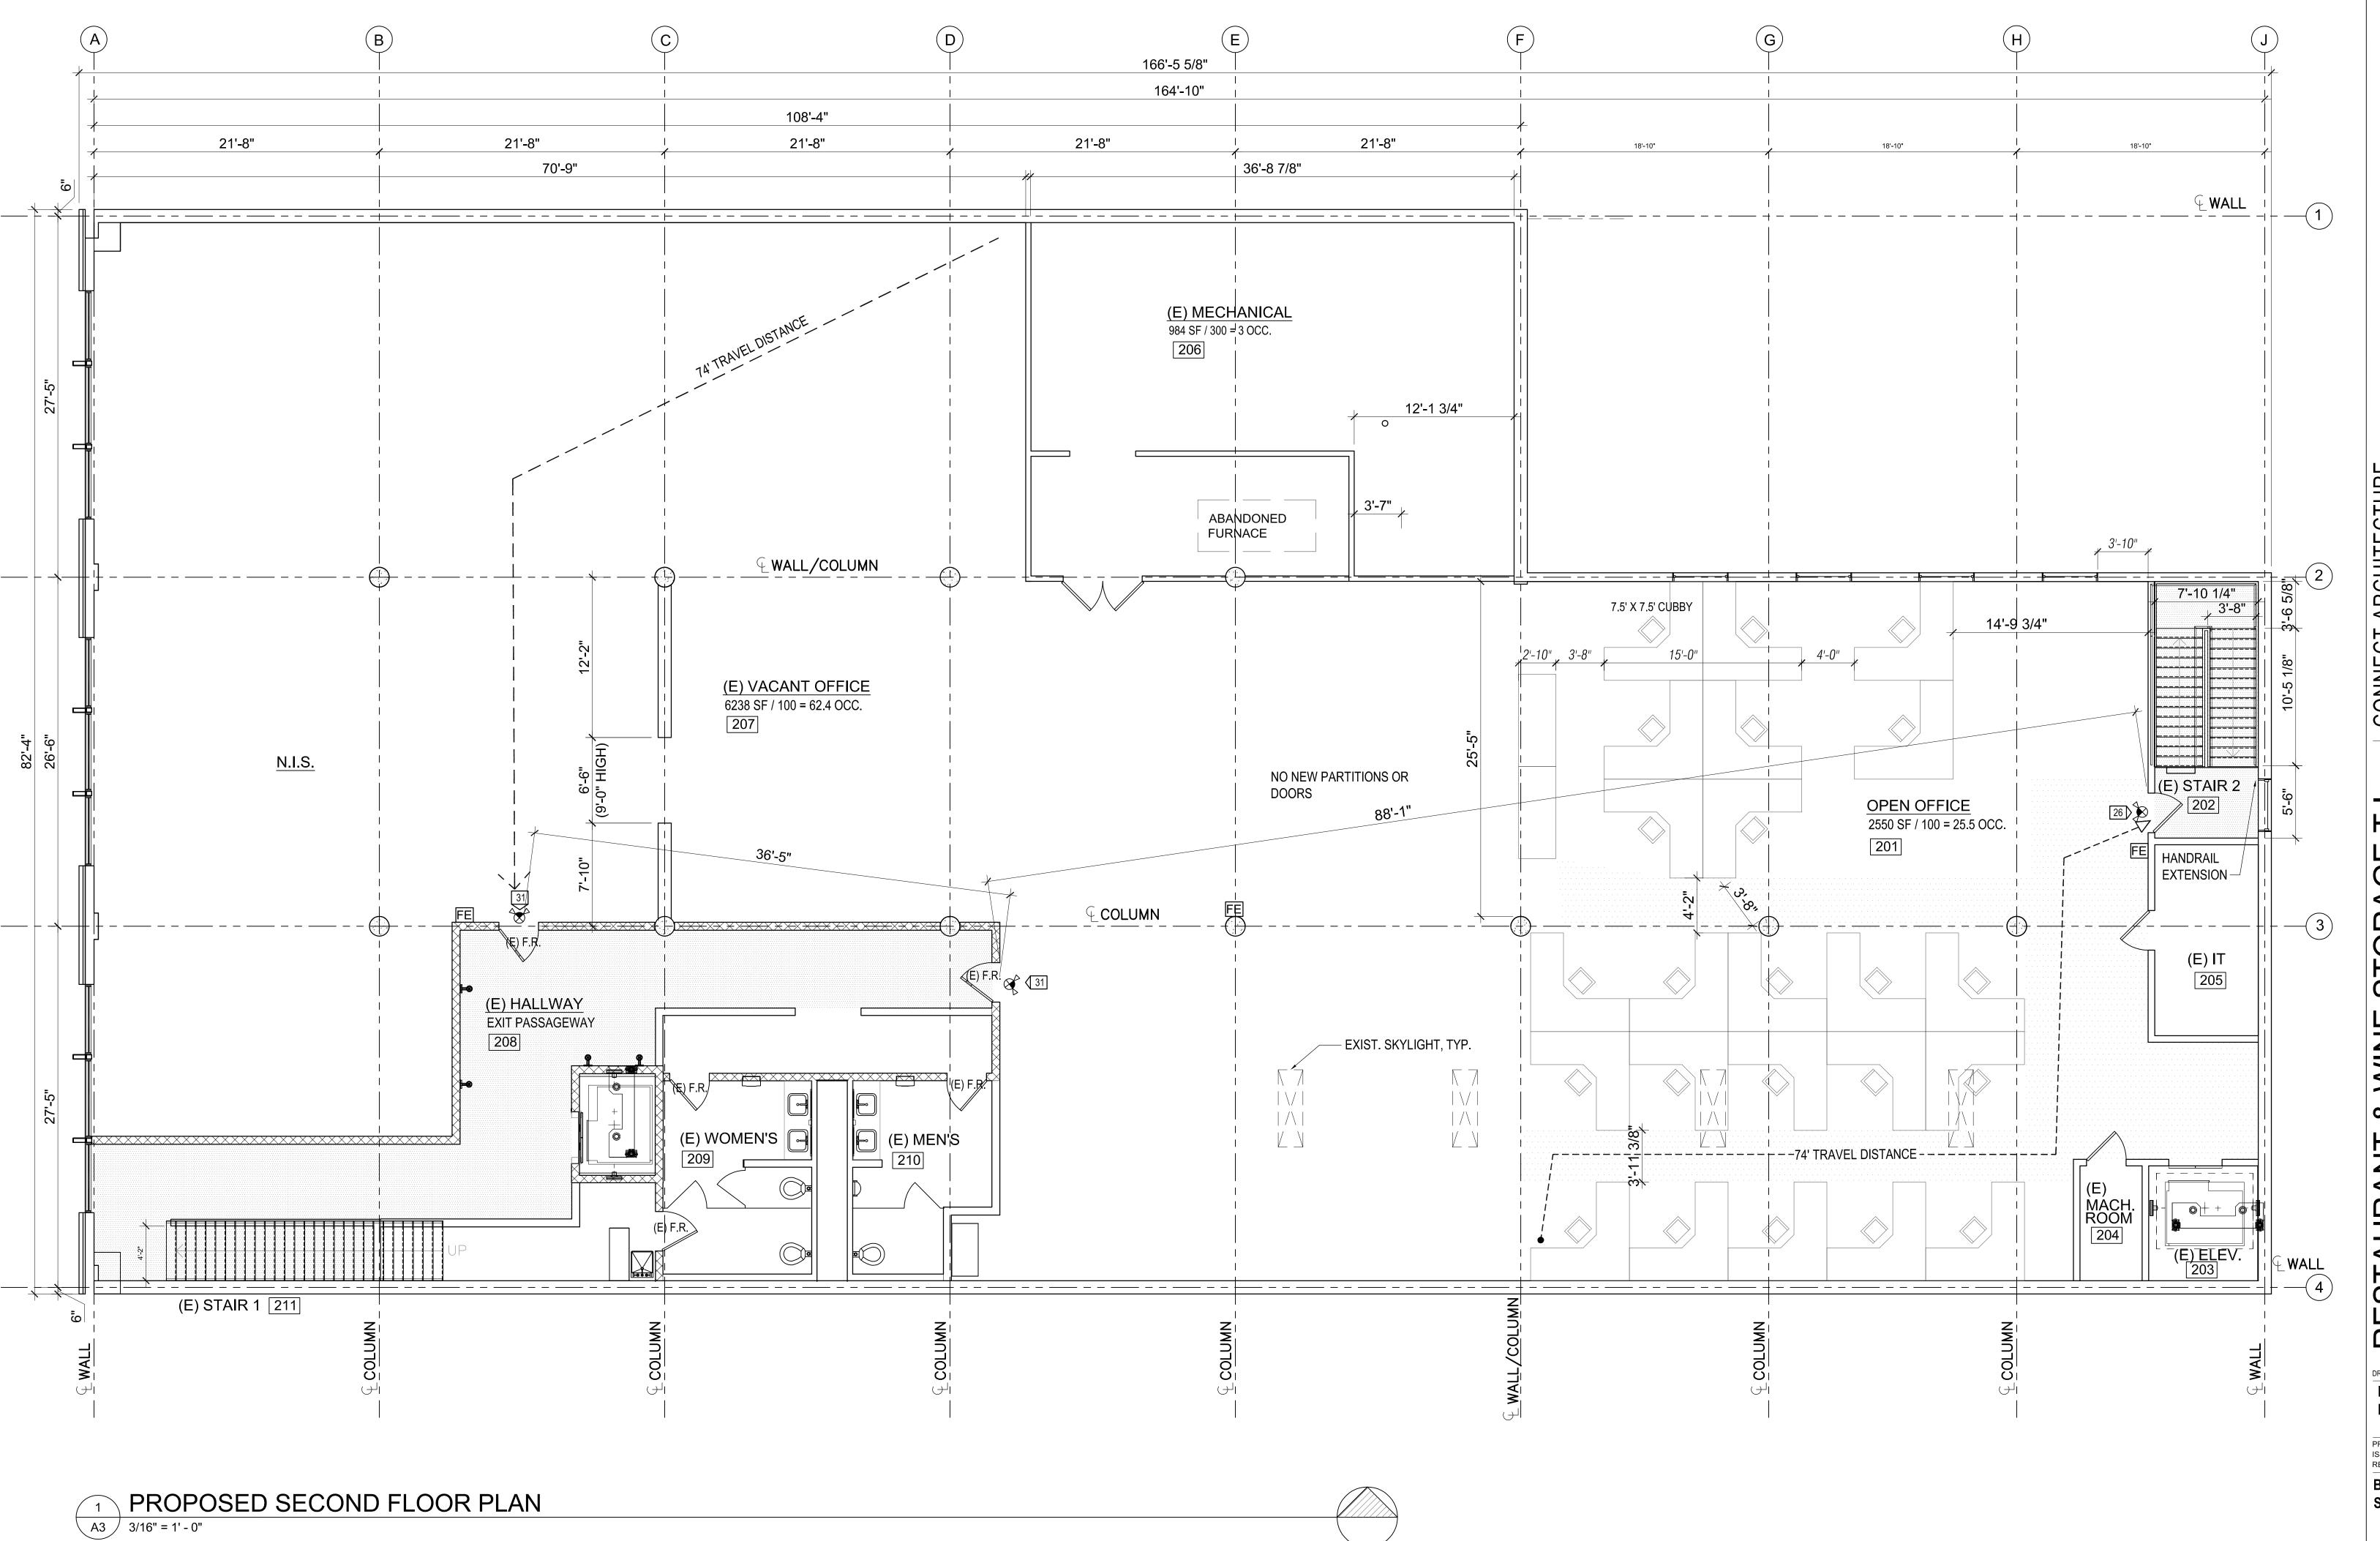

& WINE STORAGE T.I. CON

RESTAURANT & WINE STOI

DRAWING TITLE


PROPOSED SECOND
FLOOR PLAN


PROJECT NO. POA Sale
ISSUE DATE 06.13.22
REVISIONS
BUILDING PERMIT
SUBMITTAL

**A3** 

**EXISTING EXTERIOR ELEVATIONS** 

BUILDING PERMIT

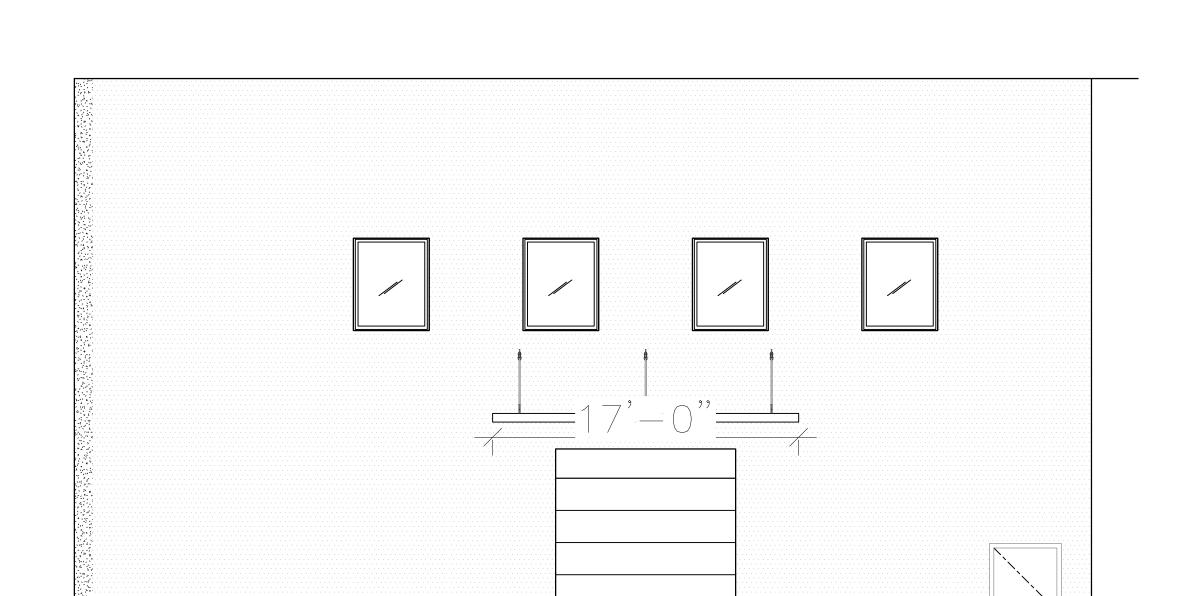


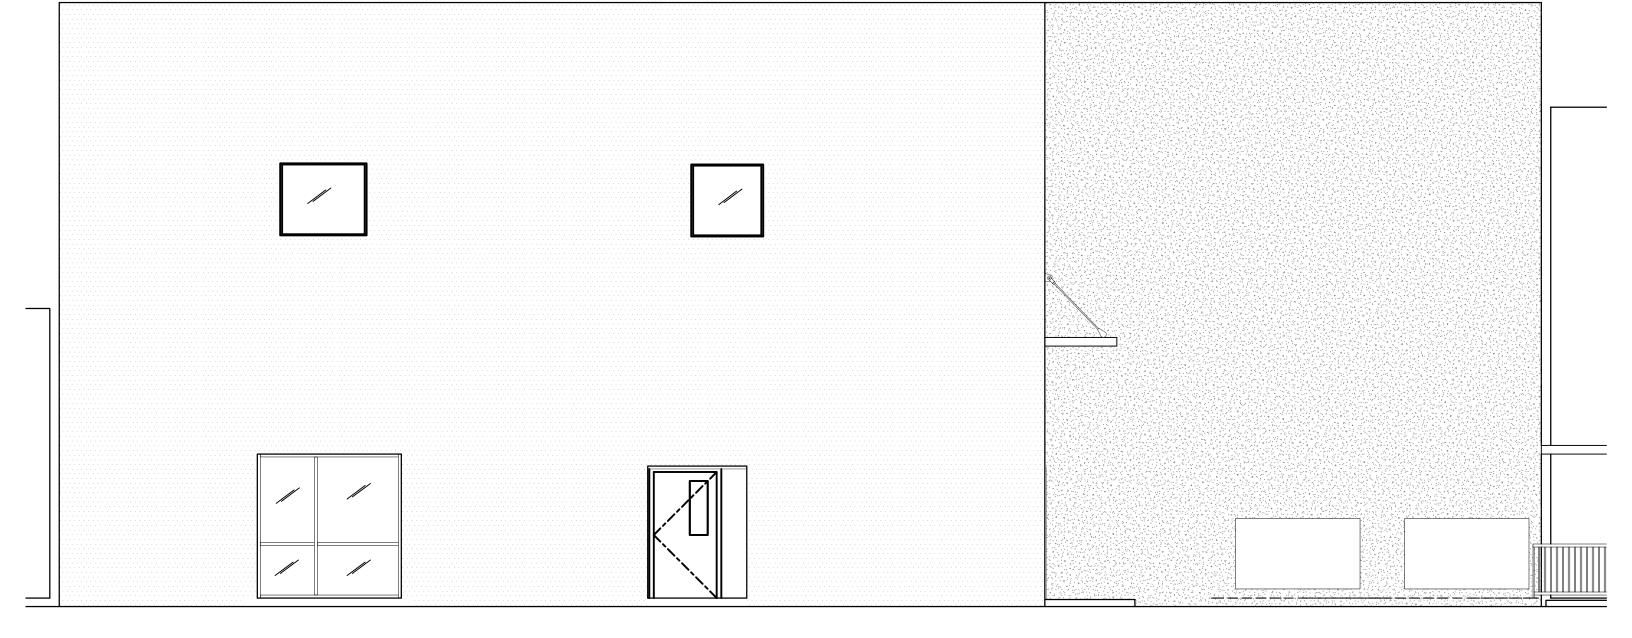


**EXISTING NORTH ELEVATION - NO CHANGES** A4 3/16" = 1' - 0"


2 EXISTING EAST ELEVATION - NO CHANGES

A4 3/16" = 1' - 0"

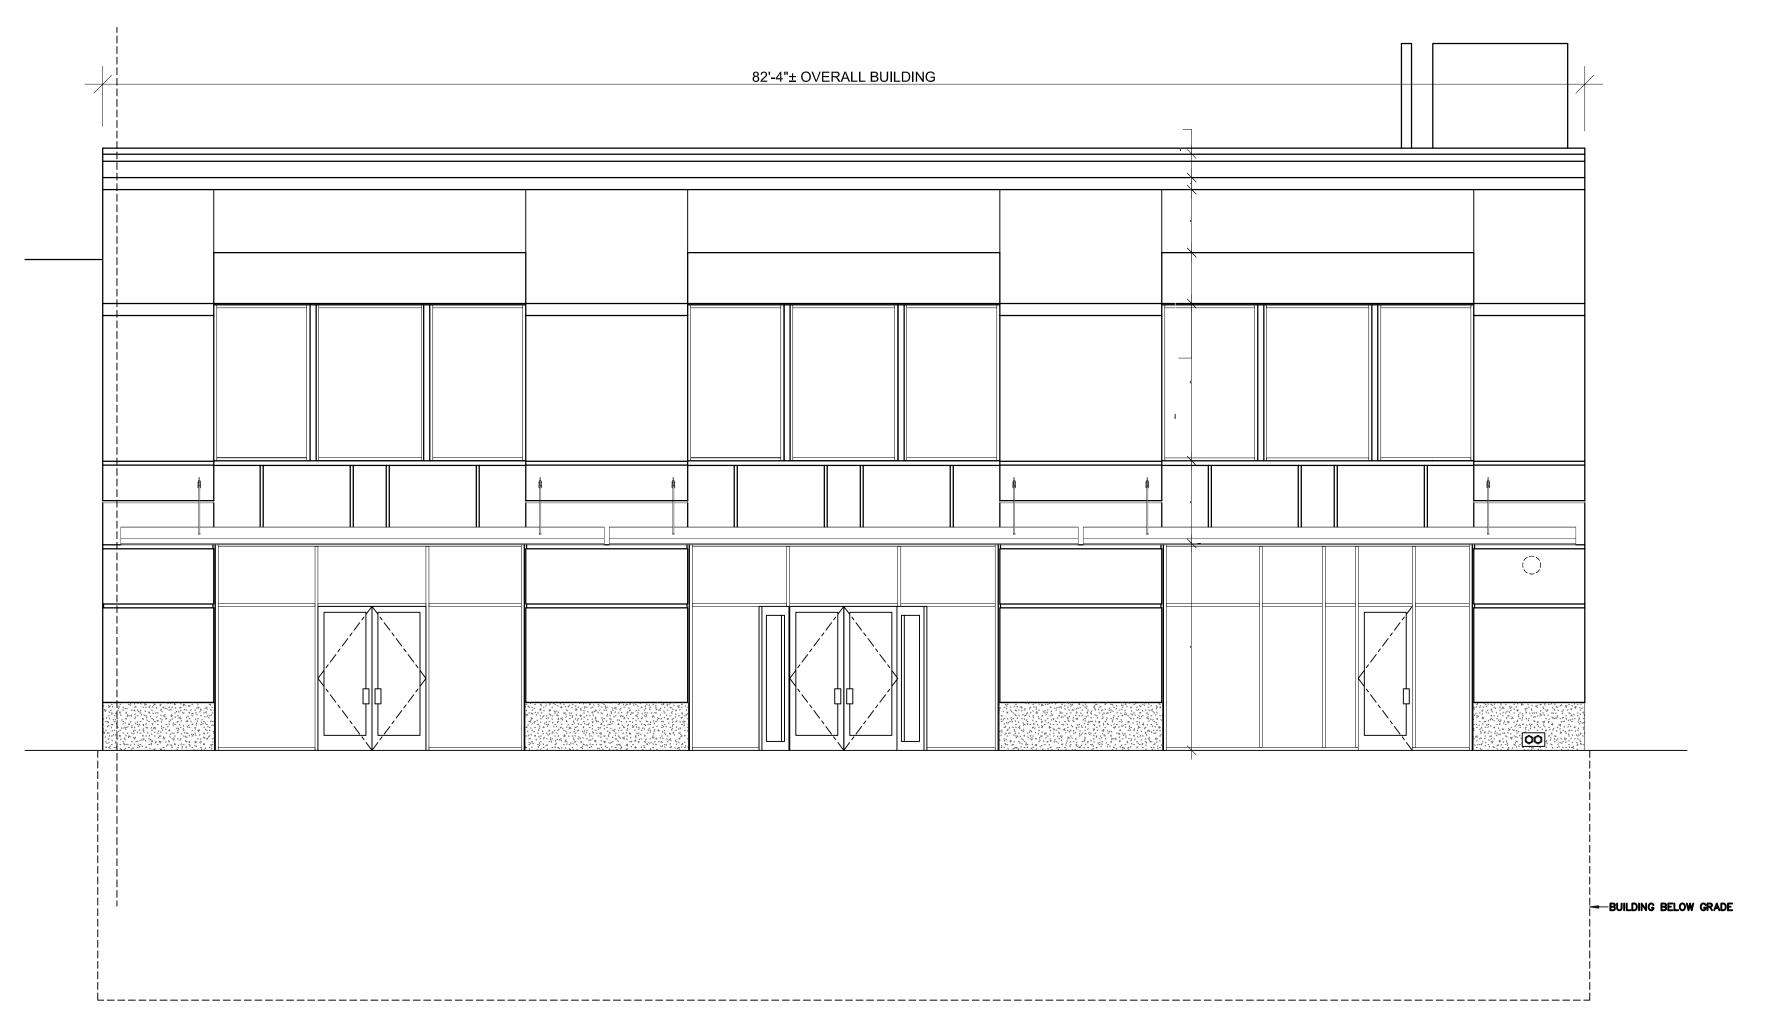


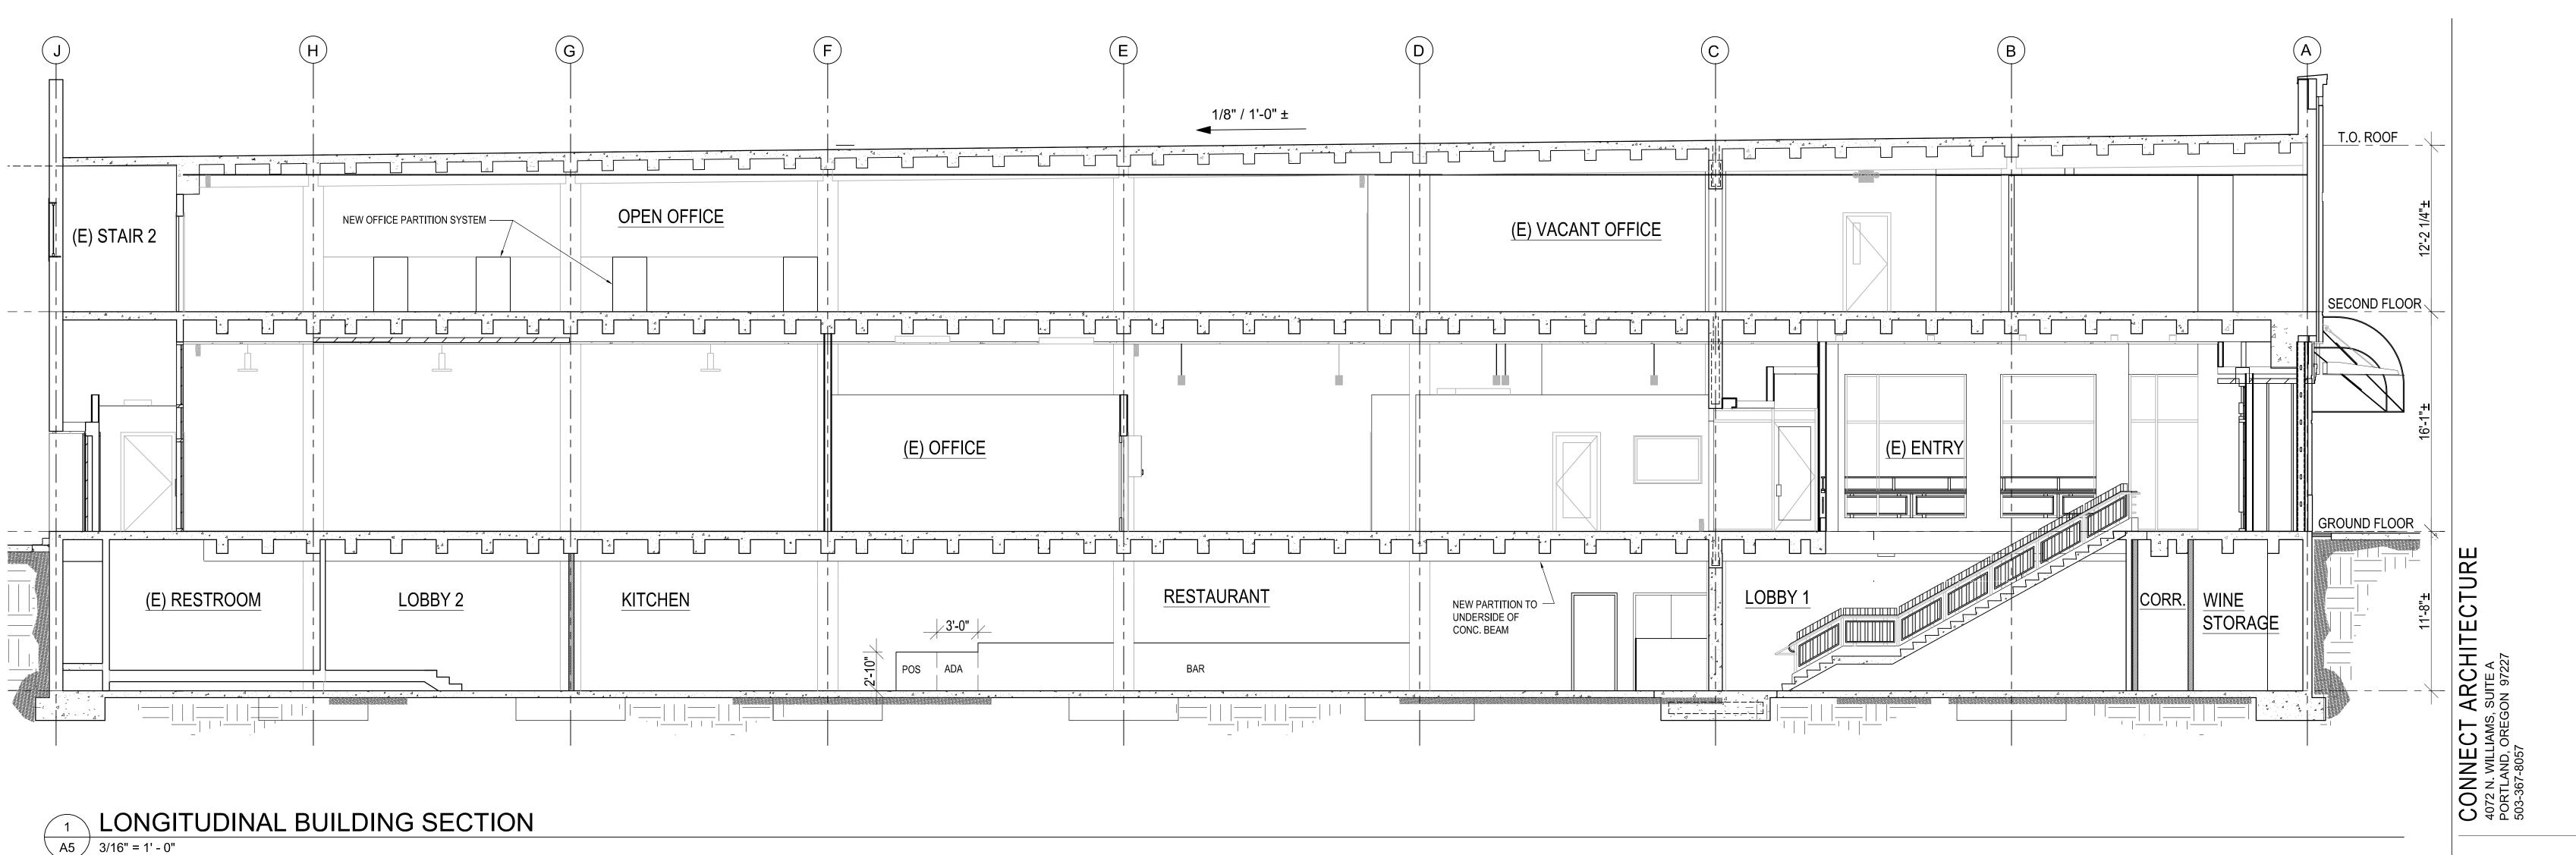




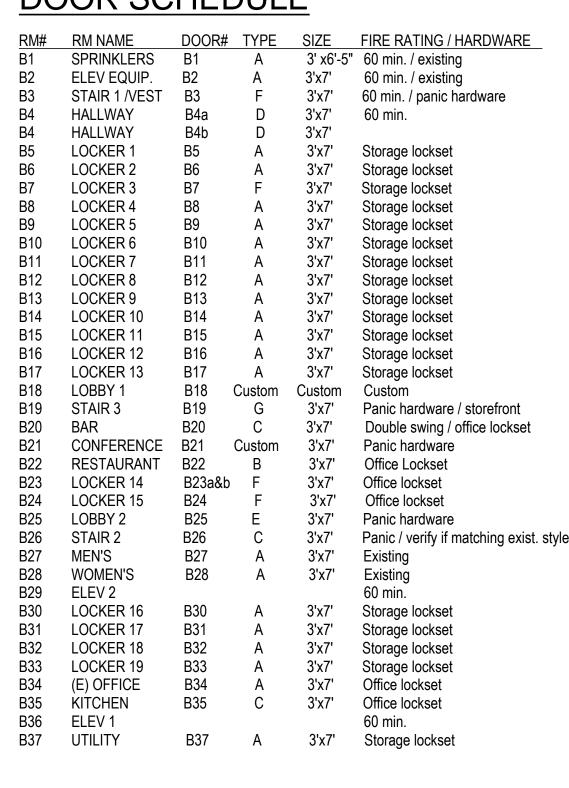




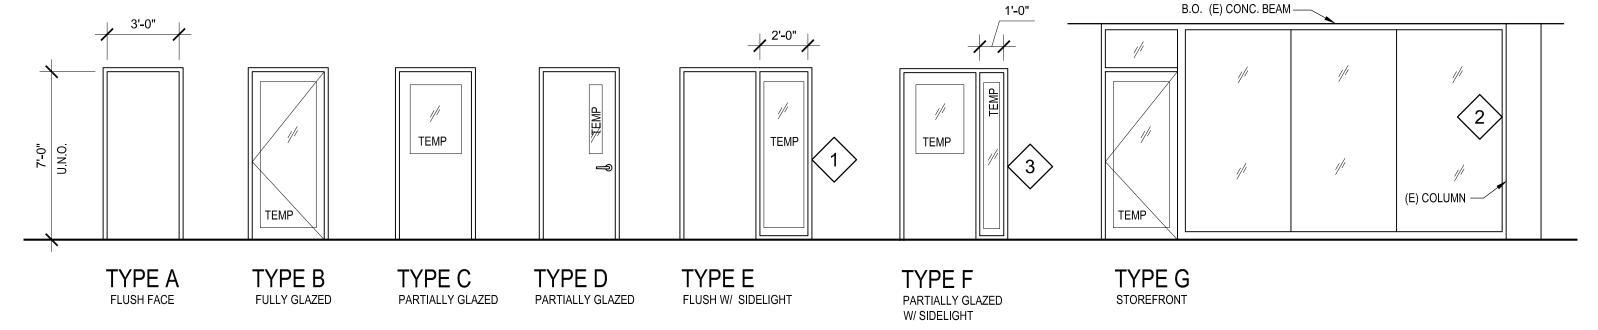




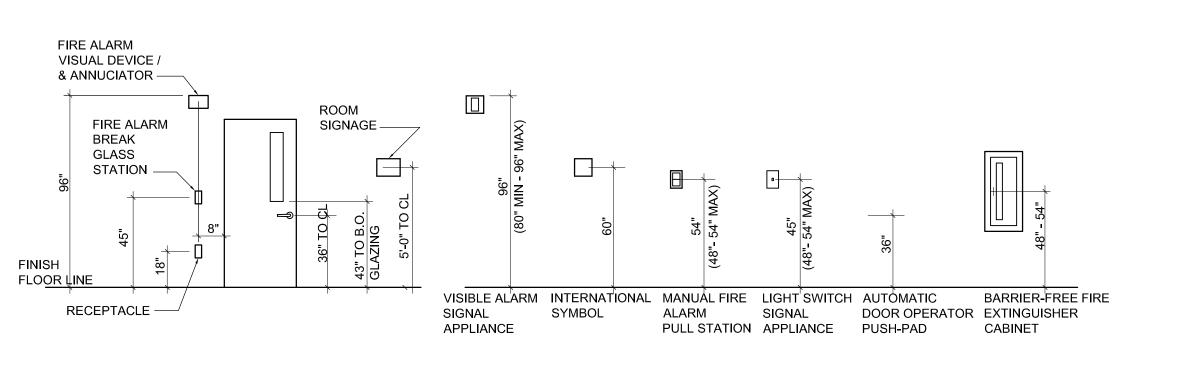




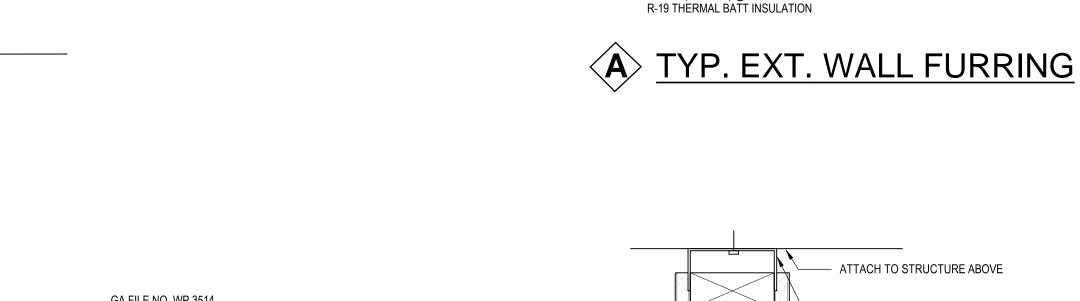

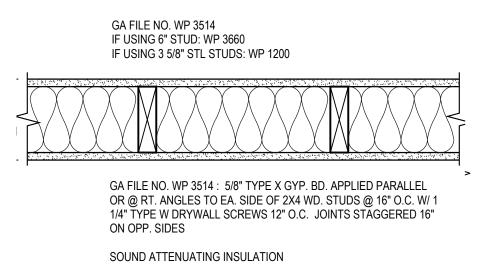




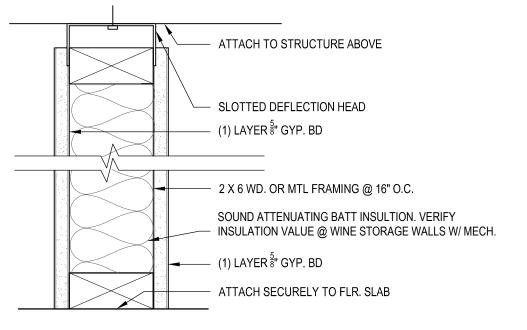

EXISTING CMU WALL W/ 1" AIR SPACE, 2x6 WD.

STUDS (OR MTL.) @ 16" O.C., CAVITY FILLED W/

TYP. INTERIOR PARTITION

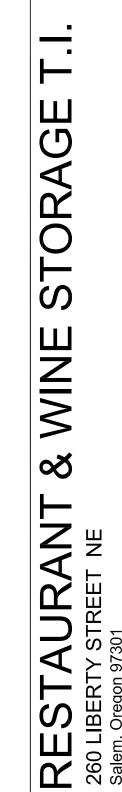

**BUILDING PERMIT** 

SUBMITTAL

DRAWING TITLE

PROJECT NO.

ISSUE DATE

REVISIONS

BLDG SECTION,

DETAILS & SCHEDULES

06.13.22