

PHOTOMETRIC PLAN SCALE: 3/32"= 1'-0'

| Calculatio | on Summary | | | - | | - | _ | | | | | |
|------------------------|-------------|-----------------------------------|-------------|-------------|--------|----------------|-----|----------|-------------------------------|---------------------------|--|--|
| Label | | | CalcType | Units | Avg | Max | Mir | n A | vg/Min | Max/Min | | |
| Overall Calcs II | | | Illuminance | Fc | 1.88 | 10.3 | 0.0 | 0.0 N.A. | | N.A. | | |
| Drive Thru Illuminance | | | Illuminance | Fc | 4.18 | 7.4 | 1.2 | 2 3.48 | | 6.17 | | |
| Parking Illuminance | | | Fc | 2.78 | 4.5 | 1.8 | 1 | .54 | 2.50 | | | |
| Luminaire | Schedule | | | | | | | | | | | |
| Symbol | Qty | Label | | Arrangement | Total | al Lamp Lumens | | LLF | Description | | | |
| Ð | 4 | AA - SLM-LED-18L-SIL-FT-40-70 | | Single | N.A. | N.A. | | 1.000 | SLM-LED-18L-SIL-FT-40-70CRI-I | | | |
| \oplus | 12 | JM-1 - OL-LED-X63-FL-11353040 | | Single | N.A. | N.A. | | | OL-LED-x63-FL-9 | | | |
| Ð | 1 | AA-1 - SLM-LED-18L-SIL-FT-40-70CR | | SINGLE | N.A. | N.A. | | | SLM-L | M-LED-18L-SIL-FT-40-70CRI | | |
| \blacksquare | 51 | EXT1_LTS14F10027MB s15070010m | | SINGLE | 96.593 | 96.593 | | | | | | |
| | - 72 | EXT2 V4-OUT-30-SB-1FT-typeC | | SINGLE | 181.22 | 181.22 | | | V4-OU | V4-OUT-30-SB | | |

20' -0" AFG

MAXIMUM 3'-0"


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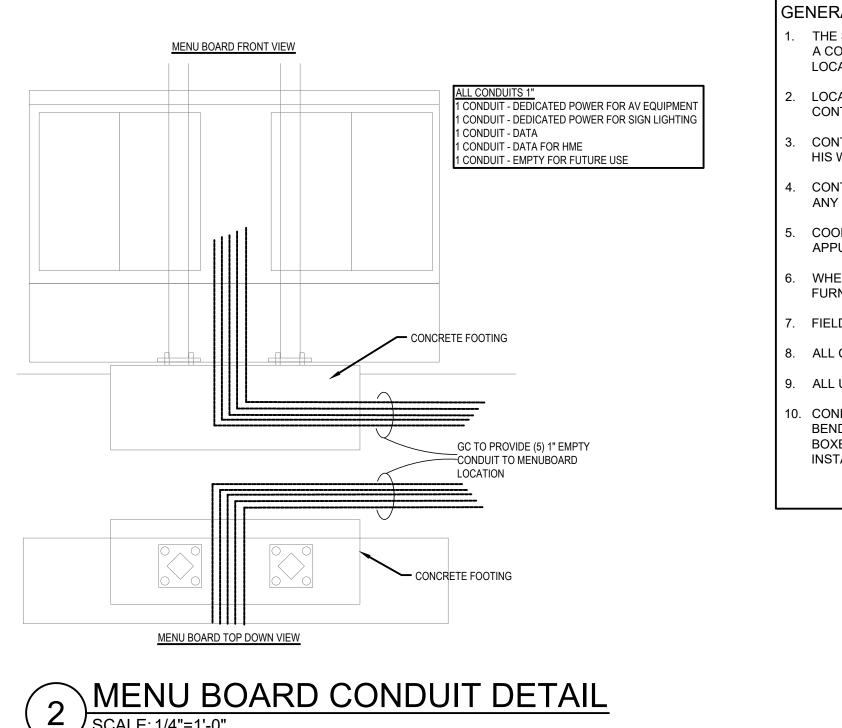



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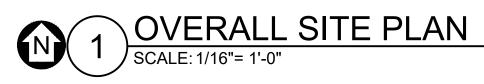
TYPICAL POLE LIGHT DETAIL SCALE: 1/4"=1'-0"



CB ANDERSON ARCHITECT 7209 Greenwood Avenue North Seattle, Washington 98103 206-782-2911 Fax 782-5624 CLIENT: JCK Birdz LLC Jersey Mike's Subs Joe Karcher 875 Country Club Road Eugene, OR 97401 Subs enter St NE) C S **Mike'** f (3805 **sey l**ast of **Jer** ist Ea **)** PLAN en lot Chicke Prown Cent 97301 SITE OTOMETRIC **Dave's Ho** Willamette Salem, OR, Ĭ 古 _____ REVISIONS: ------_____ ----------------------------------DRAWN BY: ATE -----_____ SCALE: DATE: MARCH 4 2022 JOB NUMBER: 1952.0 SHEET NUMBER: ES100



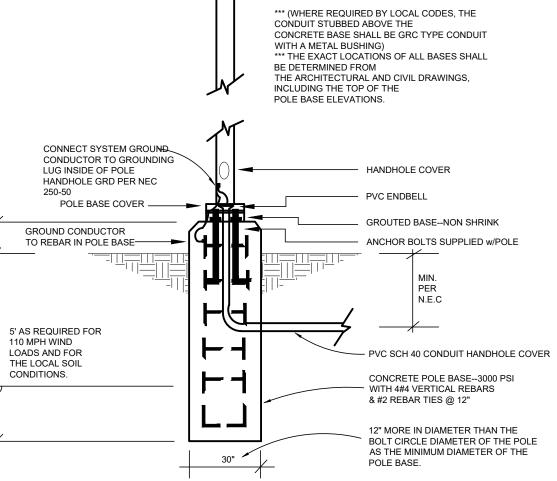

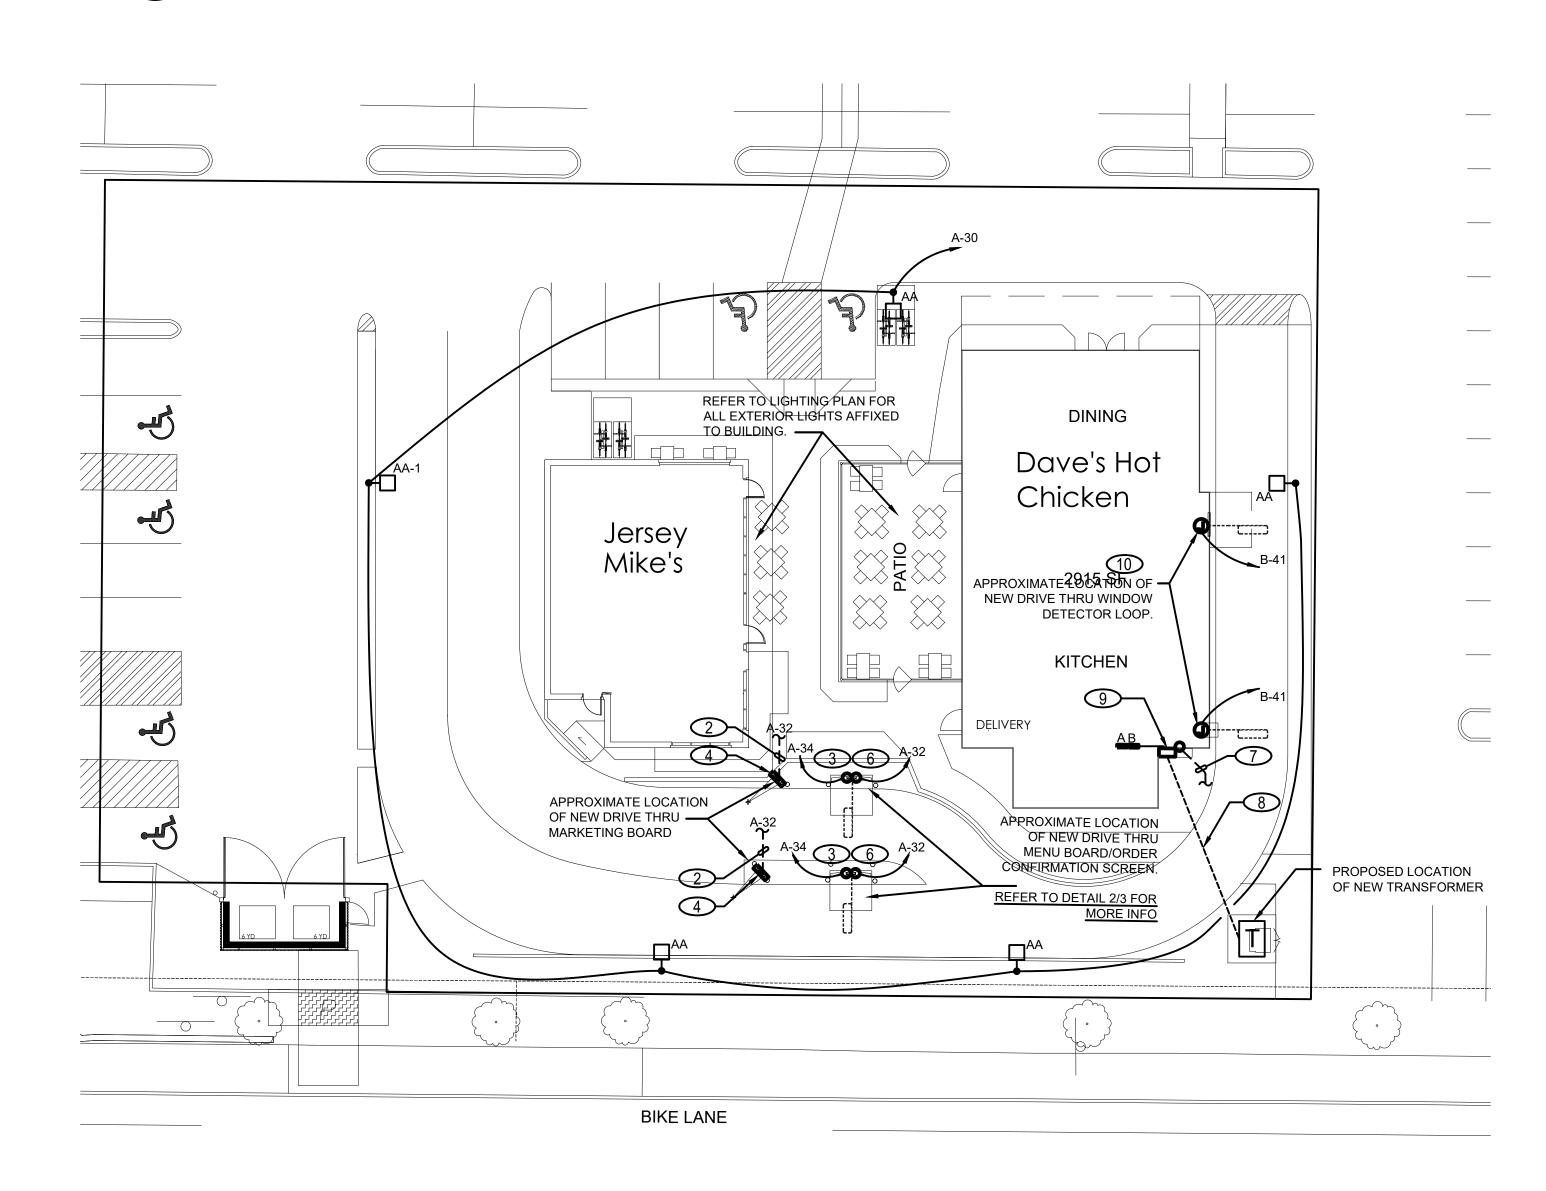

GENERAL NOTES

THE SCOPE OF THE ELECTRICAL WORK SHALL INCLUDE FURNISHING, INSTALLING & TESTING ALL ELECTRICAL SYSTEMS FOR A COMPLETE & FULLY OPERABLE INSTALLATION COMPLY WITH LATEST VERSION OF ALL APPLICABLE NATIONAL, STATE & LOCAL CODES.

LOCATIONS OF NEW ELECTRICAL SYSTEM, EQUIPMENT & DEVICES SHALL BE FIELD VERIFIED BY THE TENANT'S GENERAL CONTRACTOR (T.G.C.).

CONTRACTOR SHALL VISIT THE SITE & FAMILIARIZE HIMSELF WITH THE NEW CONDITIONS UNDER WHICH HE IS TO PERFORM HIS WORK. NO ALLOWANCE WILL BE MADE FOR FAILURE TO COMPLY.

CONTRACTOR SHALL FIELD VERIFY ALL CONDITIONS & SHALL IMMEDIATELY NOTIFY THE OWNER'S PROJECT MANAGER OF ANY DISCREPANCIES.

COORDINATE LOCATIONS & ROUTING OF FEEDERS TO PANELBOARDS WITH ALL OTHER TRADES & PROVIDE ALL NECESSARY APPURTENANCES AS REQUIRED.

WHERE THE WORD "PROVIDE" IS USED, THE WORD IS UNDERSTOOD TO MEAN "THE ELECTRICAL CONTRACTOR SHALL FURNISH, INSTALL & MAKE FINAL CONNECTION TO THE EQUIPMENT", UNLESS OTHERWISE NOTED.

FIELD VERIFY ALL UTILITIES IN THE AREA PRIOR TO TRENCHING.


ALL CONDUITS, CONDUCTORS & JUNCTION BOXES INSTALLED UNDERGROUND SHALL BE WET LOCATION RATED.


ALL UNDERGROUND CONDUITS SHALL BE INSTALLED IN COMPLIANCE WITH SECTION 300.5 OF THE C.E.C.

). CONDUIT BENDS - NUMBER OF BENDS IN ONE RUN. THERE SHALL NOT BE MORE THAN THE EQUIVALENT OF FOUR QUARTER BENDS (360 DEGREES TOTAL) BETWEEN PULL POINTS (I.E. JUNCTION BOX) CONTRACTOR TO PROVIDE ADDITIONAL JUNCTION BOXES AS NEEDED. (NOTE: ALL JUNCTION BOXES SHALL BE RATED (PER CODE) FOR THE LOCATION FOR WHICH THEY ARE INSTALLED I.E. W.P. &/OR TRAFFIC-RATED).

KEYED NOTES: (#)

- FOR WET LOCATION FOR THE ENTIRE RUN.
- 2. E.C. TO ROUTE CONDUIT/WIRE MIN. OF 24" DEEP.
- VENDOR &: OWNER.
- INSTALLATION WITH SIGN VENDOR & OWNER.
- 5. NOT CURRENTLY USED
- COORDINATE INSTALLATION WITH SIGN VENDOR & OWNER.
- 7. (2) 2" CONDUITS STUB-UP FOR TELEPHONE & CATV. EXTEND CONDUITS TO TELEPHONE DEMARCATION POINT. FIELD VERIFY.
- 8. 120/208V, 3PH, 4W, 400A ELECTRICAL SERVICE FROM UTILITY TRANSFORMER TO NEW CT CABINET. 2 SETS OF 4 #350 KCMIL.
- 9. NEW "MSB" BY EC 120/208V, 3PH 4W, 400A.
- BY OTHERS.
- NECESSARY DEVICES.
- CHICKEN TENANT SPACE (FIELD VERIFY EXACT LOCATION). DETECTOR LOOP WIRING PROVIDED & INSTALLED BY OTHERS.
- INSTALLED BY OTHERS.)
- CANOPY (LIGHTING) & ORDER CONFIRM. SCREEN (POWER). FINAL CONNECTIONS TO DRIVE THRU EQUIPMENT PROVIDE BY DRIVE THRU EQUIPMENT INSTALLER.
- INSTALLER.

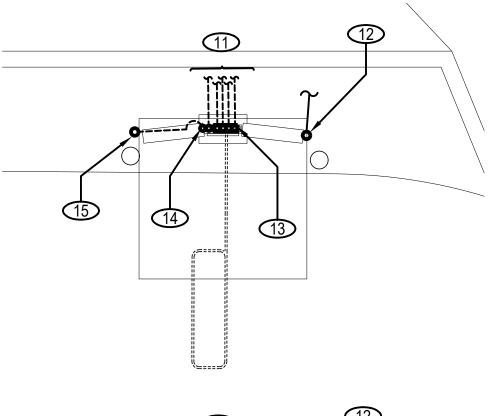

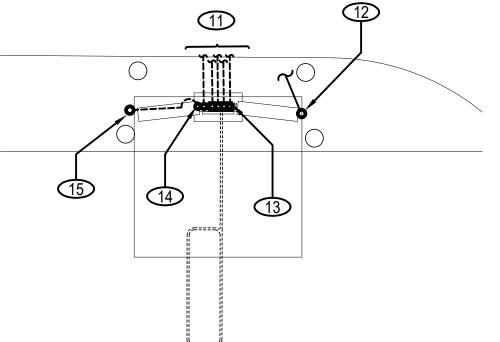



FOR CONTINUATION OF BRANCH CIRCUITRY, SEE SHEET E200 LIGHTING PLAN AND DETAILS FOR CONTROL. E.C. TO USE HEAVY-DUTY 3#10 GAUGE WIRE LISTED

FOR CONNECTION TO MENU BOARD DRIVER. VERIFY EXACT LOCATION & POWER REQUIREMENTS PRIOR TO ANY WORK. COORDINATE INSTALLATION WITH SIGN

FOR CONNECTION TO DRIVE-THRU'S DIRECTIONAL SIGN LED DRIVER. VERIFY EXACT LOCATION & POWER REQUIREMENTS PRIOR TO ANY WORK. COORDINATE

6. FOR CONNECTION TO DRIVE-THRU'S MENU WEATHER CANOPY LED DRIVER. VERIFY EXACT LOCATION & POWER REQUIREMENTS PRIOR TO ANY WORK.

10. CONTRACTOR TO PROVIDE/INSTALL 1" DETECTOR LOOP CONDUIT WITH PULL WIRE AT DRIVE THRU WINDOW (FIELD VERIFY EXACT LOCATION). PROVIDE W.P. JUNCTION BOX (SIZED PER CODE) AS NEEDED FOR CONNECTION TO INTERIOR CONDUIT STUB-OUT LOCATION. DETECTOR LOOP WIRING PROVIDED & INSTALLED

CONTRACTOR TO TRENCH CONDUIT(S) FROM OWNER'S APPROVED STUB-OUT LOCATION TO NEW DRIVE THRU EQUIPMENT. CONTRACTOR SHALL FIELD VERIFY EXACT EQUIPMENT LOCATION WITH EQUIPMENT PROVIDER PRIOR TO START OF WORK. ROUTING OF CONDUIT SHALL BE DETERMINED IN FIELD. PROVIDE ALL

12. CONTRACTOR TO PROVIDE/INSTALL 1" DETECTOR LOOP CONDUIT WITH PULL WIRE & STUB-UP INTO MENU BOARD BASE FOR EXTENSION TO DAVE'S HOT

13. CONTRACTOR TO PROVIDE (5) 1" EMPTY CONDUITS WITH PULL WIRES STUB-UP INTO DRIVE THRU MENU BOARD BASE. REFER TO DETAIL 2 ON THIS SHEET. CONTRACTOR TO STUB-UP CONDUITS INSIDE BASE OF DRIVE THRU EQUIPMENT AS DIRECTED BY DRIVE THRU EQUIPMENT/SIGNAGE INSTALLER. VERIFY FIELD DETECTOR LOOP WIRING CONDUIT STUB-UP LOCATION &/OR CONNECTION POINT (TO MENU BOARD SPEAKER TERMINAL DETECTOR LOOP) WITH DRIVE THRU EQUIPMENT INSTALLER. SEE LIGHTING PLAN SHEETS E100 FOR ADDITIONAL INFORMATION. (NOTE: DATA, AUDIO & DETECTOR LOOP WIRING PROVIDED &

14. CONTRACTOR TO PROVIDE CONDUIT & CONDUCTORS FOR POWER TO NEW DRIVE THRU MENU BOARD (LIGHTING), MENU BOARD CANOPY (LIGHTING) & ORDER CONFIRM. SCREEN (POWER). CONTRACTOR TO STUB-UP CONDUIT/CONDUCTORS INSIDE BASE OF DRIVE THRU EQUIPMENT AS DIRECTED DRIVE THRU EQUIPMENT INSTALLER. TERMINATE CONDUCTORS IN JUNCTION BOX (SIZE PER CODE) FOR FUTURE CONNECTION TO MENU BOARD (LIGHTING), MENU BOARD

15. CONTRACTOR TO PROVIDE (1) 1" CONDUIT WITH PULL WIRE STUBBED DOWN THRU MENU BOARD CONCRETE BASE, ROUTED UNDERGROUND & STUBBED-UP INTO CONCRETE BASE FOR MENU BOARD CANOPY SUPPORT POLE. COORDINATE EXACT STUB-UP LOCATION & ROUTING OF CONDUIT WITH DRIVE THRU EQUIPMENT

3 MENU BOARD ENLARGED PLAN SCALE: 1/4"=1'-0"



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