## LAND USE SUBMISSION

03.09.2022




# CDP SALEM - BUILDING C

5205 BATTLE CREEK RD SE SALEM, OR 97306



**GENERAL PROJECT NOTES PROJECT TEAM PROJECT SUMMARY** SHEET INDEX SHEET # SHEET NAME REFER TO OWNER-CONTRACTOR AGREEMENT FOR GENERAL CONDITIONS. WHERE CDP OREGON LLC THERE IS A CONFLICT BETWEEN THE CONTRACT AND NOTES HEREIN, THE CONTRACT OWNER PROJECT DESCRIPTION: 3-STORY WOOD FRAMED MULTIFAMILY BUILDING FEATURING 18 126 NE ALBERTA ST #202 TAKES PRECEDENCE. RESIDENTIAL UNITS, LAUNDRY ROOM AND FIRE RISER ROOM. GENERAL PORTLAND, OR 97211 TEL: 971.533.7466 GROSS AREA: 20,201 SF G0.01 GENERAL PROJECT INFORMATION FAX: N/A GENERAL CONTRACTOR IS RESPONSIBLE FOR THE FULL SET OF CONSTRUCTION G1.01 CONTACT: THOMAS ELDRIDGE CODE SUMMARY DOCUMENTS, INCLUDING BUT NOT LIMITED TO DRAWINGS, SPECIFICATIONS, AND EMAIL: THOMAS@COMMUNITYDEVPARTNERS.COM PROJECT ADDRESS: 5205 BATTLE CREEK RD SE THE CONTRACTOR SHALL FIELD VERIFY ALL CONDITIONS AND DIMENSIONS PRIOR TO SALEM, OR 97306 CONTRACTOR LMC CONSTRUCTION ANY WORK AND SHALL BE RESPONSIBLE FOR ALL WORK AND MATERIALS INCLUDING ARCHITECTURAL THOSE FURNISHED BY SUBCONTRACTORS. 19200 SW TETON AVE LEGAL DESCRIPTION: 083W14/ 118 AND 300 ARCHITECTURAL GENERAL NOTES AND DIAGRAMS A0.01 TUALATIN, OR 97062 DIMENSIONS TAKE PRECEDENCE OVER DRAWINGS: DO NOT SCALE DRAWINGS TO ACCESSIBILITY DIAGRAMS - RESIDENTIAL DETERMINE ANY LOCATIONS. THE ARCHITECT SHALL BE NOTIFIED OF ANY TEL: 503.646.0521 A0.10 FAX: 503.646.6823 DISCREPANCY PRIOR TO CONTINUING WITH WORK. ZONING: RM-II A0.20 **ASSEMBLIES** GENERAL CONTRACTOR SHALL KEEP THE CONSTRUCTION SITE IN A BROOM CLEAN CONTACT: CHRIS DUFFIN EMAIL: CHRISD@IMCCONSTRUCTION.COM CONDITION AT ALL TIMES DURING THE PROJECT. A2.11 FIRST & SECOND FLOOR PLANS THE CONTRACTOR SHALL REPORT TO THE ARCHITECT ANY ERRORS, INCONSISTENCIES A2.13 THIRD FLOOR & ROOF PLANS OR OMISSIONS HE OR SHE MAY DISCOVER. BRING UNFORSEEN CONDITIONS TO ARCHITECT SCOTT | EDWARDS ARCHITECTS, LLP ATTENTION OF ARCHITECT UPON DISCOVERY AT ANY POINT. THE MEANS OF 2525 E. BURNSIDE STREET A3.01 **EXTERIOR ELEVATIONS** CORRECTING ANY ERROR OR UNFORSEEN CONDITION SHALL FIRST BE APPROVED BY PORTLAND, OREGON 97214 THE ARCHITECT. A3.10 RENDERINGS TEL: 503.226.3617 ALL REQUIRED CITY AND/OR COUNTY LICENSE SHALL BE ACQUIRED AND PAID FOR BY FAX: 503.226.3715 A5.01 WALL SECTIONS THE INDIVIDUAL TRADE. CONTACT: DAVE MOJICA THE ARCHITECT WILL REVIEW SHOP DRAWINGS AND SAMPLES FOR CONFORMANCE A7.01 **EXTERIOR DETAILS** EMAIL: DMOJICA@SEALLP.COM WITH THE DESIGN CONCEPT OF THE PROJECT. THE ARCHITECT'S REVIEW OF A SEPARATE ITEM SHALL NOT INDICATE APPROVAL OF AN ASSEMBLY IN WHICH THE ITEM WES TECH ENGINEERING 3841 FAIRVIEW INDUSTRIAL DR SE #100 **ENGINEER** IT SHALL BE THE RESPONSIBILITY OF THE CONTRACTOR TO VERIFY LOCATION OF ALL SALEM, OR 97302 EXISTING UTILITIES WHETHER SHOWN HEREIN OR NOT AND TO PROTECT THEM FROM TEL: 503.585.2474 DAMAGE. THE CONTRACTOR SHALL BEAR ALL EXPENSES OF REPAIR OR FAX: N/A REPLACEMENT OF UTILITIES OR OTHER PROPERTY DAMAGED BY OPERATIONS IN CONTACT: STEVE WARD CONJUNCTION WITH THE EXECUTION OF THE WORK. EMAIL: SWARD@WESTECH-ENG.COM CITY APPROVED PLANS SHALL BE KEPT IN A SECURE PLACE AND SHALL NOT BE USED SEPARATE PERMITS AND DEFERRED SUBMITTAL BY WORKERS. THE CONTRACTOR SHALL BE RESPONSIBLE THAT ALL PLACE 735 NW 18TH AVENUE LANDSCAPE SUBCONTRACTORS' CONSTRUCTION SETS REFLECT THE SAME INFORMATION. THE **BIDDER DESIGN ITEMS** ARCHITECT CONTRACTOR SHALL ALSO MAINTAIN, IN GOOD CONDITION, ONE COMPLETE SET OF PORTLAND, OR 97209 STAMPED CITY APPROVED PLANS WITH ALL REVISIONS, ADDENDUMS, AND CHANGE TEL: 503 334 2080 ORDERS ON THE PREMISES AT ALL TIMES. THESE ARE TO BE UNDER THE CARE OF THE FAX: N/A JOB SUPERINTENDENT AND MUST BE MADE AVAILABLE TO BUILDING AND FIRE CONTACT: MAURICIO VILLARREAL EMAIL: MAURICIO.VILLARREAL@PLACE.LA CONTRACTOR SHALL PROVIDE DESIGN, ENGINEERING, FURNISHING AND INSTALLATION OF A INSPECTIONS FOR REFERENCE DURING CONSTRUCTION. COMPLETE, FUNCTIONING SYSTEM(S) BASED ON THE SCHEMATIC LAYOUT SHOWN ON THE D. THE CONTRACTOR SHALL BE RESPONSIBLE FOR THE COMPLETE SECURITY OF THE ARCHITECTURAL DRAWINGS, DESCRIBED HEREIN AND IN COMPLIANCE WITH PREVAILING SITE WHILE THE JOB IS IN PROGRESS AND UNTIL JOB COMPLETION. CODE. THE CONTRACTOR SHALL BE RESPONSIBLE FOR FINAL ORDERING OF ALL DEVICES STRUCTURAL STONEWOOD STRUCTURAL ENGINEERS, INC 1. THE CONTRACTOR SHALL TAKE ALL NECESSARY PRECAUTIONS TO ENSURE THE AND FIXTURES TO ENSURE PROPER OPTIONS, ACCESSORIES AND CONFIGURATIONS. 2001 NW 19TH SUITE 103A SAFETY OF THE OCCUPANTS AND WORKERS AT ALL TIMES. CONTRACTOR SHALL PROVIDE COMPLETE DESIGN AND DOCUMENTATION AS REQUIRED FOR THE CONTRACTOR IS SOLELY RESPONSIBLE FOR ALL CONSTRUCTION MEANS AND PORTLAND, OR 97209 SUBMISSION TO, AND APPROVAL OF ARCHITECT, OWNER, AND GOVERNING BUILDING METHODS AND SHALL MAINTAIN THE STRUCTURAL INTEGRITY OF ANY CONSTRUCTION. TEL: 360.216.1704 DEPARTMENT. 3. THE CONTRACTOR SHALL BE RESPONSIBLE FOR AND SHALL REPLACE OR REMEDY ANY FAX: N/A FAULTY, IMPROPER, OR INFERIOR MATERIALS OR WORKMANSHIP WHICH SHALL CONTACT: D. SCOTT NYSETH UPON COMPLETION OF REVIEW BY THE ARCHITECT OR ENGINEER OF RECORD, THE EMAIL: SCOTT.NYSETH@STONEWOODSTRUCTURAL.COM APPEAR WITHIN ONE (1) YEAR AFTER THE COMPLETION AND ACCEPTANCE OF THE CONTRACTOR SHALL BE RESPONSIBLE FOR ROUTING DOCUMENTS TO PERMIT AGENCY FOR WORK UNDER THIS CONTRACT. PLANS REVIEW AND PAYING ANY PLANS CHECK AND PERMIT FEES. 14. CONTRACTOR TO PROVIDE BACKING OR BLOCKING AS REQUIRED FOR MOUNTING ALL INTERFACE WALL MOUNTED SHELVES, EQUIPMENT, ACCESSORIES, CABINETS, ETC. 100 SW MAIN STREET, SUITE 1600 15. CONTRACTOR TO PROTECT ALL TREES AND ROOTS NOT SLATED FOR REMOVAL PORTLAND, OR 97204 SEPARATE PERMITS: DURING CONSTRUCTION. TEL: 503.382.2266 16. GENERAL CONTRACTOR RESPONSIBLE FOR MAINTENANCE OF STAGING AREA AND TO FAX: 503.382.2262 SIGNAGE PERMIT ENSURE THAT MATERIALS DELIVERY AND STORAGE DOES NOT INTERFERE WITH DAILY CONTACT: KIM WALL . FIRE SPRINKLER SYSTEM OPERATION OF ADJACENT PROPERTIES OR PUBLIC RIGHT OF WAY. EMAIL: KIMW@INTERFACEENG.COM FIRE DETECTION AND ALARM SYSTEM 17. GENERAL CONTRACTOR RESPONSIBLE FOR CONSTRUCTION STAKING. 4. FIRE DEPARTMENT ACCESS KEY BOX 5. HANGERS AND SUPPORT FOR HVAC 6. VIBRATION AND SEISMIC CONTROLS FOR HVAC LATERAL BRACING AND ANCHORAGE OF MECHANICAL AND ELECTRICAL EQUIPMENT WEIGHING MORE THAN 75 LBS (EXCEPTIONS PER ASCE 7, SECTION 13.1.4) 8. PRE-ENGINEERED MANUFACTURED TRUSSES SEE SPECIFICATIONS FOR ADDITIONAL REQUIREMENTS NOT LISTED HERE AND ADDTIONAL BIDDER DESIGN ITEMS. **VICINITY MAP** 



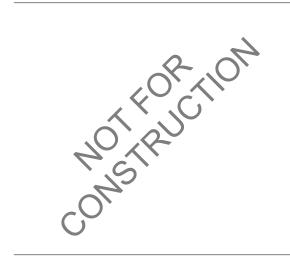

phone: (503) 226-3617 www.seallp.com

CDP SALEM -BUILDING C

Job Number:

5205 BATTLE CREEK RD SE SALEM, OR 97306

D P Community
Development
Partners

LAND USE SUBMISSION ISSUE

Drowings

Drawing:

GENERAL PROJECT INFORMATION

03.09.2022

DATE

Sheet No:

G0.01

CONSTRUCTION TYPE	R-2 V-B, SPRINKLERED PER NFPA		
	13-Ř  ETAILED REQUIREMENTS BASED	ON OCCUPANCY AND USF	
DSSC REFERENCE			
SECTION 420.2	OR OTHE IN ACCOR	EPARATING DWELLING OR SLEEPING UNITS FE R OCCUPANCIES SHALL BE CONSTRUCTED AS RDANCE WITH SECTION 708.	S FIRE PARTITIONS
SECTION 420.3 SECTION 420.4	EACH OT HORIZON	SSEMBLIES SEPARATING DWELLING OR SLEE HER OR OTHER OCCUPANCIES SHALL BE CONTAIN ASSEMBLIES IN ACCORDANCE WITH SECTOCCUPANCIES, REQUIRED PER 903.2.8	ISTRUCTED AS
SECTION 420.5	FIRE & SMOKE ALARMS GROUP F	R-2, FIRE ALARM SYSTEMS REQUIRED PER SEC LLARMS REQUIRED PER 907.2.10.2	CTION 907.2.9
CHAPTER 5: GENERAL	BUILDING HEIGHTS AND AREAS		
TABLE 504.3 TABLE 504.4 TABLE 506.2	HEIGHT / STORIES / AREA FACTOR	R-2: 60 FT / 3 STORY / 7000 SF	
MODIFICATIONS	BUILDING AREA Aa = [	A4 + /NO + I61 + O -	
SECTION 506.2.3 SINGLE-OCCUPANCY MULTIS EQUATION 5-2	STORY BUILDINGS = [700	At + (NS x lf)] x Sa 10 SF + (7000 SF x 0.75)] x 3 50 SF x 3 50 SF	
SECTION 506.3	-	F/P - 0.25] x W/30 256/256 - 0.25] x 30/30 75	
	ACTUAL HEIGHT / STORIES 34' -	9" / 3 Story	
	BUILDING FLOOR LEVEL		
	LEVEL 1 LEVEL 2	AREA (SF) 6842 SF 6842 SF	
	LEVEL 3	6842 SF 20527 SF	
SECTION 508.2	ACCESSORY OCCUPANCY N/A		
SECTION 508.2 SECTION 508.3 / 508.4	MIXED OCCUPANCY N/A  MIXED OCCUPANCY N/A		
TABLE 509	INCIDENTAL USES		
		INKLERED, NO SEPARATION REQUIRED INKLERED, NO SEPARATION REQUIRED	
CHAPTER 6: TYPES OF	CONSTRUCTION / CONSTRUCTIO	N CLASSIFICATION	
TABLE 601	FIRE RESISTANCE RATING REQUIRMEN		
	PRIMARY STRUCTURAL FRAME	LEMENT FIRE RATING 0 HOUR	<u>G *                                     </u>
	BEARING WALLS  EXTERIOR  INTERIOR	0 HOUR 0 HOUR	
	NON BEARING WALLS AND PARTITION NON BEARING WALLS AND PARTITION FLOOR CONSTRUCTION AND SECOND ROOF CONSTRUCTION AND SECOND * UNLESS OTHERWISE REQUIRED BY	NS - EXTERIOR PER TABLE ( NS - INTERIOR 0 HOUR DARY MEMBERS 0 HOUR ARY MEMBERS 0 HOUR	602
TABLE 602	FIRE RESISTANCE RATING REQUIRMEN	NTS FOR EXTERIOR WALLS BASED ON FIRE SE	PARATION DISTANCE
	X < 5'	N DISTANCE FIRE RATIN	IG
	5' <= X < 10' 10' <= X < 30'	1 HOUR 0 HOUR	
	X >= 30'	0 HOUR	
CHAPTER 7: FIRE AND	SMOKE PROTECTION FEATURES		
TABLE 705.2	MINIMUM DISTANCE OF PROJECTION	40 INCHES	
TABLE 705.8	MAXIMUM AREA OF WALL OPENINGS B	ASED ON FSD AND OPENING PROTECTION	DDOTECTED
	0 TO LESS THAN 3' 3 TO LESS THAN 5' 5 TO LESS THAN 10'	UNPROTECTED, NON-SPRINKLERED NOT PERMITTED NOT PERMITTED 10%	PROTECTED NOT PERMITTED 15% 25%
	10 TO LESS THAN 15' 15 TO LESS THAN 20'	15% 25% 45%	45% 75%
	20 TO LESS THAN 25' 25 TO LESS THAN 30' 30' OR GREATER	45% 70% NO LIMIT	NO LIMIT NO LIMIT NO LIMIT
705.8.1	ALLOWABLE AREA OF OPENINGS	EXCEPTION 2: BUILDINGS WHOSE EXTERIO	OR BEARING WALLS,
		EXTERIOR NONBEARING WALLS AND EXTE STRUCTURAL FRAME ARE NOT REQUIRED RATED SHALL BE PERMITTED TO HAVE UN OPENINGS.	TO BE FIRE-RESISTANCE
705.11	PARAPETS	EXCEPTION 1: WALL NOT REQUIRED TO BE FIRE-RESISTA ACCORDANCE WITH TABLE 602 BECAUSE ( DISTANCE.	
TABLE 706.4	FIRE WALL FIRE RESISTANCE	N/A	
TABLE 707.3.10	FIRE BARRIER ASSEMBLIES AND HORIZONTAL ASSEMBLIES BTWN FIRE AREAS	1 HOUR, INTERIOR EXIT STAIR LESS THAN	4 STORIES
SECTION 708	FIRE AREAS FIRE PARTITIONS	1 HOUR	TARI E 1020 1
SECTION 709	SMOKE BARRIERS	1/2 HOUR AT GROUP R-2 CORRIDORS PER  NOT REQUIRED	IABLE 1020.1
SECTION 709 SECTION 711	FLOOR AND ROOF ASSEMBLIES	NEXUINED	
	SUPPORTING CONSTRUCTION PER 717		
711.2.4.1 711.2.4.2 711.2.4.3	SEPARATING MIXED OCCUPANCIES SEPARATING FIRE AREAS DWELLING / SLEEPING LINITS	N/A N/A 1 HOUR	
711.2.4.3 711.2.4.4 711.2.4.5	DWELLING / SLEEPING UNITS SEPARATING SMOKE COMPARTMENTS SEPARATING INCIDENTAL USES		
711.2.4.6	OTHER SEPARATIONS	N/A	
SECTION 713	SHAFT ENCLOSURES	NOT LESS THAN 1 HOUR CONNECTING LESS NOT LESS THAN 2 HOUR CONNECTING 4 S	
CHAPTER 8: INTERIOR	FINISHES		
	OR WALL AND CEILING FNIISH REQUIREMEN		
CORRII	OR EXIT STAIRWAYS AND RAMPS AND EXIT DORS AND ENCLOSURES FOR EXIT ACCESS S AND ENCLOSED SPACES		
F: 11 11/15	CAUTE LINOLOGED OF MOED	C	

DING CODE S	SUMMARY 2	2019 OREGON STRUCTURAL SPECIALTY CODE	CHAPTER 10: MEANS	S OF EGRESS	
<b>JPANCY</b>	R-2		SECTION 1004	OCCUPANT LOAD (OL)	SEE OCCUPANT LOAD TABLE
TRUCTION TYPE  PTER 4: SPECIAL DE	V-B, SPRINKLERED PER NFF 13-R TAILED REQUIREMENTS	S BASED ON OCCUPANCY AND USE	SECTION 1005.3.1 SECTION 1005.3.2 TABLE 1006.2.1	STAIRWAY EGRESS CAPACITY FACTOR OTHER EGRESS CAPACITY FACTOR MAX OCCUPANT LOAD FOR ONE EXIT	0.3 0.2 20 OCCUPANTS
ON 420.2	SEPARATION WALLS HORIZONTAL SEPARATION	WALLS SEPARATING DWELLING OR SLEEPING UNITS FROM EACH OTHER OR OTHER OCCUPANCIES SHALL BE CONSTRUCTED AS FIRE PARTITIONS IN ACCORDANCE WITH SECTION 708.  FLOOR ASSEMBLIES SEPARATING DWELLING OR SLEEPING UNITS FROM	TABLE 1006.3.2	MAX COMMON PATH OF EGRESS TRAVEL  MAX OCCUPANT LOAD PER STORY  MIN NUMBER OF EXITS FOR STORY	125 FT 500 2
DN 420.4 DN 420.5	SPRINKLER SYSTEM FIRE & SMOKE ALARMS	EACH OTHER OR OTHER OCCUPANCIES SHALL BE CONSTRUCTED AS HORIZONTAL ASSEMBLIES IN ACCORDANCE WITH SECTION 711.  GROUP R OCCUPANCIES, REQUIRED PER 903.2.8  GROUP R-2, FIRE ALARM SYSTEMS REQUIRED PER SECTION 907.2.9	TABLE 1006.3.3(1)	STORIES WITH ONE EXIT FOR R-2	4 UNITS / 125 FT TRAVEL DISTANCE / UP TO 3 STORIES EMERGENCY ESCAPE AND RESCUE OPENINGS PER 1030 REQUIRED FOR STORIES WITH ONE EXIT
JN 420.3	FIRE & SWORE ALARWIS	SMOKE ALARMS REQUIRED PER 907.2.10.2	TABLE 1017.2	EXIT ACCESS TRAVEL DISTANCE	250 FT
TER 5: GENERAL F	BUILDING HEIGHTS AND	AREAS	TABLE 1020.1	CORRIDOR FIRE-RESISTANCE RATING	0.5 HR
504.3	HEIGHT / STORIES / AREA FA		TABLE 1020.2	MINIMUM CORRIDOR WIDTH	44 INCHES * 36 INCHES WITHIN DWELLING UNIT OR WHERE OCCUPANT LOAD <50
504.4 506.2	THE IOTH A GIOTHEO THE THE	ACTOR 17 2 CTORT 7 7000 CT	SECTION 1020.4	DEAD ENDS	20 FEET *LENGTH IS NOT LIMITED WHERE LENGTH < 2.5x WIDTH
CATIONS TION 506.2.3	BUILDING AREA	$Aa = [At + (NS \times If)] \times Sa$	CHAPTER 11: ACCES	SSIBILITY	
GLE-OCCUPANCY MULTIST ATION 5-2		= [7000 SF + (7000 SF x 0.75)] x 3 = 12250 SF x 3 = 36750 SF	SECTION 1106.2	R-2 OCCUPANCIES WITH ACCESSIBLE, TYPI PROVIDED SHALL BE ACCESSIBLE	E A OR TYPE B UNITS, AT LEAST 2% OF EACH TYPE OF PARKING
TION 506.3	FRONTAGE INCREASE	If = $[F/P - 0.25] \times W/30$ If = $[256/256 - 0.25] \times 30/30$ = 0.75		TOTAL SPACES PROVIDED: ACCESSIBLE SPACES REQUIRED: ACCESSIBLE SPACES PROVIDED: VAN ACCESSIBLE SPACES REQUIRED	
	ACTUAL HEIGHT / STORIES	34' - 9" / 3 Story		VAN ACCESSIBLE SPACES PROVID WHEELCHAIR ONLY SPACES REQU	

CHAPTER 11: ACCES	SIBILITY	
SECTION 1106.2	R-2 OCCUPANCIES WITH ACCESSIBLE, TYPE A OR TO PROVIDED SHALL BE ACCESSIBLE	YPE B UNITS, AT LEAST 2% OF EACH TYPE OF PARKING
	TOTAL SPACES PROVIDED:	167
	ACCESSIBLE SPACES REQUIRED:	167 x 2% = 4
	ACCESSIBLE SPACES PROVIDED:	6
	VAN ACCESSIBLE SPACES REQUIRED :	1 PER 6 ACCESSIBLE SPACES
	VAN ACCESSIBLE SPACES PROVIDED:	1
	WHEELCHAIR ONLY SPACES REQUIRED:	1 PER 101-200 SPACES
	WHEELCHAIR ONLY SPACES PROVIDED:	1

CTION 1107.6.2.2.1 R-2 OCCUPANCIES WITH GREATER THAN 20 DWELLING UNITS SHALL PROVIDE MINIMUM 2% TYPE A UNITS. ALL R-2 UNITS ON A SITE SHALL BE CONSIDERED TO DETERMINE TOTAL NUMBER OF UNITS AND REQUIRED NUMBER OF TYPE A UNITS TYPE A UNITS REQUIRED (TOTAL FOR SITE): 184 x 2% = 4 UNITS

TYPE A UNITS PROVIDED (THIS BUILDING): 0 UNITS WHERE THERE ARE FOUR OR MORE DWELLING UNITS, ALL UNITS SHALL BE TYPE B UNITS AT A MINIMUM CTION 1107.6.2.2.2 CEPTION: THE NUMBER OF TYPE A AND TYPE B UNITS IS PERMITTED TO BE REDUCED IN ACCORDANCE WITH

TYPE A UNITS PROVIDED (TOTAL FOR SITE): 10 UNITS

1107.7.1.1, STRUCTURES WITHOUT ELEVATOR SERVICE, ONE STORY WITH TYPE B UNITS REQUIRED

#### DITIONAL ACCESSIBILITY REQUIREMENTS

PLICABLE STANDARDS ANSI ICC A117.1 - 2009

2010 ADA STANDARDS FOR ACCESSIBLE DESIGN - TITLE II FAIR HOUSING ACCESSIBILITY GUIDELINES FHA SAFE HARBOR DESIGN DOCUMENT: IBC 2018 OHCS CORE DEVELOPMENT MANUAL

CESSIBLE UNITS

5% OF UNITS WITH MOBILITY FEATURES 184 x 5% = 10 UNITS 2% OF UNITS WITH COMMUNICATION FEATURES 184 x 2% = 4 UNITS

PTER 13: ENERGY EFFICIENCY 2021 OREGON ENERGY EFFICIENCY SPECIALTY CODE (OEESC) IMATE ZONE 4C

OPAQUE ELEMENTS	REQUIRED				PROVIDED	
	ASSEMBLY MAX.		MIN. R-VALUE			
ROOFS			•		•	
INSULATION ENTIRELY ABOVE DECK	N/A		N/A			
METAL BUILDINGS	N	I/A	N/A			
ATTIC AND OTHER	U-0	0.021	R-49		R-49	
WALLS (ABOVE GRADE)			•		•	
MASS	U-C	0.090	R-11.4	· CI	R-1	1.4 CI
METAL BUILDINGS	N	I/A	N/A			
STEEL-FRAMED	N	I/A	N/A			
WOOD-FRAMED / OTHER	U-0	0.064	R-13 + 3.8 Cl	OR R-20	R-23	
WALLS (BELOW GRADE)	C-0	0.092	R-10	CI		
FLOORS			•		•	
MASS	N	I/A	N/A			
STEEL JOIST	N/A		N/A			
WOOD FRAMED / OTHER	U-0.033		R-30		R-30	
SLAB-ON-GRADE FLOORS			•		•	
HEATED	N	I/A	N/A			
UNHEATED	F-0	).520	R-15 FO	R 24"	R-15	FOR 24"
OPAQUE DOORS						
SWINGING	U-0.370				U-0	.370
NON-SWINGING	N	I/A				
FENESTRATION	REQUIRED				PROVIDED	
	MAX U	MAX SHGC	MIN VTI/SHGC	MAX U	MAX SHGC	MIN VTI/SHGC
VERTICAL (0% - 40% OF WALL ALLOWE	D)				_	
FIXED	U-0.36	0.36	1.10	U-0.36	0.36	1.10
OPERABLE	U-0.45	0.33	1.10	U-0.45	0.33	1.10
ENTRANCE DOOR	U-0.63	0.33	1.10	U-0.63	0.33	
SKYLIGHT (0% - 3% OF ROOF ALLOWE	D)					
CI = CONTINUOUS INSULATION FC = FILLED CAVITY						


= NO REQUIREMENT = NOT APPLICABLE

CHAPTER 29:	PLUMBING FIXTURES

TOTAL UNITS 1 WC / LAV / Tub or Shower per unit required and provided

EXIT ACCESS	TRAVEL DISTANCE
EGRESS PATH NAME	EGRESS PATH LENGTH
FIRST FLOOR	54' - 1"
SECOND FLOOR	79' - 8"
THIRD FLOOR	122' - 2"

LIFE SAFETY OCCUPANT LOAD SCHEDULE				
		TABLE 10		
AREA NAME	AREA (SF)	FUNCTION OF SPACE	OCCUPANT LOAD FACTOR	OCCUPANT LOAD
FIRST FLOOR	6222 SF	Residential	200	32
SECOND FLOOR	6636 SF	Residential	200	34
THIRD FLOOR	6636 SF	Residential	200	34

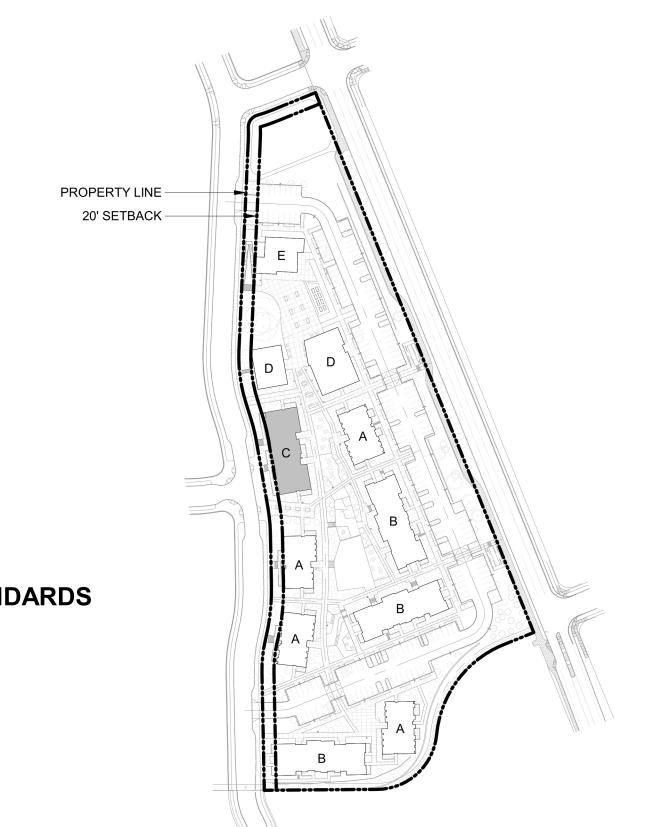

702.020 MULTIPLE FAMILY DESIGN REVIEW STANDARDS

SECTION	REQUIRMENT MET OR ADJUSTMENT REQUESTED	SHEET NUMBER		
SITE SAFETY & SEC	URITY			
702.020.c.1	REQUIREMENT MET	A2.11-A2.12		
702.020.c.2	REQUIREMENT MET	A3.01		
FACADE & BUILDING DESIGN				
702.020.e.1	REQUIREMENT MET	A2.11-A2.12		
702.020.e.8	REQUIREMENT MET	A3.01		
702.020.e.9	ADJUSTMENT REQUESTED	A3.01		
702.020.e.10	REQUIREMENT MET	A3.01		

- AREA NAME

— AREA (SF) OCCUPANT LOAD FACTOR /
NUMBER OF OCCUPANTS

> TOTALS EXIT SIGN

OCCUPANCY (CH. 3)

- FUNCTION (CH. 10)

UNOCCUPIED AREA. OCCUPANT LOAD NOT INCLUDED IN BUILDING

DIRECTION TO EXIT

**EXIT ACCESS PATH** 

EXIT ACCESS DOOR

DOOR RATING (IN MINUTES)

MULTI-PURPOSE FIRE EXTINGUISHER AND CABINET

(FE) ON BRACKET. VERIFY EXACT LOCATIONS AND QUANTITY WITH FIRE

DEPARTMENT.

(FEC) OR FIRE EXTINGUISHER

SHADE INDICATES ILLUMINATE FACE. ARROW INDICATES

NAME

← PATH A 100' - 0"

FEC or FE

SITE PLAN - ZONING DIAGRAM



SCOTT EDWARDS ARCHITECTURE LLP.


2525 E Burnside Street, Portland, OR 97214 phone: (503) 226-3617 www.seallp.com

**CDP SALEM -**

5205 BATTLE CREEK RD SE SALEM, OR 97306

**BUILDING C** 

Job Number:

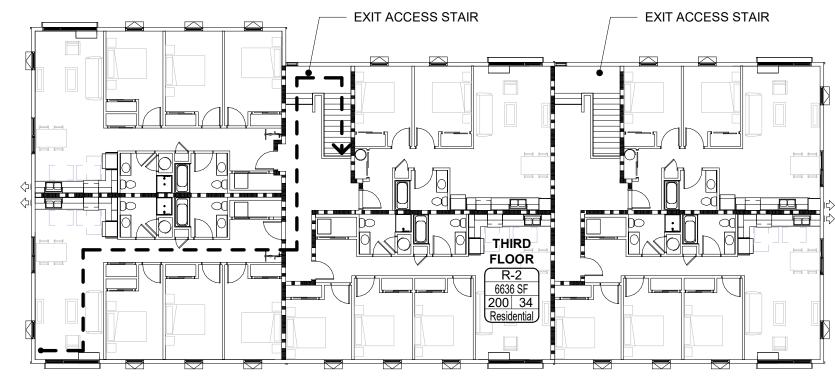

EXIT ACCESS STAIR FROM THIRD FLOOR TO SECOND FLOOR - EXIT STAIR FROM SECOND FLOOR TO FIRST FLOOR EXIT STAIR FROM SECOND FLOOR TO FIRST FLOOR — EXIT ACCESS STAIR FROM THIRD FLOOR TO SECOND FLOOR FLOOR

CODE SUMMARY LEGEND 1 HOUR RATED ASSEMBLY WALL RATINGS TO CONTINUE ABOVE / BELOW ALL DOORS, RELITES, ETC. 2 SECOND FLOOR LIFE SAFETY PLAN

1/16" = 1'-0"

THIRD FLOOR LIFE SAFETY PLAN

1/16" = 1'-0"

FIRST FLOOR R-2 └─ FIRE RISER


1 FIRST FLOOR LIFE SAFETY PLAN
1/16" = 1'-0"





ISSUE DATE Drawing:

03.09.2022

**CODE SUMMARY** 

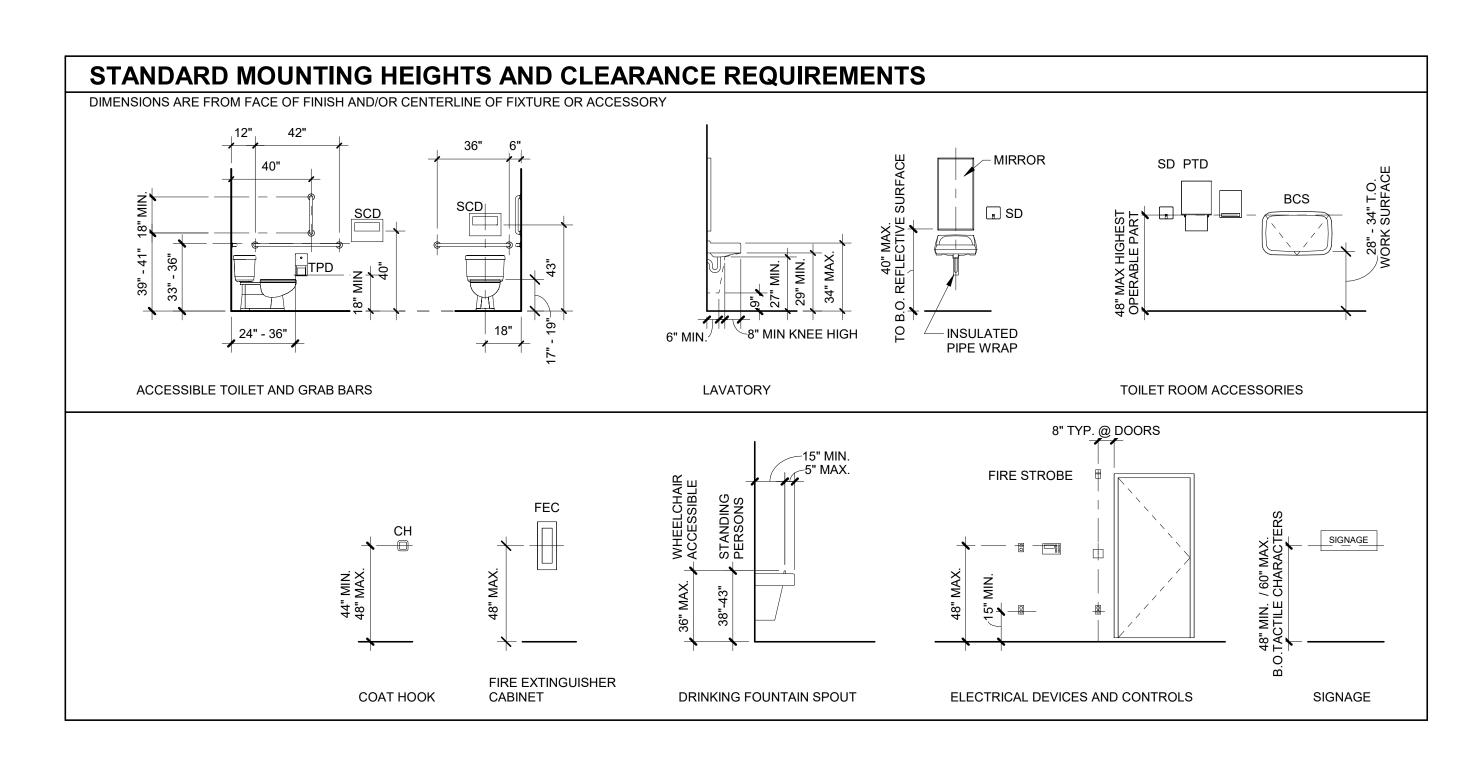

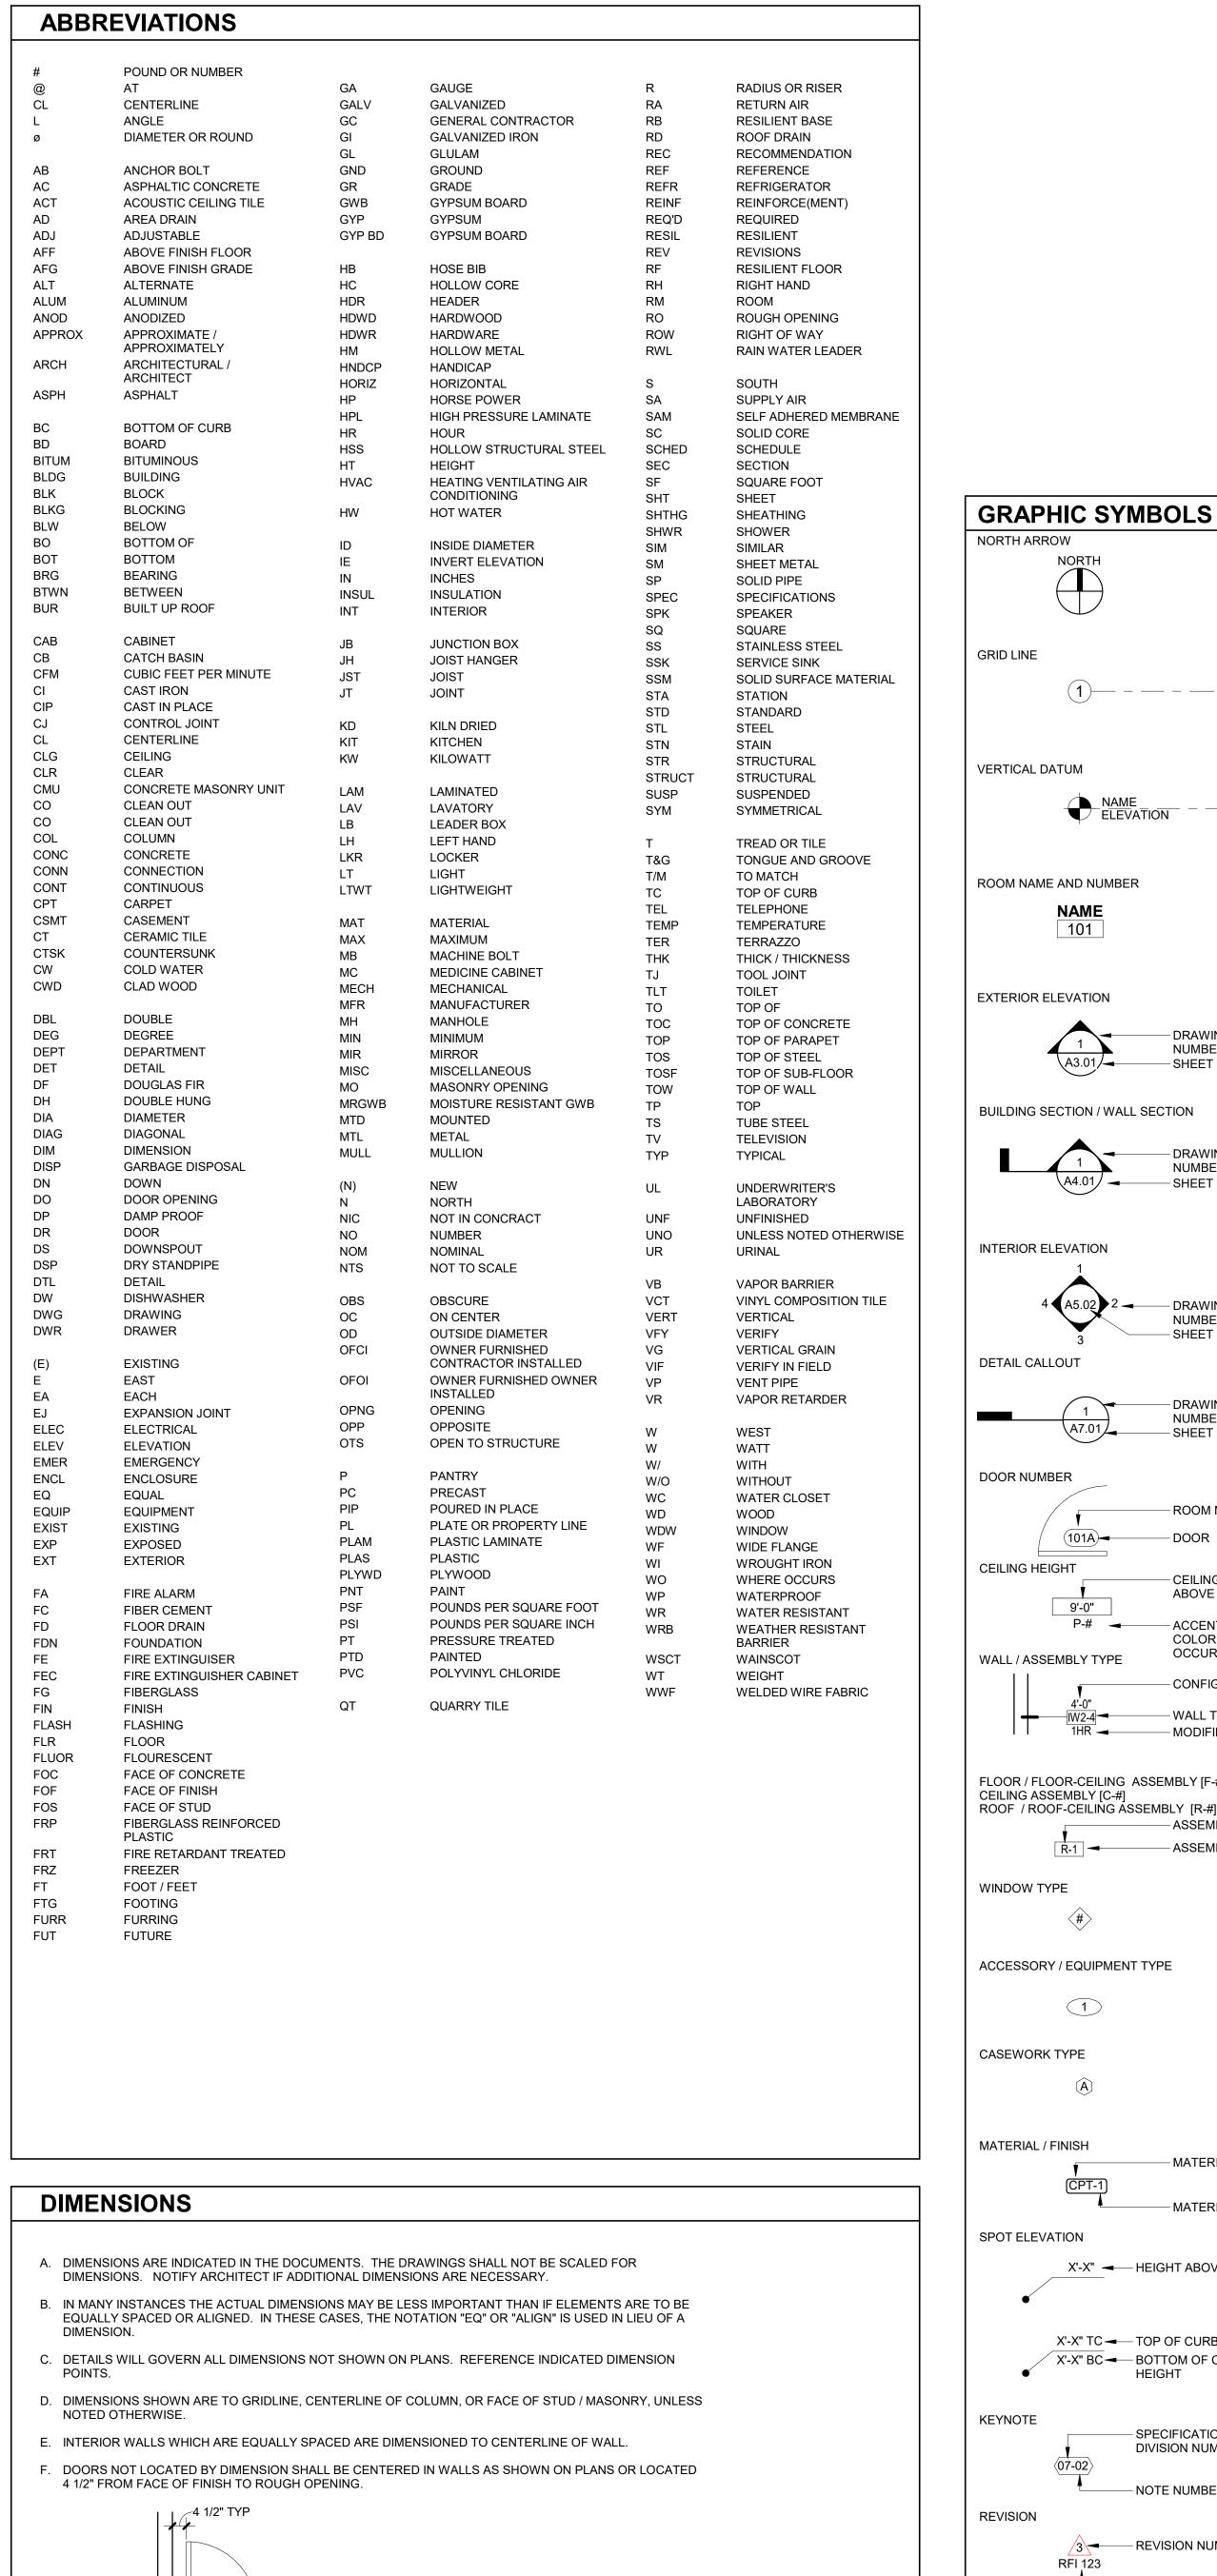

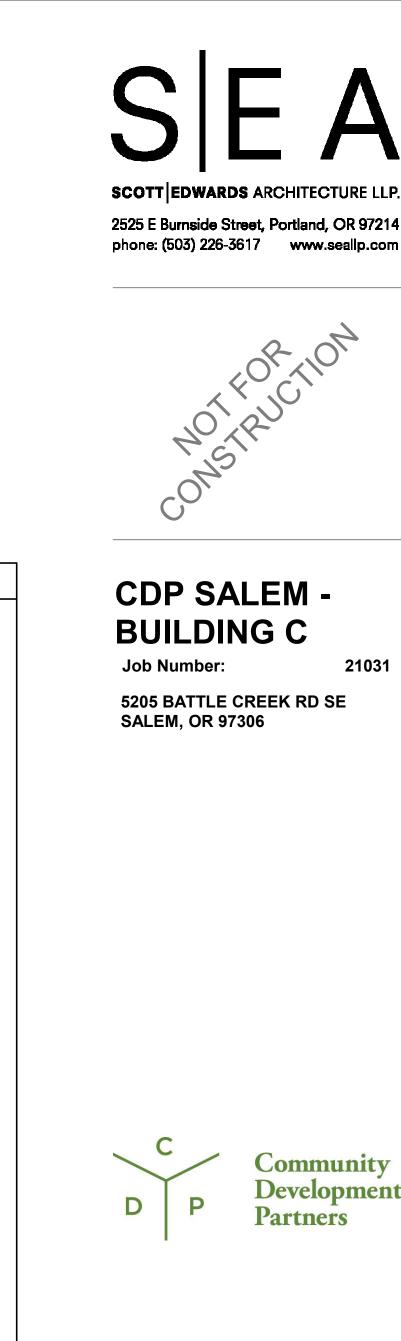

NORTH

NAME

101

\A3.01/-

\A4.01/ —

(101A)<del>-</del>-

(1)— - — - —

NAME\_ ELEVATION - -

- DRAWING

NUMBER

- DRAWING

NUMBER

→ DRAWING

NUMBER

- DRAWING

NUMBER

- SHEET NUMBER

- ROOM NUMBER

- CEILING HEIGHT

ABOVE LEVEL

- ACCENT PAINT

OCCURS


**COLOR WHERE** 


— DOOR

— SHEET NUMBER

— SHEET NUMBER

- SHEET NUMBER

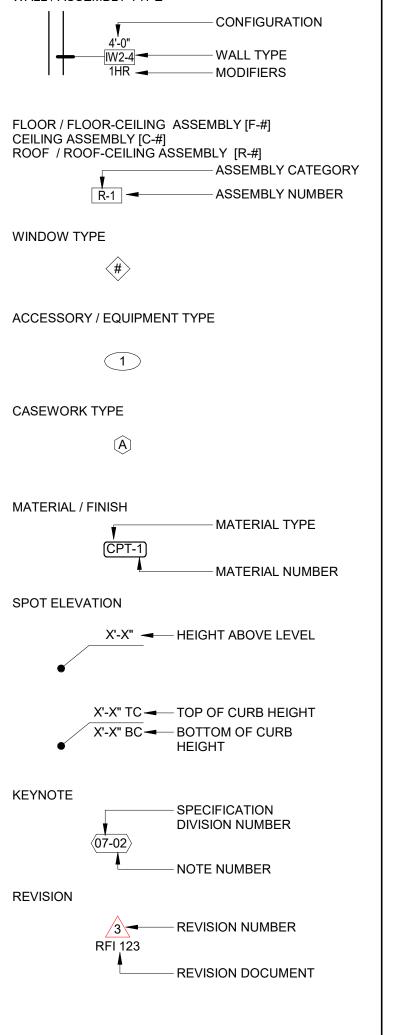

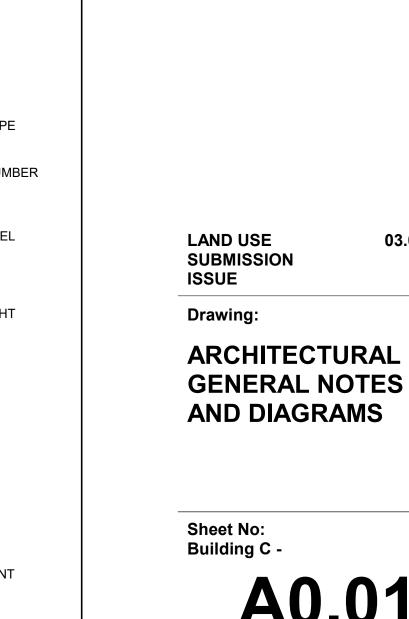

LAND USE

ISSUE

Drawing:

Sheet No: Building C -


SUBMISSION


**GENERAL NOTES** 

**AND DIAGRAMS** 


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**CDP SALEM -BUILDING C** Job Number: 5205 BATTLE CREEK RD SE **SALEM, OR 97306** 

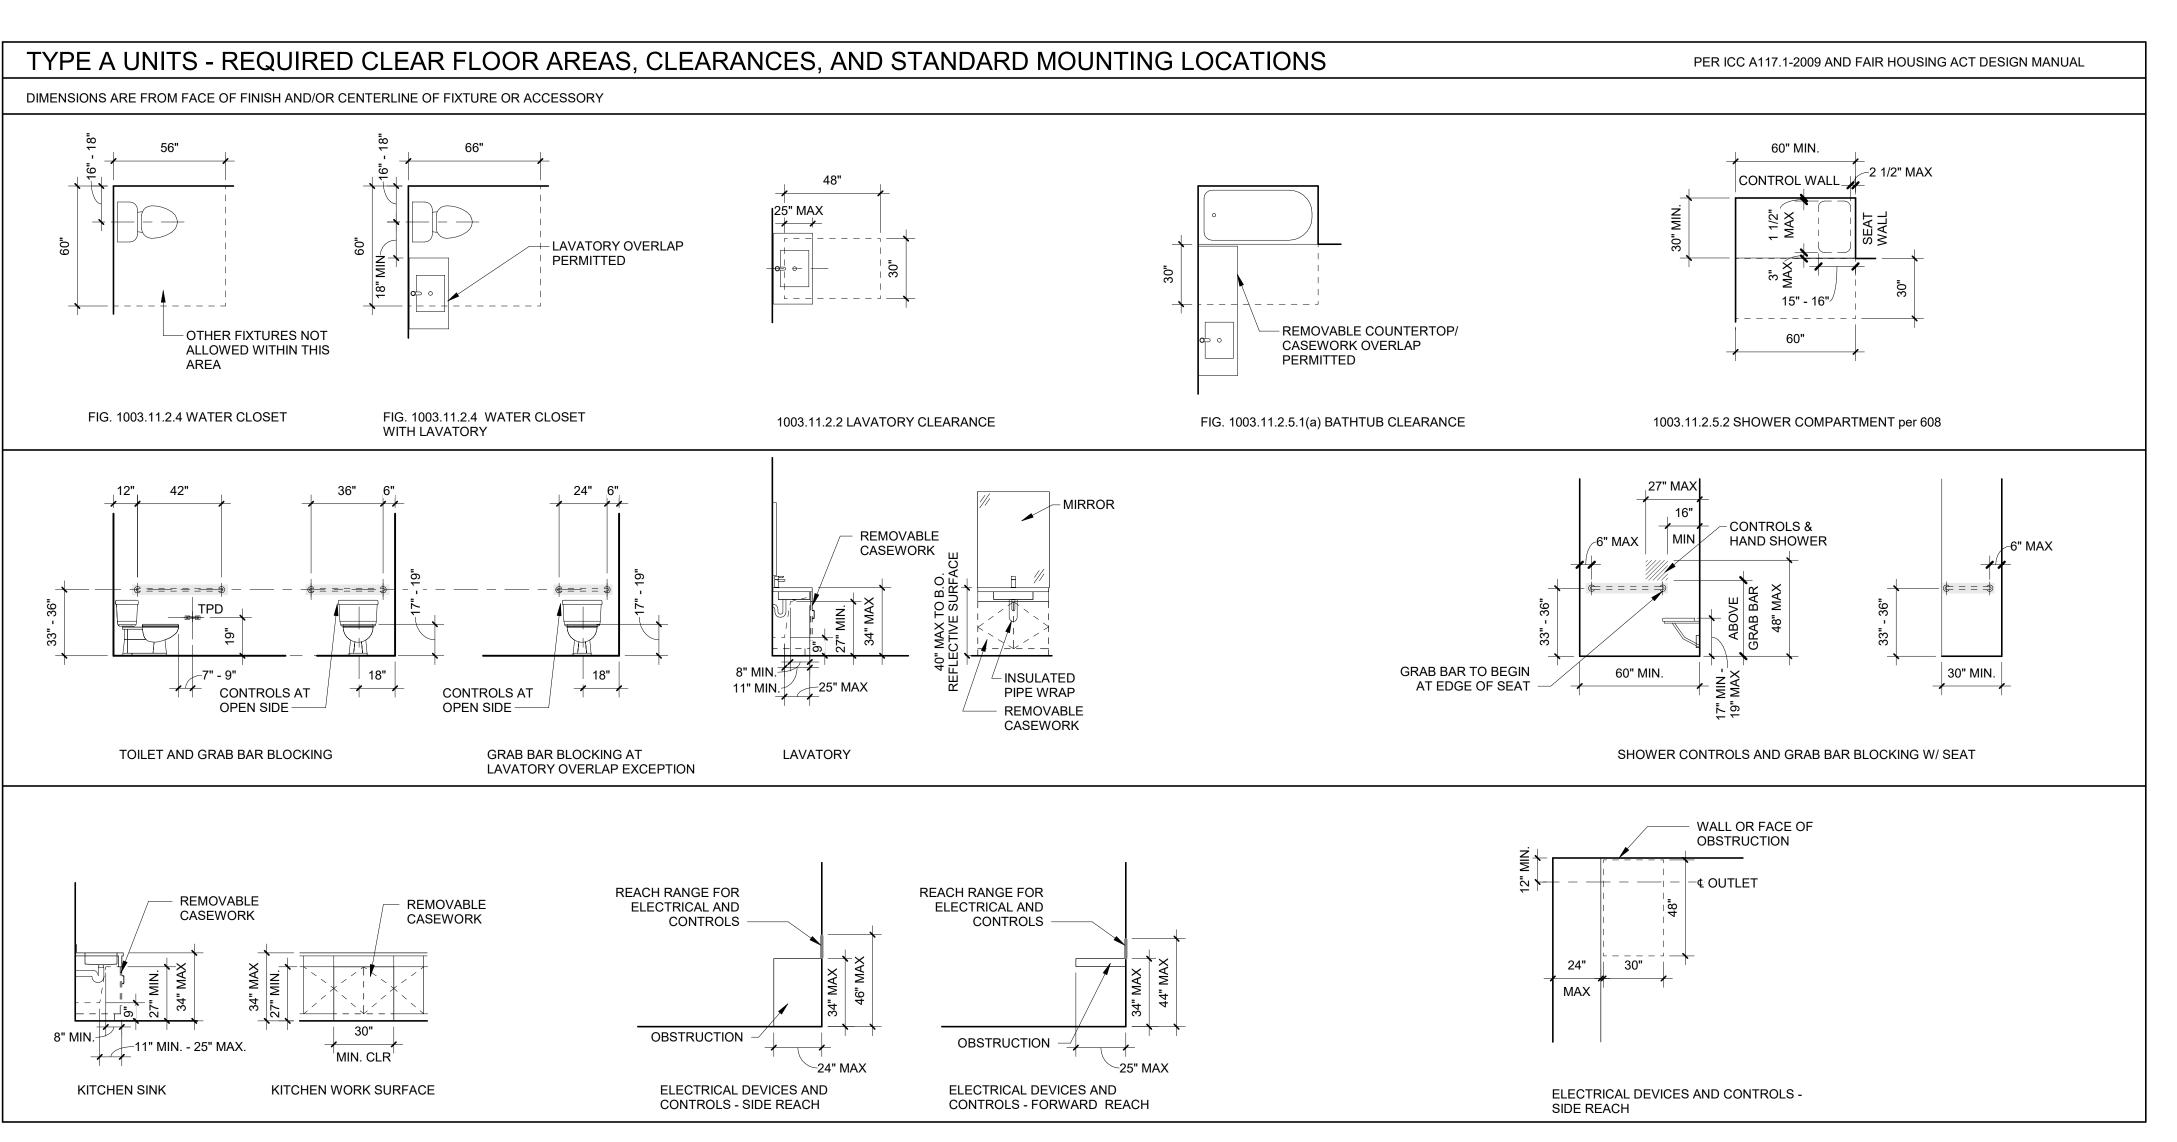

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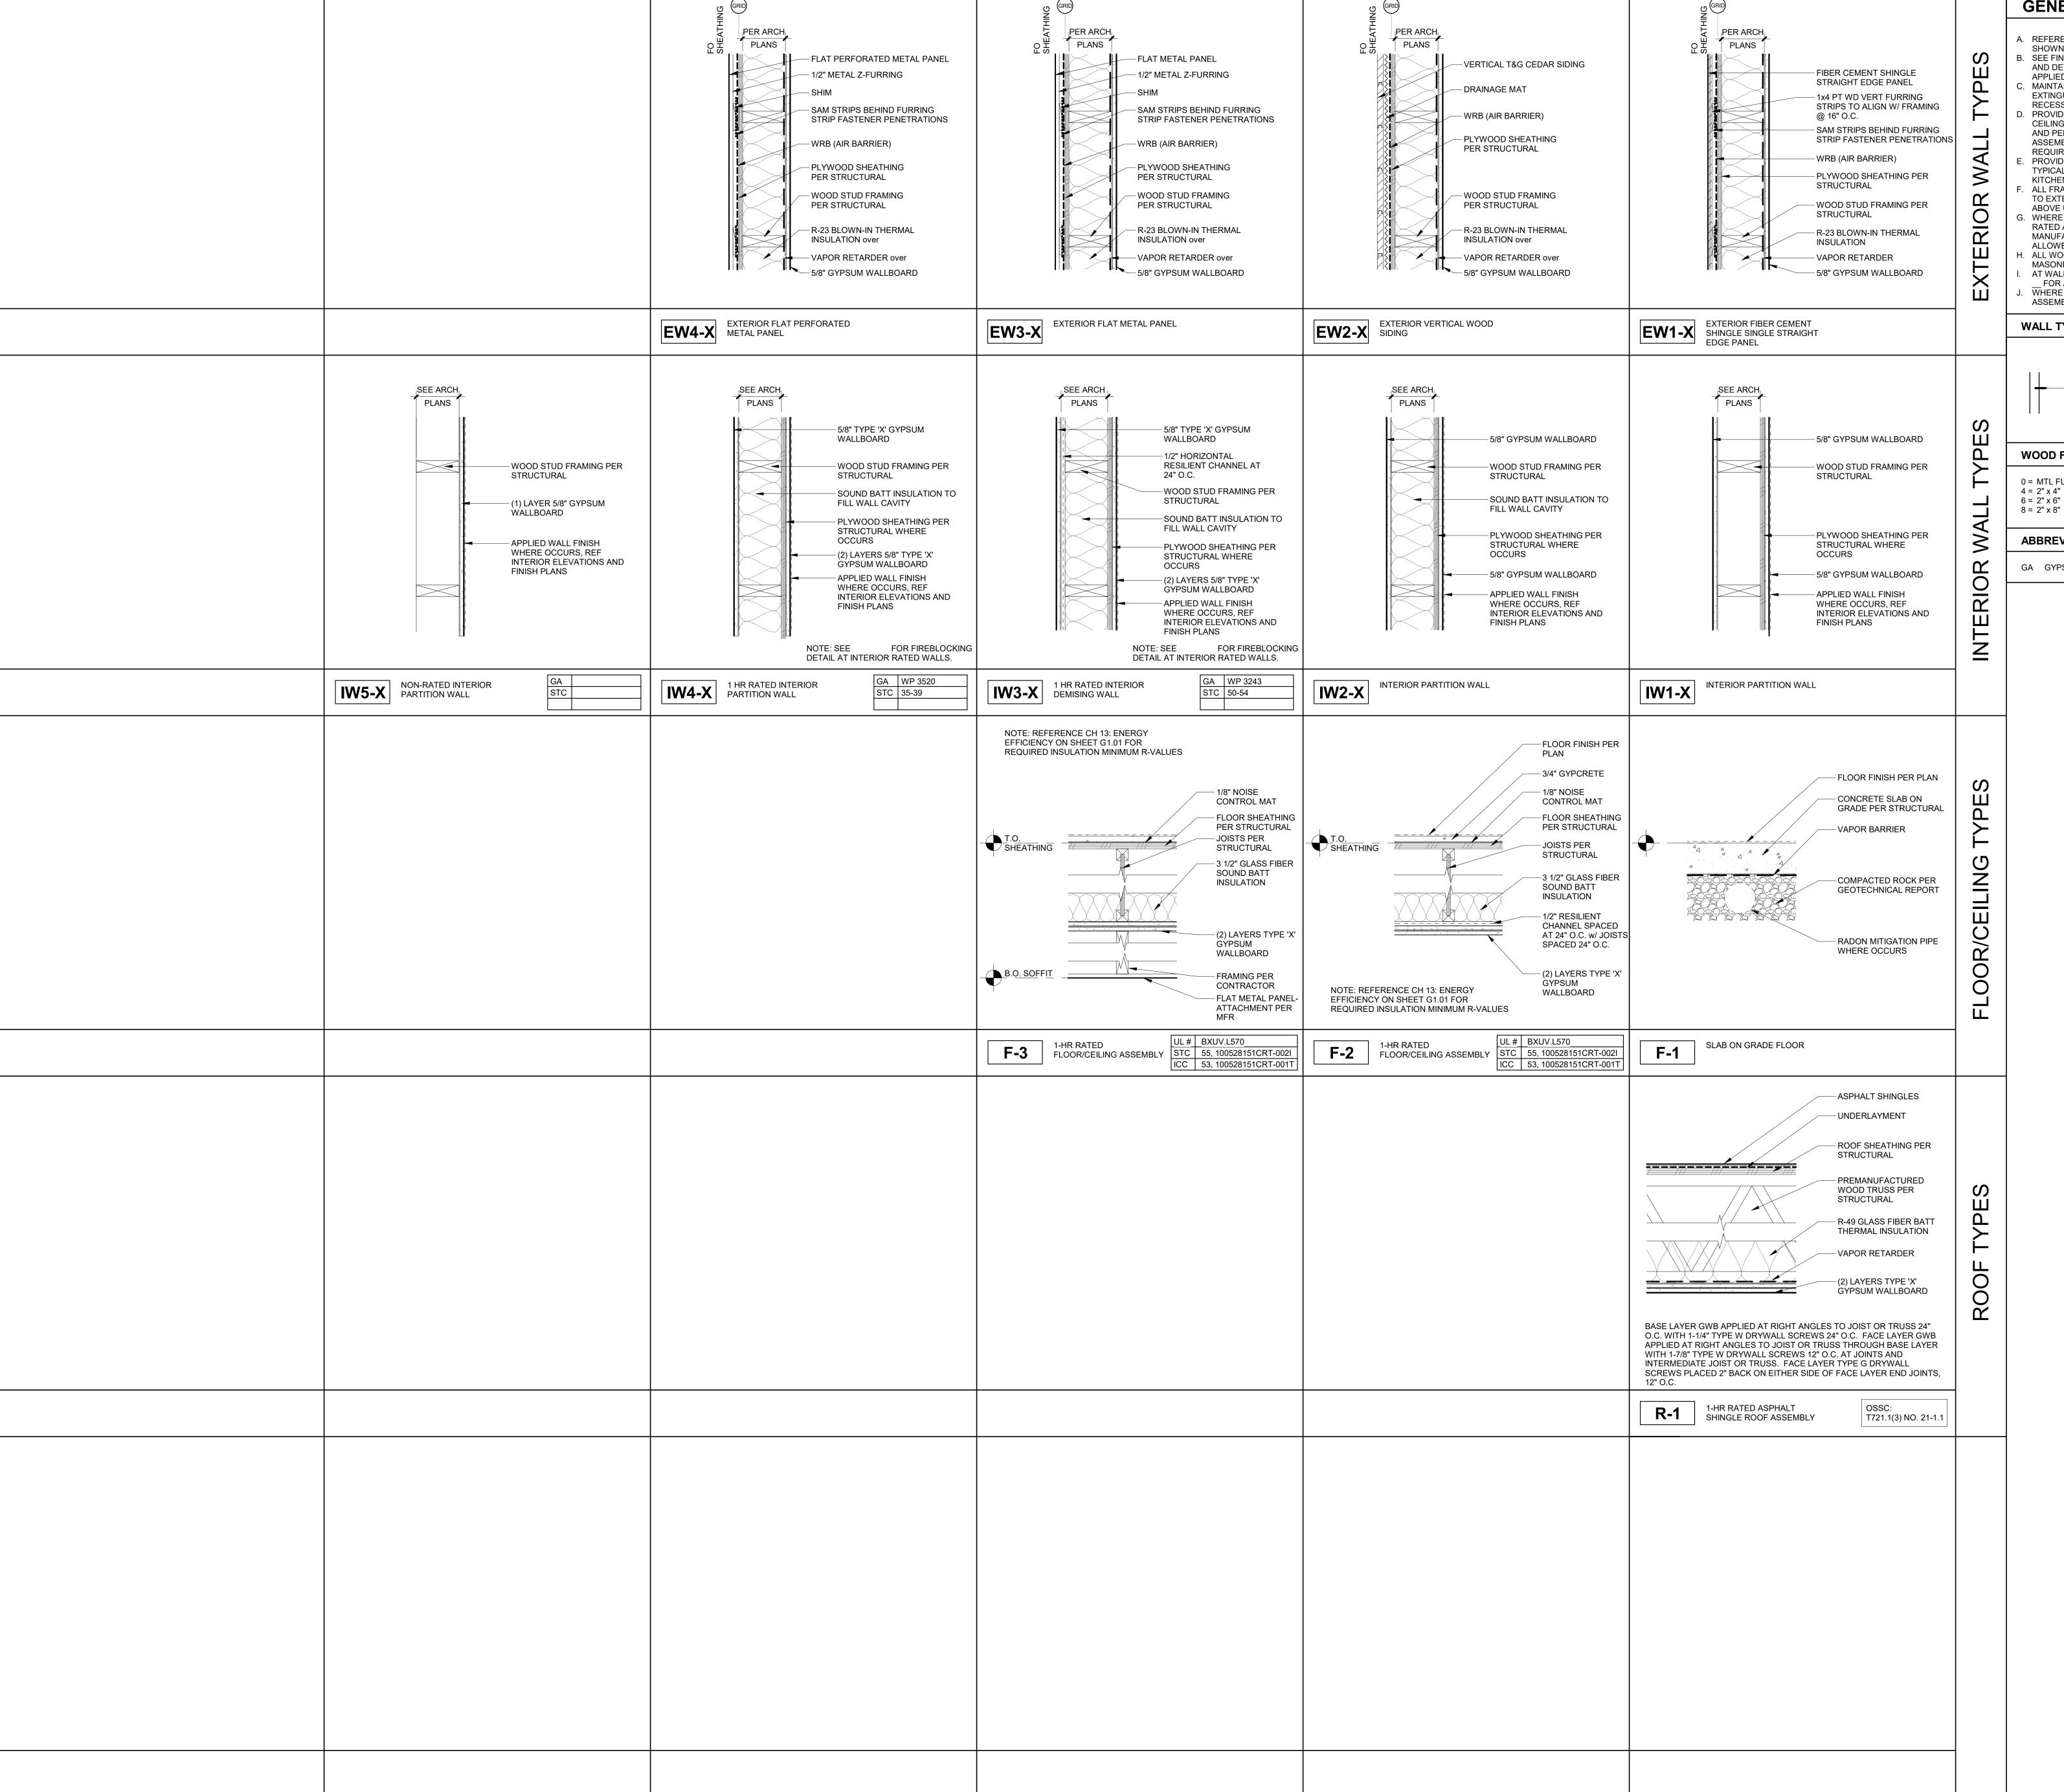
Drawing:

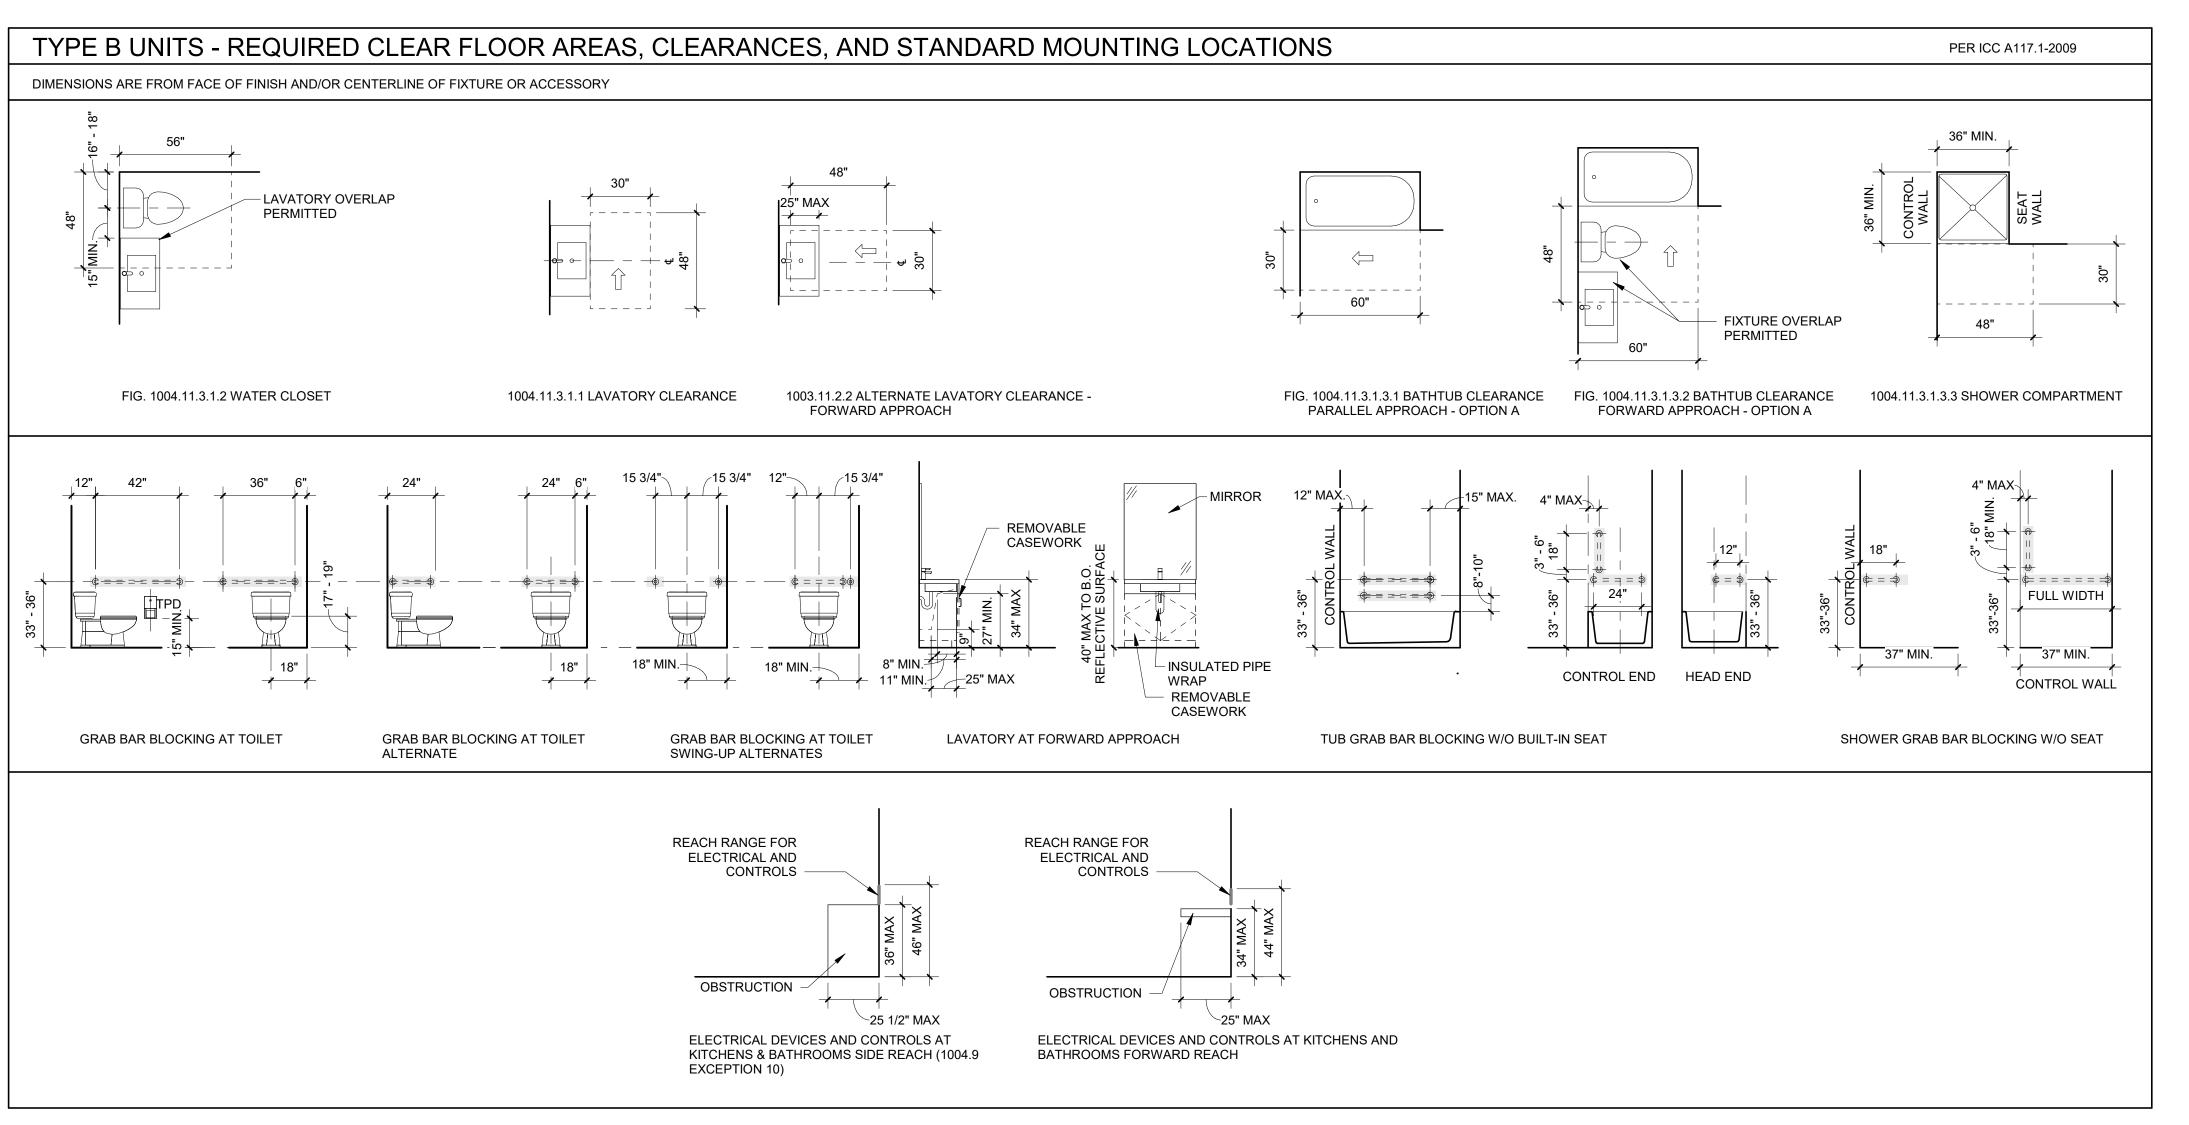**ACCESSIBILITY DIAGRAMS** -**RESIDENTIAL** 

03.09.2022

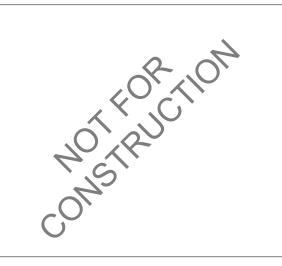DATE





### GENERAL SHEET NOTES

REFERENCE DETAILS FOR ASSEMBLIES NOT SHOWN HERE.

 SEE FINISH SCHEDULE, INTERIOR ELEVATIONS, AND DETAILS FOR SPECIAL CONDITIONS AND

B. SEE FINISH SCHEDULE, INTERIOR ELEVATIONS, AND DETAILS FOR SPECIAL CONDITIONS AND APPLIED WALL FINISHES.
C. MAINTAIN FIRE RATING OF WALLS AROUND FIRE EXTINGUISHERS, CABINETS, AND OTHER RECESSED ITEMS.
D. PROVIDE ACOUSTICAL SEALANT AT FLOOR /

EXTINGUISHERS, CABINETS, AND OTHER
RECESSED ITEMS.

D. PROVIDE ACOUSTICAL SEALANT AT FLOOR /
CEILING/ WALL TRANSITIONS, RECESSED BOXES,
AND PENETRATIONS OF SOUND RATED
ASSEMBLIES AND OTHER CONSTRUCTION AS

REQUIRED TO ACHIEVE NOTED STC RATINGS.

E. PROVIDE MOISTURE RESISTANT GYPSUM BOARD TYPICAL AT ALL RESTROOMS, BATHROOMS, AND KITCHEN WALLS.

F. ALL FRAMING AND FINISHES OF INTERIOR WALLS TO EXTEND TO THE UNDERSIDE OF STRUCTURE

ABOVE UNLESS NOTED OTHERWISE.

G. WHERE PARTITIONS ARE SOUND RATED OR FIRE RATED AND INCLUDE PROPRIETARY MANUFACTURERS, NO SUBSTITUTIONS ARE ALLOWED.

H. ALL WOOD IN CONTACT WITH CONCRETE OR

MASONRY TO BE PRESSURE TREATED.

I. AT WALLS WITH RESILIENT CHANNELS SEE DETAIL
\_\_FOR ASSEMBLY DETAILS.

J. WHERE ACOUSTIC WALL IS INDICATED, SEE \_\_FOR

WALL TYPE SYMBOL

WALL TYPE SYMBOL

WALL TYPE

PARTIAL HEIGHT / WALL

CONFIGURATION

FRAMING OR CONC

SIZE

FIRE RATING (IN HOURS)


WOOD FRAMING SIZES

0 = MTL FURRING, 7/8" OR AS INDICATED
4 = 2" x 4"

ABBREVIATIONS

GA GYPSUM ASSOCIATION

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Drawing:

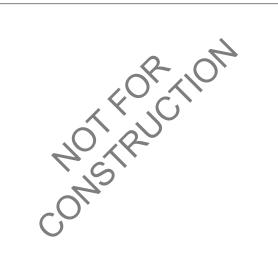ASSEMBLIES


03.09.2022

DATE

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A0.20



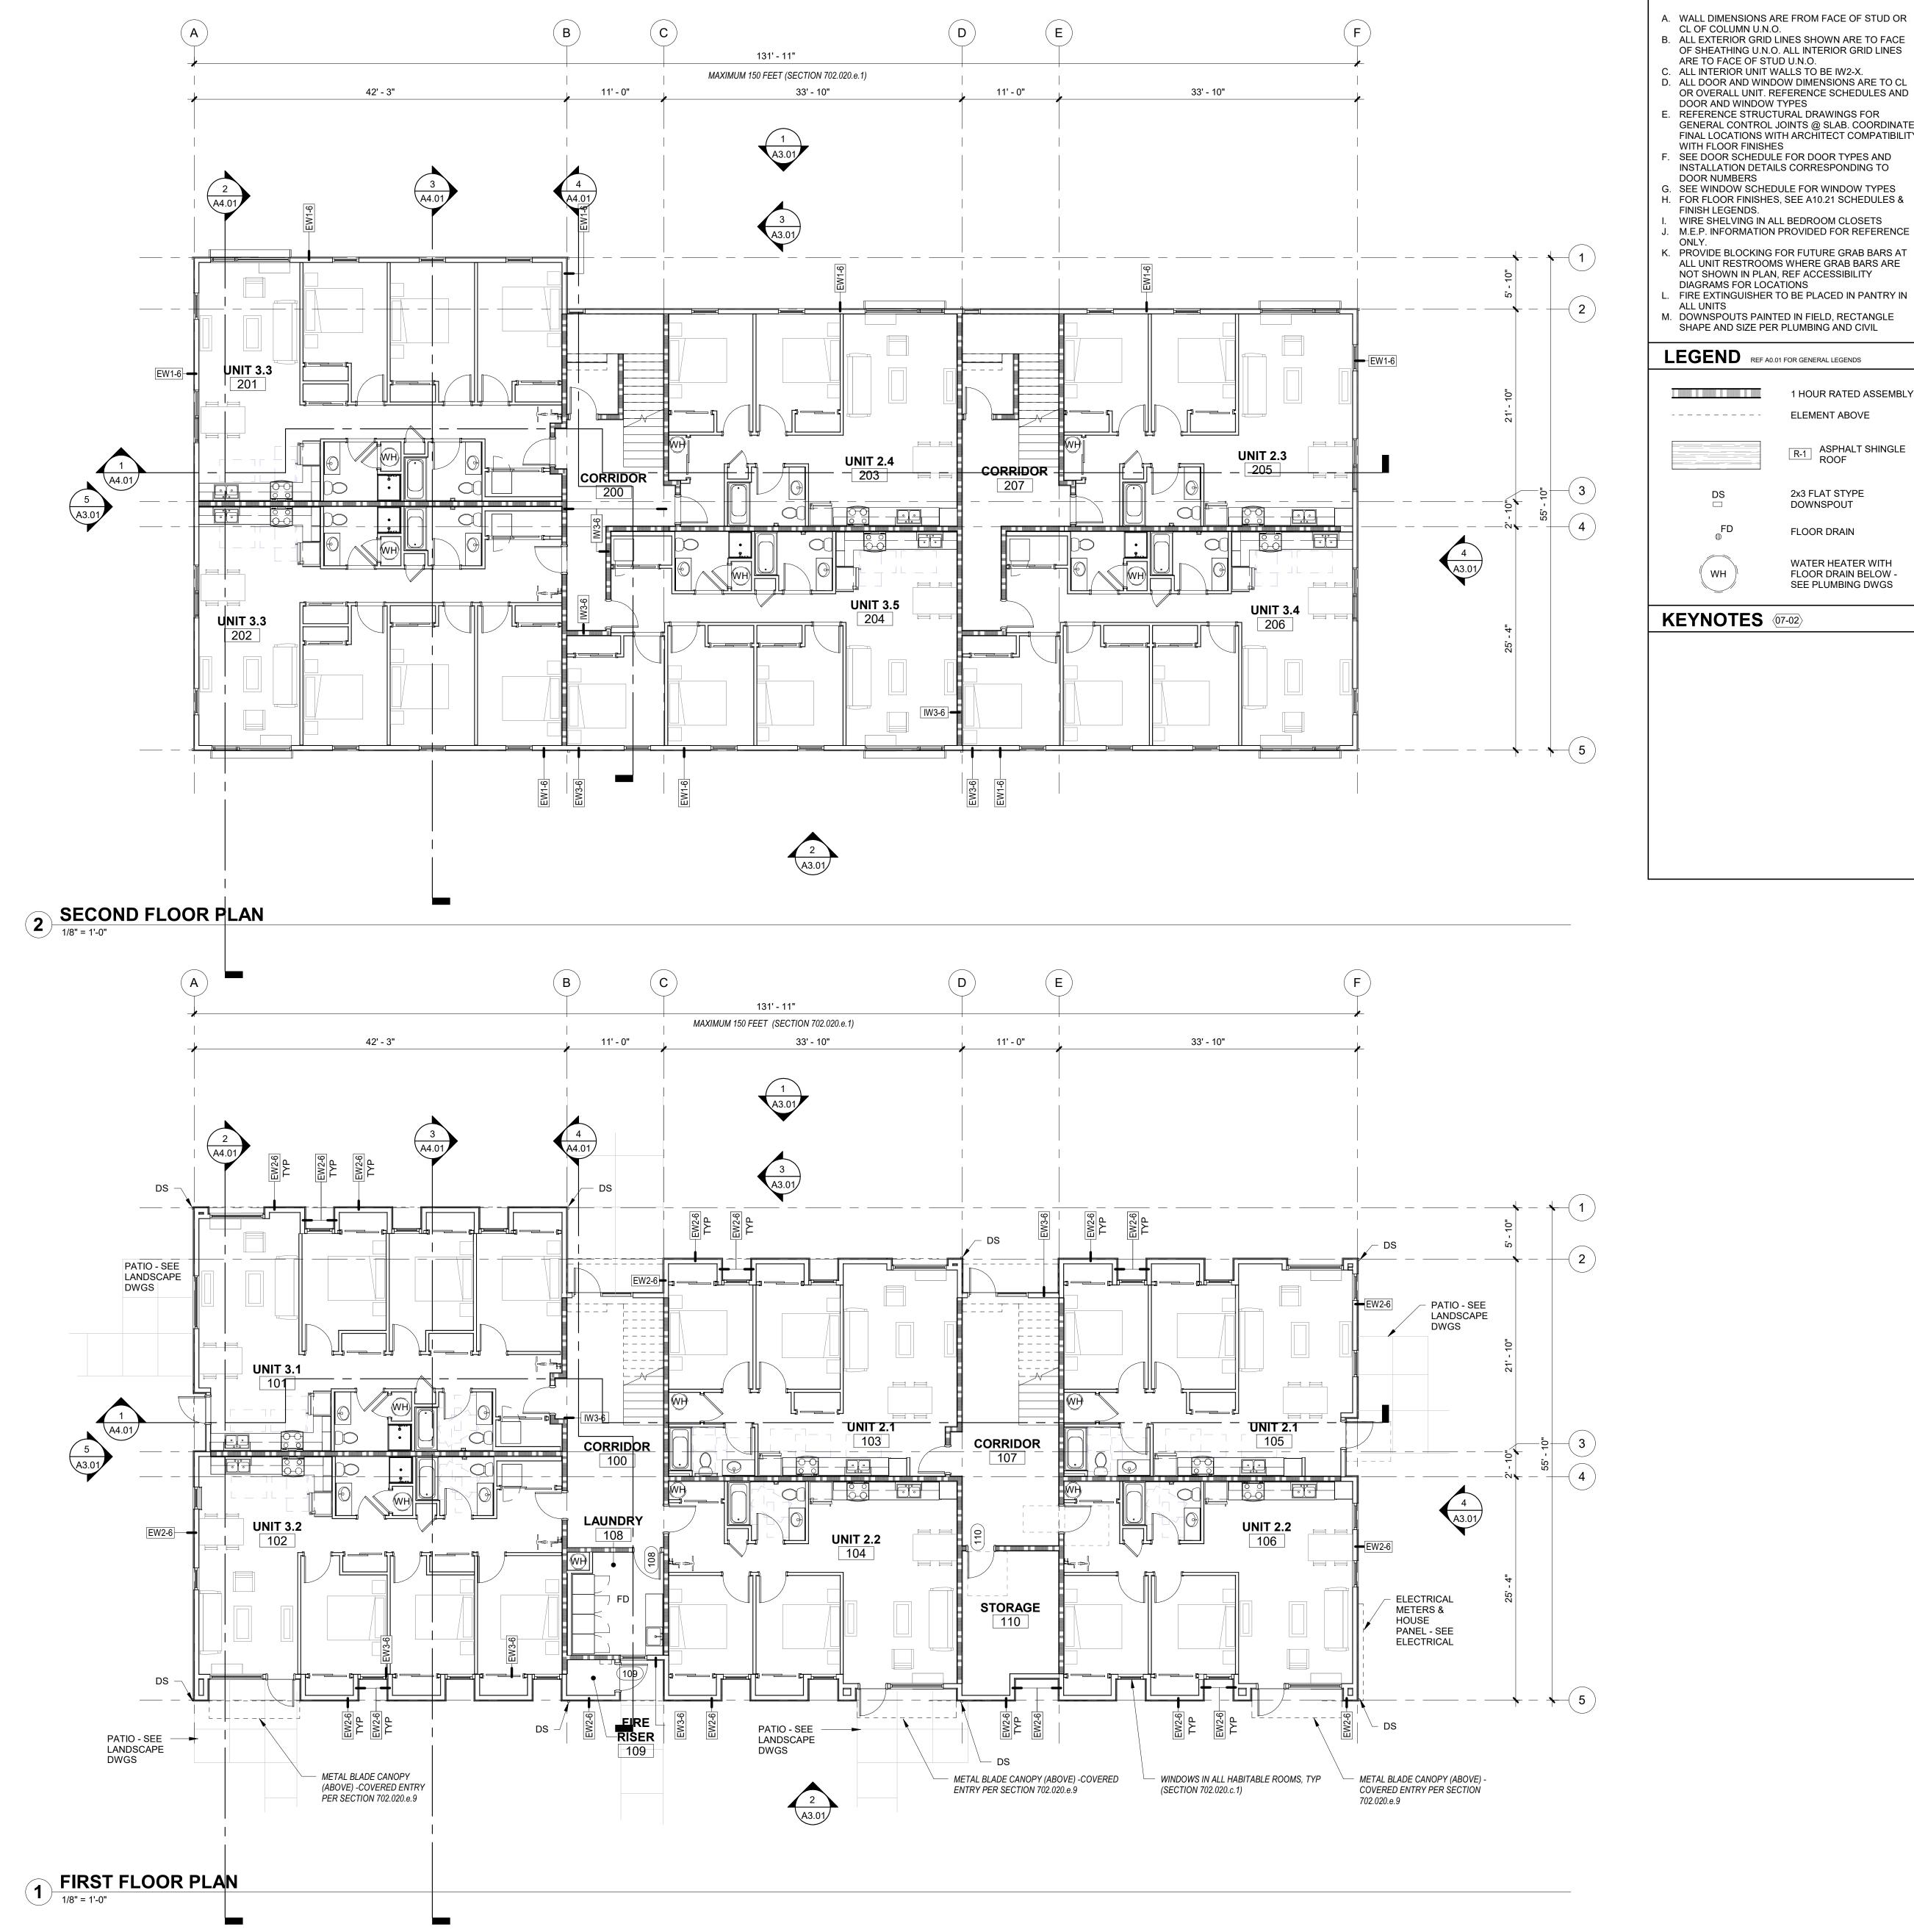

**GENERAL SHEET NOTES** 

DOOR AND WINDOW TYPES

DIAGRAMS FOR LOCATIONS

WITH FLOOR FINISHES

DOOR NUMBERS

FINISH LEGENDS.

----

E. REFERENCE STRUCTURAL DRAWINGS FOR

INSTALLATION DETAILS CORRESPONDING TO

WIRE SHELVING IN ALL BEDROOM CLOSETS

ALL UNIT RESTROOMS WHERE GRAB BARS ARE NOT SHOWN IN PLAN, REF ACCESSIBILITY

. FIRE EXTINGUISHER TO BE PLACED IN PANTRY IN

1 HOUR RATED ASSEMBLY

R-1 ASPHALT SHINGLE ROOF

**ELEMENT ABOVE** 

2x3 FLAT STYPE DOWNSPOUT

FLOOR DRAIN

WATER HEATER WITH FLOOR DRAIN BELOW -SEE PLUMBING DWGS


SHAPE AND SIZE PER PLUMBING AND CIVIL

GENERAL CONTROL JOINTS @ SLAB. COORDINATE FINAL LOCATIONS WITH ARCHITECT COMPATIBILITY

A. WALL DIMENSIONS ARE FROM FACE OF STUD OR CL OF COLUMN U.N.O. B. ALL EXTERIOR GRID LINES SHOWN ARE TO FACE OF SHEATHING U.N.O. ALL INTERIOR GRID LINES ARE TO FACE OF STUD U.N.O.
C. ALL INTERIOR UNIT WALLS TO BE IW2-X.

D. ALL DOOR AND WINDOW DIMENSIONS ARE TO CL OR OVERALL UNIT. REFERENCE SCHEDULES AND

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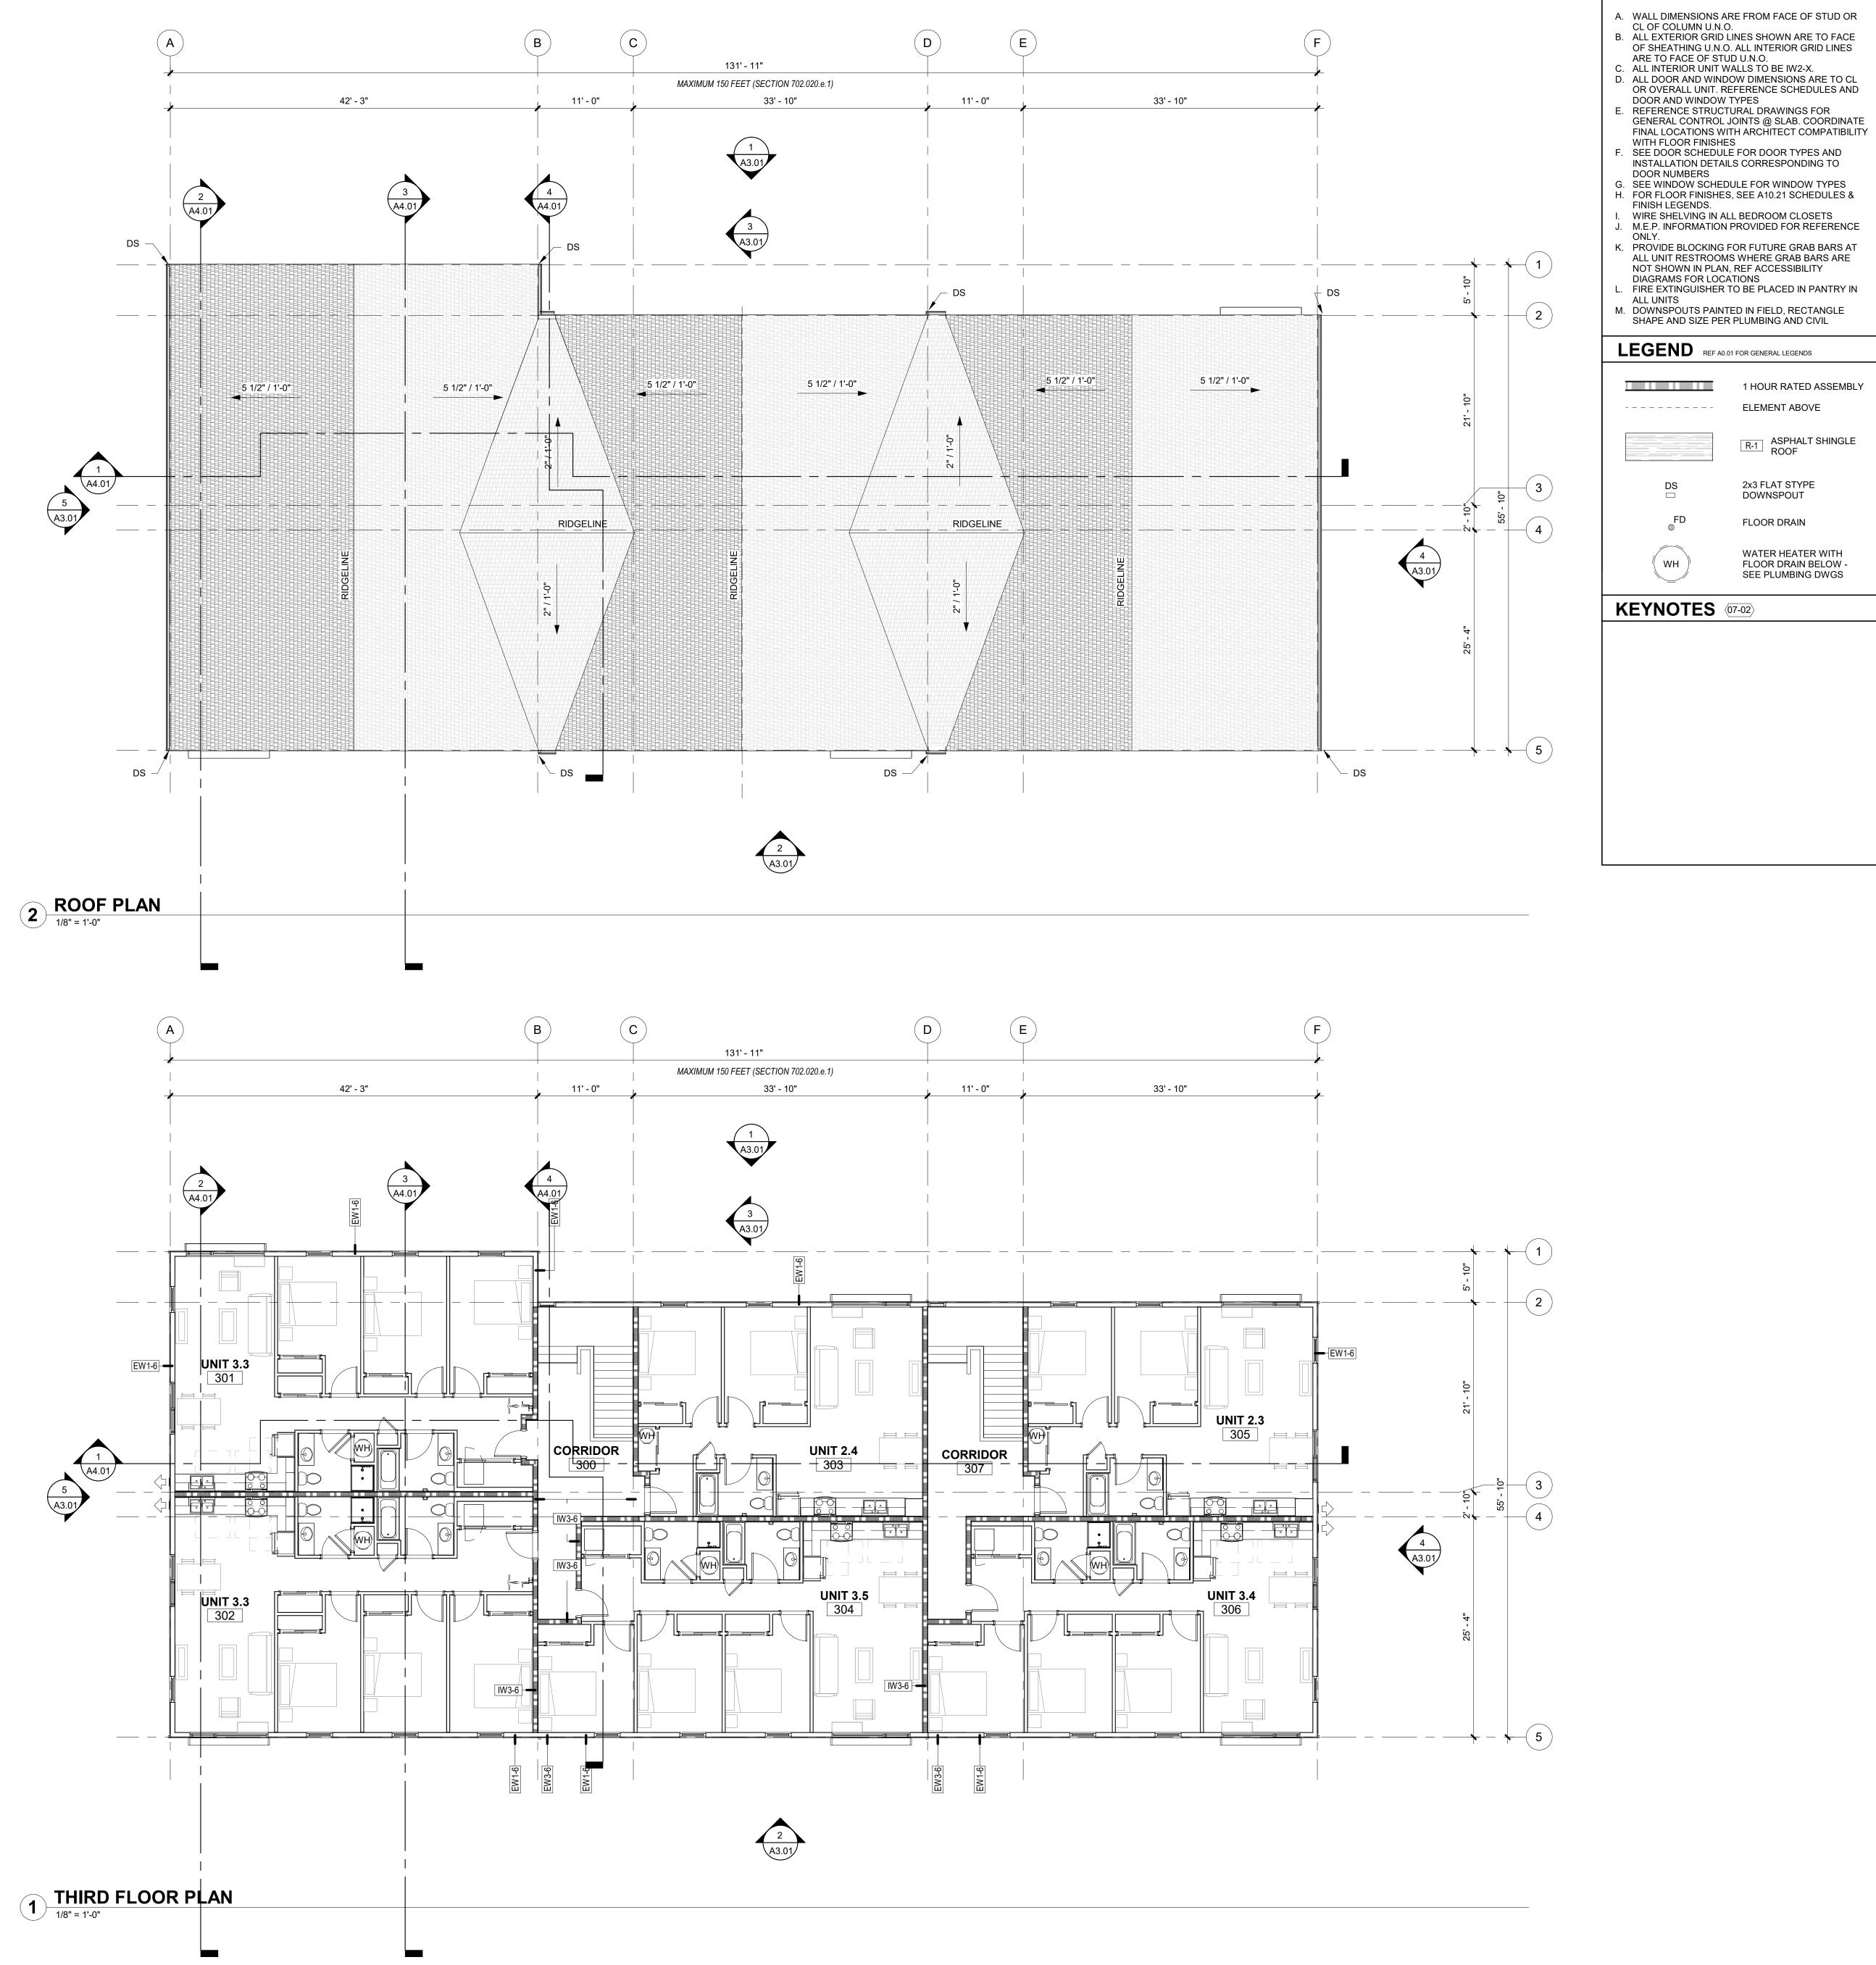
**SALEM, OR 97306** 
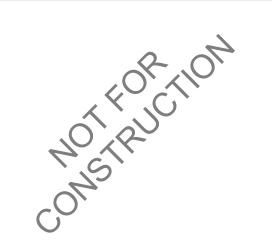
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03.09.2022 DATE Drawing:

FIRST & SECOND **FLOOR PLANS** 





**GENERAL SHEET NOTES** A. WALL DIMENSIONS ARE FROM FACE OF STUD OR CL OF COLUMN U.N.O.

SEE DOOR SCHEDULE FOR DOOR TYPES AND INSTALLATION DETAILS CORRESPONDING TO

SHAPE AND SIZE PER PLUMBING AND CIVIL

1 HOUR RATED ASSEMBLY

R-1 ASPHALT SHINGLE ROOF

**ELEMENT ABOVE** 

2x3 FLAT STYPE DOWNSPOUT

FLOOR DRAIN

WATER HEATER WITH

FLOOR DRAIN BELOW -SEE PLUMBING DWGS

DOOR NUMBERS

FINISH LEGENDS.

ALL UNITS

----

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DATE Drawing:

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THIRD FLOOR & ROOF PLANS

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**GENERAL SHEET NOTES** A. REFERENCE FLOOR PLANS FOR DOOR AND WINDOW LOCATIONS. B. REFERENCE ELECTRICAL FOR EXTERIOR LIGHT APPLICATIONS. C. CONFIRM ALL EXHAUST OPENINGS ARE MINIMUM 3'-0" FROM OPERABLE OPENINGS.
D. ALL EXTERIOR LOUVERS TO BE PAINTED TO MATCH THE EXTERIOR FINISH IT PENETRATES. E. PREFINISHED 22 GAUGE FORMED SHEET METAL WINDOW TRIM, JAMB, AND SILL AT WINDOWS. . PREFINISHED 22 GAUGE METAL THROUGH WALL FLASHING AT WINDOW HEADS. G. TRANSITION BETWEEN FIBER CEMENT SIDING PROFILES TO FOLLOW MANUFACTURER DETAILING AND REQUIREMENTS. **LEGEND** SHINGLE SIDING PRODUCT: SHINGLE SIDING, STRAIGHT EDGE PANEL COLOR: TBD, LIGHT ASPHALT SHINGLE ROOF ASR PRODUCT: TBD COLOR: TBD **FLAT METAL PANEL** PRODUCT: TBD FINISH: BLACK FLAT METAL PANEL, PERFORATED PRODUCT: TBD FINISH: BLACK **VERTICAL WOOD SIDING** PRODUCT: TBD FINISH: TBD (CO-1) CONCRETE STEM WALL X-VENT PTHP (BEYOND)

L \_ \_ \_ \_ J

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COMSTRUCTION

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Drawing:

EXTERIOR ELEVATIONS

03.09.2022

DATE



**BUILDING FACING COURTYARD 1** 

#### **MATERIALS**




**VERTICAL WOOD SIDING** PRODUCT: TBD FINISH: TBD

THESE DRAWINGS ARE THE ORIGINAL UNPUBLISHED WORK OF THE ARCHITECT AND MAY NOT BE DUPLICATED OR USED WITHOUT THE WRITTEN CONSENT OF THE ARCHITECT.



SHINGLE SIDING PRODUCT: SHINGLE SIDING, STRAIGHT EDGE PANEL FINISH: TBD, LIGHT

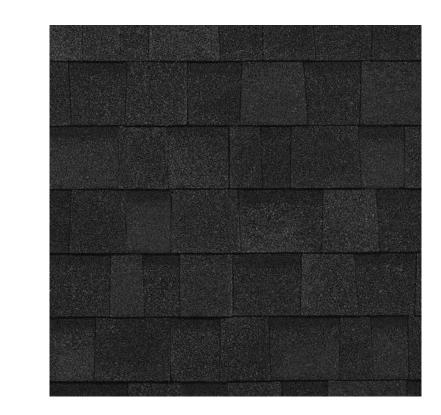

**ASPHALT SHINGLE ROOF** PRODUCT: TBD FINISH: TBD, DARK



**FLAT METAL PANEL** PRODUCT: TBD FINISH: TBD, DARK



**VINYL WINDOWS** PRODUCT: VPI ENDURANCE FINISH: TBD, LIGHT & DARK



PATH FROM PARKING TO COURTYARD



**BUILDING PATIOS** 



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Job Number:


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**RENDERINGS** 



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RIOT FORTION CONSTRUCTION

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Drawing:


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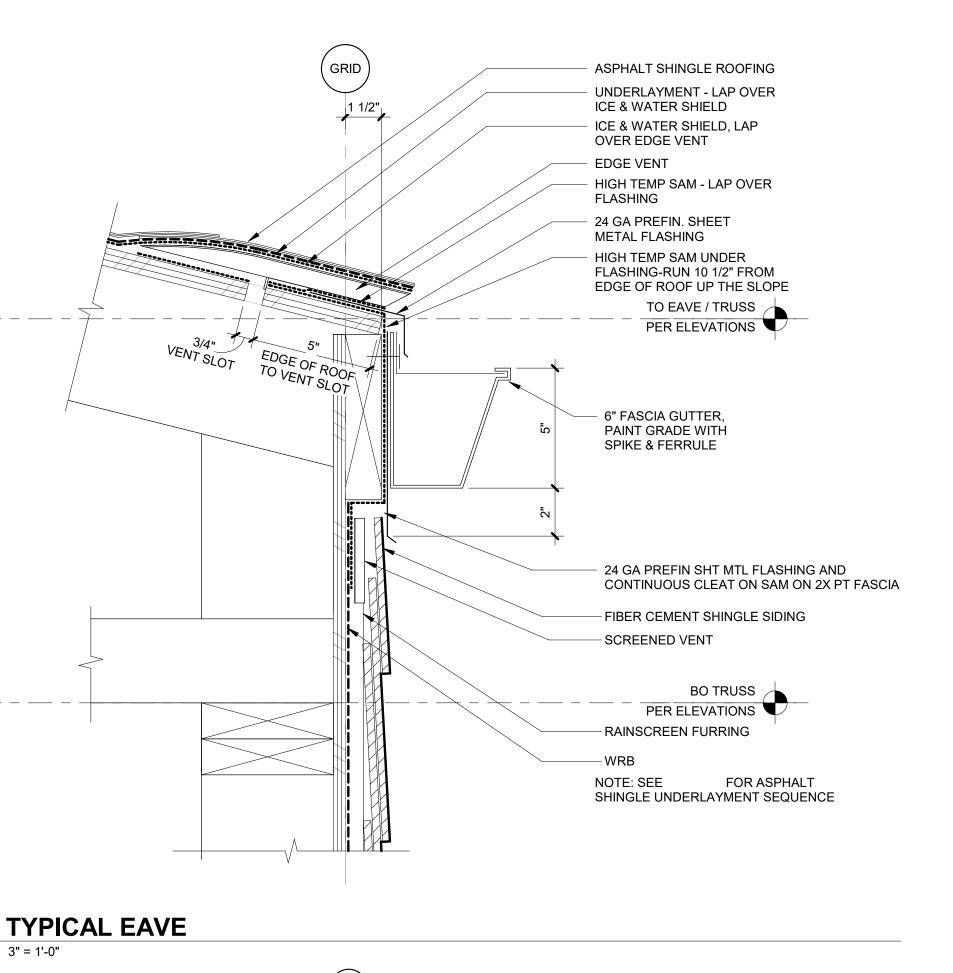
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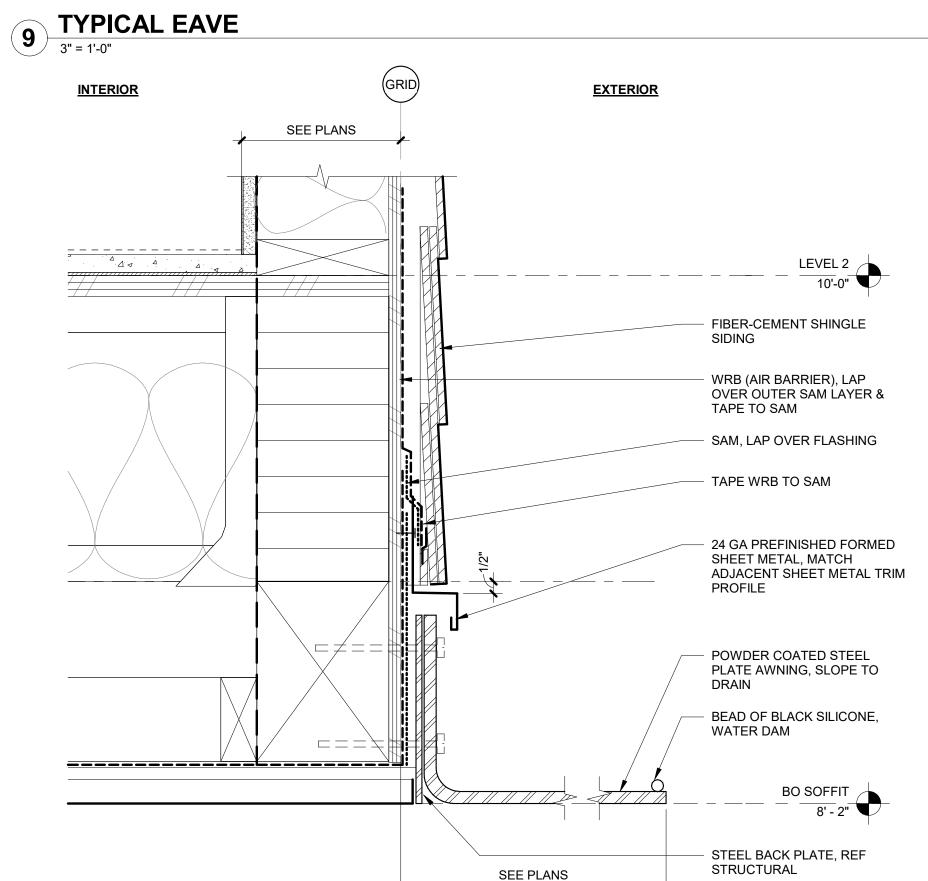
WALL SECTIONS

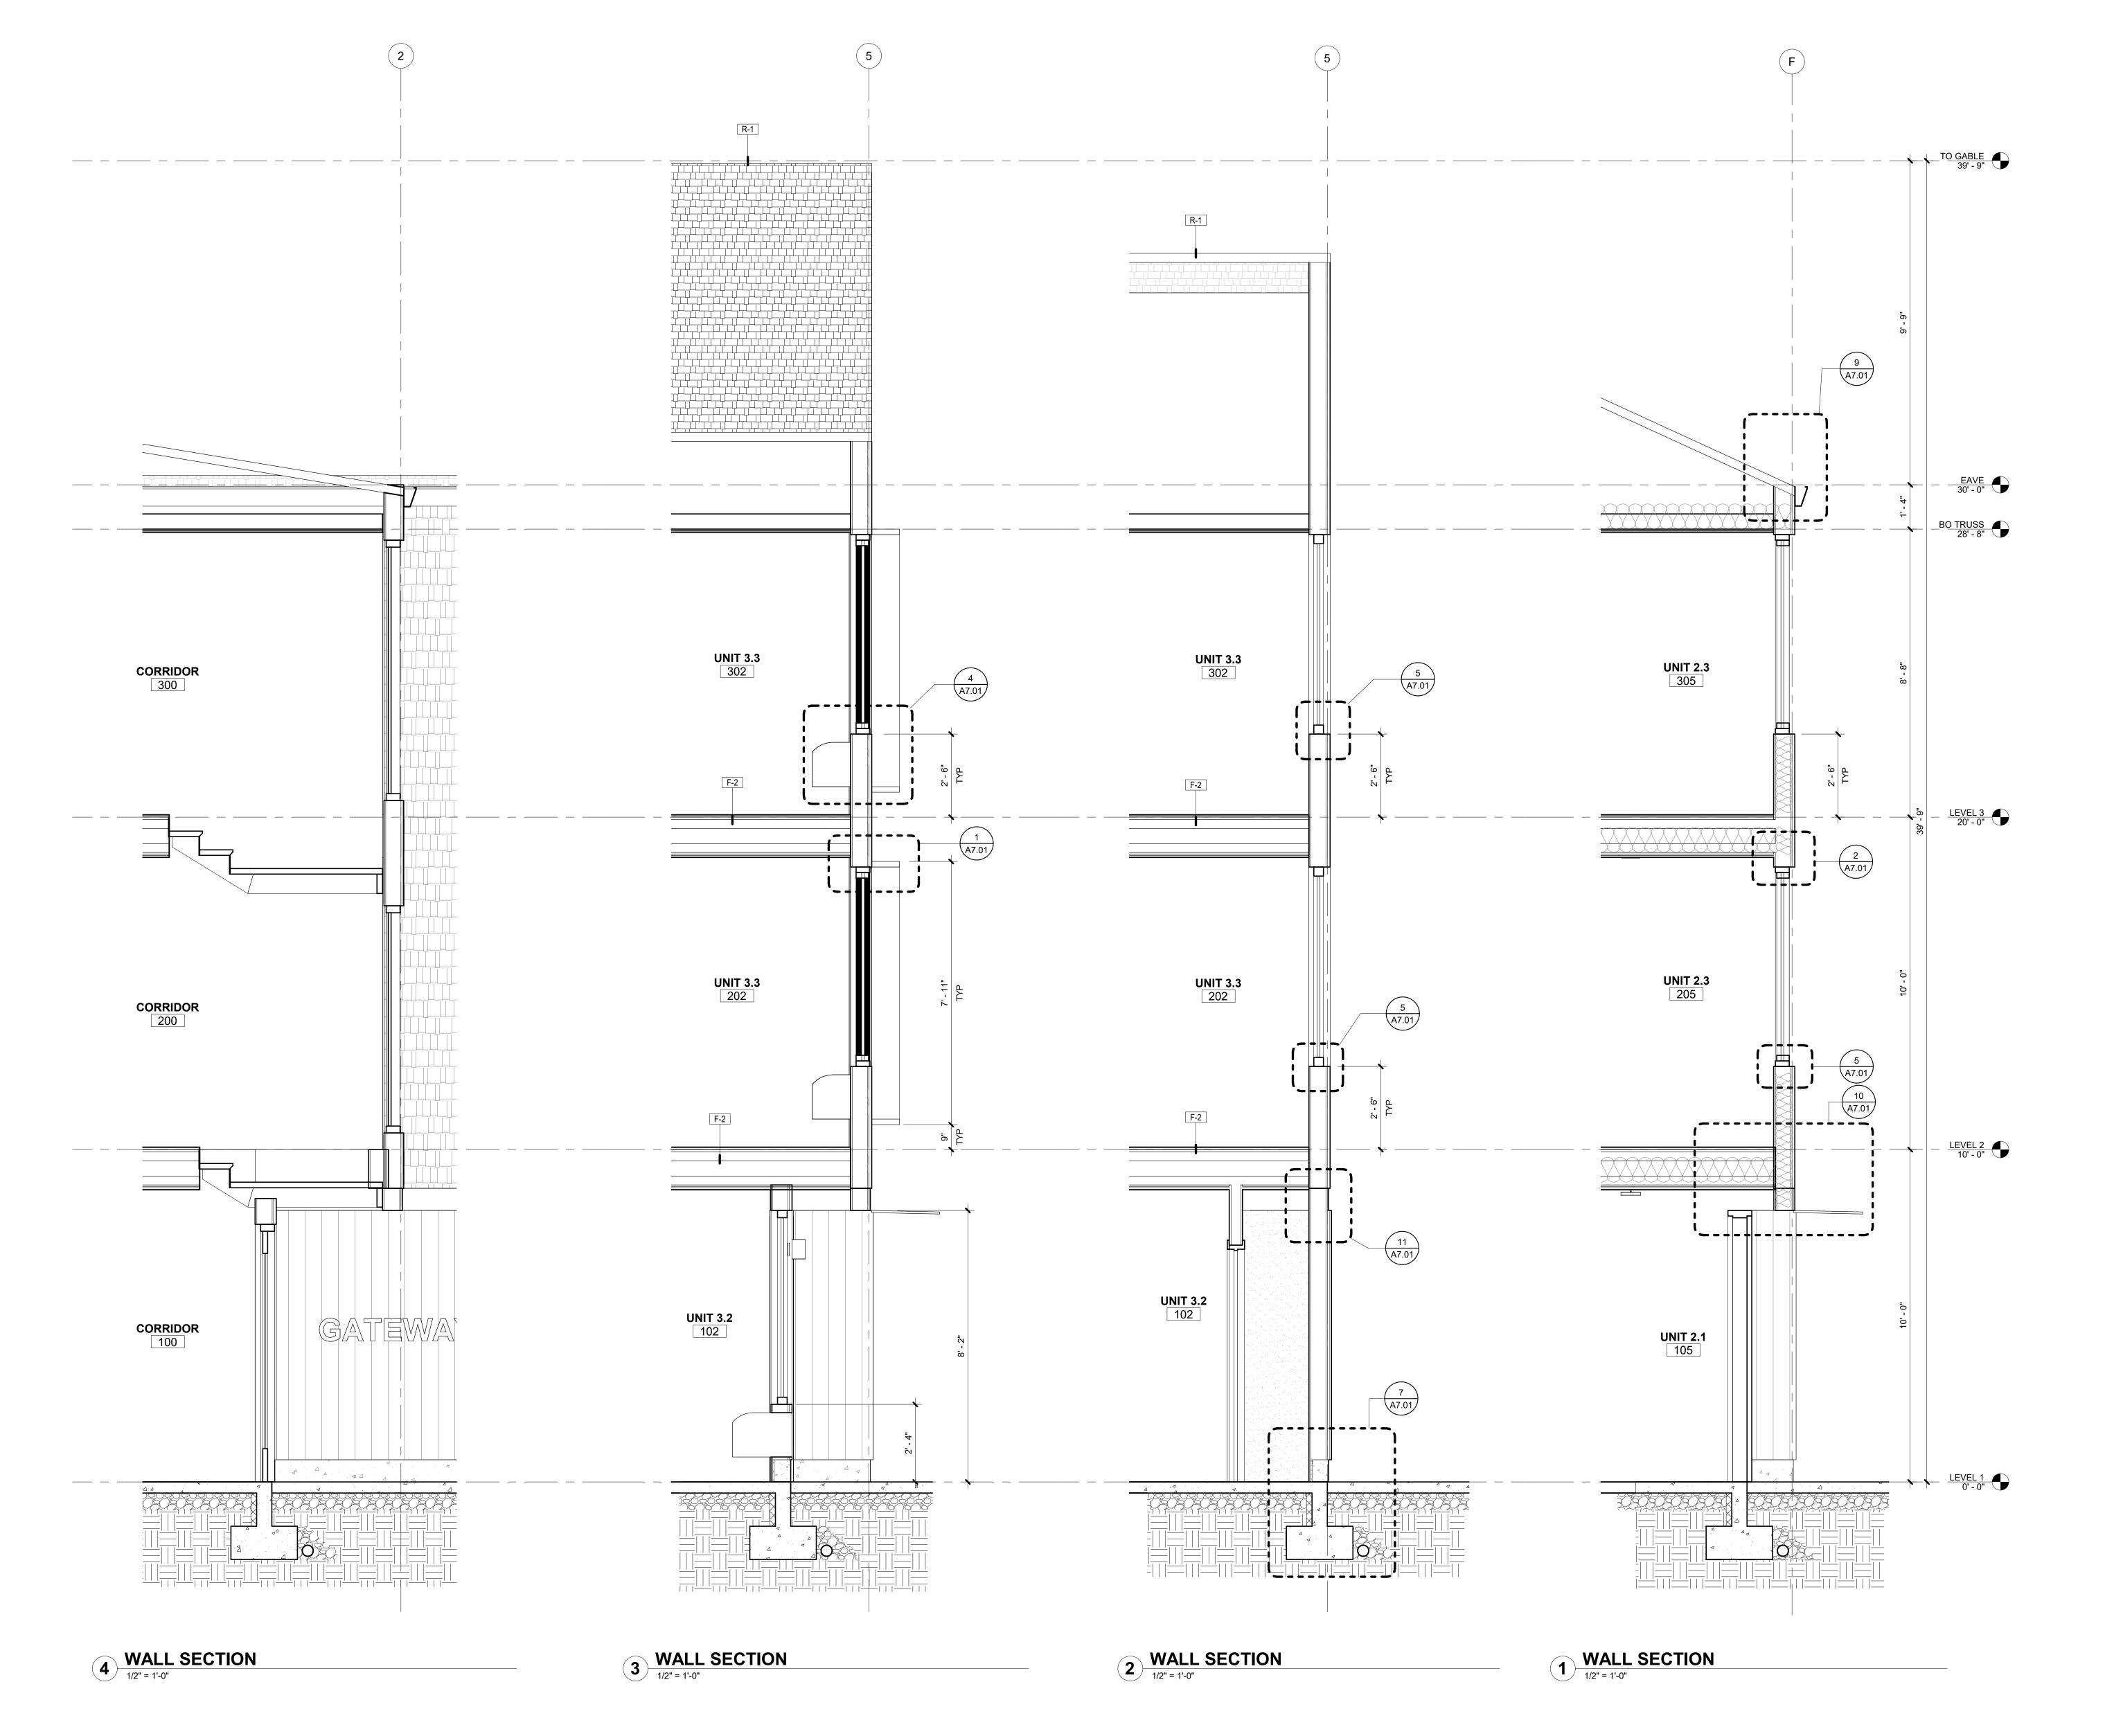Sheet No: Building C -


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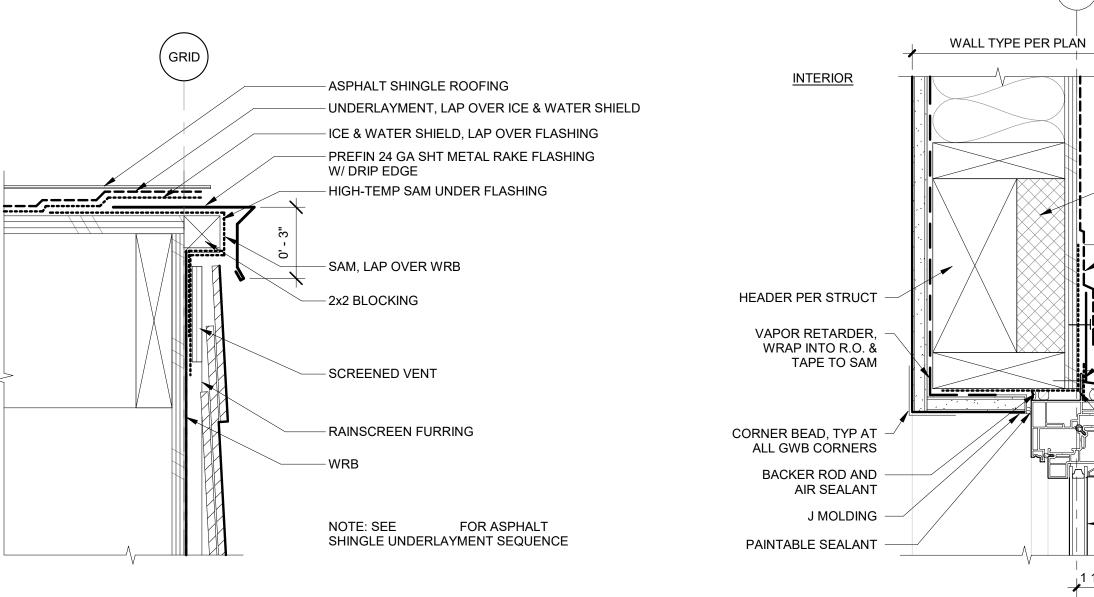








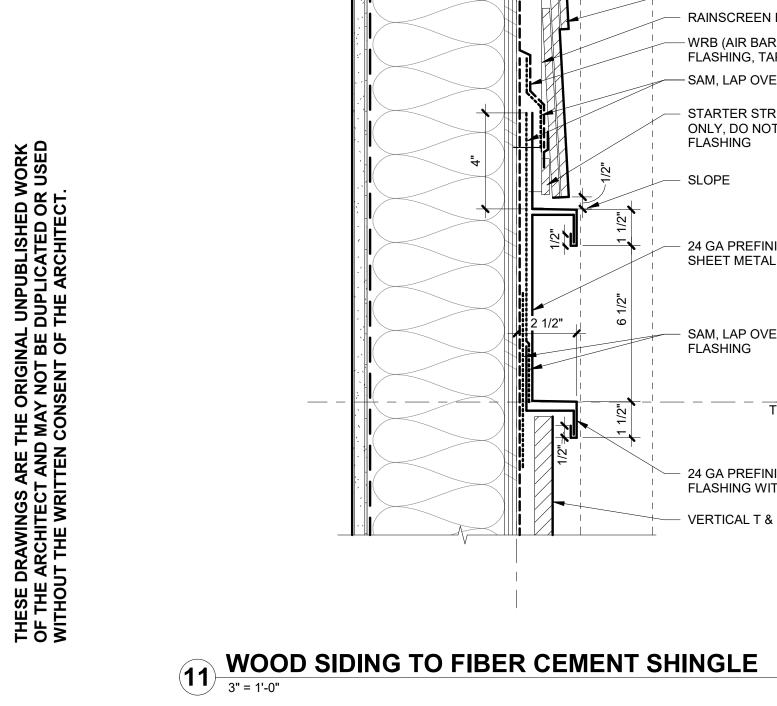



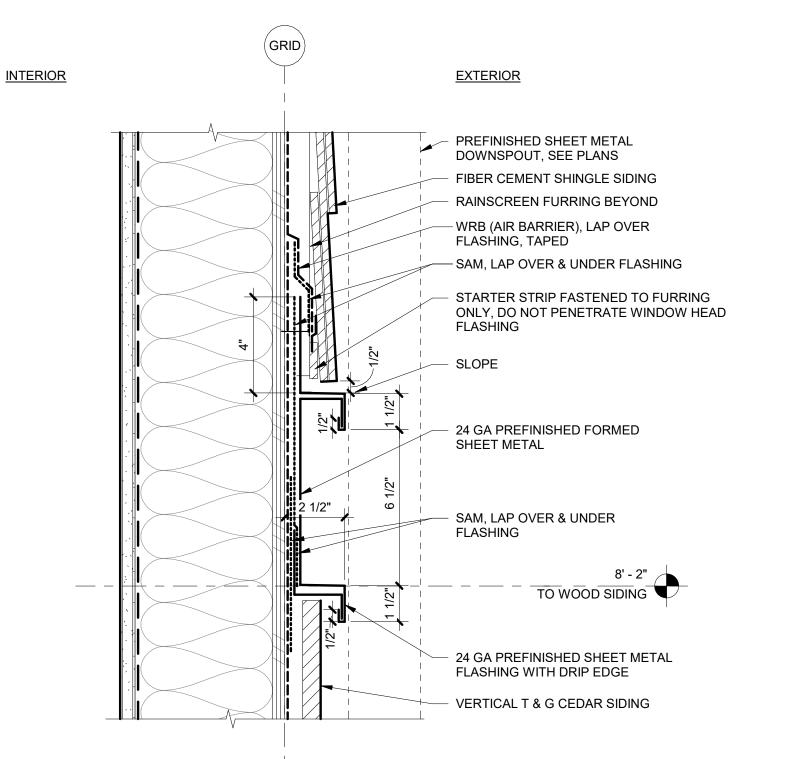

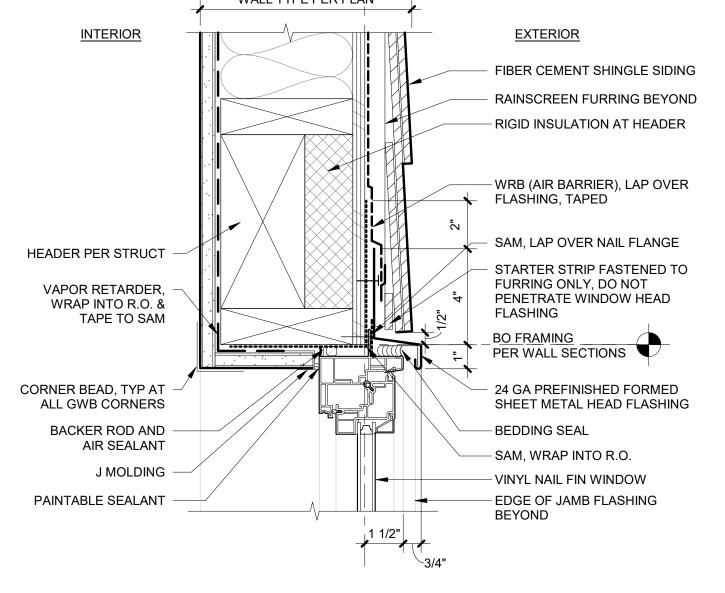

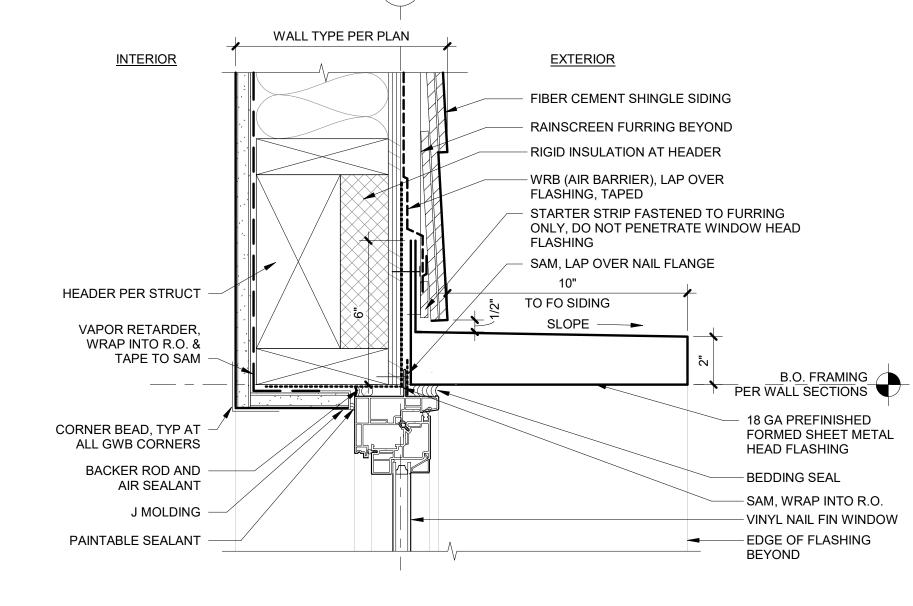







**5205 BATTLE CREEK RD SE SALEM, OR 97306** 

### WINDOW HEAD @ FIBER-CEMENT SIDING W/ TRIM **SURROUND**3" = 1'-0"

WINDOW SILL @ PTHP LEVELS 2-3

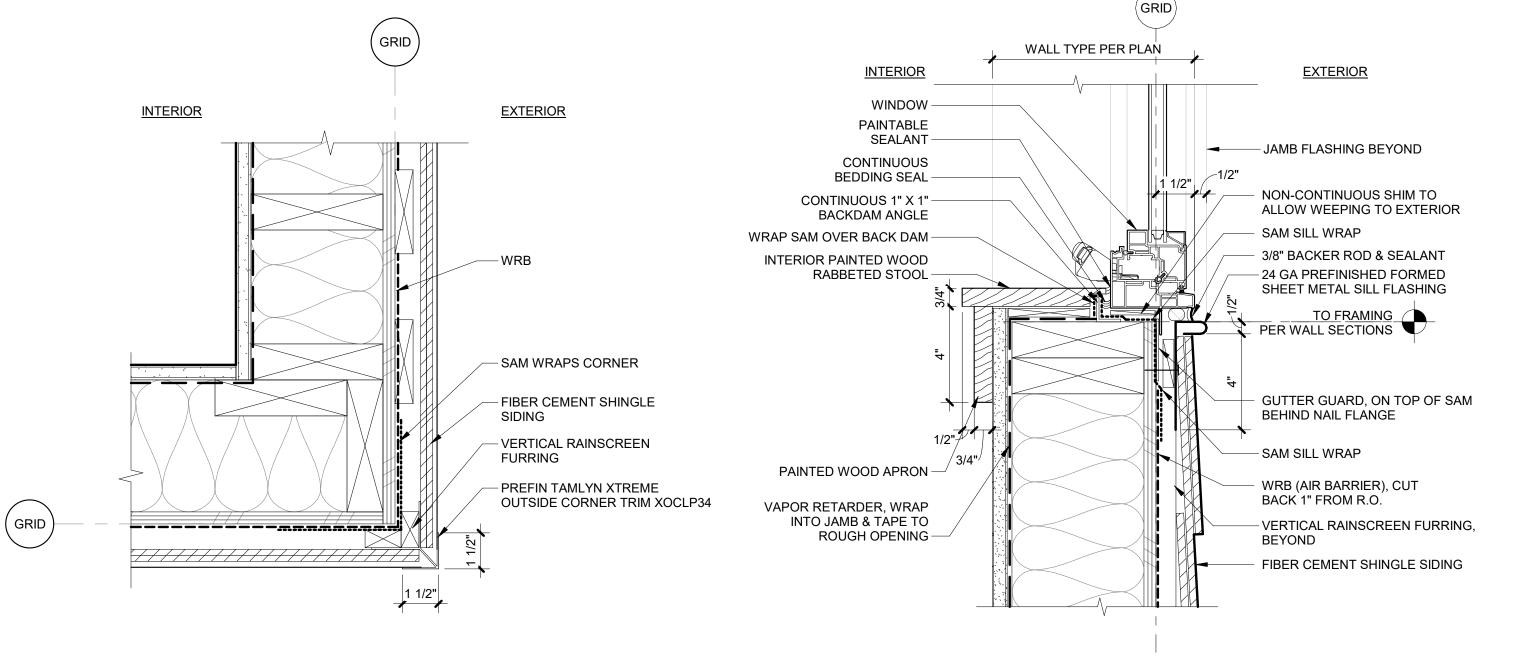

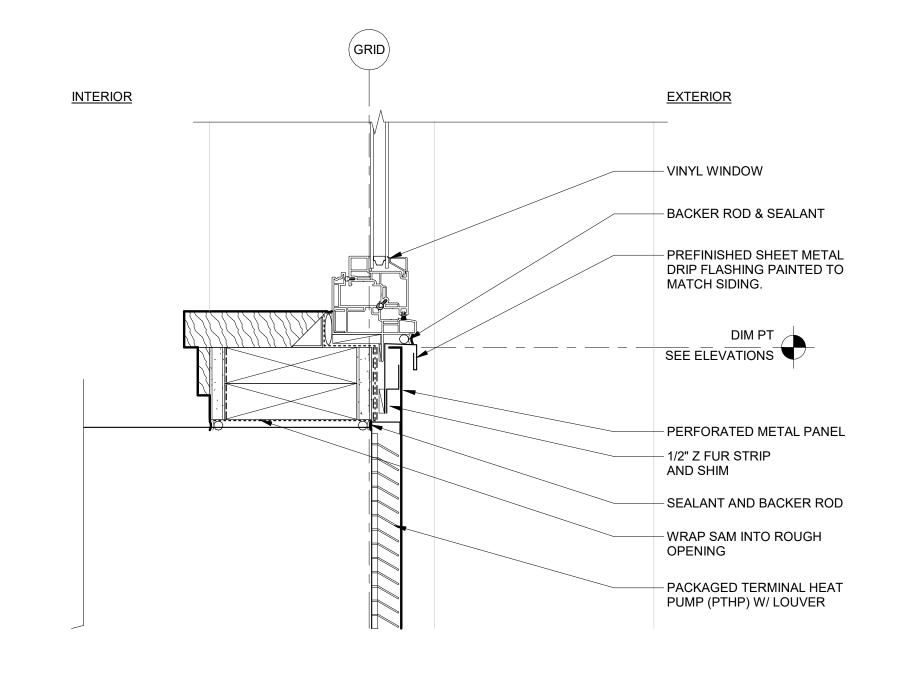



## 6 FIBER CEMENT SHINGLE OUTSIDE CORNER

<u>INTERIOR</u>

GYP BD -

WOOD FRAMING -

INSULATION -

WD NAILER

VAPOR RETARDER -

FOAM SILL GASKET

CONCRETE CURB, R-1.2

WALL BASE PER FINISH PLANS -

SEALANT BEAD BETWEEN

FINISH FLOORING TYPE

PER FINISH PLAN -

GYP AND CONCRETE FLOOR

PROVIDE RIGID INSULATION AT SLAB

FOOTING, WHICHEVER IS LESS -

PERIMETER 2'-0" DEEP OR TO THE T.O.


REF: STRUCTURAL FOUNDATION PLAN —

1/2" CONTINUOUS RIGID INSULATION, R-3 —

3 TYPICAL RAKE



WINDOW HEAD @ FIBER-CEMENT SIDING
3" = 1'-0"

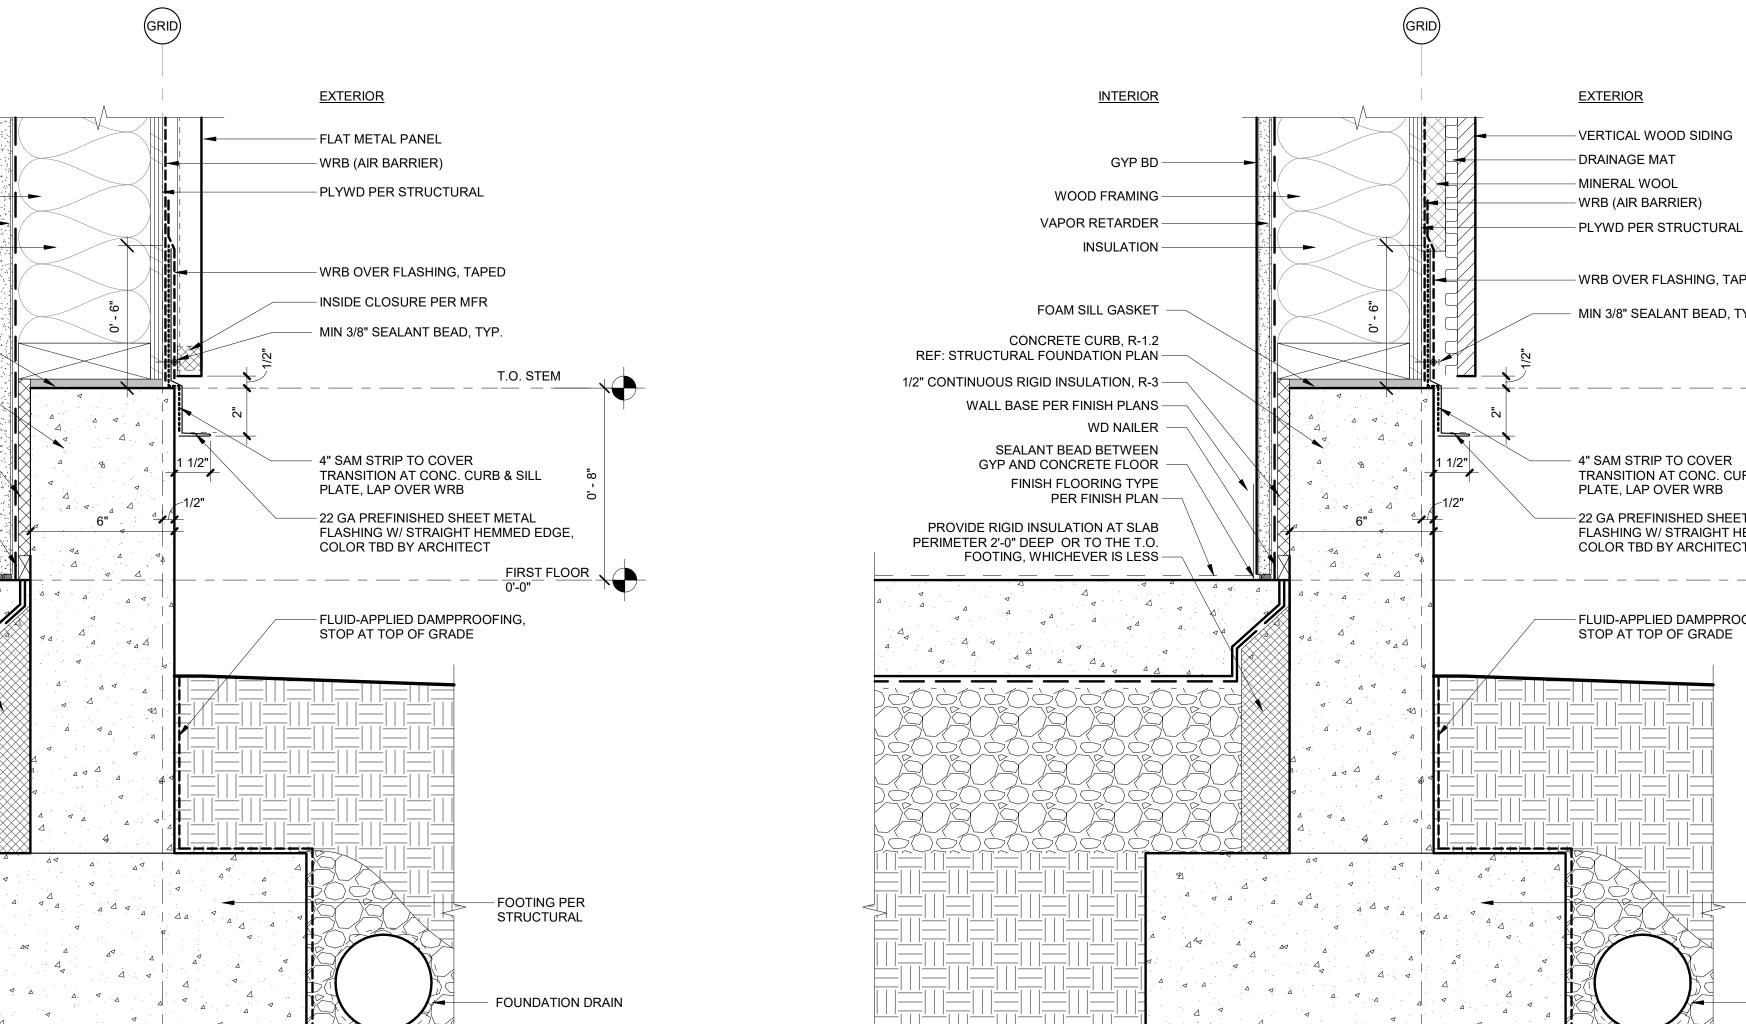

- WRB OVER FLASHING, TAPED MIN 3/8" SEALANT BEAD, TYP. T.O. STEM 4" SAM STRIP TO COVER TRANSITION AT CONC. CURB & SILL PLATE, LAP OVER WRB - 22 GA PREFINISHED SHEET METAL FLASHING W/ STRAIGHT HEMMED EDGE, COLOR TBD BY ARCHITECT - FLUID-APPLIED DAMPPROOFING, STOP AT TOP OF GRADE - FOOTING PER STRUCTURAL FOUNDATION DRAIN

LAND USE 03.09.2022 SUBMISSION **Drawing:** 

**EXTERIOR DETAILS** 

DATE

Sheet No:

8 CURB AT METAL WALL PANEL
3" = 1'-0"

7 CURB AT WOOD SIDING
3" = 1'-0"