LAND USE SUBMISSION

03.11.2022




CDP SALEM - BUILDING B

5205 BATTLE CREEK RD SE SALEM, OR 97306



GENERAL PROJECT NOTES	PROJECT TEAM	PROJECT SUMMARY	SHEET INDEX
REFER TO OWNER-CONTRACTOR AGREEMENT FOR GENERAL CONDITIONS. WHERE	OWNER CDP OREGON LLC		SHEET # SHEET NAME
THERE IS A CONFLICT BETWEEN THE CONTRACT AND NOTES HEREIN, THE CONTRACT TAKES PRECEDENCE.	126 NE ALBERTA ST #202 PORTLAND, OR 97211 TEL: 971.533.7466	PROJECT DESCRIPTION: 3-STORY, WOOD FRAMED MULTIFAMILY BUILDING FEATURING 24 RESIDENTIAL UNITS	GENERAL
GENERAL CONTRACTOR IS RESPONSIBLE FOR THE FULL SET OF CONSTRUCTION DOCUMENTS, INCLUDING BUT NOT LIMITED TO DRAWINGS, SPECIFICATIONS, AND	FAX: N/A CONTACT: THOMAS ELDRIDGE EMAIL: THOMAS@COMMUNITYDEVPARTNERS.COM	GROSS AREA: 22,739 SF	G0.01 GENERAL PROJECT INFORMATION G1.01 CODE SUMMARY
ADDENDA. 2. THE CONTRACTOR SHALL FIELD VERIFY ALL CONDITIONS AND DIMENSIONS PRIOR TO	CONTRACTOR LMC CONSTRUCTION	PROJECT ADDRESS: 5205 BATTLE CREEK RD SE SALEM, OR 97306	
ANY WORK AND SHALL BE RESPONSIBLE FOR ALL WORK AND MATERIALS INCLUDING THOSE FURNISHED BY SUBCONTRACTORS. 3. DIMENSIONS TAKE PRECEDENCE OVER DRAWINGS: DO NOT SCALE DRAWINGS TO	19200 SW TETON AVE TUALATIN, OR 97062 TEL: 503.646.0521	LEGAL DESCRIPTION: 083W14/ 118 AND 300	ARCHITECTURAL A0.01 ARCHITECTURAL GENERAL NOTES AND DIAGRAMS
DETERMINE ANY LOCATIONS. THE ARCHITECT SHALL BE NOTIFIED OF ANY DISCREPANCY PRIOR TO CONTINUING WITH WORK.	FAX: 503.646.6823 CONTACT: CHRIS DUFFIN	ZONING: RM-II	A0.10 ACCESSIBILITY DIAGRAMS - RESIDENTIAL A0.20 ASSEMBLIES
 GENERAL CONTRACTOR SHALL KEEP THE CONSTRUCTION SITE IN A BROOM CLEAN CONDITION AT ALL TIMES DURING THE PROJECT. THE CONTRACTOR SHALL REPORT TO THE ARCHITECT ANY ERRORS, INCONSISTENCIES 	EMAIL: CHRISD@IMCCONSTRUCTION.COM ARCHITECT SCOTT EDWARDS ARCHITECTS, LLP		A1.01 SITE PLAN
OR OMISSIONS HE OR SHE MAY DISCOVER. BRING UNFORSEEN CONDITIONS TO ATTENTION OF ARCHITECT UPON DISCOVERY AT ANY POINT. THE MEANS OF	2525 E. BURNSIDE STREET PORTLAND, OREGON 97214		A2.11 FLOOR PLAN - LEVEL 1 & 2 A2.12 FLOOR PLAN - LEVEL 3 & ROOF PLAN
CORRECTING ANY ERROR OR UNFORSEEN CONDITION SHALL FIRST BE APPROVED BY THE ARCHITECT. 6. ALL REQUIRED CITY AND/OR COUNTY LICENSE SHALL BE ACQUIRED AND PAID FOR BY	TEL: 503.226.3617 FAX: 503.226.3715 CONTACT: DAVE MOJICA		A2.31 REFLECTED CEILING PLAN - LEVEL 1 & 2
THE INDIVIDUAL TRADE. 7. THE ARCHITECT WILL REVIEW SHOP DRAWINGS AND SAMPLES FOR CONFORMANCE WITH THE DESIGN CONCEPT OF THE PROJECT. THE ARCHITECT'S REVIEW OF A	EMAIL: DMOJICA@SEALLP.COM		A2.32 REFLECTED CEILING PLAN - LEVEL 3 A3.01 EXTERIOR ELEVATIONS
SEPARATE ITEM SHALL NOT INDICATE APPROVAL OF AN ASSEMBLY IN WHICH THE ITEM FUNCTIONS.	CIVIL WES TECH ENGINEERING ENGINEER 3841 FAIRVIEW INDUSTRIAL DR SE #100 SALEM, OR 97302		A3.02 EXTERIOR ELEVATIONS A4.01 BUILDING SECTIONS
8. IT SHALL BE THE RESPONSIBILITY OF THE CONTRACTOR TO VERIFY LOCATION OF ALL EXISTING UTILITIES WHETHER SHOWN HEREIN OR NOT AND TO PROTECT THEM FROM DAMAGE. THE CONTRACTOR SHALL BEAR ALL EXPENSES OF REPAIR OR	TEL: 503.585.2474 FAX: N/A		A5.01 WALL SECTIONS
REPLACEMENT OF UTILITIES OR OTHER PROPERTY DAMAGED BY OPERATIONS IN CONJUNCTION WITH THE EXECUTION OF THE WORK. 9. CITY APPROVED PLANS SHALL BE KEPT IN A SECURE PLACE AND SHALL NOT BE USED	CONTACT: STEVE WARD EMAIL: SWARD@WESTECH-ENG.COM		A6.01 ENLARGED UNIT PLANS A6.02 ENLARGED UNIT PLANS
BY WORKERS. THE CONTRACTOR SHALL BE RESPONSIBLE THAT ALL SUBCONTRACTORS' CONSTRUCTION SETS REFLECT THE SAME INFORMATION. THE	LANDSCAPE PLACE ARCHITECT 735 NW 18TH AVENUE	SEPARATE PERMITS AND DEFERRED SUBMITTAL	A6.03 ENLARGED UNIT PLANS A6.04 KITCHEN & BATH ELEVATIONS
CONTRACTOR SHALL ALSO MAINTAIN, IN GOOD CONDITION, ONE COMPLETE SET OF STAMPED CITY APPROVED PLANS WITH ALL REVISIONS, ADDENDUMS, AND CHANGE ORDERS ON THE PREMISES AT ALL TIMES. THESE ARE TO BE UNDER THE CARE OF THE	PORTLAND, OR 97209 TEL: 503 334 2080 FAX: N/A	BIDDER DESIGN ITEMS	A7.01 EXTERIOR DETAILS
JOB SUPERINTENDENT AND MUST BE MADE AVAILABLE TO BUILDING AND FIRE INSPECTIONS FOR REFERENCE DURING CONSTRUCTION. 10. THE CONTRACTOR SHALL BE RESPONSIBLE FOR THE COMPLETE SECURITY OF THE	CONTACT: MAURICIO VILLARREAL EMAIL: MAURICIO.VILLARREAL@PLACE.LA	CONTRACTOR SHALL PROVIDE DESIGN, ENGINEERING, FURNISHING AND INSTALLATION OF A COMPLETE, FUNCTIONING SYSTEM(S) BASED ON THE SCHEMATIC LAYOUT SHOWN ON THE	A7.02 CLADDING DETAILS
SITE WHILE THE JOB IS IN PROGRESS AND UNTIL JOB COMPLETION. 11. THE CONTRACTOR SHALL TAKE ALL NECESSARY PRECAUTIONS TO ENSURE THE	STRUCTURAL STONEWOOD STRUCTURAL ENGINEERS, INC ENGINEER 2001 NW 19TH SUITE 103A	ARCHITECTURAL DRAWINGS, DESCRÍBED HEREIN AND IN COMPLIANCE WITH PREVAILING CODE. THE CONTRACTOR SHALL BE RESPONSIBLE FOR FINAL ORDERING OF ALL DEVICES AND FIXTURES TO ENSURE PROPER OPTIONS, ACCESSORIES AND CONFIGURATIONS.	A7.03 WINDOW SEQUENCING & PENETRATION DETAILS A7.04 WINDOW DETAILS
SAFETY OF THE OCCUPANTS AND WORKERS AT ALL TIMES. 12. THE CONTRACTOR IS SOLELY RESPONSIBLE FOR ALL CONSTRUCTION MEANS AND METHODS AND SHALL MAINTAIN THE STRUCTURAL INTEGRITY OF ANY CONSTRUCTION.	PORTLAND, OR 97209 TEL: 360.216.1704 FAX: N/A	CONTRACTOR SHALL PROVIDE COMPLETE DESIGN AND DOCUMENTATION AS REQUIRED FOR SUBMISSION TO, AND APPROVAL OF ARCHITECT, OWNER, AND GOVERNING BUILDING	A7.04A DOOR DETAILS
13. THE CONTRACTOR SHALL BE RESPONSIBLE FOR AND SHALL REPLACE OR REMEDY ANY FAULTY, IMPROPER, OR INFERIOR MATERIALS OR WORKMANSHIP WHICH SHALL	CONTACT: D. SCOTT NYSETH EMAIL: SCOTT.NYSETH@STONEWOODSTRUCTURAL.COM	DEPARTMENT. UPON COMPLETION OF REVIEW BY THE ARCHITECT OR ENGINEER OF RECORD, THE	A7.05 MATERIAL TRANSITIONS A7.06 ROOF DETAILS
APPEAR WITHIN ONE (1) YEAR AFTER THE COMPLETION AND ACCEPTANCE OF THE WORK UNDER THIS CONTRACT. 14. CONTRACTOR TO PROVIDE BACKING OR BLOCKING AS REQUIRED FOR MOUNTING ALL	MEP INTERFACE ENGINEER 100 SW MAIN STREET, SUITE 1600	CONTRACTOR SHALL BE RESPONSIBLE FOR ROUTING DOCUMENTS TO PERMIT AGENCY FOR PLANS REVIEW AND PAYING ANY PLANS CHECK AND PERMIT FEES.	A9.01 INTERIOR FIRE RATING DETAILS A10.01 DOOR SCHEDULE AND DOOR & WINDOW TYPES
WALL MOUNTED SHELVES, EQUIPMENT, ACCESSORIES, CABINETS, ETC. 15. CONTRACTOR TO PROTECT ALL TREES AND ROOTS NOT SLATED FOR REMOVAL DURING CONSTRUCTION.	PORTLAND, OR 97204 TEL: 503.382.2266	SEPARATE PERMITS:	A10.21 FINISH SCHEDULE AND LEGEND
16. GENERAL CONTRACTOR RESPONSIBLE FOR MAINTENANCE OF STAGING AREA AND TO ENSURE THAT MATERIALS DELIVERY AND STORAGE DOES NOT INTERFERE WITH DAILY	FAX: 503.382.2262 CONTACT: KIM W EMAIL: KIMW@INTERFACEENG.COM	1. DEMOLITION PERMIT 2. SIGNAGE PERMIT	STRUCTURAL
OPERATION OF ADJACENT PROPERTIES OR PUBLIC RIGHT OF WAY. 17. GENERAL CONTRACTOR RESPONSIBLE FOR CONSTRUCTION STAKING.	,	3. FIRE SPRINKLER SYSTEM4. FIRE DETECTION AND ALARM SYSTEM	S0.01 GENERAL STRUCTURAL NOTES AND SPECIAL INSPECTIONS
		5. FIRE DEPARTMENT ACCESS KEY BOX6. HANGERS AND SUPPORT FOR HVAC7. VIBRATION AND SEISMIC CONTROLS FOR HVAC	S1.01 TYPICAL DETAILS
		 LATERAL BRACING AND ANCHORAGE OF MECHANICAL AND ELECTRICAL EQUIPMENT WEIGHING MORE THAN 75 LBS (EXCEPTIONS PER ASCE 7, SECTION 13.1.4) 	S1.02 TYPICAL DETAILS S1.03 TYPICAL DETAILS
		9. PRE-ENGINEERED MANUFACTURED TRUSSES 10. STAIR FRAMING 11. ALUMINUM STOREFRONT	S1.04 SHEET NOTES AND SCHEDULES S2.01a FOUNDATION PLAN - SECTOR A
		SEE SPECIFICATIONS FOR ADDITIONAL REQUIREMENTS NOT LISTED HERE AND ADDTIONAL	S2.01b FOUNDATION PLAN - SECTOR B
		BIDDER DESIGN ITEMS.	S2.02a SECOND FLOOR FRAMING PLAN - SECTOR A S2.02b SECOND FLOOR FRAMING PLAN - SECTOR B
			S2.03a THIRD FLOOR FRAMING PLAN - SECTOR A
			S2.03b THIRD FOOR FRAMING PLAN - SECTOR B S2.04a ROOF FRAMING PLAN - SECTOR A
			S2.04b ROOF FRAMING PLAN - SECTOR B
			S4.01 FOUNDATION DETAILS S5.01 FRAMING DETAILS
			S5.02 FRAMING DETAILS
	VICINITY MAP	-	
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	PROJECT SITE		
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CDP SALEM -BUILDING B

21031

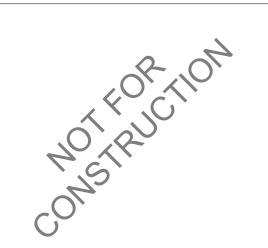Job Number:

5205 BATTLE CREEK RD SE SALEM, OR 97306

LAND USE SUBMISSION ISSUE

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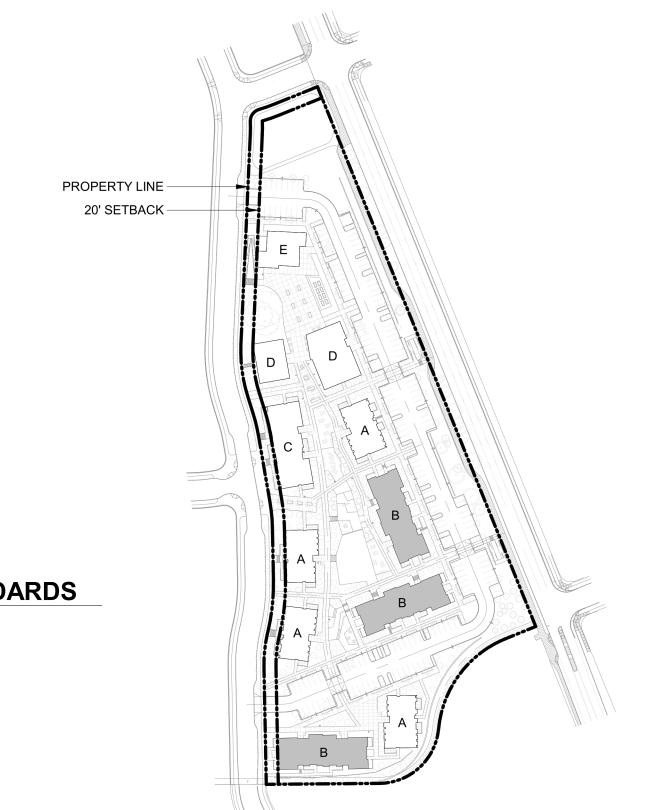
GENERAL PROJECT INFORMATION

03.11.2022

DATE

OF THE ARCHITECT AND MAY NOT BE DUPLICATED OR USED	WITHOUT THE WRITTEN CONSENT OF THE ARCHITECT.
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UILDING CODE	SUMMARY 2019 OR	REGON STRUCTURAL SPECIALTY CO	DDE	CHAPTER 10: MEANS OF EGRESS					
OCCUPANCY	R-2			SECTION 1004 OCCUPANT LOAD (OL) SEE OCCUPANT LOAD TABLE					
CONSTRUCTION TYPE	V-B, SPRINKLERED PER NFPA 13-R			SECTION 1005.3.1	STAIRWAY EGRESS CAPACITY FAC	CTOR 0.3			
CHAPTER 4: SPECIAL D	DETAILED REQUIREMENTS BASE	D ON OCCUPANCY AND USE		SECTION 1005.3.2	OTHER EGRESS CAPACITY FACTO	R 0.2			
DSSC REFERENCE SECTION 420.2	SEPARATION WALLS WALLS	SEPARATING DWELLING OR SLEEPING UNITS FI	ROM FACH OTHER	TABLE 1006.2.1	MAX OCCUPANT LOAD FOR ONE EXMAX COMMON PATH OF EGRESS T				
SECTION 420.2	OR OTH	HER OCCUPANCIES SHALL BE CONSTRUCTED AS ORDANCE WITH SECTION 708.		TABLE 1006.3.2	MAX OCCUPANT LOAD PER STORY	ý 500			
SECTION 420.3	EACH O	ASSEMBLIES SEPARATING DWELLING OR SLEEDTHER OR OTHER OCCUPANCIES SHALL BE CON	NSTRUCTED AS	7,622,633,6,2	MIN NUMBER OF EXITS FOR STORY				
HORIZONTAL ASSEMBLIES IN ACCORDANCE WITH SECTION 711. SECTION 420.4 SPRINKLER SYSTEM GROUP R OCCUPANCIES, REQUIRED PER 903.2.8		TABLE 1006.3.3(1)	STORIES WITH ONE EXIT FOR R-2	EMERGENCY ESCAPE A	4 UNITS / 125 FT TRAVEL DISTANCE / UP TO 3 STORIES EMERGENCY ESCAPE AND RESCUE OPENINGS PER 1030 REQUIRED FOR STORIES WITH ONE EXIT				
SECTION 420.5		P R-2, FIRE ALARM SYSTEMS REQUIRED PER SEC E ALARMS REQUIRED PER 907.2.10.2	CTION 907.2.9	TABLE 1017.2	EXIT ACCESS TRAVEL DISTANCE	250 FT	S WITH ONE EXIT		
				TABLE 1020.1	CORRIDOR FIRE-RESISTANCE RAT				
CHAPTER 5: GENERAL	BUILDING HEIGHTS AND AREAS	j		TABLE 1020.2	MINIMUM CORRIDOR WIDTH		WITHIN DWELLING UNIT (OR WHERE	
ABLE 504.3 ABLE 504.4 ABLE 506.2	HEIGHT / STORIES / AREA FACTOR	R-2: 60 FT / 3 STORY / 7000 SF		SECTION 1020.4	DEAD ENDS	OCCUPANT LOAD <50 20 FEET *! FNOTH IS NOT LIMITE		WIDTH	
MODIFICATIONS						LENGTH IS NOT LIMITE	D WHERE LENGTH < 2.5x \	חוטוא	
SECTION 506.2.3	BUILDING AREA Aa =	= [At + (NS x lf)] x Sa		CHAPTER 11: ACCESSIBI	LITY				
SINGLE-OCCUPANCY MULTISEQUATION 5-2	= 12	000 SF + (7000 SF x 0.75)] x 3 2250 SF x 3 3750 SF		SECTION 1106.2	R-2 OCCUPANCIES WITH ACCESSIE PROVIDED SHALL BE ACCESSIBLE		EAST 2% OF EACH TYPE (OF PARKING	
SECTION 506.3		= [F/P - 0.25] x W/30			TOTAL SPACES PROVIDEI	D: 167			
GEO 11011 000.10	If =	= [414/414 - 0.25] x 30/30 0.75			ACCESSIBLE SPACES REC ACCESSIBLE SPACES PRO	OVIDED: 6			
	ACTUAL HEIGHT / STORIES 37'	" - 2" / 3 Story			VAN ACCESSIBLE SPACES VAN ACCESSIBLE SPACES	S PROVIDED: 1	SSIBLE SPACES		
		NG AREA			WHEELCHAIR ONLY SPAC WHEELCHAIR ONLY SPAC		SPACES		
	FLOOR LEVEL	AREA (SF) 7719 SF		SECTION 1107.6.2.2.1	R-2 OCCUPANCIES WITH GREATER R-2 UNITS ON A SITE SHALL BE CO				
	LEVEL 3.1 LEVEL 2.1	7719 SF 7719 SF			NUMBER OF TYPE A UNITS			LQUINED	
		23157 SF			TYPE A UNITS PROVIDED	·	UNITS		
SECTION 508.2	ACCESSORY OCCUPANCY N/A	A		SECTION 1107.6.2.2.2	TYPE A UNITS PROVIDED WHERE THERE ARE FOUR OR MOR	,	ALL DE TVDE DUNITO AT	Δ	
SECTION 508.3 / 508.4	MIXED OCCUPANCY N/A	A							
TABLE 509	INCIDENTAL USES			EXCEPTION:	THE NUMBER OF TYPE A AND TYPE SECTION 1107.7	WITHOUT ELEVATOR SERVICE, ONI			
		PRINKLERED, NO SEPARATION REQUIRED PRINKLERED, NO SEPARATION REQUIRED			TIOT.T. II, OTROGIONEO	WITHOUT ELEVATION GENVIOL, ON		TO REGUIRED	
CHAPTER 6: TYPES OF	CONSTRUCTION / CONSTRUCTION	ON CLASSIFICATION		ADDITIONAL ACCESSIBIL	ITY REQUIREMENTS				
TABLE 601	on Fire resistance rating requirments for building elements		APPLICABLE STANDARDS						
		BUILDING ELEMENT FIRE RATING *			ANSI ICC A117.1 - 2009 2010 ADA STANDARDS FOR ACCESSIBLE DESIGN - TITLE II				
	PRIMARY STRUCTURAL FRAME BEARING WALLS	PRIMARY STRUCTURAL FRAME 0 HOUR BEARING WALLS			SECTION 504 FAIR HOUSING ACCESSIBILITY GUIDELINES				
	EXTERIOR 0 HOUR INTERIOR 0 HOUR			FHA SAFE HARBOR DESIGN DOCUMENT: IBC 2018 OHCS CORE DEVELOPMENT MANUAL					
		NON BEARING WALLS AND PARTITIONS - EXTERIOR PER TABLE 602 NON BEARING WALLS AND PARTITIONS - INTERIOR 0 HOUR							
		FLOOR CONSTRUCTION AND SECONDARY MEMBERS 0 HOUR ROOF CONSTRUCTION AND SECONDARY MEMBERS 0 HOUR		5% OF UNITS WITH MOBILITY FEATURES 184 x 5% = 10 UNITS 2% OF UNITS WITH COMMUNICATION FEATURES 184 x 2% = 4 UNITS					
	* UNLESS OTHERWISE REQUIRED B	Y THIS CODE		CHAPTER 13: ENERGY E	FFICIENCY 2021 OREGON I	ENERGY EFFICIENCY SPEC	CIALTY CODE (OEES	 3C)	
TABLE 602	FIRE RESISTANCE RATING REQUIRMS	ENTS FOR EXTERIOR WALLS BASED ON FIRE SE	EPARATION DISTANCE	CLIMATE ZONE 4C			(-		
	FIRE SEPARATI			OPAQUE ELEMENTS	ASSEMBLY MAX.	REQUIRED MIN. R-VALUE	PROV	VIDED	
	X < 5' 5' <= X < 10'	1 HOUR 1 HOUR		ROOFS INSULATION ENTIRELY ABOV					
	10' <= X < 30' X >= 30'	0 HOUR 0 HOUR		DECK METAL BUILDINGS	VE N/A	N/A N/A			
				ATTIC AND OTHER WALLS (ABOVE GRADE)	U-0.021	R-49	R	R-49	
CHAPTER 7: FIRE AND	SMOKE PROTECTION FEATURES	3		MASS METAL BUILDINGS	U-0.090 N/A	R-11.4 CI N/A			
TABLE 705.2	MINIMUM DISTANCE OF PROJECTION	40 INCHES		STEEL-FRAMED WOOD-FRAMED / OTHER	N/A U-0.064	N/A N/A R-13 + 3.8 CI OR R-20	R	R-23	
TABLE 705.8	MAXIMUM AREA OF WALL OPENINGS	BASED ON FSD AND OPENING PROTECTION	PD0750750	WALLS (BELOW GRADE) FLOORS	C-0.092	R-10 CI			
	0 TO LESS THAN 3'	UNPROTECTED, NON-SPRINKLERED NOT PERMITTED	PROTECTED NOT PERMITTED	MASS STEEL JOIST	N/A N/A	N/A N/A			
	3 TO LESS THAN 5' 5 TO LESS THAN 10'	NOT PERMITTED 10%	15% 25%	WOOD FRAMED / OTHER SLAB-ON-GRADE FLOORS	U-0.033	R-30	R	R-30	
	10 TO LESS THAN 15' 15 TO LESS THAN 20'	15% 25%	45% 75%	HEATED UNHEATED	N/A F-0.520	N/A R-15 FOR 24"	R-15 F	FOR 24"	
	20 TO LESS THAN 25' 25 TO LESS THAN 30' 30' OR GREATER	45% 70% NO LIMIT	NO LIMIT NO LIMIT NO LIMIT	OPAQUE DOORS SWINGING	U-0.370		<u>'</u>).370	
705.8.1	30' OR GREATER ALLOWABLE AREA OF OPENINGS	NO LIMIT EXCEPTION 2: BUILDINGS WHOSE EXTERIO		NON-SWINGING	N/A				
. 50.0.1	. LLOW DEL ANEA OF OPENINGS	EXTERIOR NONBEARING WALLS AND EXTE STRUCTURAL FRAME ARE NOT REQUIRED	ERIOR PRIMARY) TO BE FIRE-RESISTANCE	FENESTRATION	MAX U MAX SH		PROVIDED (U MAX SHGC	MIN VTI/SHO	
		RATED SHALL BE PERMITTED TO HAVE UN OPENINGS.	NLIIVII I EU UNPKOTECTED	VERTICAL (0% - 40% OF WALL A	U-0.36 0.36			1.10	
705.11	PARAPETS	EXCEPTION 1: WALL NOT REQUIRED TO BE FIRE-RESISTATE ACCORDANCE WITH TABLE 602 RECAUSE		OPERABLE ENTRANCE DOOR	U-0.45 0.33 U-0.63 0.33			1.10 1.10	
		ACCORDANCE WITH TABLE 602 BECAUSE ODISTANCE.	OF PIRE SEPAKATION	SKYLIGHT (0% - 3% OF ROOF AI	LLOWED)		I	<u> </u>	
TABLE 706.4	FIRE WALL FIRE RESISTANCE	N/A		CI = CONTINUOUS INSULATION FC = FILLED CAVITY	1	ı	1	1	
TABLE 707.3.10	FIRE BARRIER ASSEMBLIES AND HORIZONTAL ASSEMBLIES BTWN FIRE AREAS	1 HOUR, INTERIOR EXIT STAIR LESS THAN	4 STORIES	NR = NO REQUIREMENT NA = NOT APPLICABLE					
SECTION 708	FIRE PARTITIONS	1 HOUR 1/2 HOUR AT GROUP R-2 CORRIDORS PER	R TABLE 1020 1						
SECTION 709	SMOKE BARRIERS	NOT REQUIRED		CHAPTER 29: PLUMBING FIXTURES					
SECTION 711	FLOOR AND ROOF ASSEMBLIES			R-2	TOTAL UNITS 24 1 \	WC / LAV / Tub or Shower per unit requ	uired and provided		
	SUPPORTING CONSTRUCTION PER 7								
711.2.4.1 711.2.4.2	SEPARATING MIXED OCCUPANCIES SEPARATING FIRE AREAS	N/A N/A							
711.2.4.3 711.2.4.4	DWELLING / SLEEPING UNITS SEPARATING SMOKE COMPARTMENT								
711.2.4.5 711.2.4.6	SEPARATING INCIDENTAL USES OTHER SEPARATIONS	PER TABLE 509 N/A							
SECTION 713	SHAFT ENCLOSURES	NOT LESS THAN 1 HOUR CONNECTING LES	SS THAN 4 STORIES			EXIT ACCES	SS TRAVEL DISTANC	 CE	
	OHALI LNOLUGURES	NOT LESS THAN 1 HOUR CONNECTING LES				EGRESS PATH NAME FIRST FLOOR	EGRESS PAT	H LENGTH	
	FINISHES					SECOND FLOOR THIRD FLOOR	76' - 6 120' -	6"	
CHAPTER 8: INTERIOR	RIOR WALL AND CEILING FNIISH REQUIREME	ENTS (FLAME SPREAD RATING)							
					LIFE	SAFETY OCCUPANT LOAD	SCHEDULE		
INTER	RIOR EXIT STAIRWAYS AND RAMPS AND EXI					T		т —	
TABLE 803.13 INTER INTER CORR	RIOR EXIT STAIRWAYS AND RAMPS AND EXI RIDORS AND ENCLOSURES FOR EXIT ACCES MS AND ENCLOSED SPACES						1004.1.2	OCCI IPAI	
TABLE 803.13 INTER INTER CORR ROOM	RIDORS AND ENCLOSURES FOR EXIT ACCES AS AND ENCLOSED SPACES					FUNCTION OF SPACE	1004.1.2 OCCUPANT LOAD FACTOR	OCCUPAI LOAD	
TABLE 803.13 INTER INTER CORR ROOM CHAPTER 9: FIRE PRO	RIDORS AND ENCLOSURES FOR EXIT ACCES AS AND ENCLOSED SPACES			_	FIRST FLOOR 723 SECOND FLOOR 747	FUNCTION OF	1004.1.2 OCCUPANT		



702.020 MULTIPLE FAMILY DESIGN REVIEW STANDARDS

SECTION	REQUIRMENT MET OR ADJUSTMENT REQUESTED	SHEET NUMBER			
SITE SAFETY & SECURITY					
702.020.c.1	REQUIREMENT MET	A2.11-A2.12			
702.020.c.2	REQUIREMENT MET	A3.01-A3.02			
FACADE & BUILDING DESIGN					
702.020.e.1	REQUIREMENT MET	A2.11-A2.12			
702.020.e.8	ADJUSTMENT REQUESTED	A3.01-A3.02			
702.020.e.9	REQUIREMENT MET	A2.11-A2.12, A3.01			
702.020.e.10	REQUIREMENT MET	A3.01-A3.02			

CODE SUMMARY LEGEND

OBJECT ABOVE

ALL DOORS, RELITES, ETC.

FEC or FE

WALL RATINGS TO CONTINUE ABOVE / BELOW

OCCUPANCY (CH. 3)

#SF
OLF #
Function

OCCUPANCY (CH. 3)

AREA (SF)
OCCUPANT LOAD FACTOR /
NUMBER OF OCCUPANTS

TOTALS

- FUNCTION (CH. 10)

UNOCCUPIED AREA. OCCUPANT LOAD NOT INCLUDED IN BUILDING

EXIT ACCESS PATH

EXIT ACCESS DOOR

DOOR RATING (IN MINUTES)

MULTI-PURPOSE FIRE
EXTINGUISHER AND CABINET
(FEC) OR FIRE EXTINGUISHER
(FE) ON BRACKET. VERIFY
EXACT LOCATIONS AND
QUANTITY WITH FIRE
DEPARTMENT.

SHADE INDICATES ILLUMINATE FACE. ARROW INDICATES DIRECTION TO EXIT

1 HOUR RATED ASSEMBLY

SITE PLAN - ZONING DIAGRAM




2525 E Burnside Street, Portland, OR 97214 phone: (503) 226-3617 www.seallp.com

CDP SALEM -


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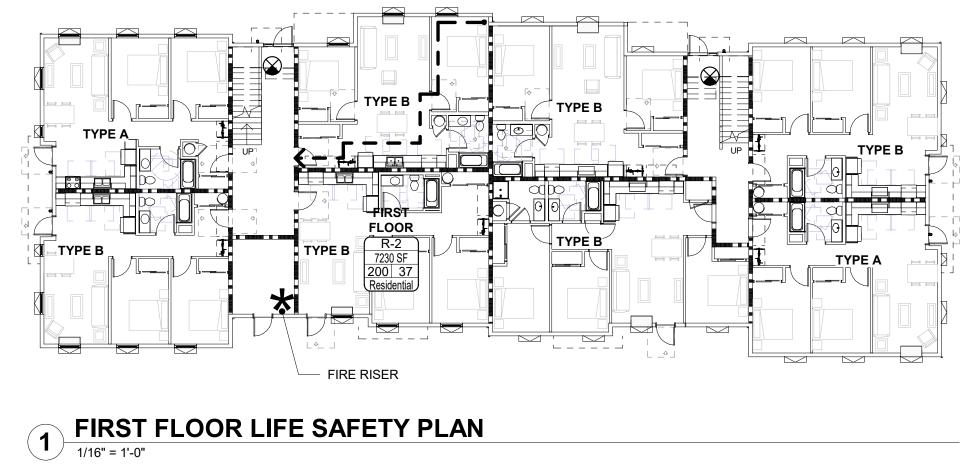
Job Number:



3 THIRD FLOOR LIFE SAFETY PLAN 1/16" = 1'-0"

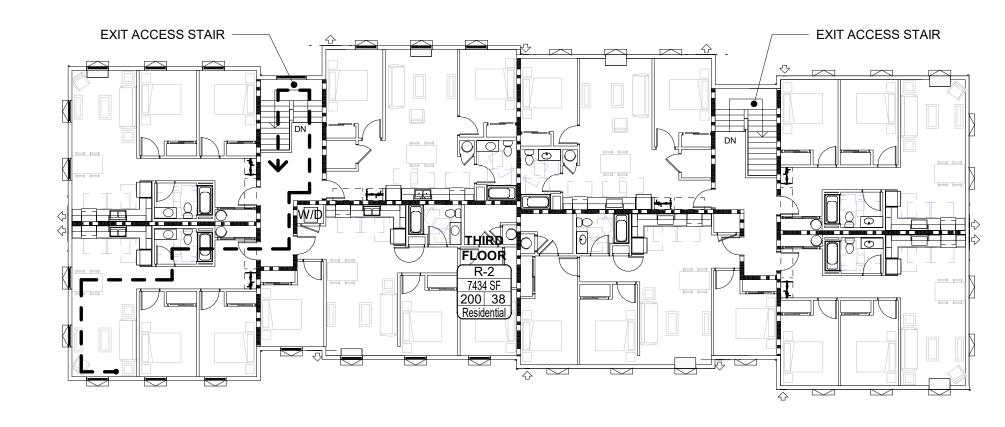



2 SECOND FLOOR LIFE SAFETY PLAN 1/16" = 1'-0"

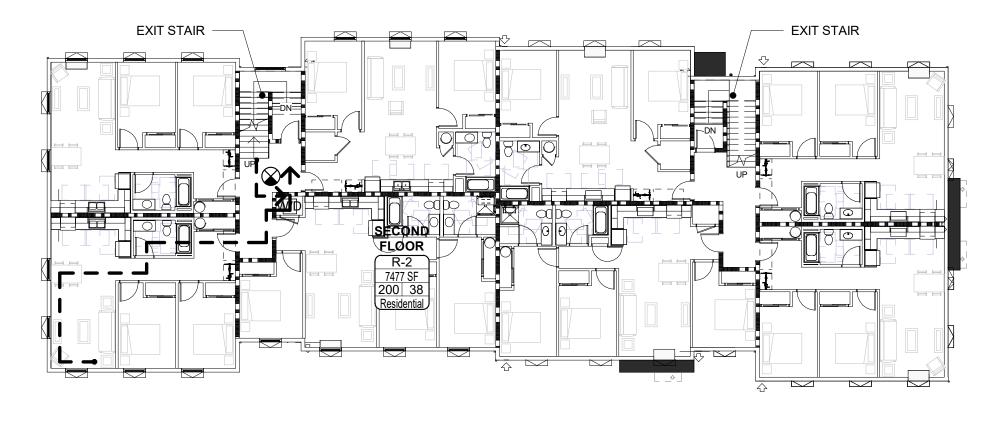

03.11.2022 LAND USE SUBMISSION DATE ISSUE Drawing:

CODE SUMMARY

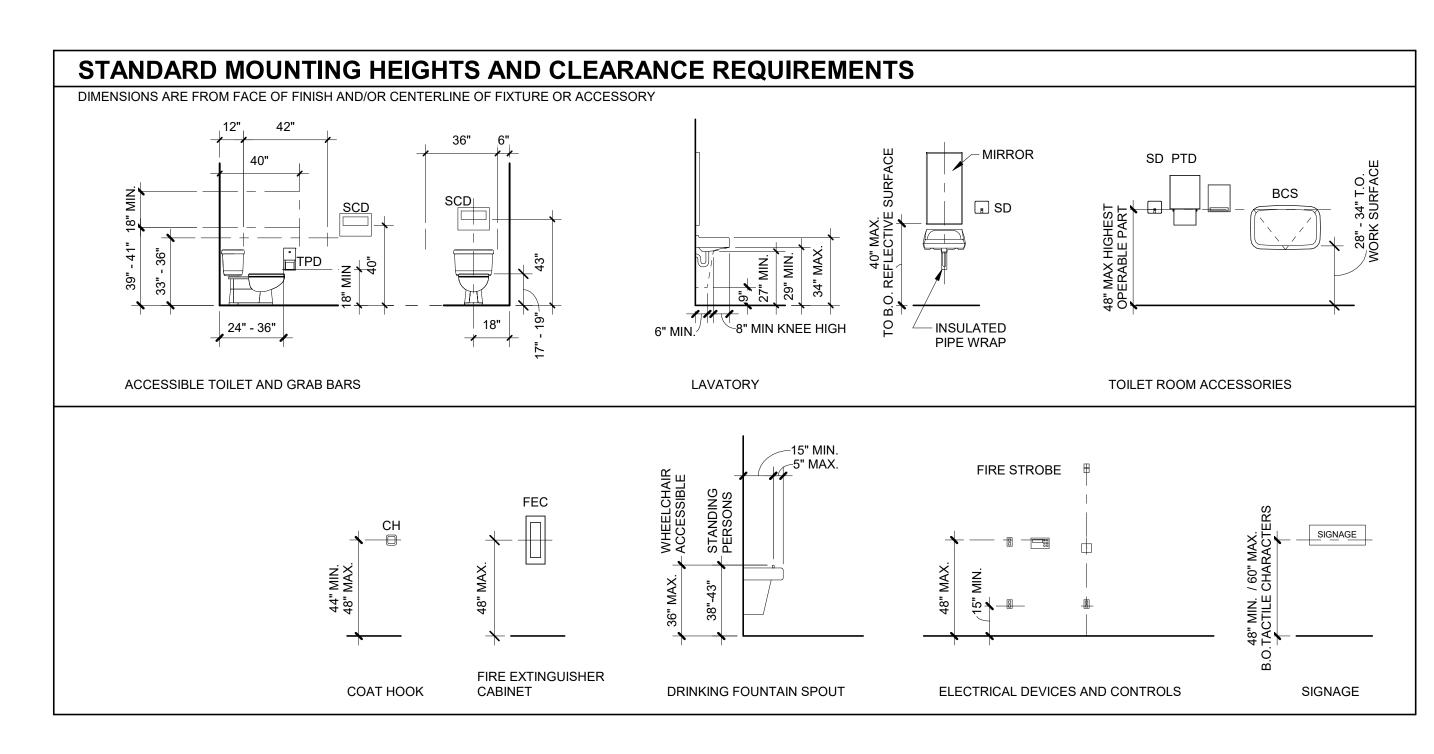

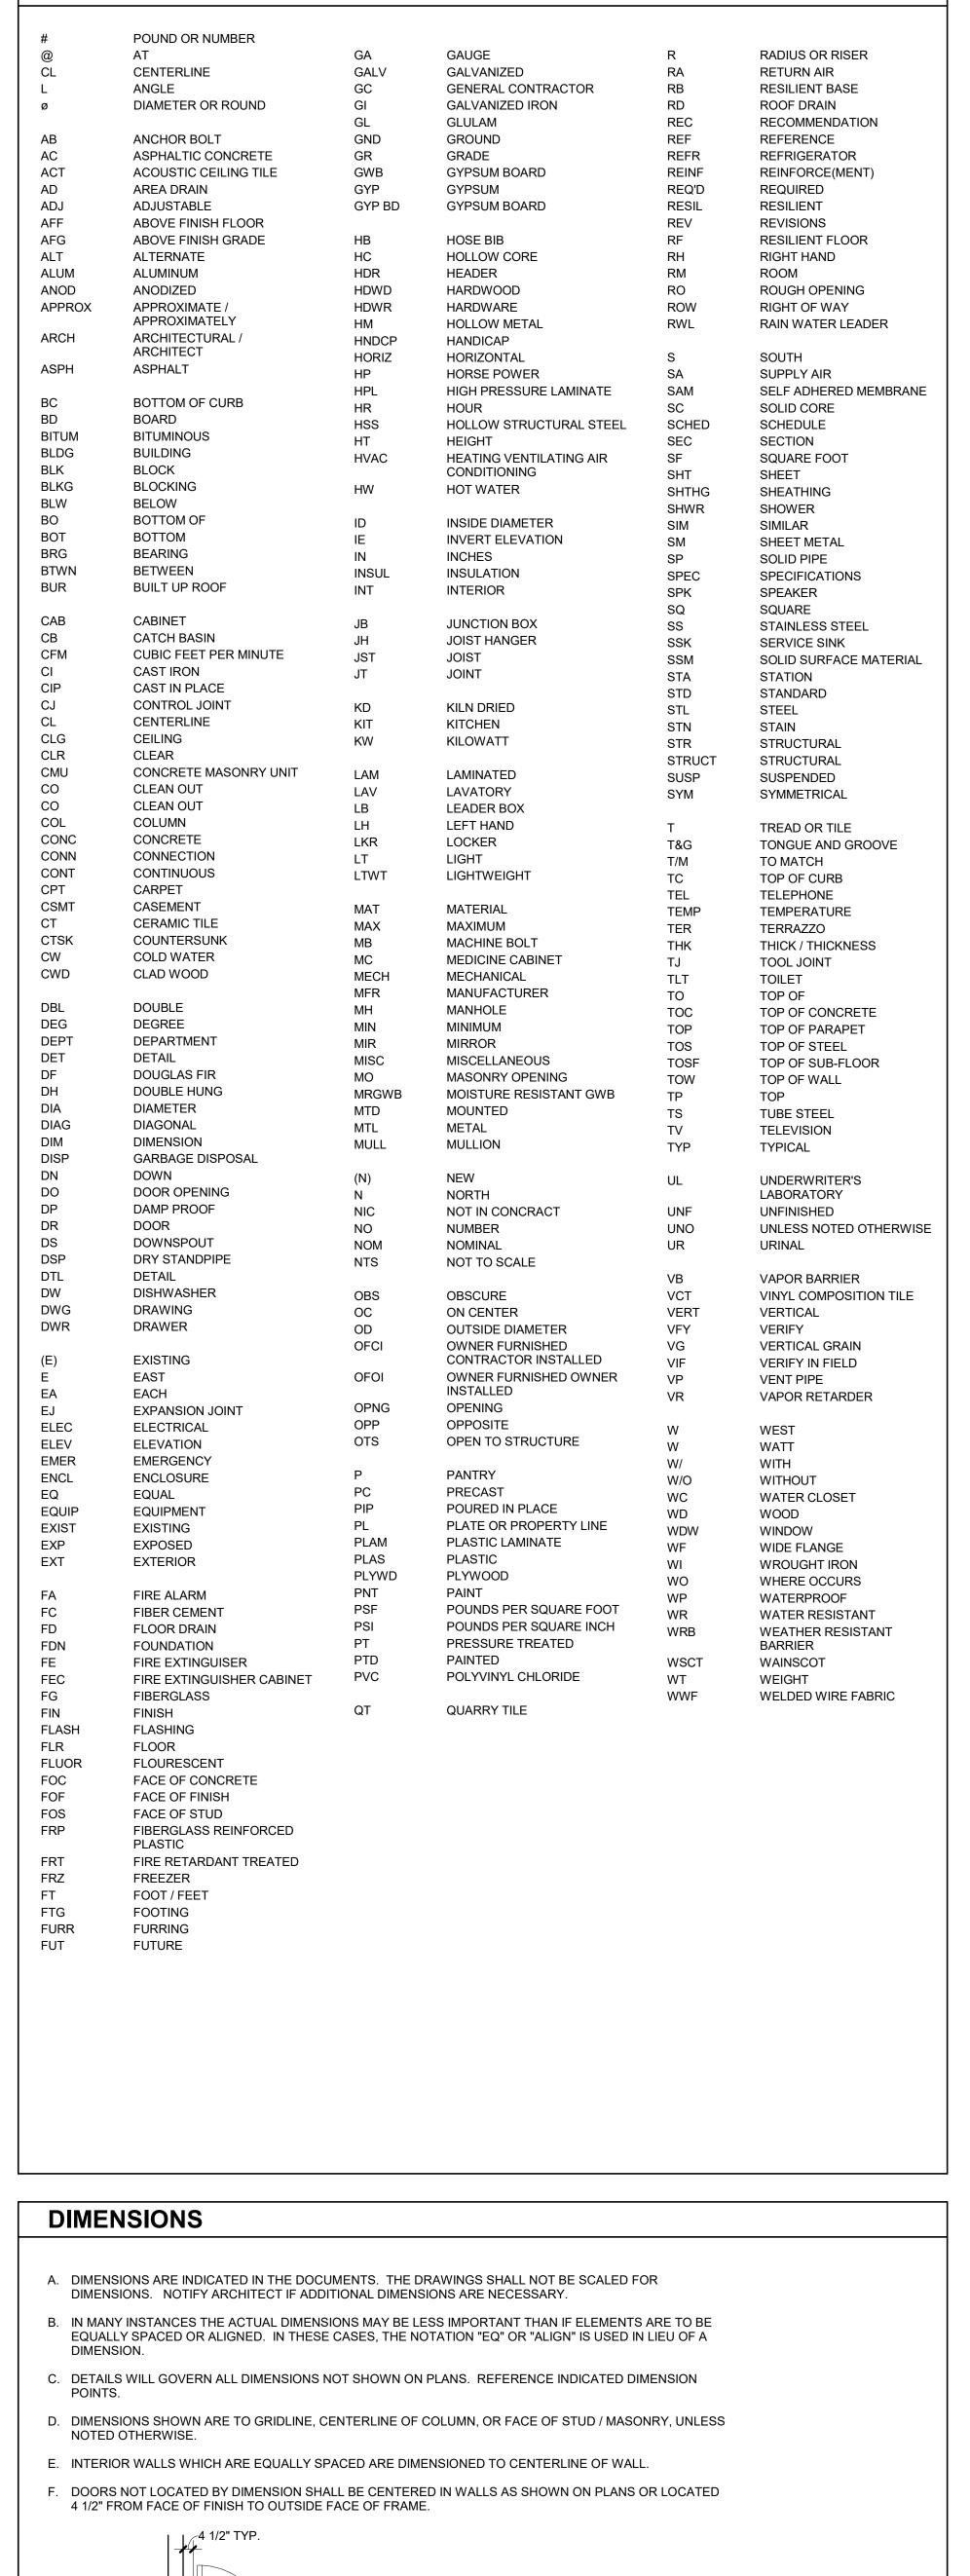

ABBREVIATIONS



CDP SALEM -**BUILDING B**

Development

Partners

5205 BATTLE CREEK RD SE SALEM, OR 97306

Job Number:

101

(1)— - — - —

GRAPHIC SYMBOLS

NORTH

VERTICAL DATUM NAME_ ELEVATION - -

NORTH ARROW

GRID LINE

ROOM NAME AND NUMBER NAME

EXTERIOR ELEVATION

- DRAWING NUMBER - SHEET NUMBER

BUILDING SECTION / WALL SECTION

- DRAWING NUMBER — SHEET NUMBER

INTERIOR ELEVATION

→ DRAWING NUMBER — SHEET NUMBER DETAIL CALLOUT

- DRAWING NUMBER - SHEET NUMBER DOOR NUMBER

- ROOM NUMBER — DOOR (101A)--CEILING HEIGHT - CEILING HEIGHT ABOVE LEVEL - ACCENT PAINT **COLOR WHERE** OCCURS WALL / ASSEMBLY TYPE

IW2-4 - MODIFIERS FLOOR / FLOOR-CEILING ASSEMBLY [F-#] CEILING ASSEMBLY [C-#] ROOF / ROOF-CEILING ASSEMBLY [R-#]

- CONFIGURATION

— WALL TYPE

- ASSEMBLY CATEGORY — ASSEMBLY NUMBER WINDOW TYPE

ACCESSORY / EQUIPMENT TYPE

1 CASEWORK TYPE

MATERIAL / FINISH - MATERIAL TYPE - MATERIAL NUMBER

SPOT ELEVATION

X'-X" ── HEIGHT ABOVE LEVEL X'-X" TC ─ TOP OF CURB HEIGHT X'-X" BC
 BOTTOM OF CURB

KEYNOTE - SPECIFICATION REVISION

DIVISION NUMBER NOTE NUMBER REVISION NUMBER

- REVISION DOCUMENT

Sheet No: Building B -

03.11.2022

DATE

SE DRAWINGS ARE THE ORIGINAL THE ARCHITECT AND MAY NOT BE HOUT THE WRITTEN CONSENT OF

ARCHITECTURAL

GENERAL NOTES


AND DIAGRAMS


LAND USE

ISSUE


Drawing:

SUBMISSION

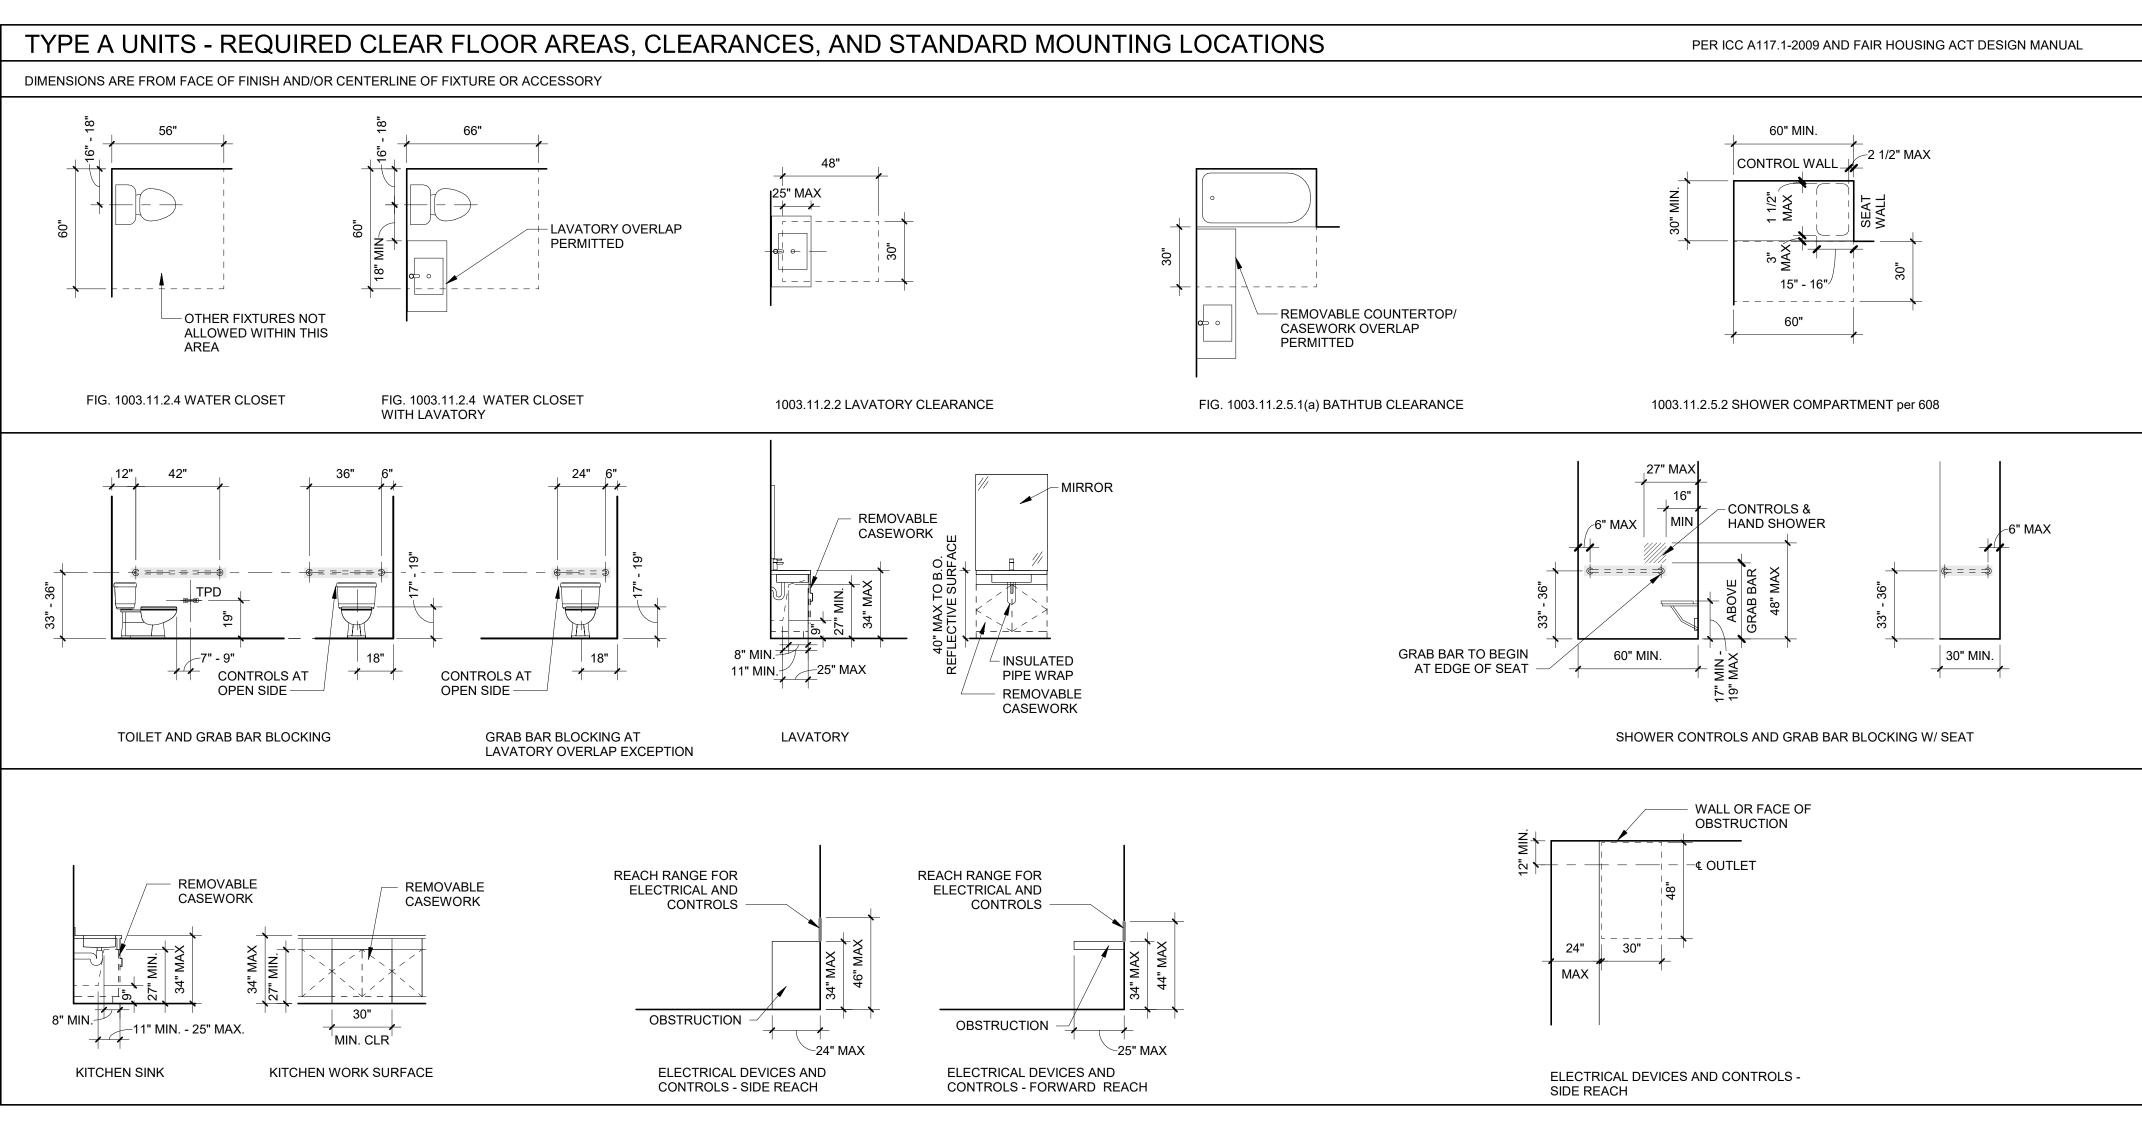

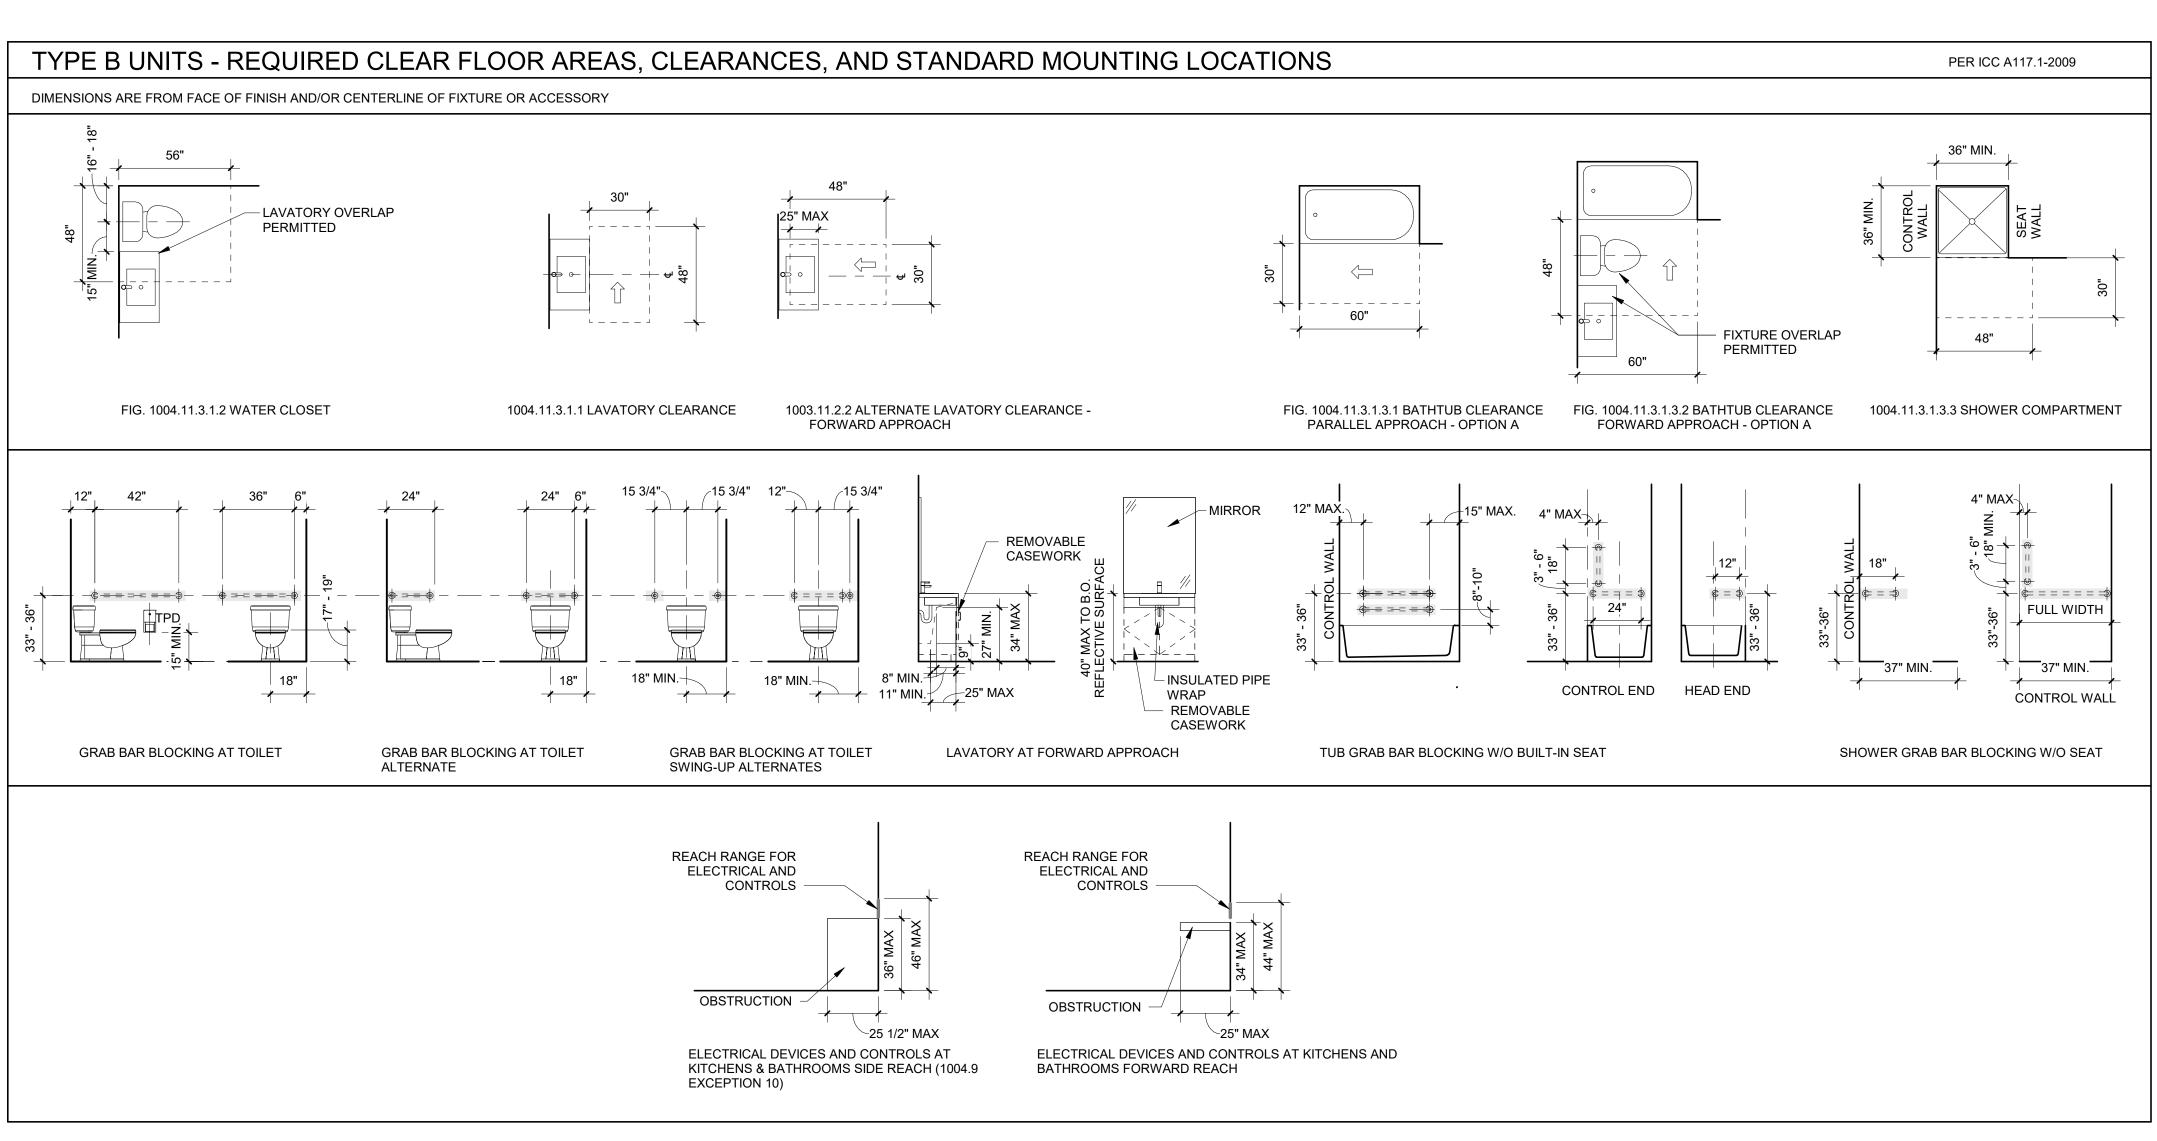

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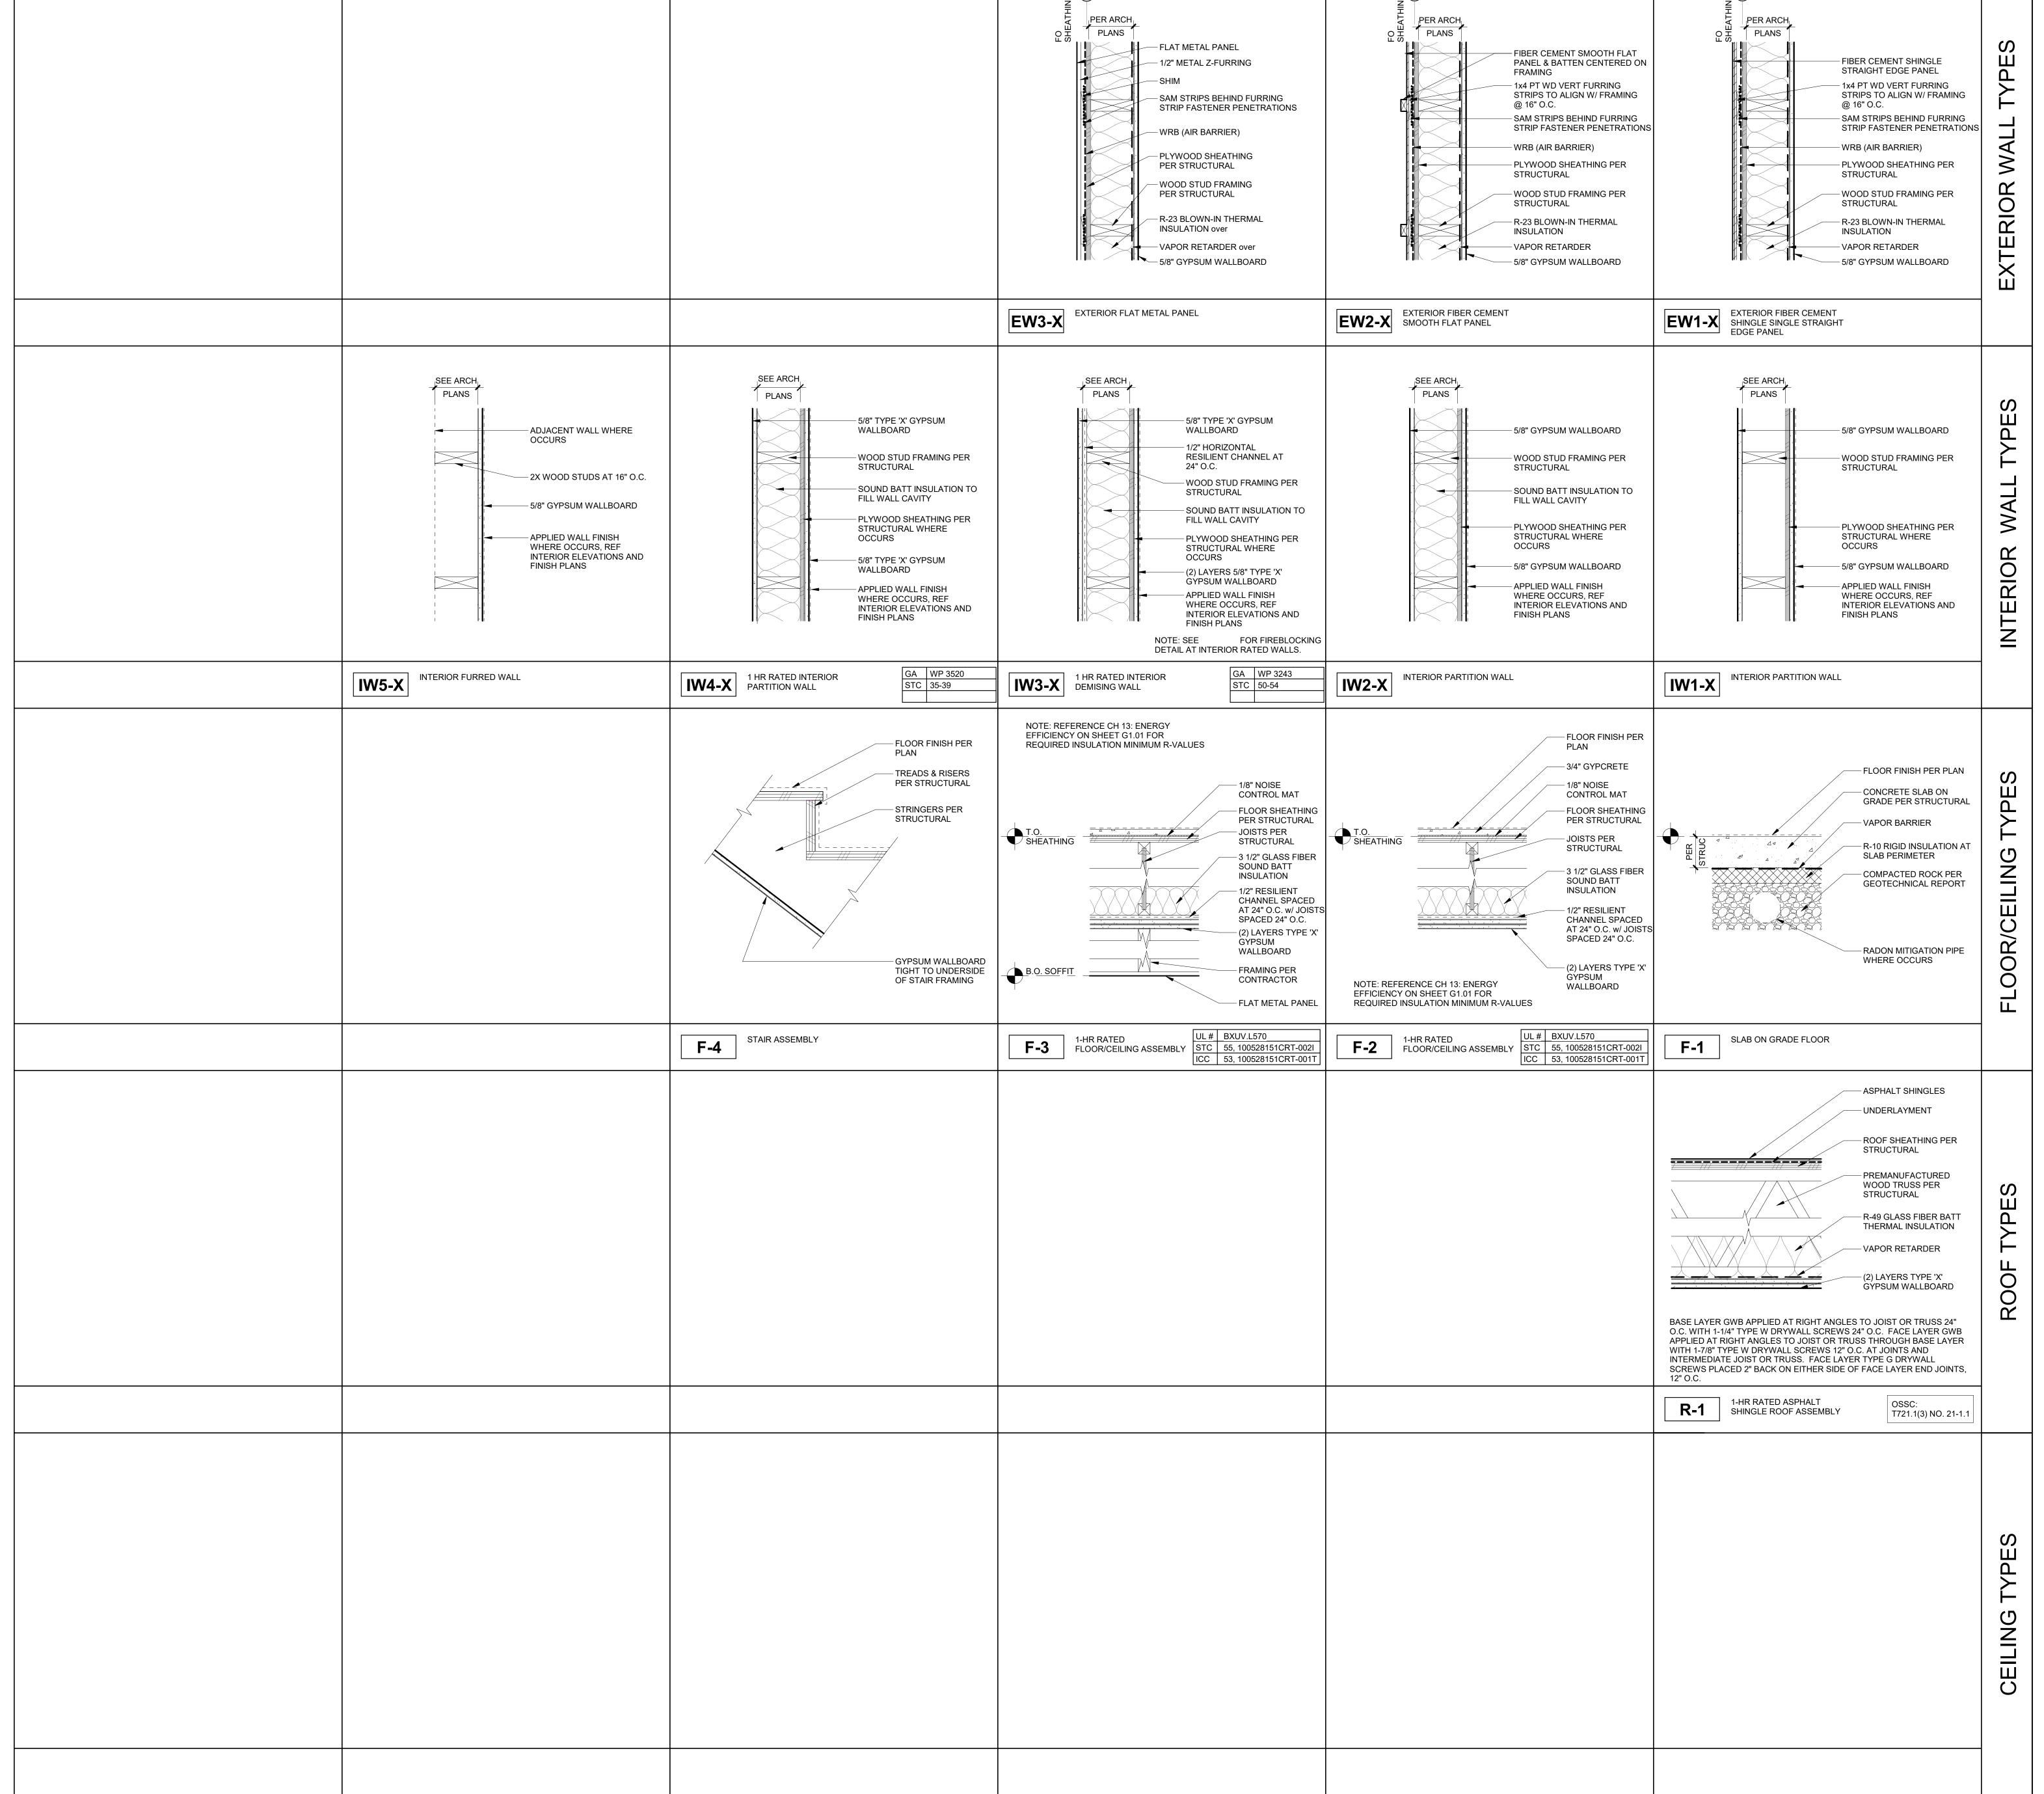
CDP SALEM -BUILDING B 21031 Job Number: **5205 BATTLE CREEK RD SE SALEM, OR 97306**

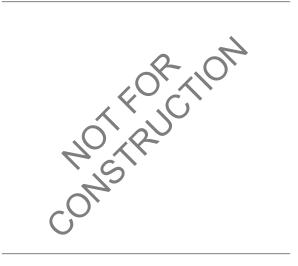

LAND USE SUBMISSION 03.11.2022 ISSUE DATE Drawing: **ACCESSIBILITY DIAGRAMS** -


Sheet No: Building B -

RESIDENTIAL



GENERAL SHEET NOTES

- A. REFERENCE DETAILS FOR ASSEMBLIES NOT SHOWN HERE.
- B. SEE FINISH SCHEDULE, INTERIOR ELEVATIONS, AND DETAILS FOR SPECIAL CONDITIONS AND APPLIED WALL FINISHES.
- MAINTAIN FIRE RATING OF WALLS AROUND FIRE EXTINGUISHERS, CABINETS, AND OTHER RECESSED ITEMS. PROVIDE ACOUSTICAL SEALANT AT FLOOR /
- CEILING/ WALL TRANSITIONS, RECESSED BOXES, AND PENETRATIONS OF SOUND RATED ASSEMBLIES AND OTHER CONSTRUCTION AS REQUIRED TO ACHIEVE NOTED STC RATINGS.
- PROVIDE MOISTURE RESISTANT GYPSUM BOARD TYPICAL AT ALL RESTROOMS, BATHROOMS, AND KITCHEN WALLS. . ALL FRAMING AND FINISHES OF INTERIOR WALLS
- TO EXTEND TO THE UNDERSIDE OF STRUCTURE ABOVE UNLESS NOTED OTHERWISE. 6. WHERE PARTITIONS ARE SOUND RATED OR FIRE RATED AND INCLUDE PROPRIETARY MANUFACTURERS, NO SUBSTITUTIONS ARE ALLOWED. H. ALL WOOD IN CONTACT WITH CONCRETE OR
- MASONRY TO BE PRESSURE TREATED. PROVIDE DEFLECTION HEADS OR CLIPS AT ALL NON-LOAD BEARING CONDITIONS. . FOR TYPICAL LIGHT GAUGE METAL FRAMING DETAILS SEE X/XX.

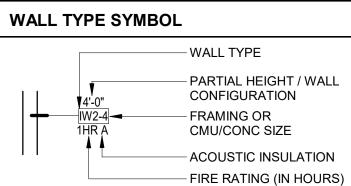




WOOD FRAMING SIZES 0 = MTL FURRING, 7/8" OR AS INDICATED $4 = 2" \times 4"$ 6 = 2" x 6"

WALL CONFIGURATION

 $8 = 2" \times 8"$

STRUCTURE

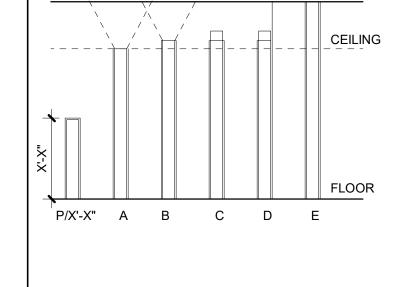

- P PARTIAL HEIGHT WALL, SEE ELEVATIONS OR SECTIONS
- X'-X" HEIGHT AS INDICATED TO TOP OF FINISH A FRAMING AND FINISHES TERMINATE AT
- UNDERSIDE OF CEILING. BRACE AS REQUIRED. FRAMING AND FINISHES TERMINATE 4" ABOVE
- FRAMING EXTENDS TO BOTTOM OF STRUCTURE. FINISHES TERMINATE AT 4" ABOVE FINISHED CEILING. FRAMING AND FINISH ONE SIDE OF WALL

FINISHED CEILING. BRACE AS REQUIRED.

EXTEND TO BOTTOM OF STRUCTURE. FINISH OTHER SIDE TERMINATES AT 4" ABOVE FINISHED CEILING.


FRAMING AND FINISHES BOTH SIDE EXTEND TO UNDERSIDE OF STRUCTURE ABOVE.

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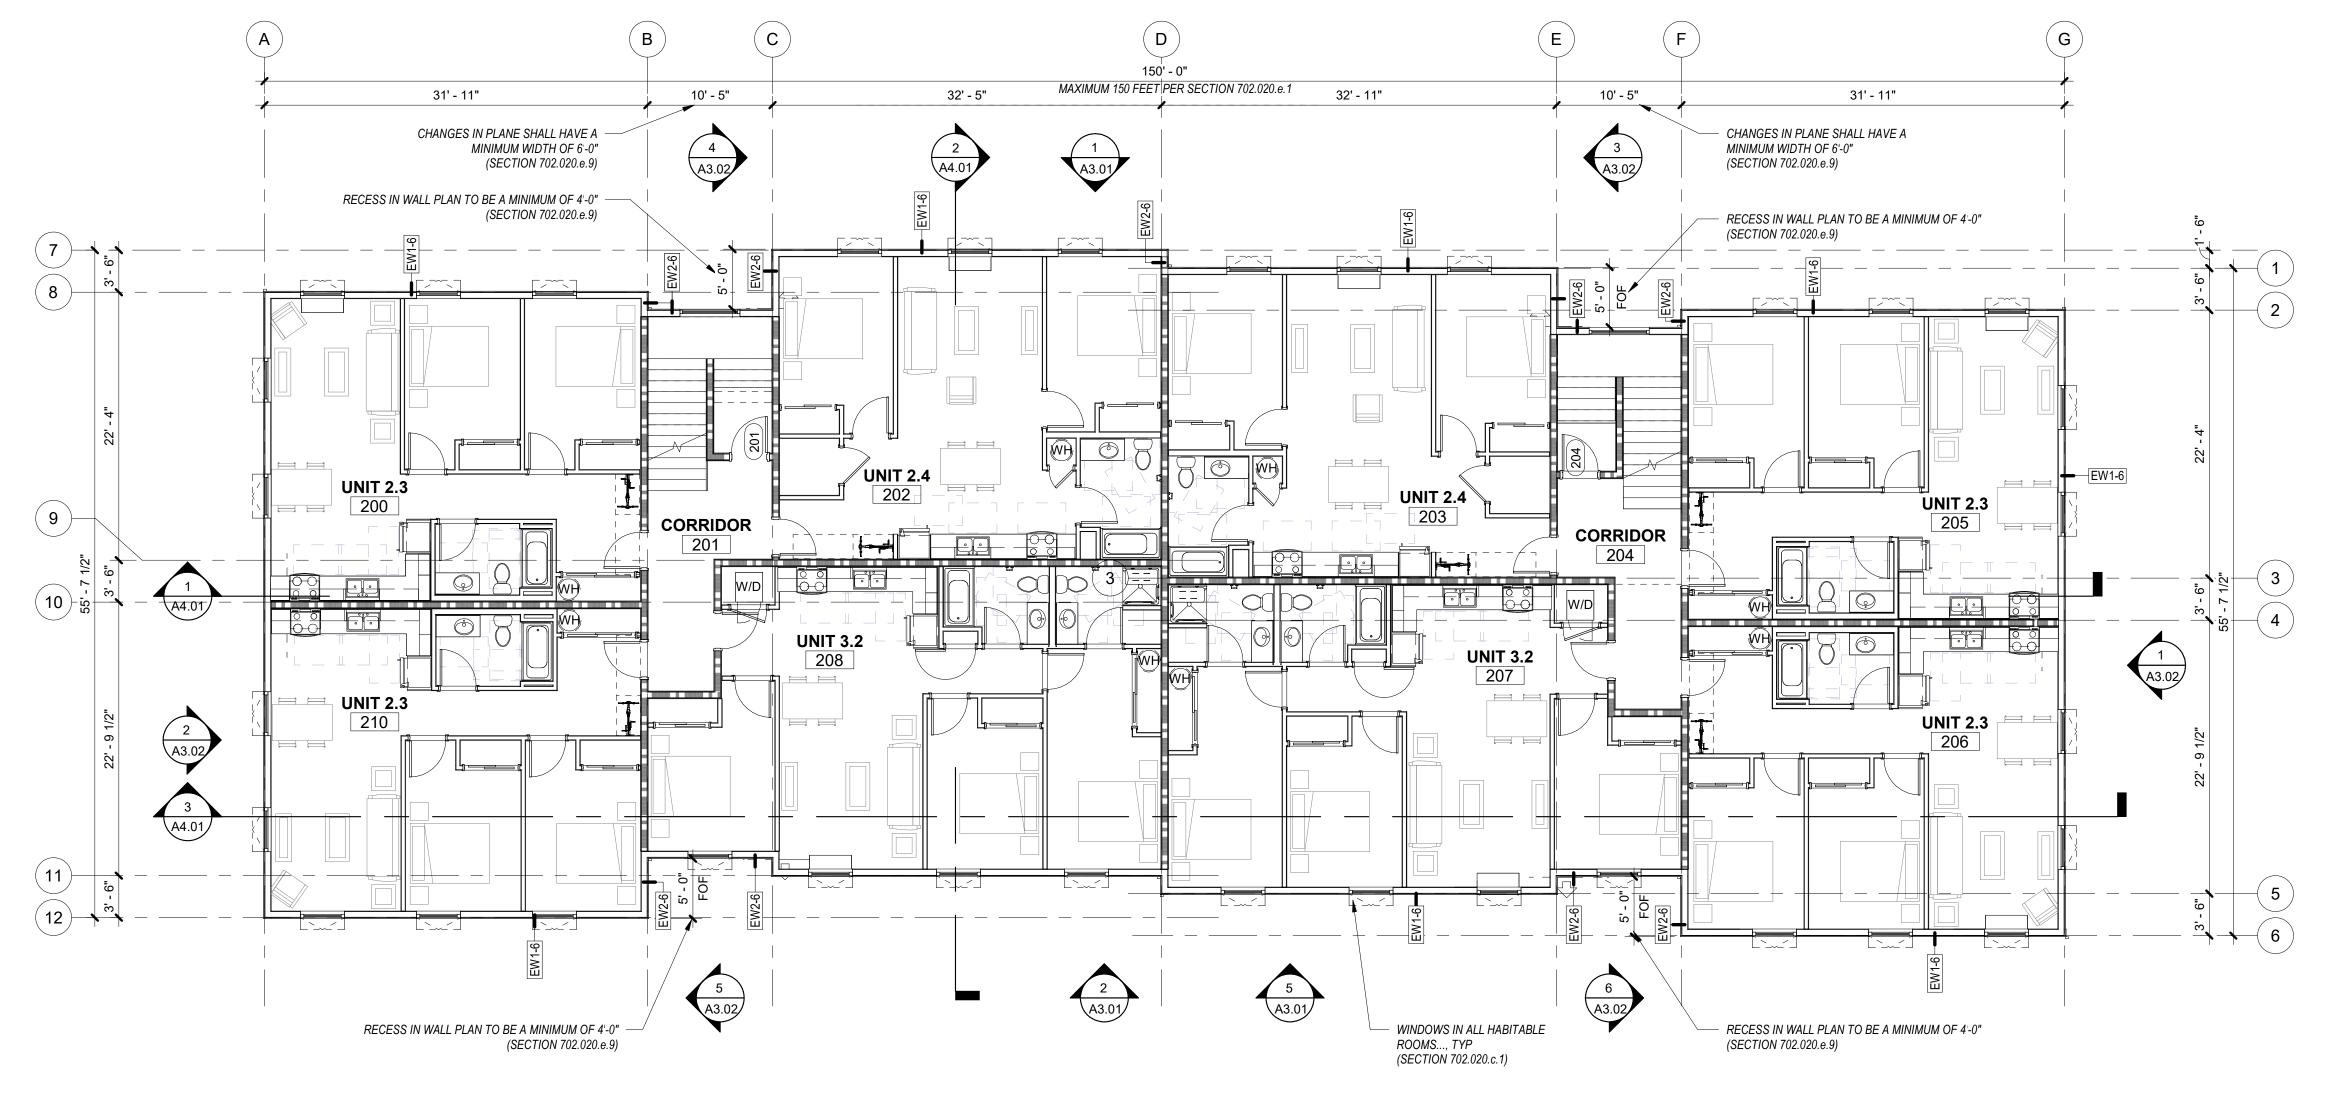
5205 BATTLE CREEK RD SE SALEM, OR 97306



LAND USE


Drawing: **ASSEMBLIES** 03.11.2022

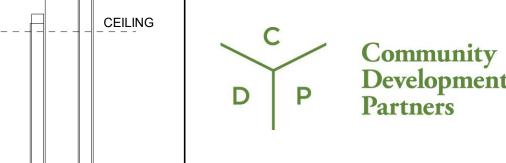DATE



PLOOR PLAN - LEVEL 2

1/8" = 1'-0"

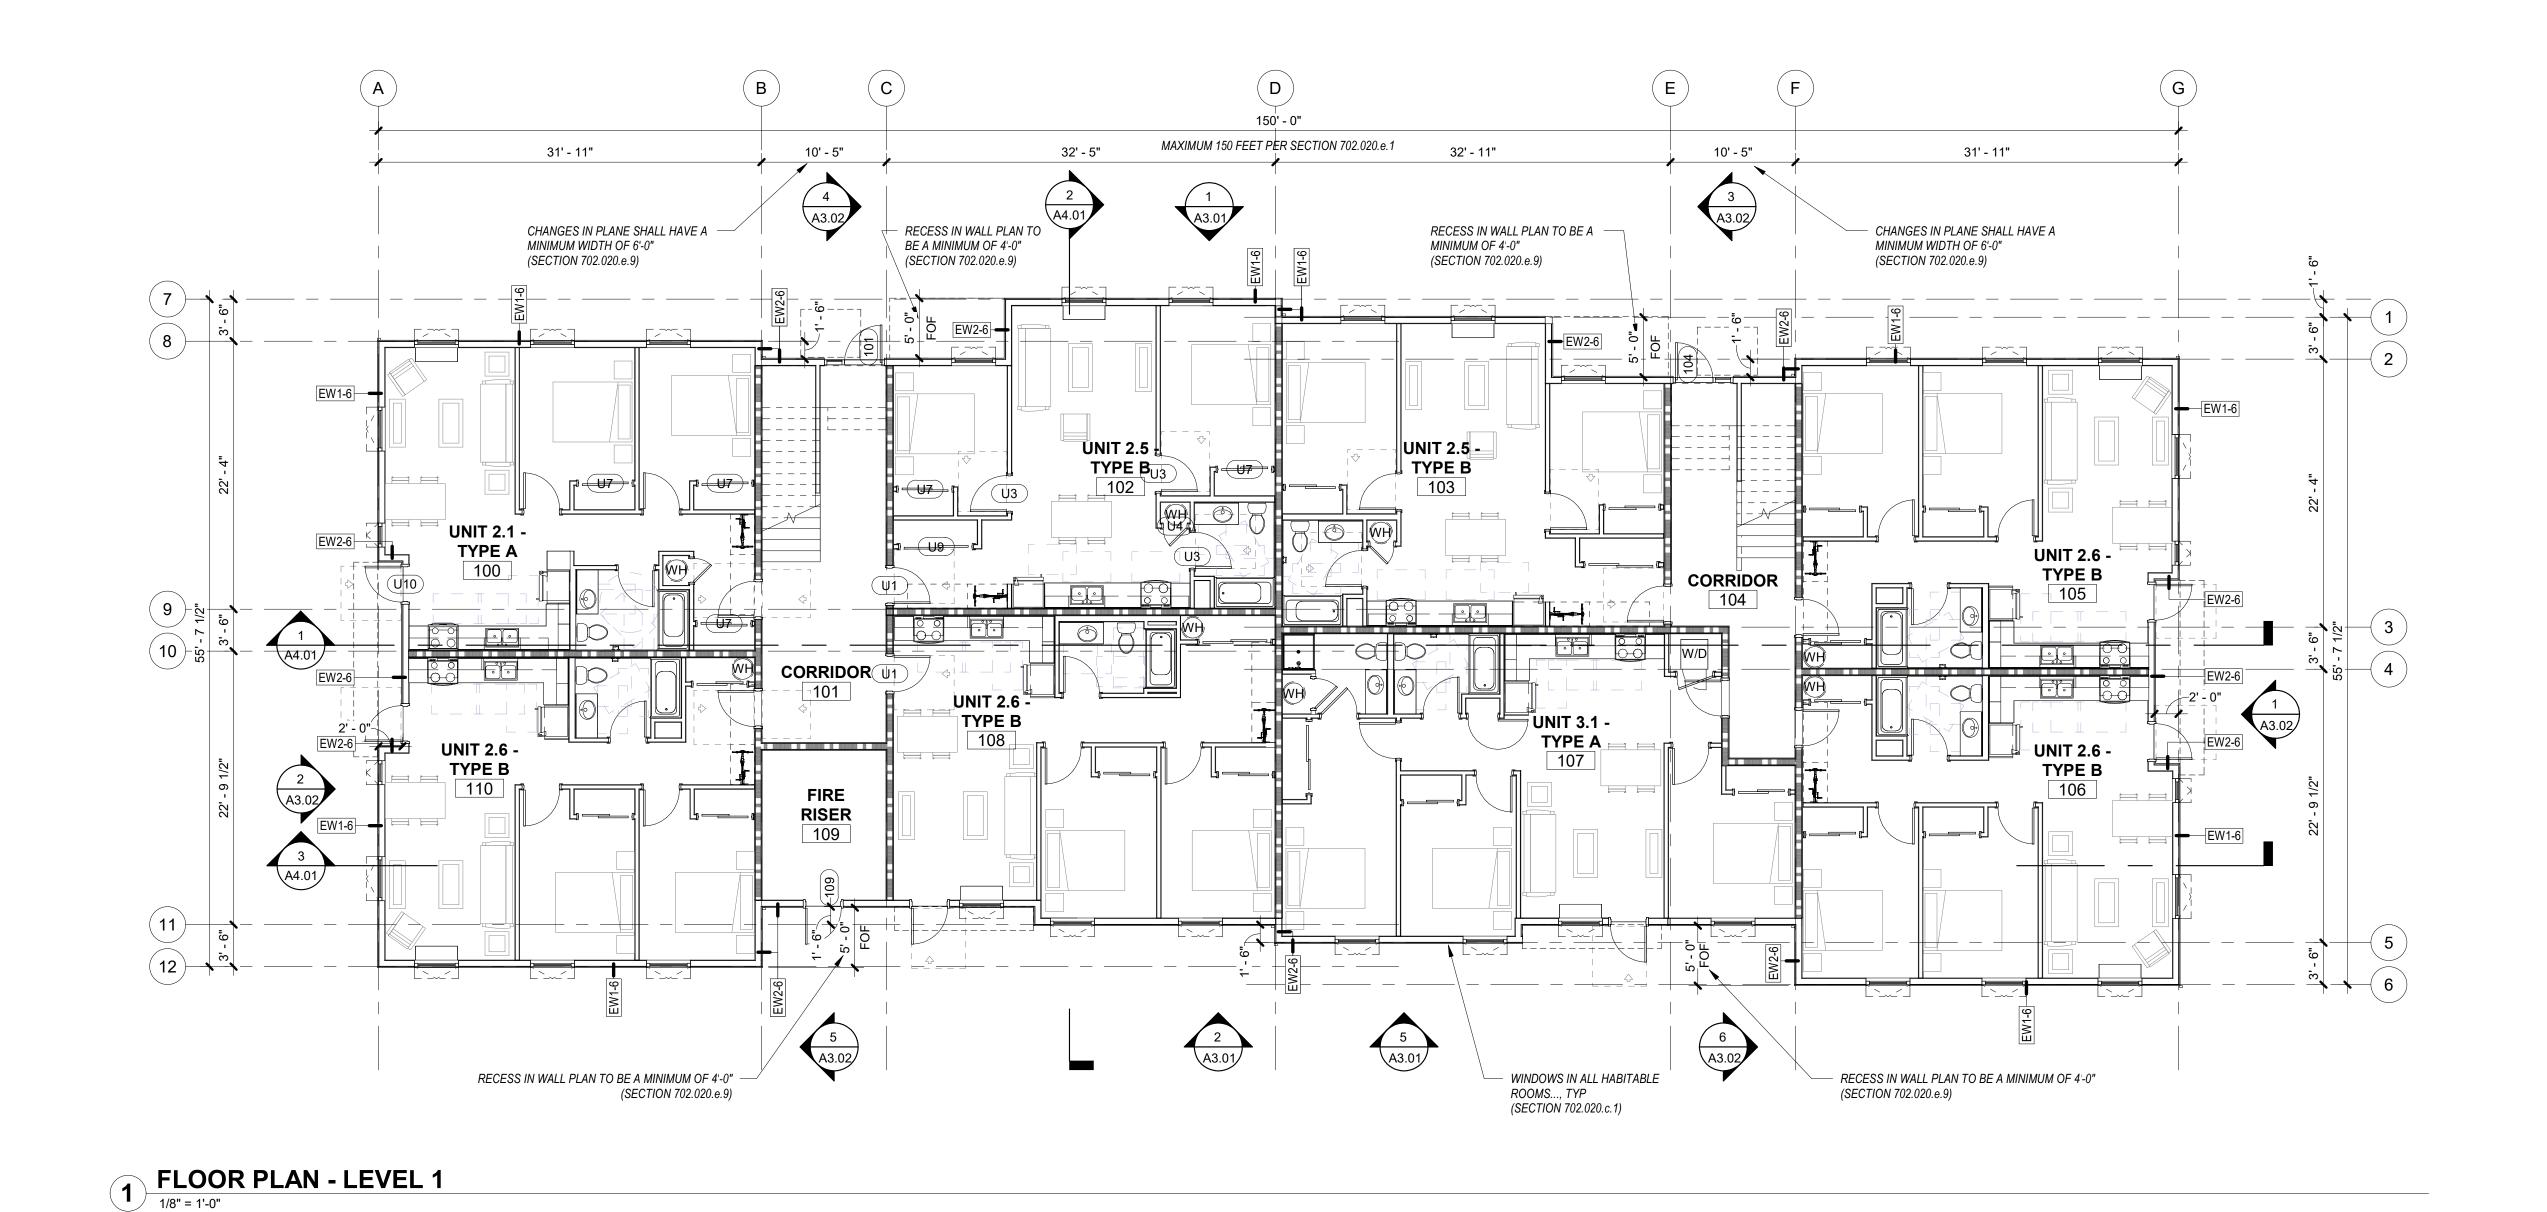

GENERAL SHEET NOTES A. WALL DIMENSIONS ARE FROM FACE OF STUD OR CL OF COLUMN U.N.O. B. ALL EXTERIOR GRID LINES SHOWN ARE TO FACE OF SHEATHING U.N.O. ALL INTERIOR GRID LINES ARE TO FACE OF STUD U.N.O.

DOOR AND WINDOW TYPES

WITH FLOOR FINISHES

DOOR NUMBERS

PENETRATIONS

LEGEND

⊕ FD

KEYNOTES (07-02)

DIAGRAMS FOR LOCATIONS

D. REFERENCE STRUCTURAL DRAWINGS FOR

E. SEE DOOR SCHEDULE FOR DOOR TYPES AND

F. SEE WINDOW SCHEDULE FOR WINDOW TYPES

G. FOR FLOOR FINISHES, SEE FLOOR FINISH PLAN

H. WIRE SHELVING IN ALL BEDROOM CLOSETS I. M.E.P. INFORMATION PROVIDED FOR REFERENCE

ONLY. CONTRACTOR TO COORDINATE ALL LOCATIONS OF EQUIPMENT AND REQUIRED

PROVIDE BLOCKING FOR FUTURE GRAB BARS AT ALL UNIT RESTROOMS WHERE GRAB BARS ARE NOT SHOWN IN PLAN, REF ACCESSIBILITY

K. FIRE EXTINGUISHER TO BE PLACED IN PANTRY IN ALL UNITS
L. CURTAIN RODS AT ALL BEDROOM CLOSETS ARE CFCI, IN LIEU OF DOORS. CURTAINS ARE OFOI. M. DOWNSPOUTS PAINTED IN FIELD, RECTANGLE SHAPE AND SIZE PER PLUMBING AND CIVIL

1 HOUR RATED ASSEMBLY

FLOOR DRAIN

R-1 ASPHALT SHINGLE ROOF

R-2 STANDING SEAM

METAL ROOF

PROVIDE FIRE-RETARDANT TREATED ROOF SHEATHING IN

WATER HEATER W FLOOR DRAIN BELOW - REF PLUMBING

OPERABLE WINDOW

AREA INDICATED

DOWNSPOUT

---- ELEMENT ABOVE

INSTALLATION DETAILS CORRESPONDING TO

C. ALL DOOR AND WINDOW DIMENSIONS ARE TO CL **SCOTT EDWARDS** ARCHITECTURE LLP. OR OVERALL UNIT. REFERENCE SCHEDULES AND 2525 E Burnside Street, Portland, OR 97214 phone: (503) 226-3617 www.seallp.com GENERAL CONTROL JOINTS @ SLAB. COORDINATE FINAL LOCATIONS WITH ARCHITECT COMPATIBILITY



CDP SALEM -BUILDING B

Job Number: 5205 BATTLE CREEK RD SE **SALEM, OR 97306**

Development Partners


LAND USE SUBMISSION

Drawing: FLOOR PLAN - LEVEL 1 & 2

03.11.2022

DATE

2 ROOF PLAN 1/8" = 1'-0"

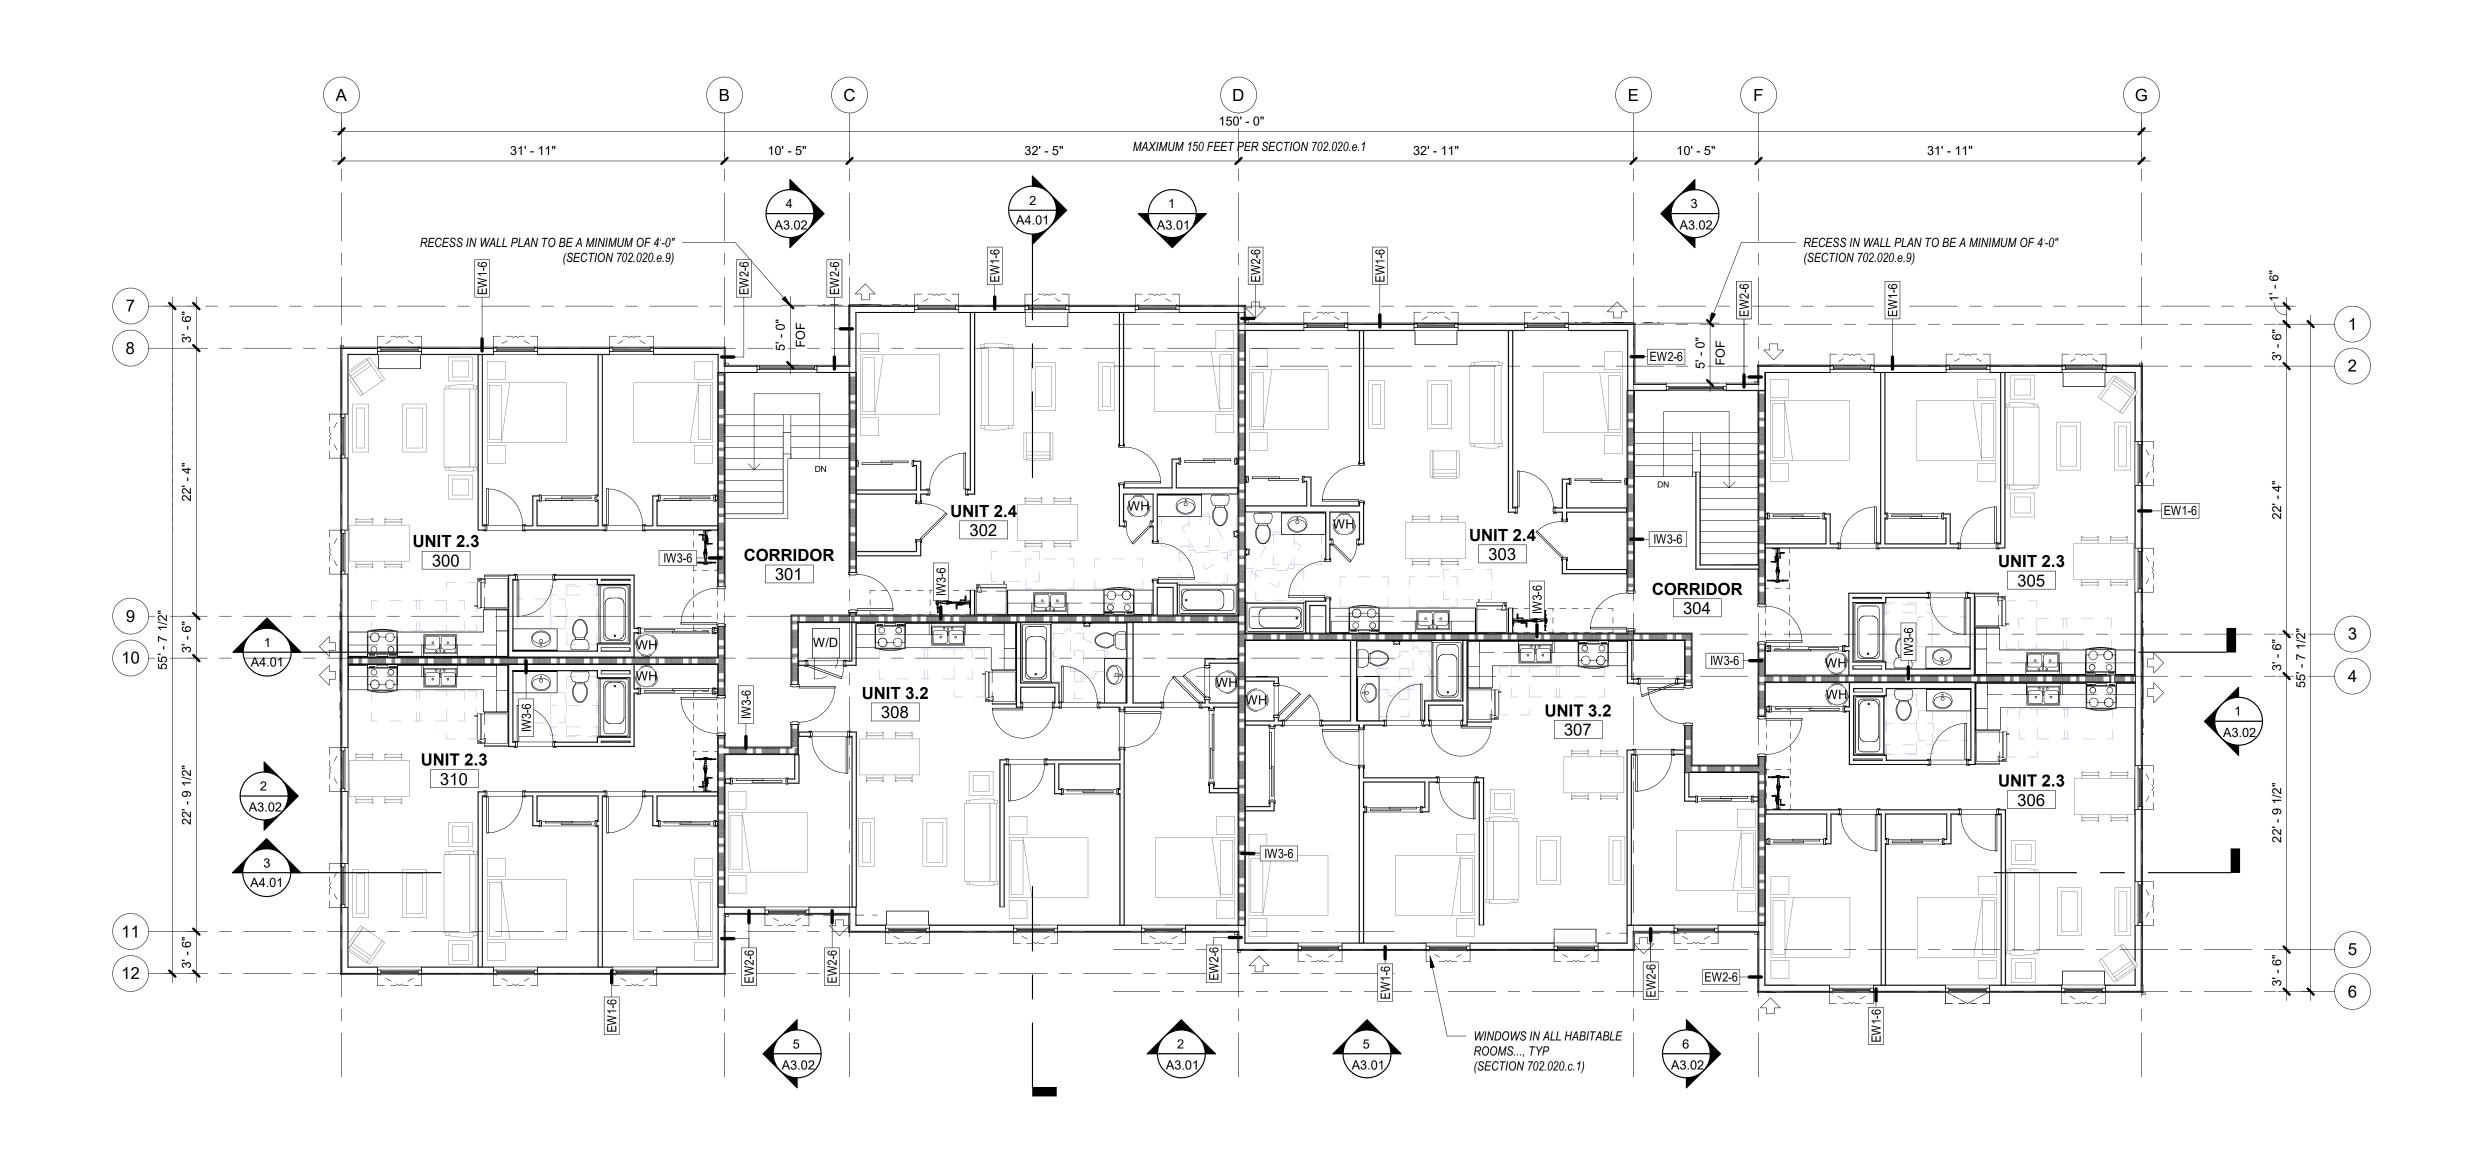

THIRD FLOOR PLAN

1/8" = 1'-0"

GENERAL SHEET NOTES


- A. WALL DIMENSIONS ARE FROM FACE OF STUD OR CL OF COLUMN U.N.O.
 B. ALL EXTERIOR GRID LINES SHOWN ARE TO FACE OF SHEATHING U.N.O. ALL INTERIOR GRID LINES ARE TO FACE OF STUD U.N.O.
 C. ALL DOOR AND WINDOW DIMENSIONS ARE TO CL OR OVERALL UNIT. REFERENCE SCHEDULES AND DOOR AND WINDOW TYPES
- DOOR AND WINDOW TYPES

 D. REFERENCE STRUCTURAL DRAWINGS FOR
 GENERAL CONTROL JOINTS @ SLAB. COORDINATE
 FINAL LOCATIONS WITH ARCHITECT COMPATIBILITY
 - WITH FLOOR FINISHES

 E. SEE DOOR SCHEDULE FOR DOOR TYPES AND INSTALLATION DETAILS CORRESPONDING TO DOOR NUMBERS

F. SEE WINDOW SCHEDULE FOR WINDOW TYPES

- G. FOR FLOOR FINISHES, SEE FLOOR FINISH PLAN
 H. WIRE SHELVING IN ALL BEDROOM CLOSETS
 I. M.E.P. INFORMATION PROVIDED FOR REFERENCE ONLY. CONTRACTOR TO COORDINATE ALL LOCATIONS OF EQUIPMENT AND REQUIRED PENETRATIONS
 J. PROVIDE BLOCKING FOR FUTURE GRAB BARS AT
- PENETRATIONS
 PROVIDE BLOCKING FOR FUTURE GRAB BARS AT ALL UNIT RESTROOMS WHERE GRAB BARS ARE NOT SHOWN IN PLAN, REF ACCESSIBILITY DIAGRAMS FOR LOCATIONS
- K. FIRE EXTINGUISHER TO BE PLACED IN PANTRY IN ALL UNITSL. CURTAIN RODS AT ALL BEDROOM CLOSETS ARE
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 M. DOWNSPOUTS PAINTED IN FIELD, RECTANGLE SHAPE AND SIZE PER PLUMBING AND CIVIL

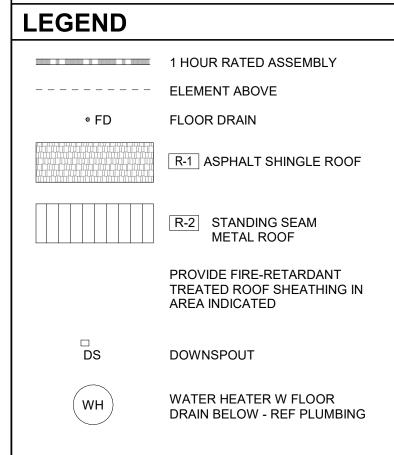

OPERABLE WINDOW

KEYNOTES (07-02)



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5205 BATTLE CREEK RD SE

BUILDING B

Job Number:

SALEM, OR 97306

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Drawing:


FLOOR PLAN - LEVEL 3 & ROOF PLAN

03.11.2022

DATE

Sheet No: Building B -

A2.12

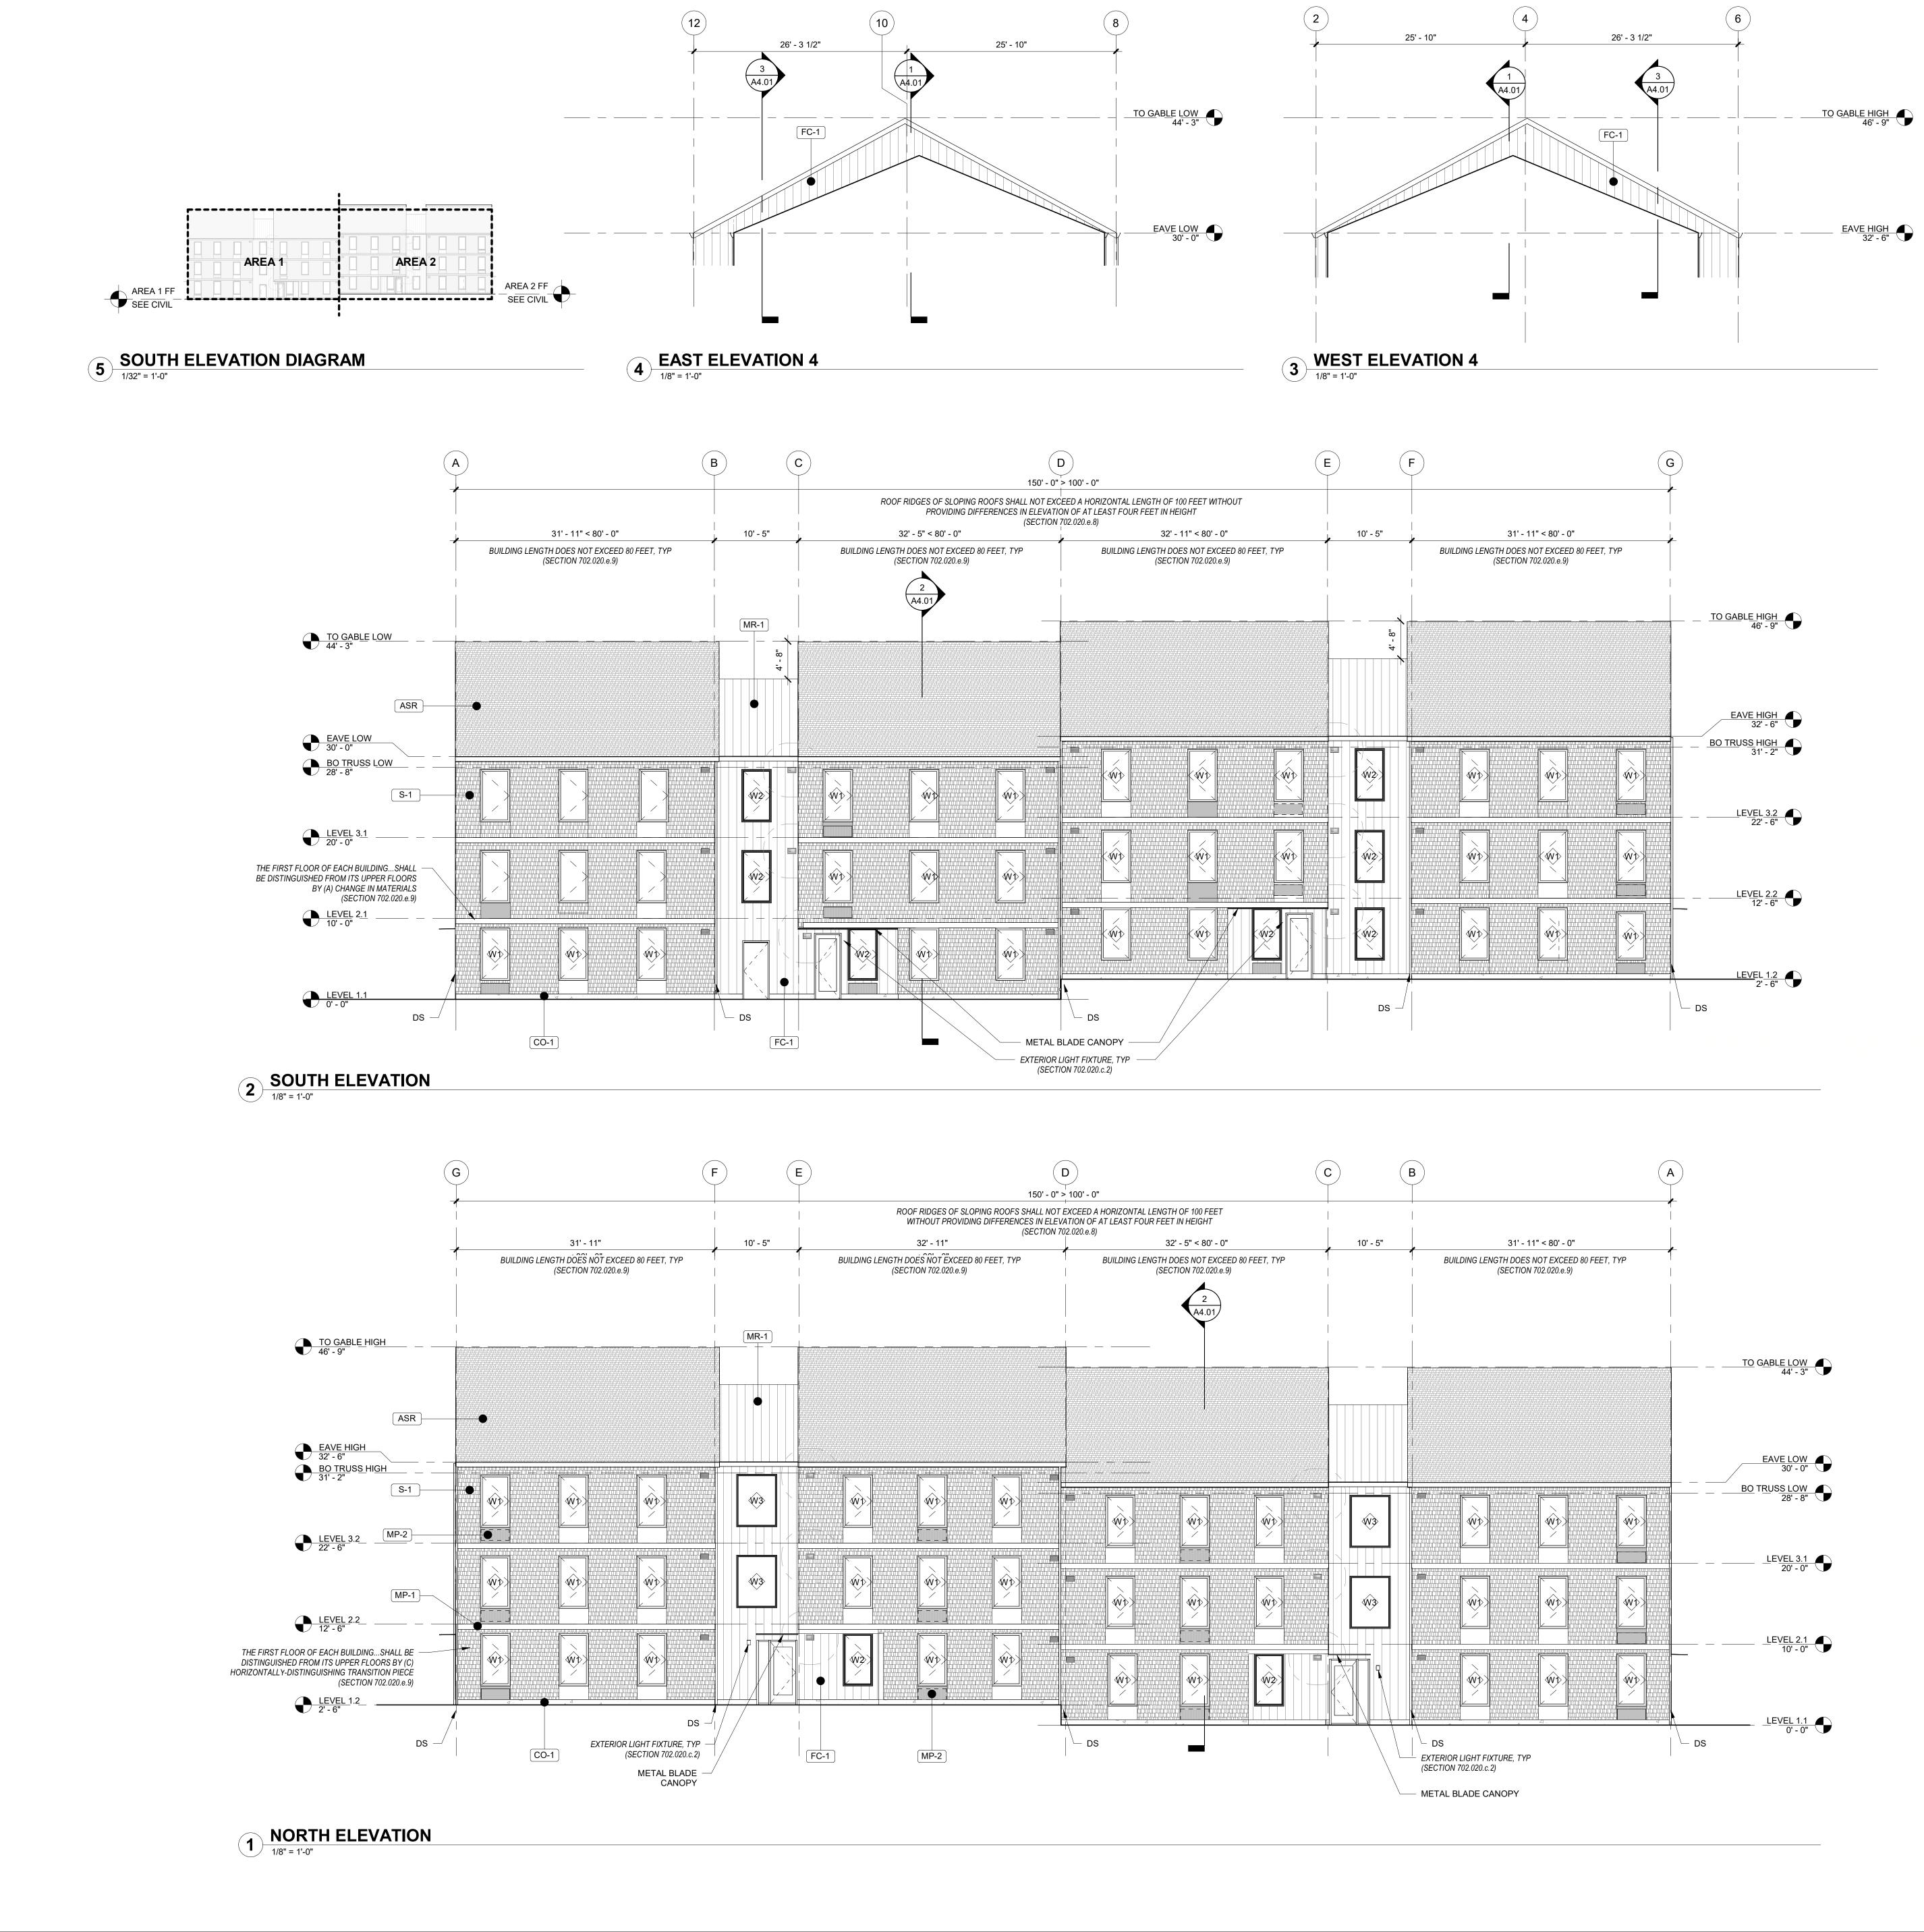

GENERAL SHEET NOTES A. REFERENCE FLOOR PLANS FOR DOOR AND WINDOW LOCATIONS. B. REFERENCE ELECTRICAL FOR EXTERIOR LIGHT APPLICATIONS.

CONFIRM ALL EXHAUST OPENINGS ARE MINIMUM **SCOTT EDWARDS** ARCHITECTURE LLP. 3'-0" FROM OPERABLE OPENINGS. D. ALL EXTERIOR LOUVERS TO BE PAINTED TO 2525 E Burnside Street, Portland, OR 97214 MATCH THE EXTERIOR FINISH IT PENETRATES. phone: (503) 226-3617 www.seallp.com PREFINISHED 22 GAUGE FORMED SHEET METAL WINDOW TRIM, JAMB, AND SILL AT WINDOWS. PREFINISHED 22 GAUGE METAL THROUGH WALL FLASHING AT WINDOW HEADS.
G. TRANSITION BETWEEN FIBER CEMENT SIDING PROFILES TO FOLLOW MANUFACTURER DETAILING AND REQUIREMENTS. **LEGEND** SHINGLE SIDING PRODUCT: FIBER CEMENT SHINGLE SIDING, STRAIGHT EDGE PANEL COLOR: TBD, DARK **ASPHALT SHINGLE ROOF** (ASR) PRODUCT: TBD **CDP SALEM -**COLOR: TBD **BUILDING B FLAT METAL PANEL** Job Number: PRODUCT: TBD FINISH: BLACK **5205 BATTLE CREEK RD SE SALEM, OR 97306** FLAT METAL PANEL, PERFORATED PRODUCT: TBD FINISH: BLACK **BOARD & BATTEN SIDING** PRODUCT: FIBER CEMENT SMOOTH FLAT PANEL COLOR: WHITE

STANDING SEAM METAL ROOF

CONCRETE STEM WALL

PRODUCT:

X-VENT

PTHP (BEYOND)

COLOR: WHITE

D P Community
Development
Partners

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Drawing:

EXTERIOR ELEVATIONS


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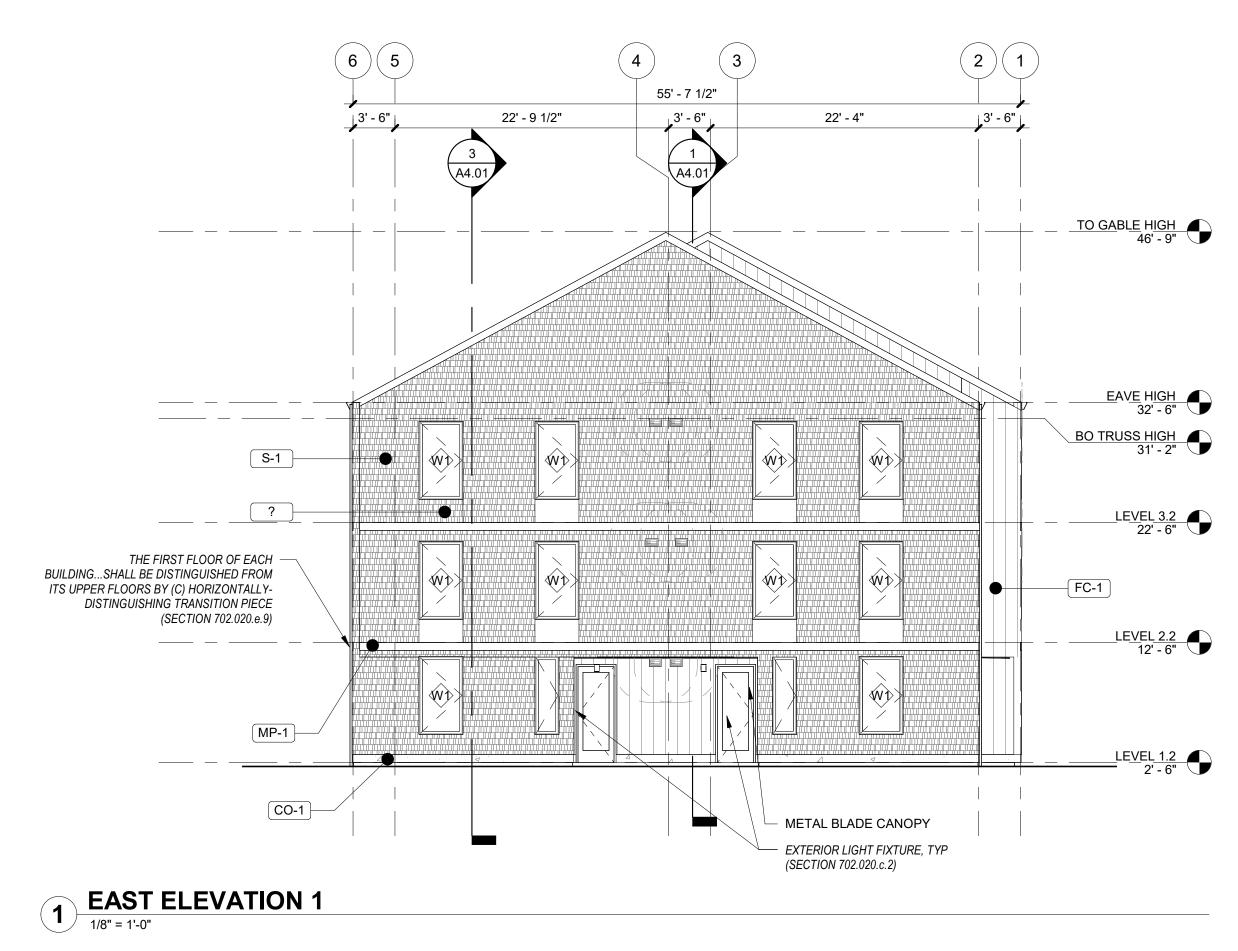
A3.01








52' - 1 1/2" 25' - 10" 26' - 3 1/2" TO GABLE LOW 44' - 3" <u>EAVE LOW</u> 30' - 0" FC-1 LEVEL 2.1 10' - 0"


WEST ELEVATION 21/8" = 1'-0"

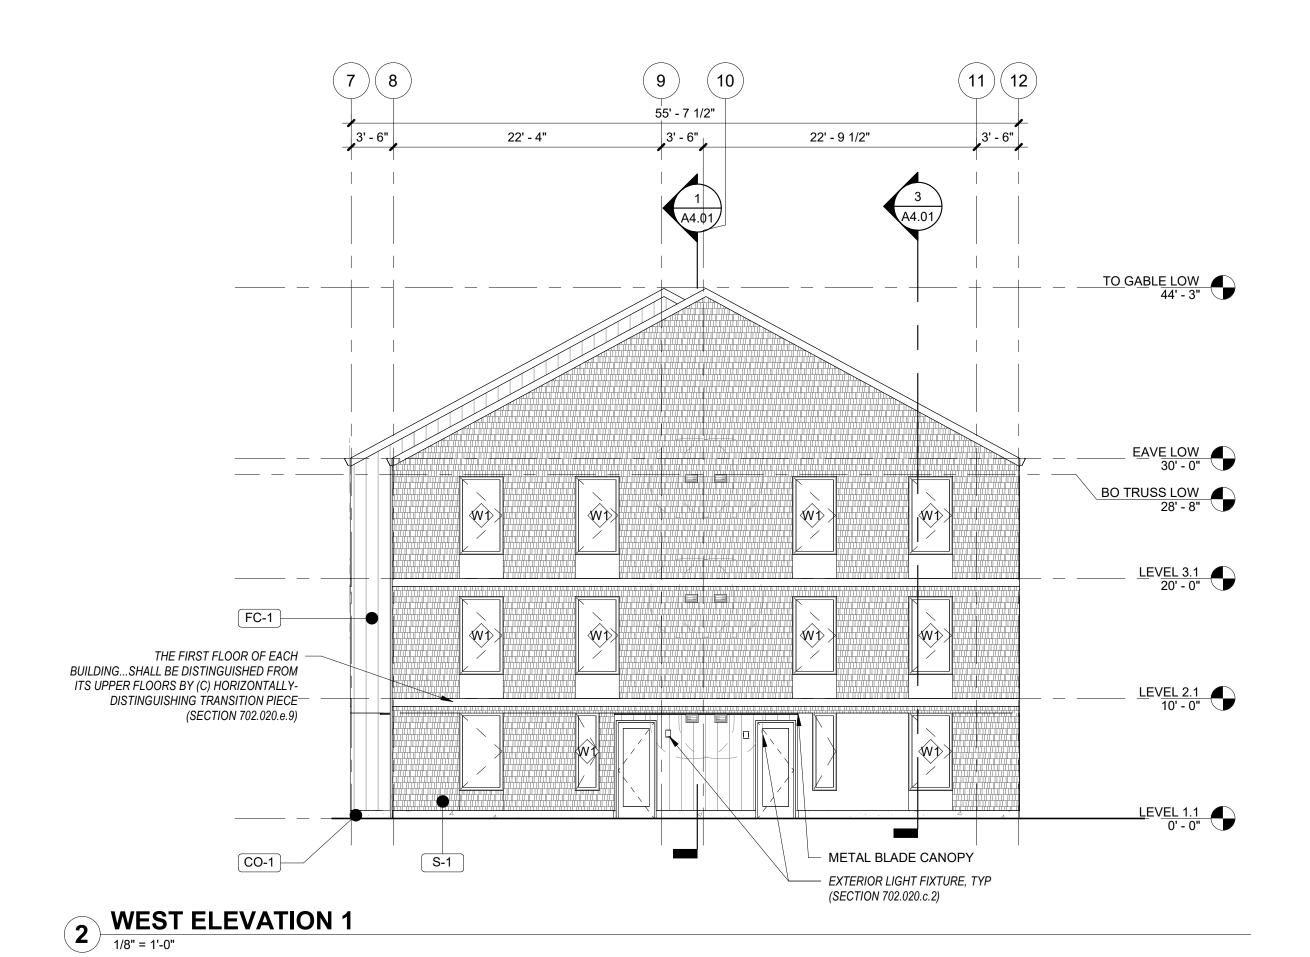

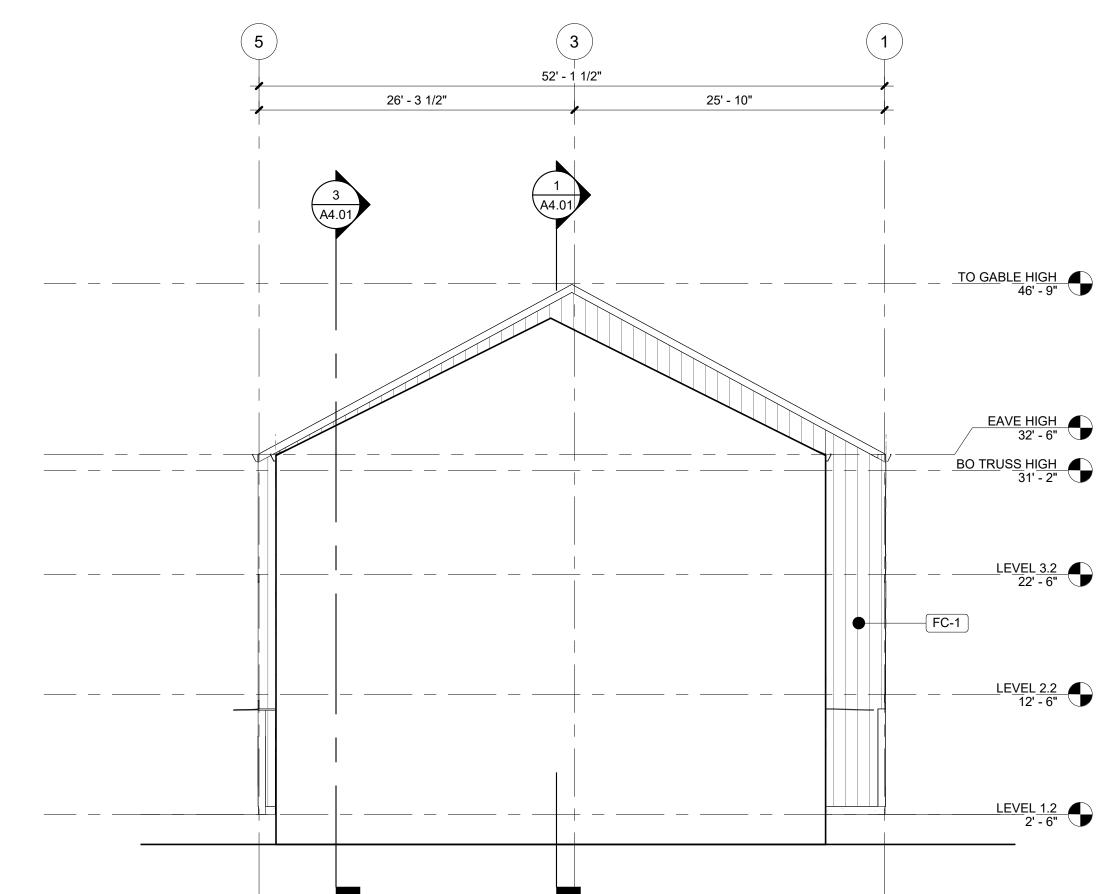

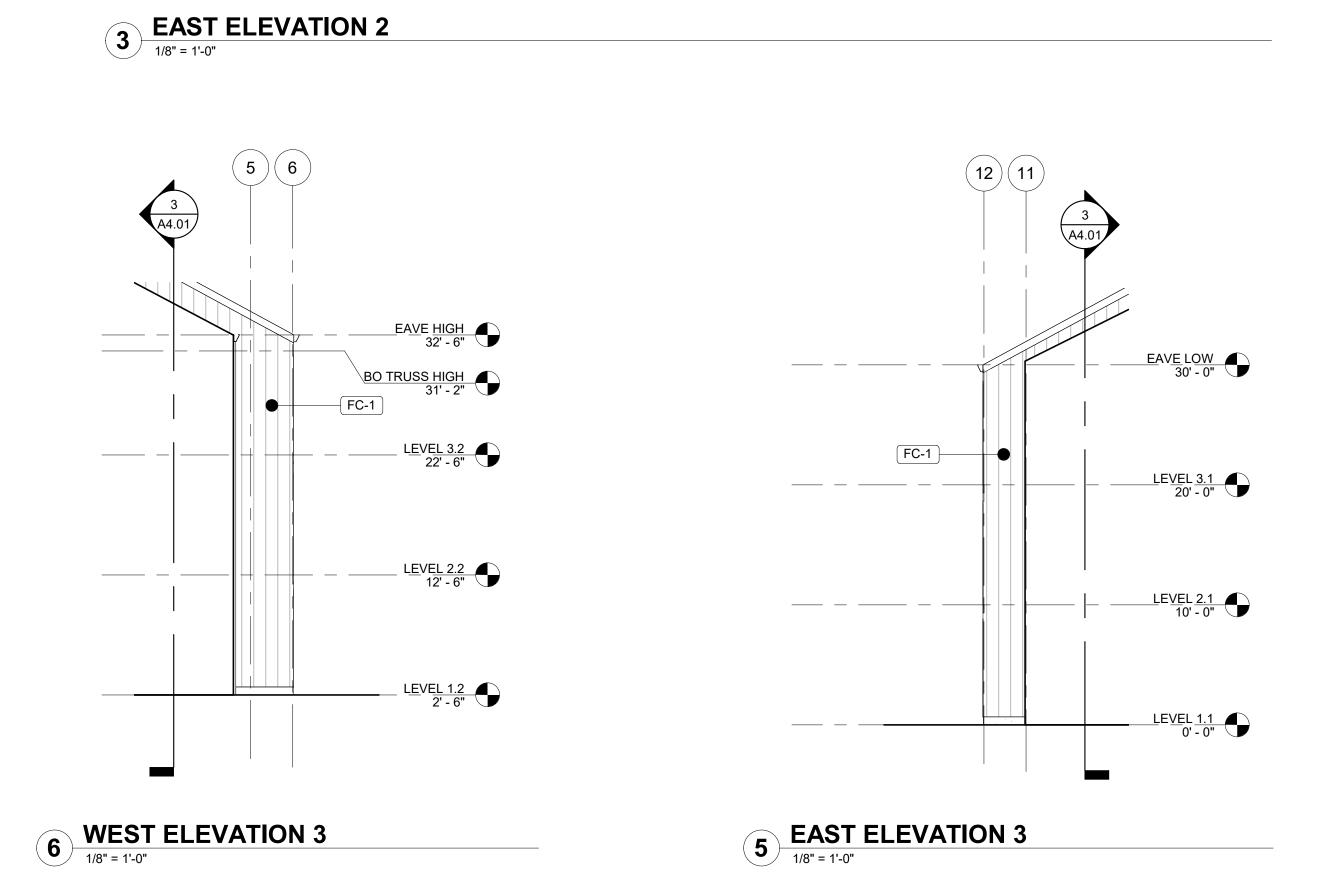

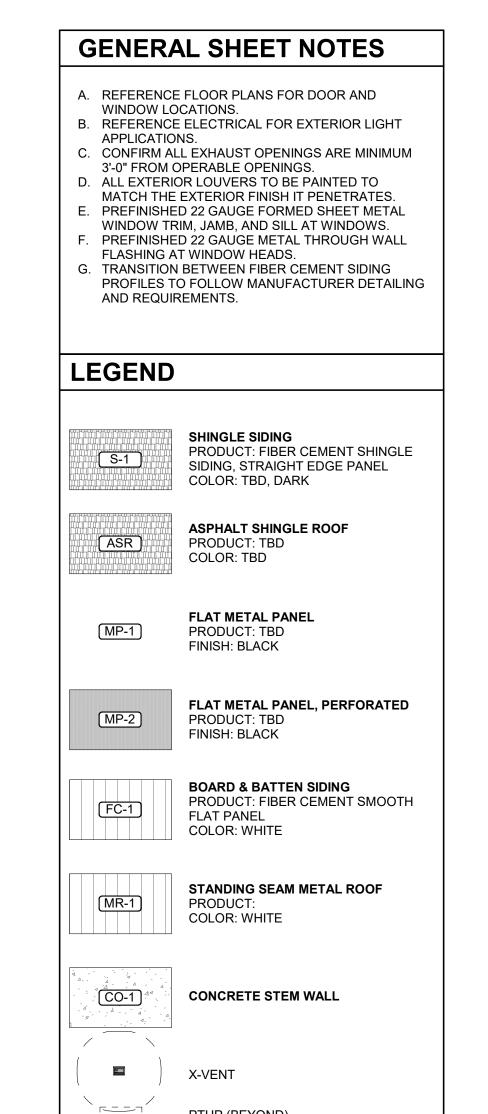

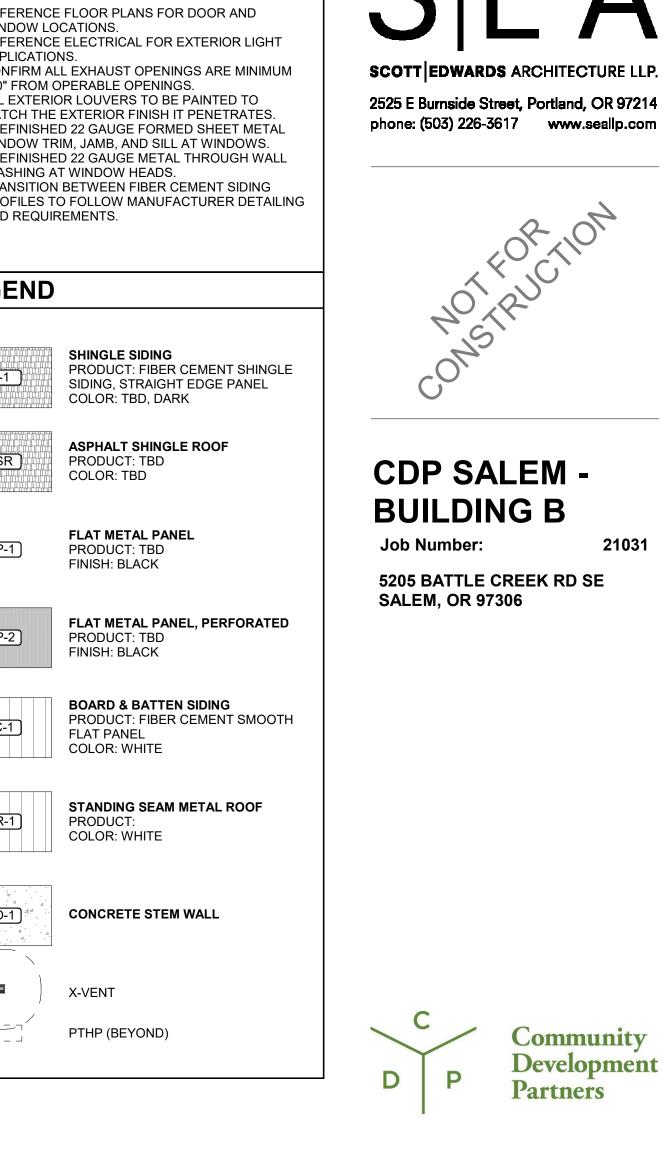




DATE

EXTERIOR ELEVATIONS



BUILDING FACING COURTYARD 2

MATERIALS

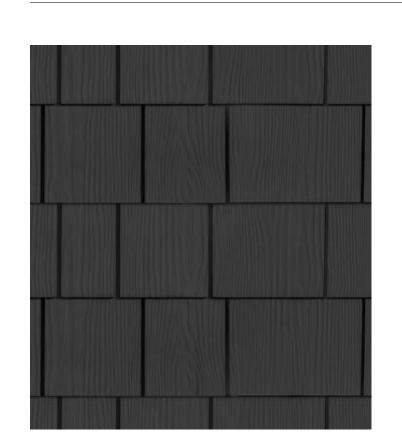

SHINGLE SIDING
PRODUCT: FIBER CEMENT
SHINGLE SIDING, STRAIGHT
EDGE PANEL
COLOR: TBD, DARK

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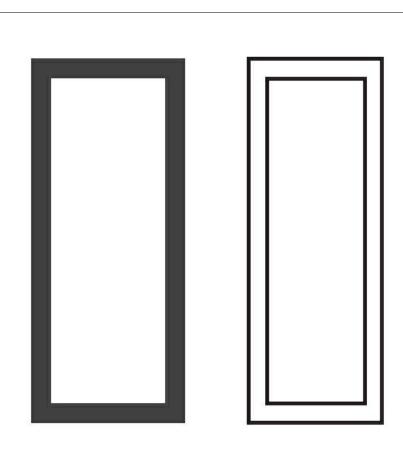
BOARD AND BATTEN SIDING
PRODUCT: FIBER CEMENT
SMOOTH FLAT PANEL
COLOR: WHITE



ASPHALT SHINGLE ROOF PRODUCT: TBD FINISH: TBD, DARK



FLAT METAL PANEL PRODUCT: TBD FINISH: TBD, DARK



VINYL WINDOWS
PRODUCT: PRODUCT: VPI
ENDURANCE AND KAWNEER
TRIFAB 451
FINISH: TBD, LIGHT & DARK



BUILDING FACING PARKING



PATH FROM PARKING TO COURTYARD

* SITE AND LANDSCAPING SHOWN FOR REFERENCE ONLY. SEE CIVIL AND LANDSCAPE DRAWINGS FOR FULL DESIGN.

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CDP SALEM -

5205 BATTLE CREEK RD SE SALEM, OR 97306

BUILDING B

Job Number:

D P Partners

LAND USE SUBMISSION ISSUE

RENDERINGS

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A3.10

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CDP SALEM -**BUILDING B**

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LAND USE SUBMISSION ISSUE

Drawing:


WALL SECTIONS

03.11.2022


DATE

WALL TYPE PER PLAN <u>INTERIOR</u> **EXTERIOR** FIBER CEMENT SHINGLE SIDING RAINSCREEN FURRING BEYOND RIGID INSULATION AT HEADER - WRB (AIR BARRIER), LAP OVER FLASHING, TAPED ' - SAM, LAP OVER NAIL FLANGE HEADER PER STRUCT STARTER STRIP FASTENED TO FURRING ONLY, DO NOT PENETRATE WINDOW HEAD VAPOR RETARDER, WRAP INTO R.O. & TAPE TO SAM B.O. FRAMING
PER WALL SECTIONS CORNER BEAD, TYP AT 24 GA PREFINISHED FORMED ALL GWB CORNERS SHEET METAL HEAD FLASHING BACKER ROD AND - BEDDING SEAL AIR SEALANT - SAM, WRAP INTO R.O. J MOLDING - VINYL NAIL FIN WINDOW PAINTABLE SEALANT — EDGE OF JAMB FLASHING BEYOND

3 WINDOW HEAD @ F.C. SHINGLE SIDING

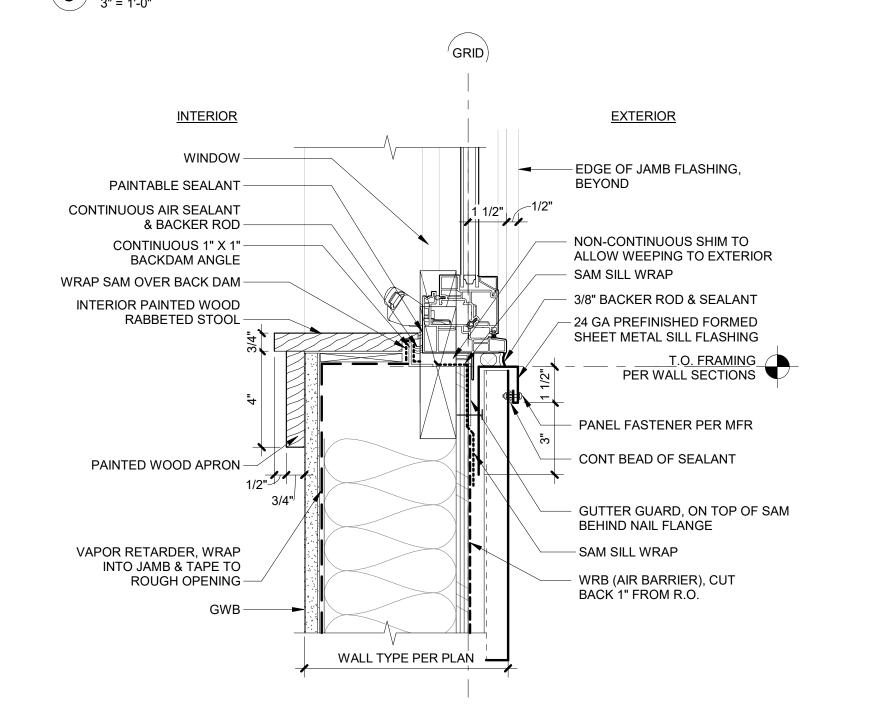

7 WINDOW SILL @ METAL PANEL SIDING 3" = 1'-0"

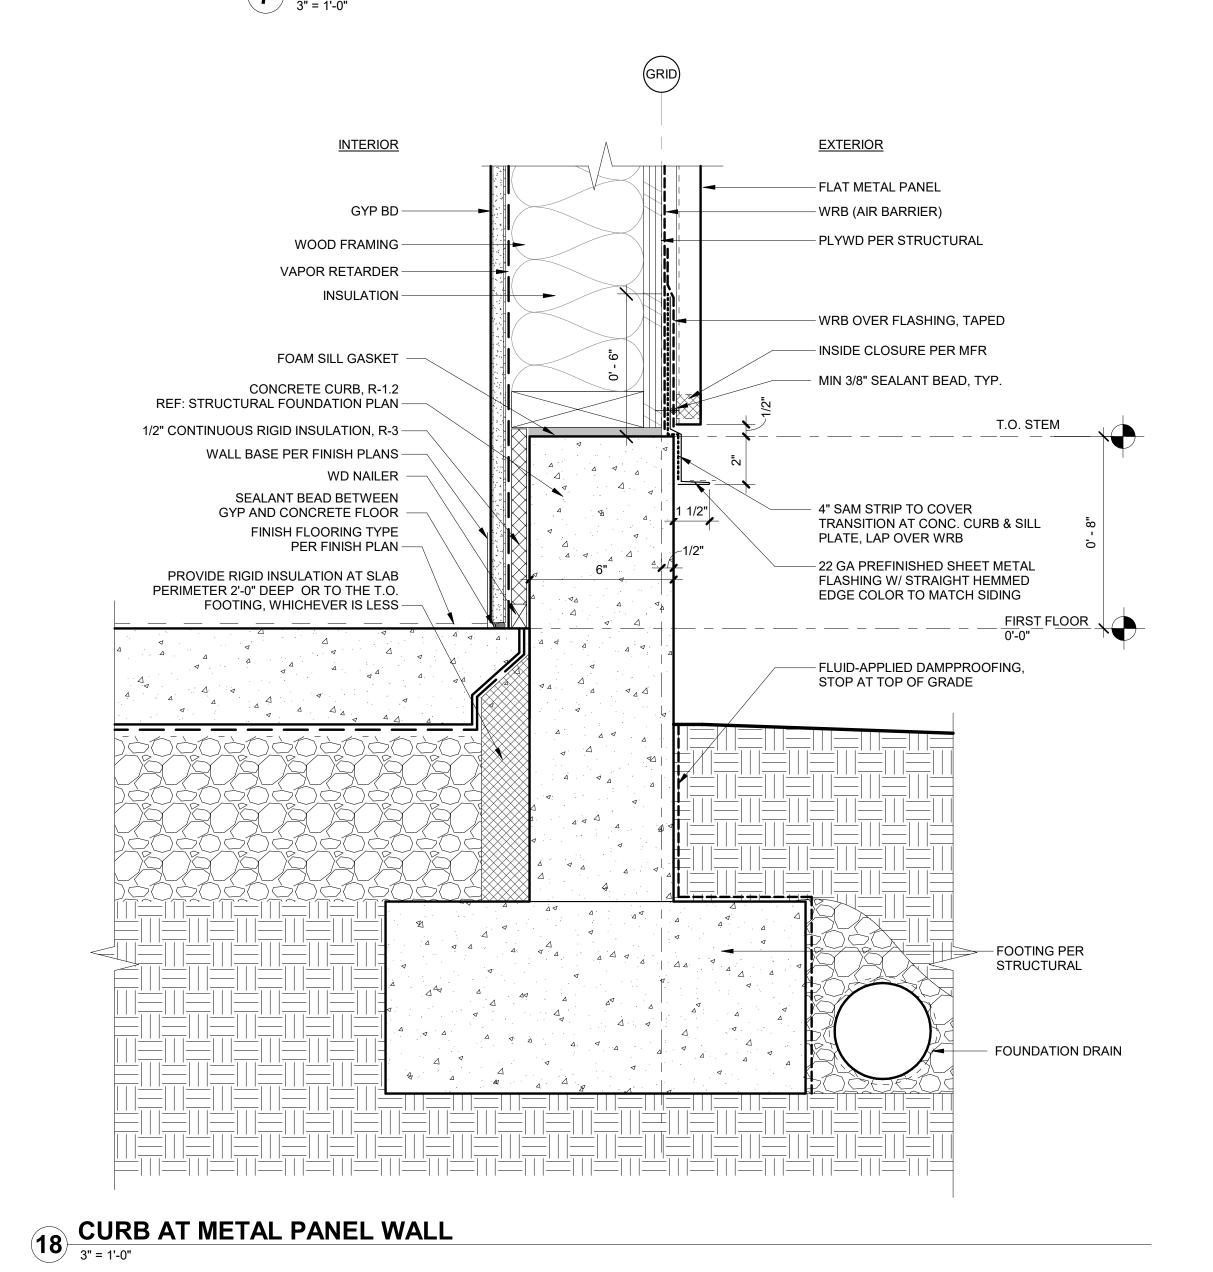


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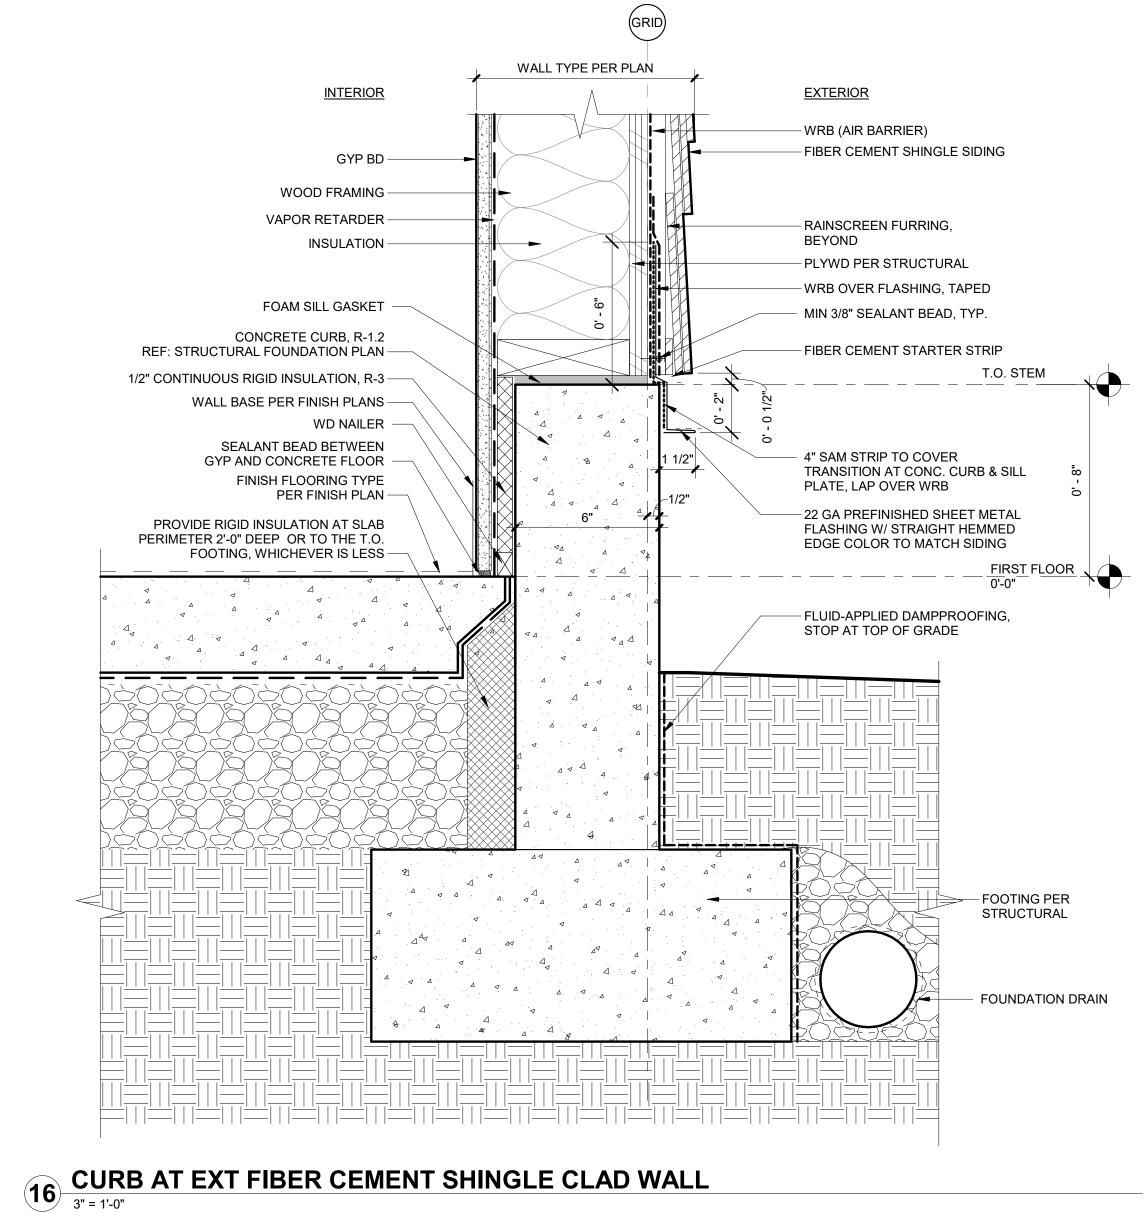
Job Number: **5205 BATTLE CREEK RD SE**

SALEM, OR 97306





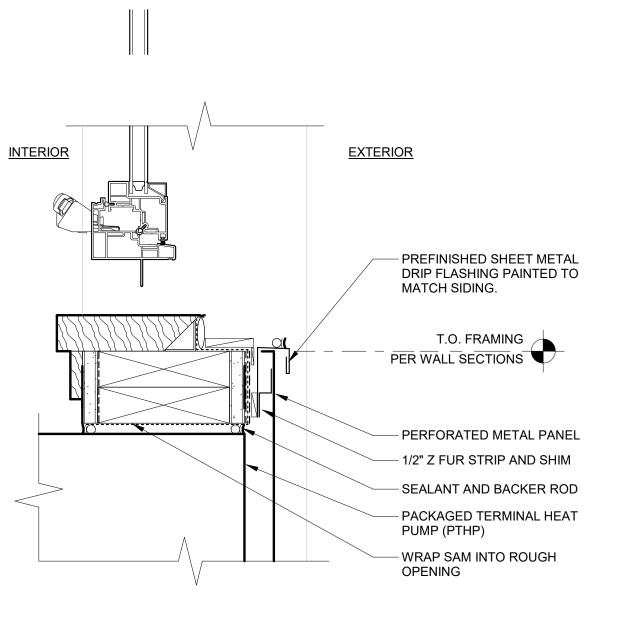



LAND USE SUBMISSION ISSUE

Drawing: **EXTERIOR DETAILS**

03.11.2022

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