

LAND USE SUBMISSION

03.11.2022



CDP SALEM - BUILDING A

5205 BATTLE CREEK RD SE
SALEM, OR 97306

S|E A
SCOTT EDWARDS ARCHITECTURE LLP.
2525 E Burnside Street, Portland, OR 97214
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FILE PATH: C:\Revit_Local\21031_CDP Salem Gateway_Walk Up Building A_22_mculbertson.rvt

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GENERAL PROJECT NOTES		PROJECT TEAM		PROJECT SUMMARY		SHEET INDEX																																									
<p>REFER TO OWNER-CONTRACTOR AGREEMENT FOR GENERAL CONDITIONS. WHERE THERE IS A CONFLICT BETWEEN THE CONTRACT AND NOTES HEREIN, THE CONTRACT TAKES PRECEDENCE.</p> <p>1. GENERAL CONTRACTOR IS RESPONSIBLE FOR THE FULL SET OF CONSTRUCTION DOCUMENTS, INCLUDING BUT NOT LIMITED TO DRAWINGS, SPECIFICATIONS, AND ADDENDA.</p> <p>2. THE CONTRACTOR SHALL FIELD VERIFY ALL CONDITIONS AND DIMENSIONS PRIOR TO ANY WORK AND SHALL BE RESPONSIBLE FOR ALL WORK AND MATERIALS INCLUDING THOSE FURNISHED BY SUBCONTRACTORS.</p> <p>3. DIMENSIONS TAKE PRECEDENCE OVER DRAWINGS; DO NOT SCALE DRAWINGS TO DETERMINE ANY LOCATIONS. THE ARCHITECT SHALL BE NOTIFIED OF ANY DISCREPANCY PRIOR TO CONTINUING WITH WORK.</p> <p>4. GENERAL CONTRACTOR SHALL KEEP THE CONSTRUCTION SITE IN A BROOM CLEAN CONDITION AT ALL TIMES DURING THE PROJECT.</p> <p>5. THE CONTRACTOR SHALL REPORT TO THE ARCHITECT ANY ERRORS, INCONSISTENCIES OR OMISSIONS HE OR SHE MAY DISCOVER. BRING UNFORSEEN CONDITIONS TO ATTENTION OF ARCHITECT UPON DISCOVERY AT ANY POINT. THE MEANS OF CORRECTING ANY ERROR OR UNFORSEEN CONDITION SHALL FIRST BE APPROVED BY THE ARCHITECT.</p> <p>6. ALL REQUIRED CITY AND/OR COUNTY LICENSE SHALL BE ACQUIRED AND PAID FOR BY THE INDIVIDUAL TRADE.</p> <p>7. THE ARCHITECT WILL REVIEW SHOP DRAWINGS AND SAMPLES FOR CONFORMANCE WITH THE DESIGN CONCEPT OF THE PROJECT. THE ARCHITECT'S REVIEW OF A SEPARATE ITEM SHALL NOT INDICATE APPROVAL OF AN ASSEMBLY IN WHICH THE ITEM FUNCTIONS.</p> <p>8. IT SHALL BE THE RESPONSIBILITY OF THE CONTRACTOR TO VERIFY LOCATION OF ALL EXISTING UTILITIES WHETHER SHOWN HEREIN OR NOT AND TO PROTECT THEM FROM DAMAGE. THE CONTRACTOR SHALL BEAR ALL EXPENSES OF REPAIR OR REPLACEMENT OF UTILITIES OR OTHER PROPERTY DAMAGED BY OPERATIONS IN CONJUNCTION WITH THE EXECUTION OF THE WORK.</p> <p>9. CITY APPROVED PLANS SHALL BE KEPT IN A SECURE PLACE AND SHALL NOT BE USED BY WORKERS. THE CONTRACTOR SHALL BE RESPONSIBLE THAT ALL SUBCONTRACTORS' CONSTRUCTION SETS REFLECT THE SAME INFORMATION. THE CONTRACTOR SHALL ALSO MAINTAIN, IN GOOD CONDITION, ONE COMPLETE SET OF STAMPED CITY APPROVED PLANS WITH ALL REVISIONS, ADDENDUMS, AND CHANGE ORDERS ON THE PREMISES AT ALL TIMES. THESE ARE TO BE UNDER THE CARE OF THE JOB SUPERINTENDENT AND MUST BE MADE AVAILABLE TO BUILDING AND FIRE INSPECTIONS FOR REFERENCE DURING CONSTRUCTION.</p> <p>10. THE CONTRACTOR SHALL BE RESPONSIBLE FOR THE COMPLETE SECURITY OF THE SITE WHILE THE JOB IS IN PROGRESS AND UNTIL JOB COMPLETION.</p> <p>11. THE CONTRACTOR SHALL TAKE ALL NECESSARY PRECAUTIONS TO ENSURE THE SAFETY OF THE OCCUPANTS AND WORKERS AT ALL TIMES.</p> <p>12. THE CONTRACTOR IS SOLELY RESPONSIBLE FOR ALL CONSTRUCTION MEANS AND METHODS AND SHALL MAINTAIN THE STRUCTURAL INTEGRITY OF ANY CONSTRUCTION.</p> <p>13. THE CONTRACTOR SHALL BE RESPONSIBLE FOR AND SHALL REPLACE OR REMEDY ANY FAULTY, IMPROPER, OR INFERIOR MATERIALS OR WORKMANSHIP WHICH SHALL APPEAR WITHIN ONE (1) YEAR AFTER THE COMPLETION AND ACCEPTANCE OF THE WORK UNDER THIS CONTRACT.</p> <p>14. CONTRACTOR TO PROVIDE BACKING OR BLOCKING AS REQUIRED FOR MOUNTING ALL WALL MOUNTED SHELVES, EQUIPMENT, ACCESSORIES, CABINETS, ETC.</p> <p>15. CONTRACTOR TO PROTECT ALL TREES AND ROOTS NOT SLATED FOR REMOVAL DURING CONSTRUCTION.</p> <p>16. GENERAL CONTRACTOR RESPONSIBLE FOR MAINTENANCE OF STAGING AREA AND TO ENSURE THAT MATERIALS DELIVERY AND STORAGE DOES NOT INTERFERE WITH DAILY OPERATION OF ADJACENT PROPERTIES OR PUBLIC RIGHT OF WAY.</p> <p>17. GENERAL CONTRACTOR RESPONSIBLE FOR CONSTRUCTION STAKING.</p>		<p>OWNER</p> <p>CDP OREGON LLC 126 NE ALBERTA ST #202 PORTLAND, OR 97211 TEL: 971.533.7466 FAX: N/A CONTACT: THOMAS ELDRIDGE EMAIL: THOMAS@COMMUNITYDEVPARTNERS.COM</p> <p>CONTRACTOR</p> <p>LMC CONSTRUCTION 19200 SW TETON AVE TUALATIN, OR 97062 TEL: 503.646.0521 FAX: 503.646.6823 CONTACT: CHRIS DUFFIN EMAIL: CHRISD@LMCCONSTRUCTION.COM</p> <p>ARCHITECT</p> <p>SCOTT EDWARDS ARCHITECTS, LLP 2525 E. BURNSIDE STREET PORTLAND, OREGON 97214 TEL: 503.226.3617 FAX: 503.226.3715 CONTACT: DAVE MOJICA EMAIL: DMOJICA@SEALLP.COM</p> <p>CIVIL ENGINEER</p> <p>WEST TECH ENGINEERING 3841 FAIRVIEW INDUSTRIAL DR SE #100 SALEM, OR 97302 TEL: 503.585.2474 FAX: N/A CONTACT: STEVE WARD EMAIL: SWARD@WESTECH-ENG.COM</p> <p>LANDSCAPE ARCHITECT</p> <p>PLACE 735 NW 18TH AVENUE PORTLAND, OR 97209 TEL: 503.334.2080 FAX: N/A CONTACT: MAURICIO VILLARREAL EMAIL: MAURICIO.VILLARREAL@PLACE.LA</p> <p>STRUCTURAL ENGINEER</p> <p>STONEWOOD STRUCTURAL ENGINEERS, INC 2001 NW 19TH SUITE 103A PORTLAND, OR 97209 TEL: 360.216.1704 FAX: N/A CONTACT: D. SCOTT NYSETH EMAIL: SCOTT.NYSETH@STONEWOODSTRUCTURAL.COM</p> <p>MEP</p> <p>INTERFACE 100 SW MAIN STREET, SUITE 1600 PORTLAND, OR 97204 TEL: 503.382.2266 FAX: 503.382.2262 CONTACT: KIM WALL EMAIL: KIMW@INTERFACEENG.COM</p>		<p>PROJECT DESCRIPTION: 3-STORY WOOD FRAMED MULTIFAMILY BUILDING FEATURING 12 RESIDENTIAL UNITS, LAUNDRY ROOM AND FIRE RISER ROOM.</p> <p>GROSS AREA: 13,593 SF</p> <p>PROJECT ADDRESS: 5205 BATTLE CREEK RD SE SALEM, OR 97306</p> <p>LEGAL DESCRIPTION: 083W14/ 118 AND 300</p> <p>ZONING: RM-II</p>		<table><tr><th>SHEET #</th><th>SHEET NAME</th></tr><tr><td colspan="2">GENERAL</td></tr><tr><td>G0.01</td><td>GENERAL PROJECT INFORMATION</td></tr><tr><td>G0.01A</td><td>GENERAL PROJECT INFORMATION</td></tr><tr><td>G1.01</td><td>CODE SUMMARY</td></tr><tr><td colspan="2">ARCHITECTURAL</td></tr><tr><td>A0.01</td><td>ARCHITECTURAL GENERAL NOTES AND DIAGRAMS</td></tr><tr><td>A0.10</td><td>ACCESSIBILITY DIAGRAMS - RESIDENTIAL</td></tr><tr><td>A0.20</td><td>ASSEMBLIES</td></tr><tr><td>A2.11</td><td>FIRST FLOOR PLAN</td></tr><tr><td>A2.12</td><td>SECOND FLOOR PLAN</td></tr><tr><td>A2.13</td><td>THIRD FLOOR PLAN</td></tr><tr><td>A2.21</td><td>ROOF</td></tr><tr><td>A3.01</td><td>EXTERIOR ELEVATIONS</td></tr><tr><td>A3.02</td><td>EXTERIOR ELEVATIONS</td></tr><tr><td>A5.01</td><td>WALL SECTIONS</td></tr><tr><td>A7.11</td><td>FOUNDATION DETAILS</td></tr><tr><td>A7.21</td><td>WINDOW DETAILS</td></tr><tr><td>A7.31</td><td>MATERIAL TRANSITIONS</td></tr><tr><td>A7.41</td><td>ROOF, SOFFIT & PARAPET DETAILS</td></tr></table>		SHEET #	SHEET NAME	GENERAL		G0.01	GENERAL PROJECT INFORMATION	G0.01A	GENERAL PROJECT INFORMATION	G1.01	CODE SUMMARY	ARCHITECTURAL		A0.01	ARCHITECTURAL GENERAL NOTES AND DIAGRAMS	A0.10	ACCESSIBILITY DIAGRAMS - RESIDENTIAL	A0.20	ASSEMBLIES	A2.11	FIRST FLOOR PLAN	A2.12	SECOND FLOOR PLAN	A2.13	THIRD FLOOR PLAN	A2.21	ROOF	A3.01	EXTERIOR ELEVATIONS	A3.02	EXTERIOR ELEVATIONS	A5.01	WALL SECTIONS	A7.11	FOUNDATION DETAILS	A7.21	WINDOW DETAILS	A7.31	MATERIAL TRANSITIONS	A7.41	ROOF, SOFFIT & PARAPET DETAILS
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		<p>SEPARATE PERMITS AND DEFERRED SUBMITTAL BIDDER DESIGN ITEMS</p> <p>CONTRACTOR SHALL PROVIDE DESIGN, ENGINEERING, FURNISHING AND INSTALLATION OF A COMPLETE, FUNCTIONING SYSTEM(S) BASED ON THE SCHEMATIC LAYOUT SHOWN ON THE ARCHITECTURAL DRAWINGS, DESCRIBED HEREIN AND IN COMPLIANCE WITH PREVAILING CODE. THE CONTRACTOR SHALL BE RESPONSIBLE FOR FINAL ORDERING OF ALL DEVICES AND FIXTURES TO ENSURE PROPER OPTIONS, ACCESSORIES AND CONFIGURATIONS. CONTRACTOR SHALL PROVIDE COMPLETE DESIGN AND DOCUMENTATION AS REQUIRED FOR SUBMISSION TO, AND APPROVAL OF ARCHITECT, OWNER, AND GOVERNING BUILDING DEPARTMENT.</p> <p>UPON COMPLETION OF REVIEW BY THE ARCHITECT OR ENGINEER OF RECORD, THE CONTRACTOR SHALL BE RESPONSIBLE FOR ROUTING DOCUMENTS TO PERMIT AGENCY FOR PLANS REVIEW AND PAYING ANY PLANS CHECK AND PERMIT FEES.</p> <p><u>SEPARATE PERMITS:</u></p> <p>1. SIGNAGE PERMIT 2. FIRE SPRINKLER SYSTEM 3. FIRE DETECTION AND ALARM SYSTEM 4. FIRE DEPARTMENT ACCESS KEY BOX 5. HANGERS AND SUPPORT FOR HVAC 6. VIBRATION AND SEISMIC CONTROLS FOR HVAC 7. LATERAL BRACING AND ANCHORAGE OF MECHANICAL AND ELECTRICAL EQUIPMENT WEIGHING MORE THAN 75 LBS (EXCEPTIONS PER ASCE 7, SECTION 13.1.4) 8. PRE-ENGINEERED MANUFACTURED TRUSSES 9. STAIR FRAMING 10. ALUMINUM STOREFRONTS</p> <p>SEE SPECIFICATIONS FOR ADDITIONAL REQUIREMENTS NOT LISTED HERE AND ADDITIONAL BIDDER DESIGN ITEMS.</p>																																													
		<p>VICINITY MAP</p>																																													

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CDP SALEM - BUILDING A

Job Number: 21031

5205 BATTLE CREEK RD SE
SALEM, OR 97306

C

D

P

Community Development Partners

LAND USE SUBMISSION ISSUE

03.11.2022


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Drawing: GENERAL PROJECT INFORMATION

Sheet No: Building A - G0.01

Diagram illustrating the minimum clearances for a doorway:


- Minimum clear height: $\geq 80"$
- Minimum clear width: $\geq 27"$
- Maximum door swing clearance: $4" \text{ MAX.}$

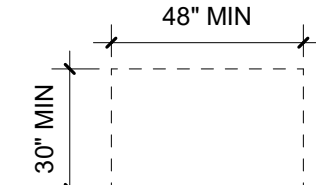

24" MIN.

42" MIN.

* 48" MIN. PROVIDED

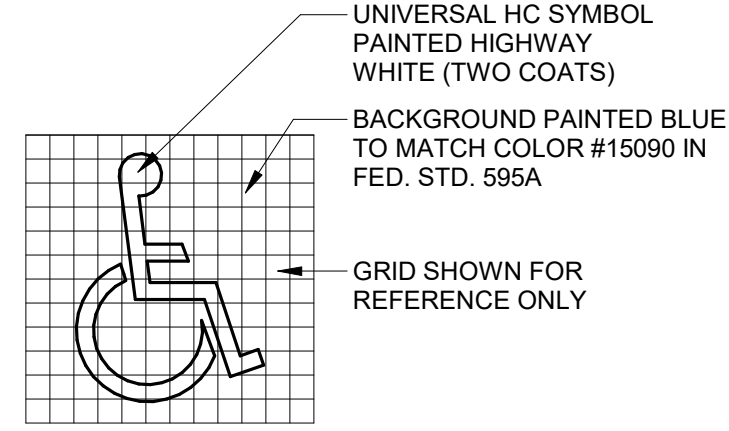

- A. VERIFY ALL ACCESSIBILITY REQUIREMENTS WITH CURRENT CODE AND LOCAL JURISDICTION.
- B. DIAGRAMS ARE INCLUDED AS A CONVENIENCE ONLY AND ARE NOT ALL INCLUSIVE. REFERENCE CURRENT CODE AND PROJECT DOCUMENTS FOR ADDITIONAL REQUIREMENTS.
- C. NOTIFY ARCHITECT OF ANY DISCREPANCIES BETWEEN DIMENSIONS SHOWN HERE AND PROPOSED WORK.



#	POUND OR NUMBER				
@	AT	GA	GAUGE	RA	RADIUS OR RISER
CL	CENTERLINE	GALV	GALVANIZED	RR	RETURN AIR
L	ANGLE	GC	GENERAL CONTRACTOR	RB	RESILIENT BASE
	DIAMETER OR DIAMOND	GI	GALVANIZED IRON	RD	ROOF DRAIN
		GL	GULUM	REC	RECOMMENDATION
AB	ANCHOR BOLT	GND	GROUND	REF	REFERENCE
AC	ASPHALTIC CONCRETE	GRADE	GRADE	REF	REFRIGERATOR
ACT	ACOUSTIC CEILING TILE	GWB	GYPSPUM BOARD	REINF	REINFORCE(MENT)
AD	AREA DRAIN	GYP	GYPSPUM	REQD	REQUIRED
ADJ	ADJUSTABLE	GYP BD	GYPSPUM BOARD	RESIL	RESILIENT
AF	ABOVE FINISH FLOOR			REV	REVISIONS
AFG	ABOVE FINISH GRADE	HB	HOSE BIB	RF	RESILIENT FLOOR
ALT	ALTERNATE	HC	HOLLOW CORE	RH	RIGHT HAND
ALUM	ALUMINUM	HDR	HEADER	RM	ROOM
AND	ANDIZED	HDWR	HARDWARE	RO	ROUGH OPENING
APPROX	APPROXIMATE / APPROXIMATELY	HDWR	HARDWARE	ROW	RIGHT OF WAY
		HM	HOLLOW METAL	RWL	RAIN WATER LEADER

A. DIMENSIONS ARE INDICATED IN THE DOCUMENTS. THE DRAWINGS SHALL NOT BE SCALED FOR DIMENSIONS. NOTIFY ARCHITECT IF ADDITIONAL DIMENSIONS ARE NECESSARY.


B. IN MANY INSTANCES THE ACTUAL DIMENSIONS MAY BE LESS IMPORTANT THAN IF ELEMENTS ARE TO BE EQUALLY SPACED OR ALIGNED. IN THESE CASES, THE NOTATION "EQ" OR "ALIGN" IS USED IN LIEU OF A DIMENSION.

C. DETAILS WILL GOVERN ALL DIMENSIONS NOT SHOWN ON PLANS. REFERENCE INDICATED DIMENSION POINTS.

D. DIMENSIONS SHOWN ARE TO GRIDLINE, CENTERLINE OF COLUMN, OR FACE OF STUD / MASONRY, UNLESS NOTED OTHERWISE.

E. INTERIOR WALLS WHICH ARE EQUALLY SPACED ARE DIMENSIONED TO CENTERLINE OF WALL.

F. DOORS NOT LOCATED BY DIMENSION SHALL BE CENTERED IN WALLS AS SHOWN ON PLANS OR LOCATED 4 1/2" FROM FACE OF FINISH TO ROUGH OPENING.

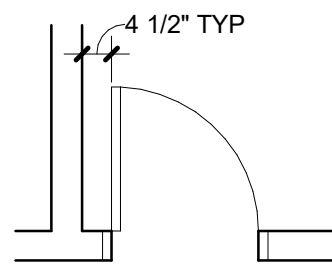


REVISION

 REVISION NUMBER

TYPE A UNITS - REQUIRED CLEAR FLOOR AREAS, CLEARANCES, AND STANDARD MOUNTING LOCATIONS

PER ICC A117.1-2009 AND FAIR HOUSING ACT DESIGN MANUAL


DIMENSIONS ARE FROM FACE OF FINISH AND/OR CENTERLINE OF FIXTURE OR ACCESSORY

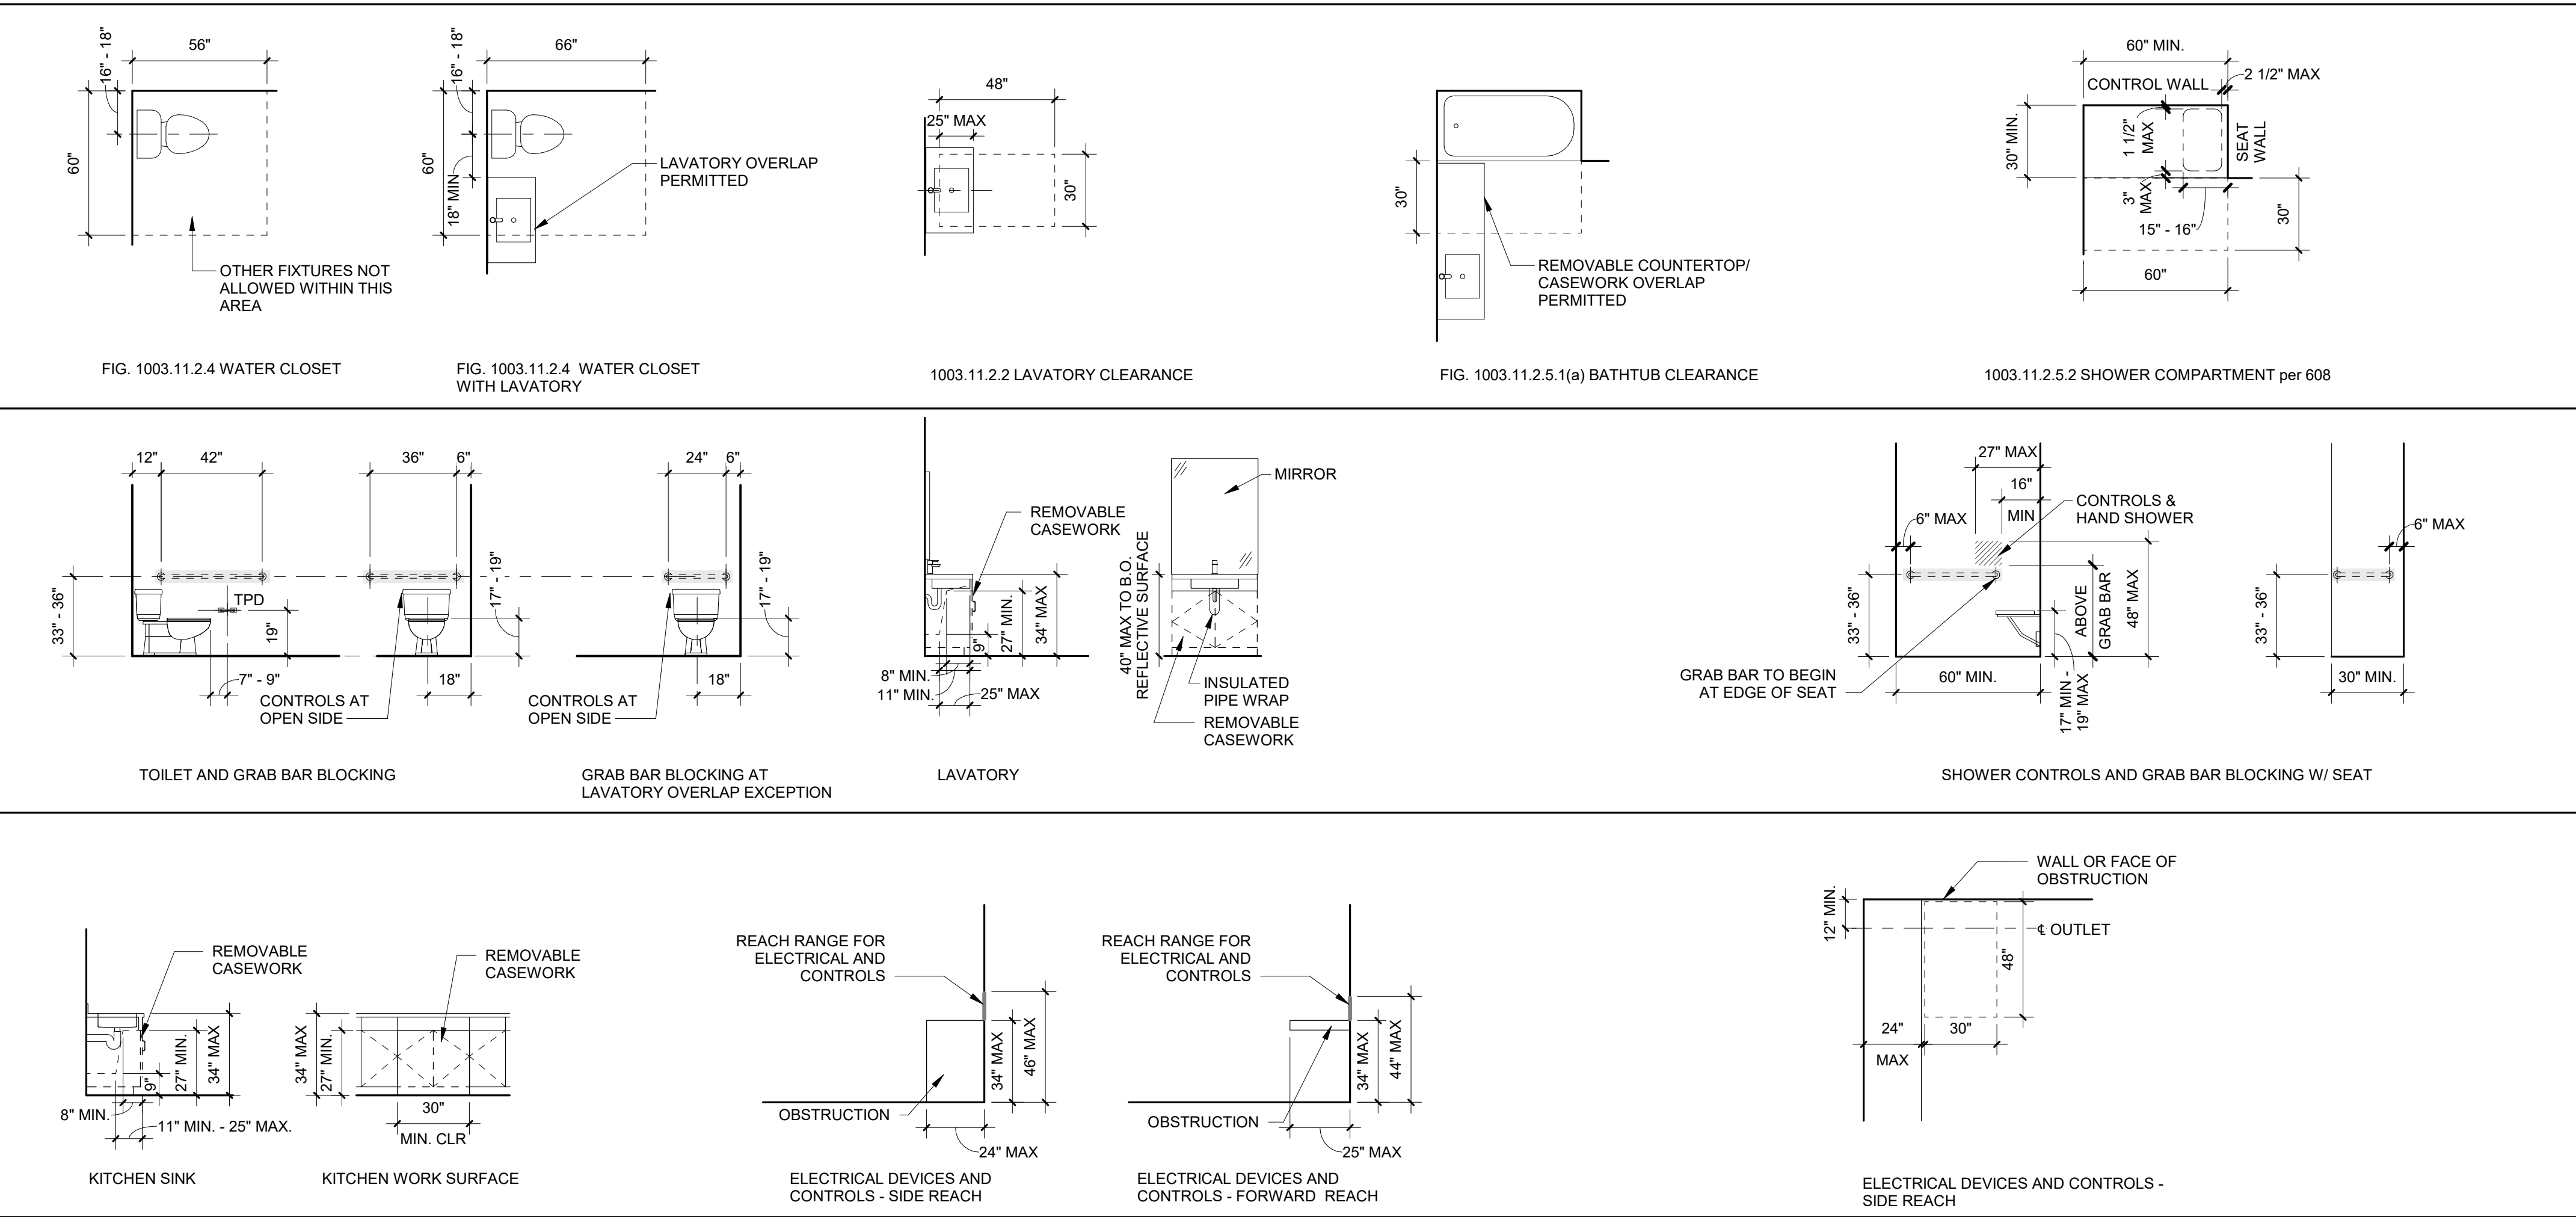

TYPE B UNITS - REQUIRED CLEAR FLOOR AREAS, CLEARANCES, AND STANDARD MOUNTING LOCATIONS

PER ICC A117.1-2009

DIMENSIONS ARE FROM FACE OF FINISH AND/OR CENTERLINE OF FIXTURE OR ACCESSORY

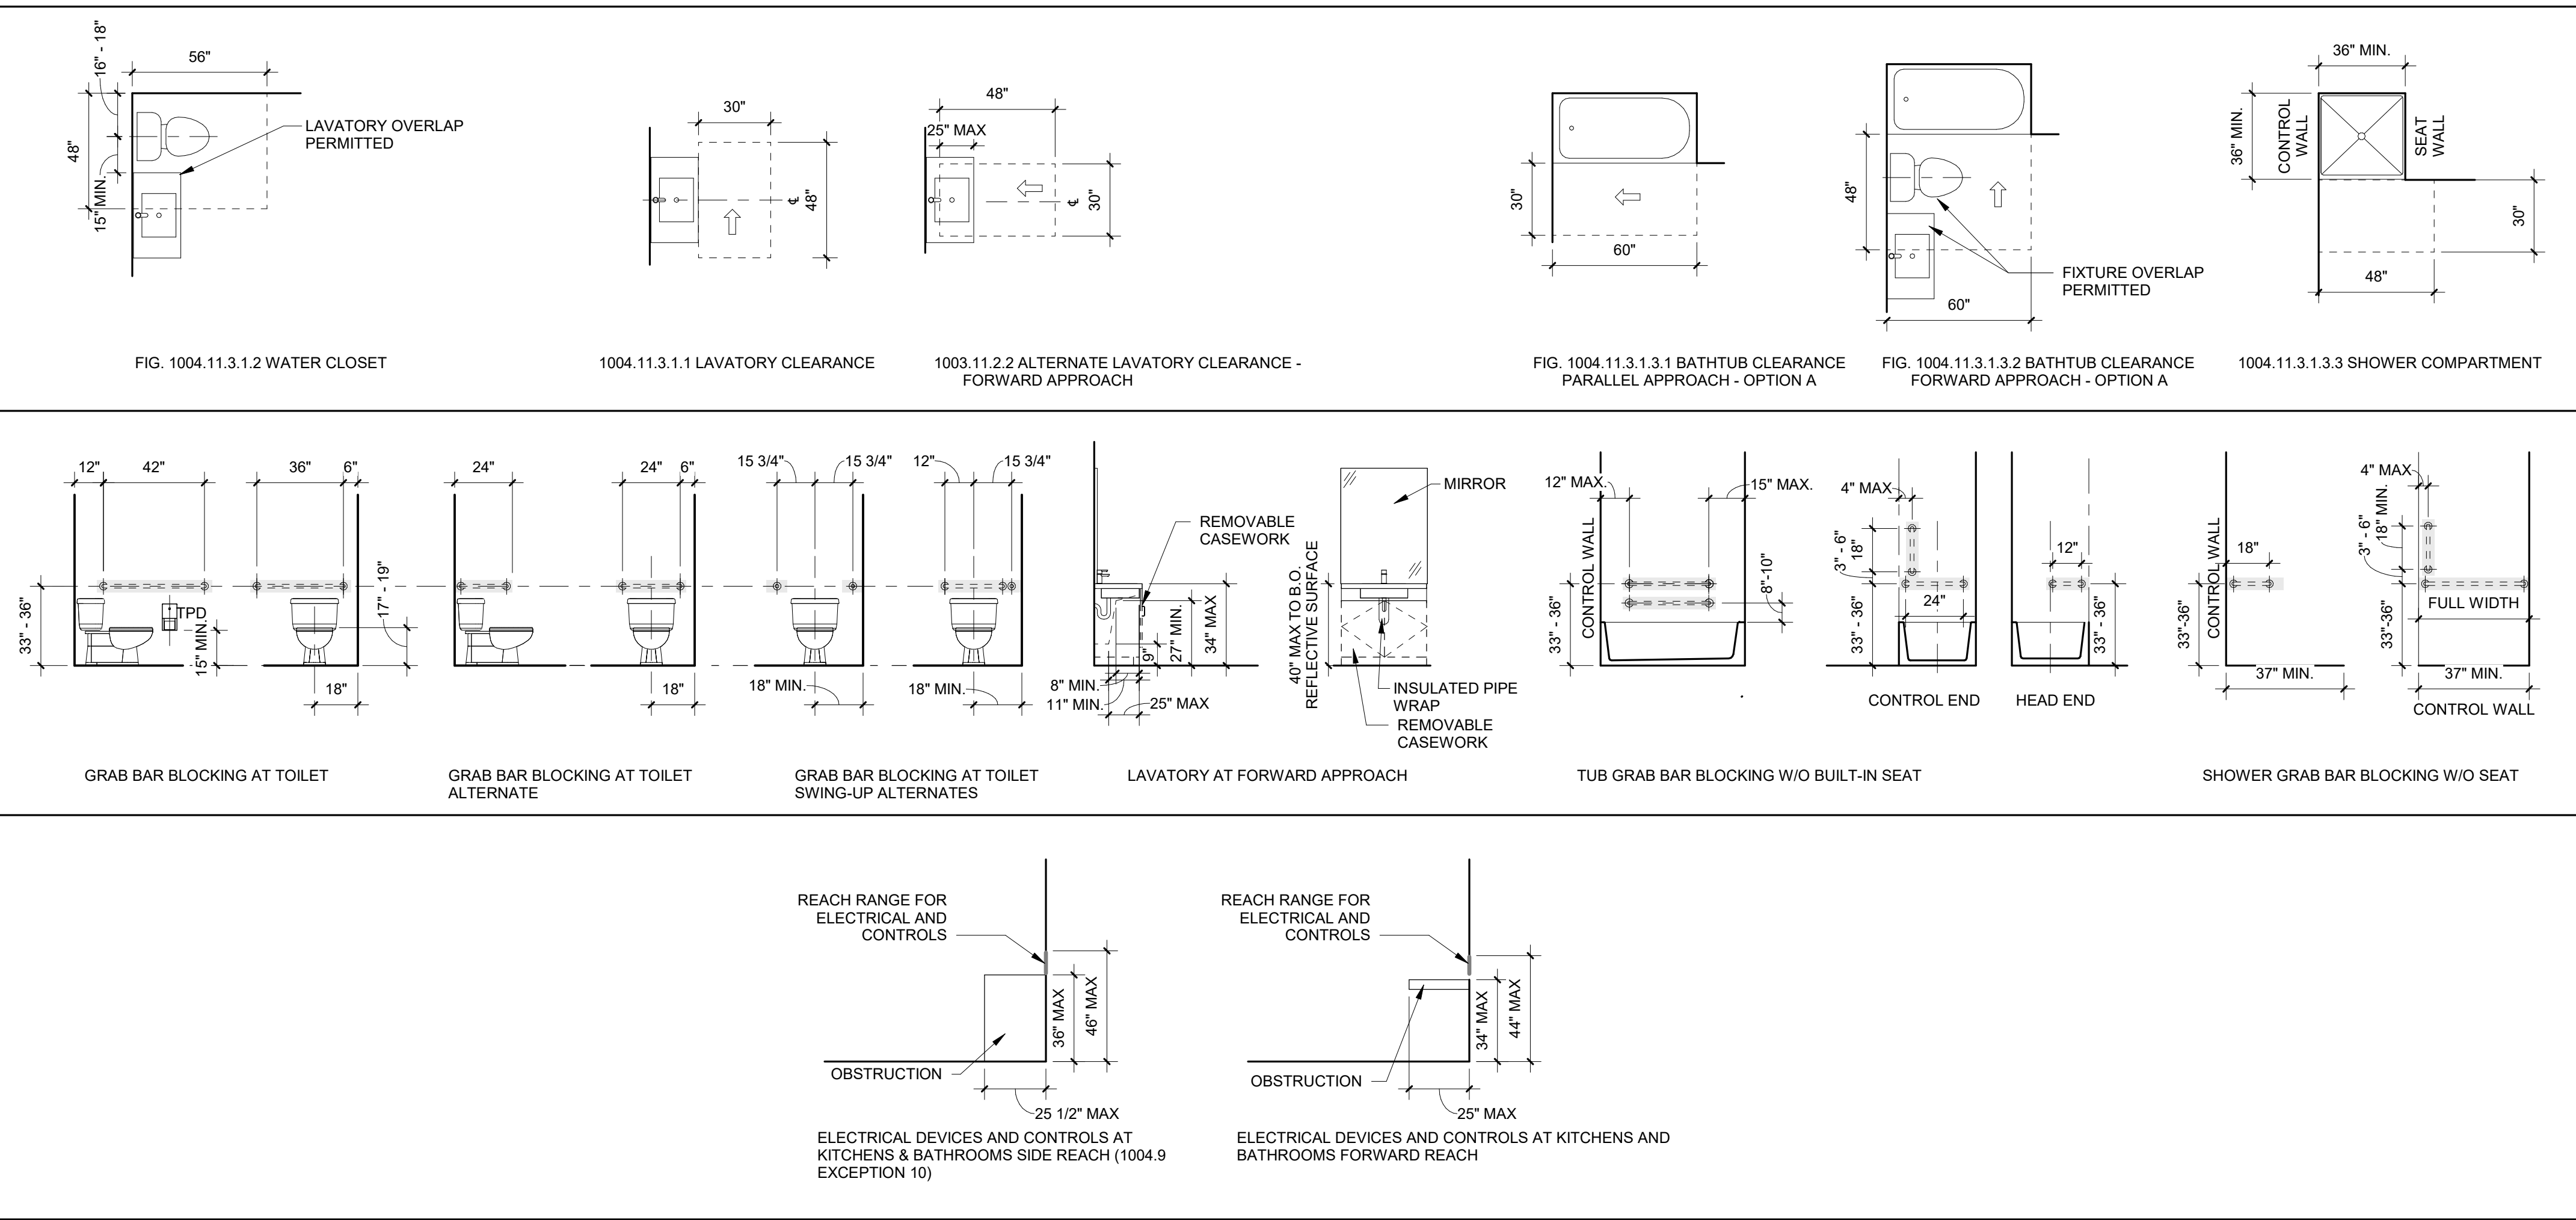

<h1>GENERAL SHEET NOTES</h1>	
<p>A. REFERENCE DETAILS FOR ASSEMBLIES NOT SHOWN HERE.</p> <p>B. SEE FINISH SCHEDULE, INTERIOR ELEVATIONS, AND DETAILS FOR SPECIAL CONDITIONS AND APPLIED WALL FINISHES.</p> <p>C. MAINTAIN FIRE RATING OF WALLS AROUND FIRE EXTINGUISHERS, CABINETS, AND OTHER RECESSED ITEMS.</p> <p>D. PROVIDE ACOUSTICAL SEALANT AT FLOOR / CEILING/ WALL TRANSITIONS, RECESSED BOXES, AND PENETRATIONS OF SOUND RATED ASSEMBLIES AND OTHER CONSTRUCTION AS REQUIRED TO ACHIEVE NOTED STC RATINGS.</p> <p>E. PROVIDE MOISTURE RESISTANT GYPSUM BOARD TYPICAL AT ALL RESTROOMS, BATHROOMS, AND KITCHEN WALLS.</p> <p>F. ALL FRAMING AND FINISHES OF INTERIOR WALLS TO EXTEND TO THE UNDERSIDE OF STRUCTURE ABOVE UNLESS NOTED OTHERWISE.</p> <p>G. WHERE PARTITIONS ARE SOUND RATED OR FIRE RATED AND INCLUDE PROPRIETARY MANUFACTURERS, NO SUBSTITUTIONS ARE ALLOWED.</p> <p>H. ALL WOOD IN CONTACT WITH CONCRETE OR MASONRY TO BE PRESSURE TREATED.</p> <p>I. AT WALLS WITH RESILIENT CHANNELS SEE DETAIL FOR ASSEMBLY DETAILS.</p> <p>J. WHERE ACOUSTIC WALL IS INDICATED, SEE ____ FOR ASSEMBLY DETAILS.</p>	
<h2>WALL TYPE SYMBOL</h2>	
<h2>WOOD FRAMING SIZES</h2>	
<p>0 = MTL FURRING, 7/8" OR AS INDICATED</p> <p>4 = 2" x 4"</p> <p>6 = 2" x 6"</p> <p>8 = 2" x 8"</p>	
<h2>ABBREVIATIONS</h2>	
GA	GYPSUM ASSOCIATION

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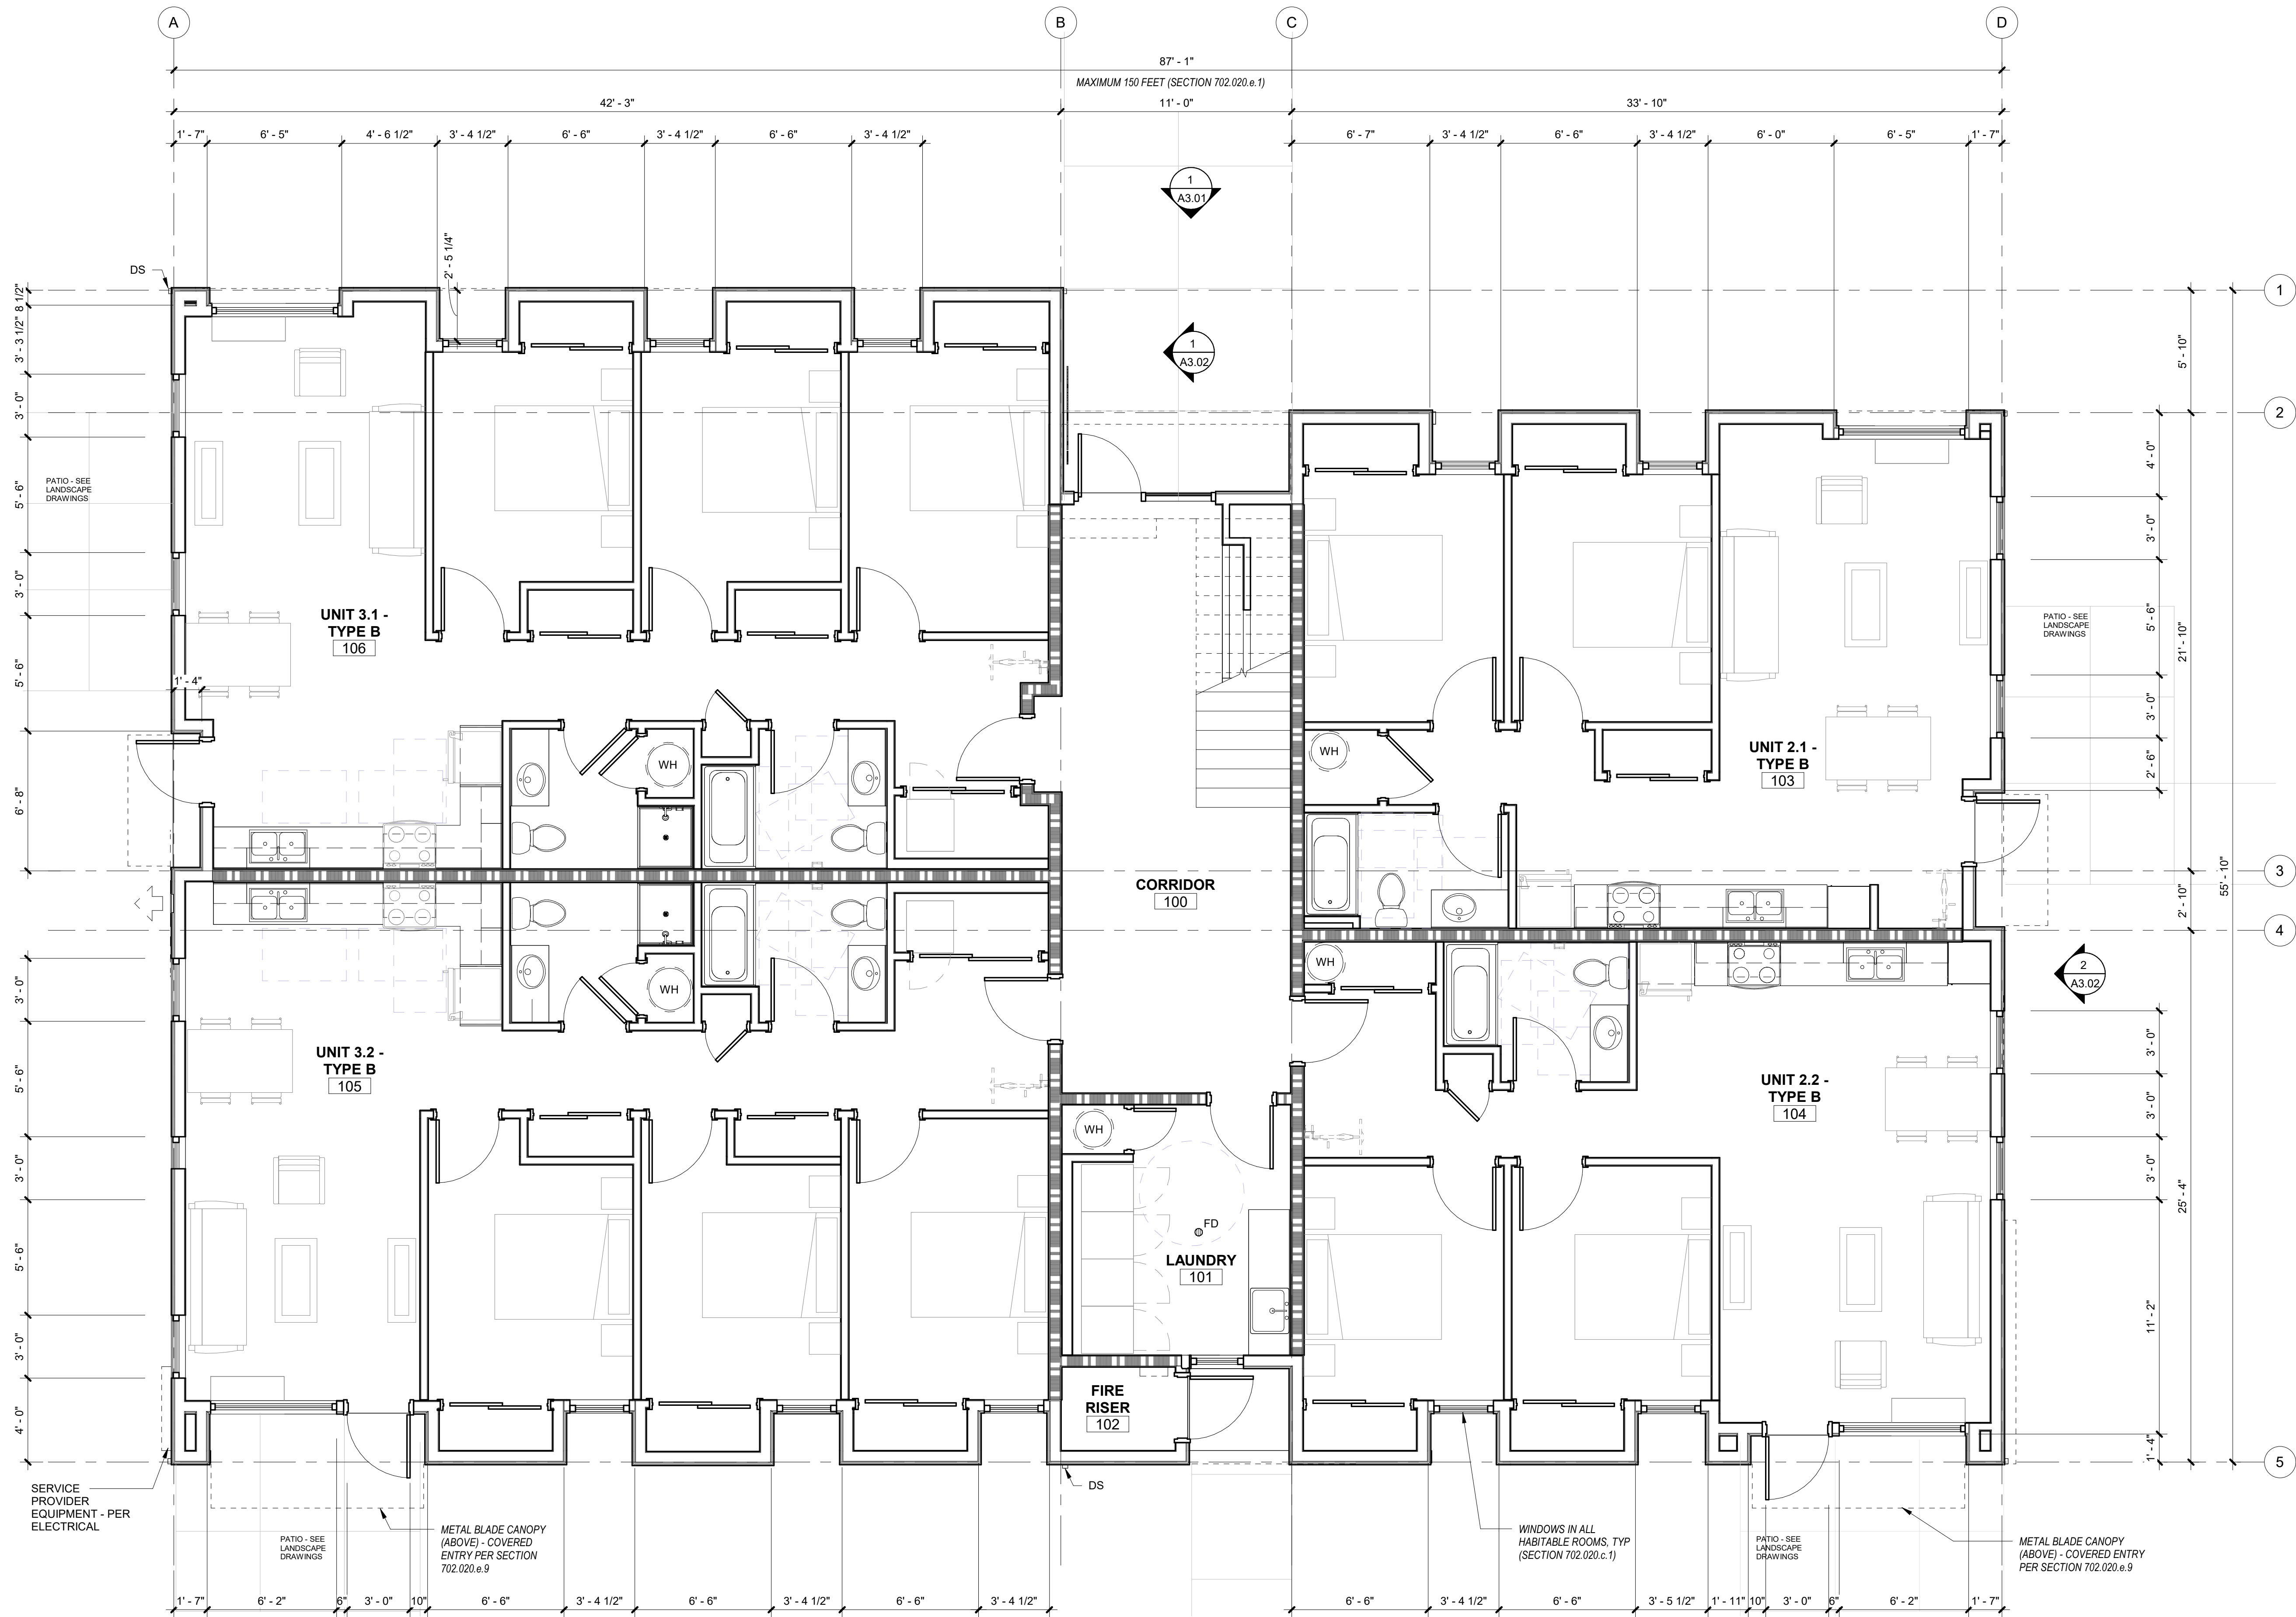
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NOT FOR CONSTRUCTION

CDP SALEM - BUILDING A

Job Number: 21031

5205 BATTLE CREEK RD SE
SALEM, OR 97306



1 FIRST FLOOR PLAN
1/4" = 1'-0"

GENERAL SHEET NOTES

- A. WALL DIMENSIONS ARE FROM FACE OF STUD OR CL OF COLUMN U.N.O.
- B. ALL EXTERIOR GRID LINES SHOWN ARE TO FACE OF SHEATHING U.N.O. ALL INTERIOR GRID LINES ARE TO FACE OF STUD U.N.O.
- C. ALL INTERIOR UNIT WALLS TO BE IW2-X.
- D. ALL DOOR AND WINDOW DIMENSIONS ARE TO CL OR OVERALL UNIT. REFERENCE SCHEDULES AND DOOR AND WINDOW TYPES
- E. REFERENCE STRUCTURAL DRAWINGS FOR GENERAL CONTROL JOINTS @ SLAB. COORDINATE FINAL LOCATIONS WITH ARCHITECT COMPATIBILITY WITH FLOOR FINISHES
- F. SEE DOOR SCHEDULE FOR DOOR TYPES AND INSTALLATION DETAILS CORRESPONDING TO DOOR NUMBERS
- G. SEE WINDOW SCHEDULE FOR WINDOW TYPES
- H. FOR FLOOR FINISHES, SEE A10.21 SCHEDULES & FINISH LEGENDS.
- I. WIRE SHELVING IN ALL BEDROOM CLOSETS
- J. M.E.P. INFORMATION PROVIDED FOR REFERENCE ONLY
- K. PROVIDE BLOCKING FOR FUTURE GRAB BARS AT ALL UNIT RESTROOMS WHERE GRAB BARS ARE NOT SHOWN IN PLAN, REF ACCESSIBILITY DIAGRAMS FOR LOCATIONS
- L. FIRE EXTINGUISHER TO BE PLACED IN PANTRY IN ALL UNITS
- M. DOWNSPOUTS PAINTED IN FIELD, RECTANGLE SHAPE AND SIZE PER PLUMBING AND CIVIL

LEGEND

REF A0.01 FOR GENERAL LEGENDS

- 1 HOUR RATED ASSEMBLY ELEMENT ABOVE
- ASPHALT SHINGLE ROOF
- 2x3 FLAT STYPE DOWNSPOUT
- FLOOR DRAIN
- WATER HEATER WITH FLOOR DRAIN BELOW - SEE PLUMBING DWGS

KEYNOTES 07-02

LAND USE SUBMISSION ISSUE 03.11.2022 DATE

Drawing:


FIRST FLOOR PLAN

Sheet No: Building A -

A2.11

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1 SECOND FLOOR PLAN
1/4" = 1'-0"

GENERAL SHEET NOTES

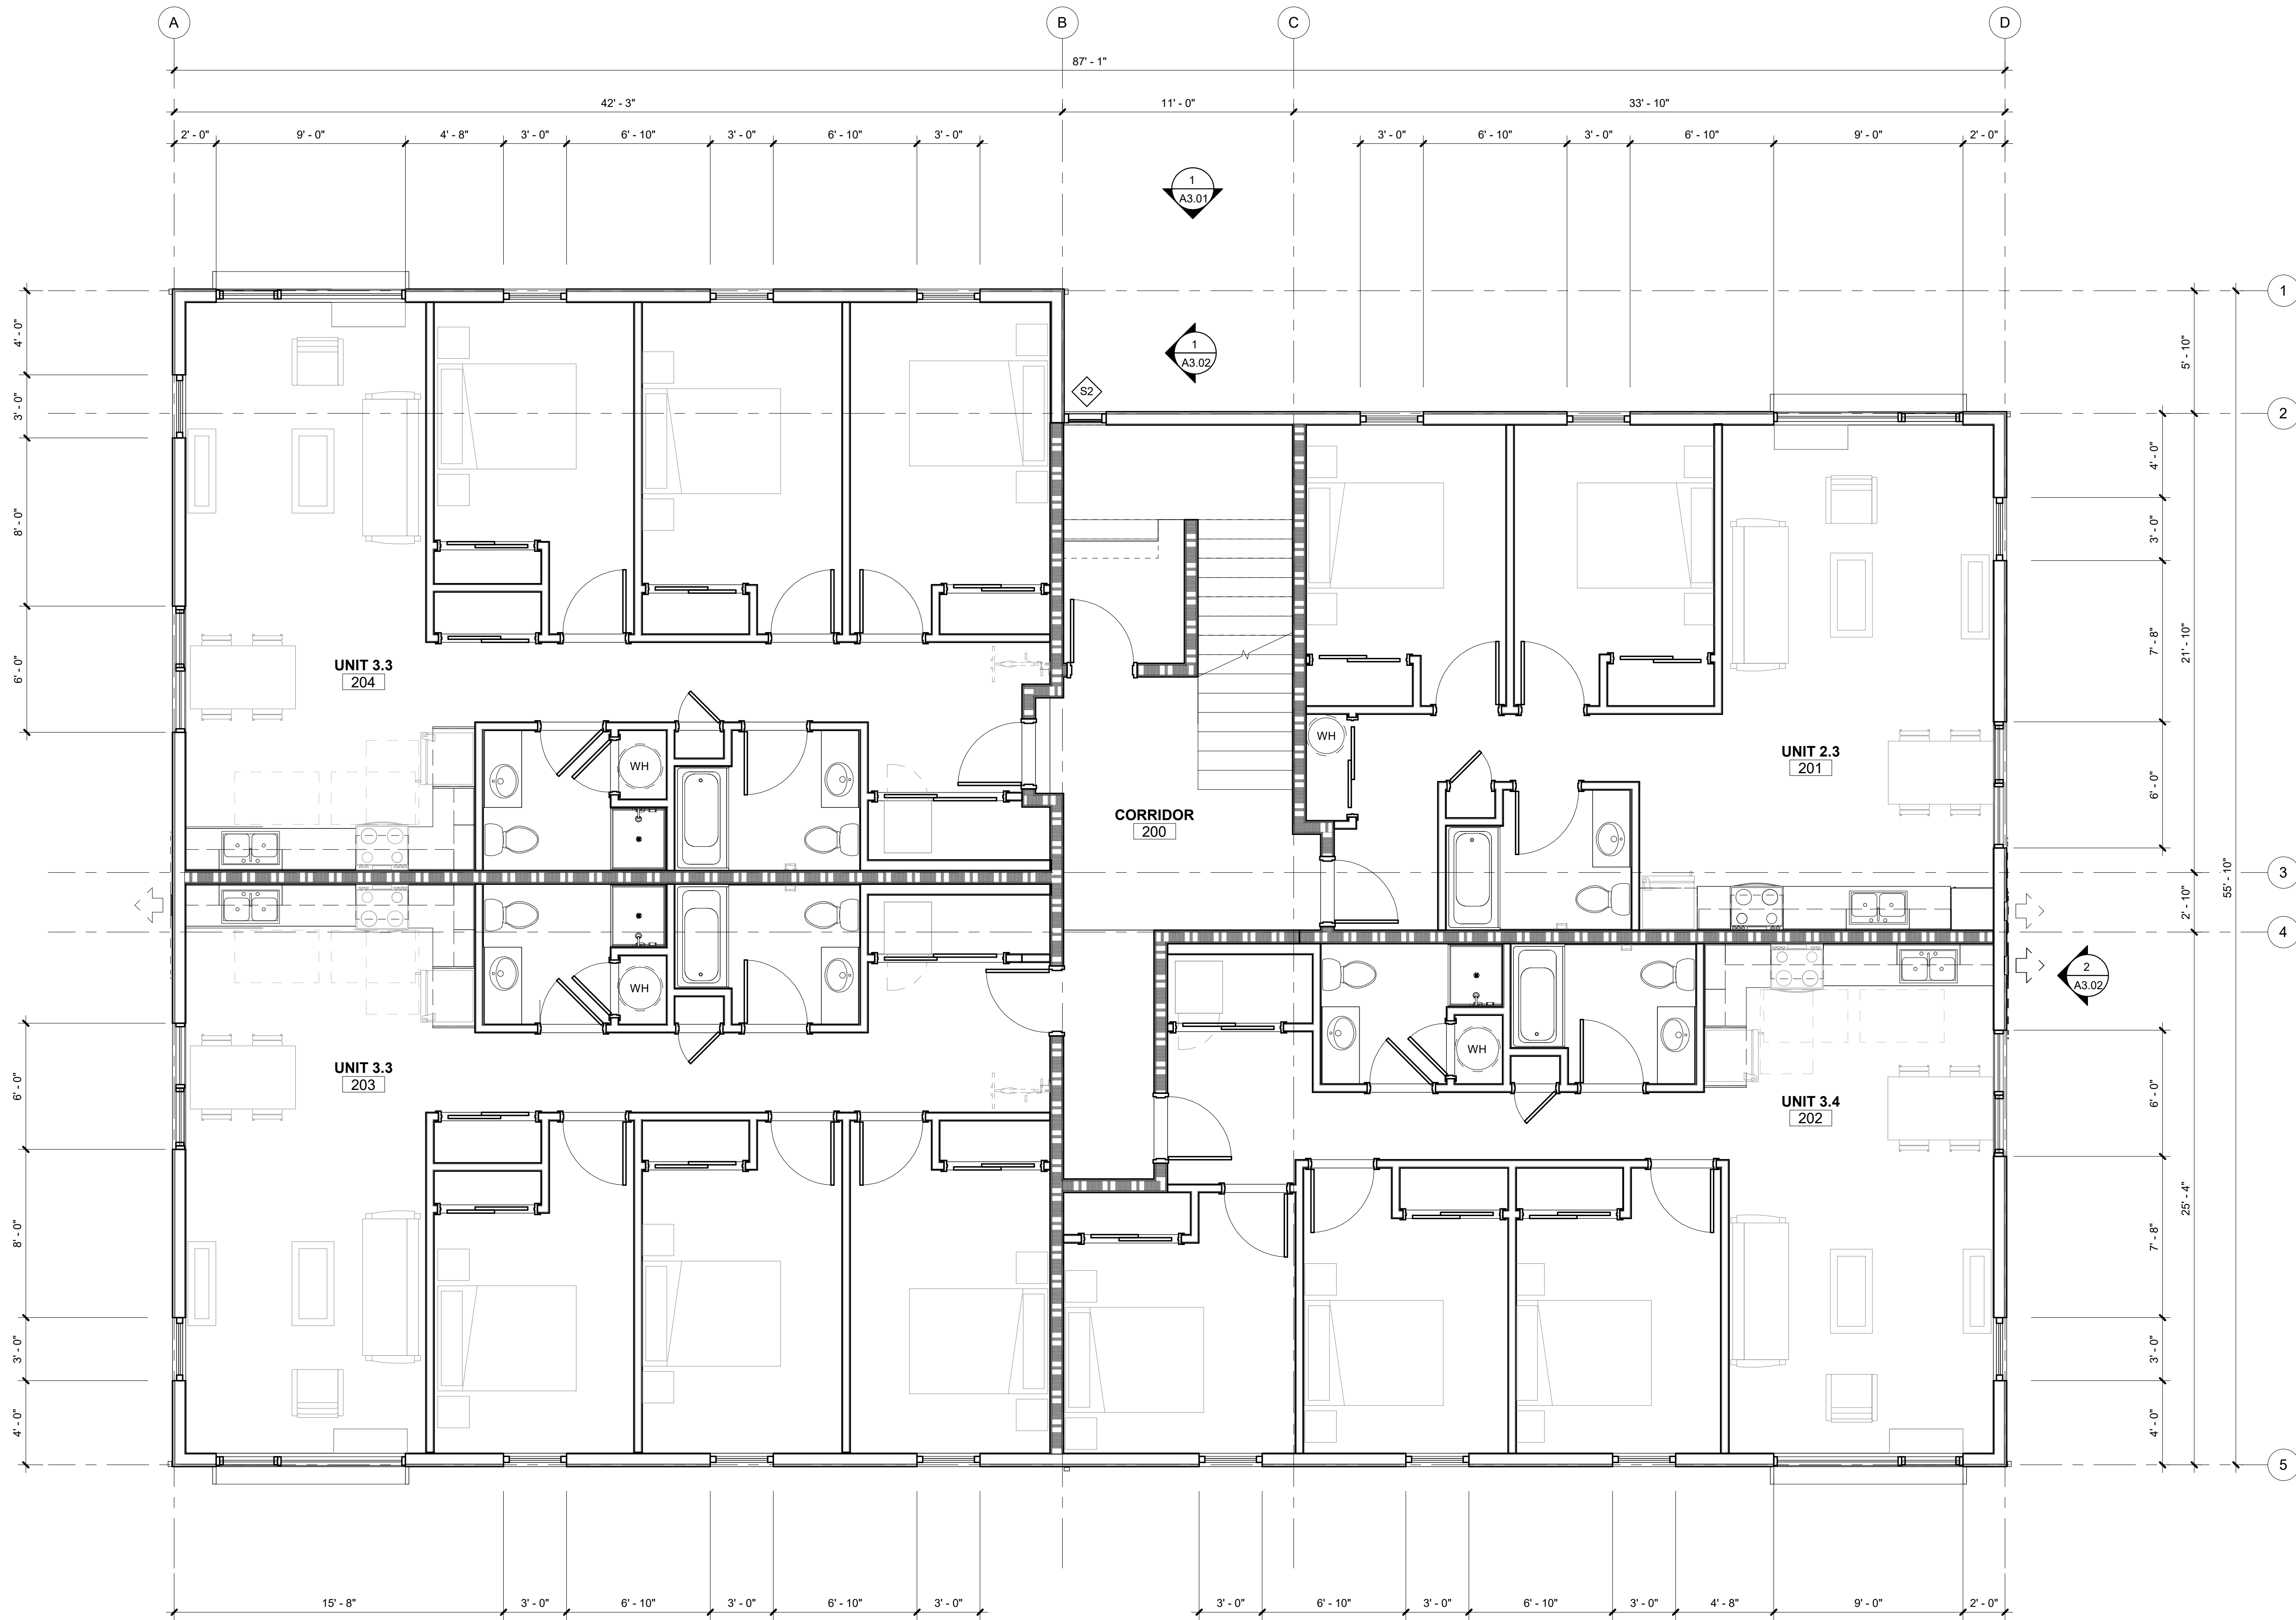A. WALL DIMENSIONS ARE FROM FACE OF STUD OR CL OF COLUMN U.N.O.
 B. ALL EXTERIOR GRID LINES SHOWN ARE TO FACE OF SHEATHING U.N.O. ALL INTERIOR GRID LINES ARE TO FACE OF STUD U.N.O.
 C. ALL INTERIOR UNIT WALLS TO BE 1/2" X 1/2" X 1/2" OVERALL UNIT. REFERENCE SCHEDULES AND DOOR AND WINDOW TYPES.
 D. ALL DOOR AND WINDOW DIMENSIONS ARE TO CL OR OVERALL UNIT. REFERENCE SCHEDULES AND DOOR AND WINDOW TYPES.
 E. REFERENCE STRUCTURAL DRAWINGS FOR GENERAL CONTROL JOINTS @ SLAB. COORDINATE FINAL LOCATIONS WITH ARCHITECT COMPATIBILITY WITH FLOOR FINISHES.
 F. SEE DOOR SCHEDULE FOR DOOR TYPES AND INSTALLATION DETAILS CORRESPONDING TO DOOR NUMBERS.
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LEGEND REF A0.01 FOR GENERAL LEGENDS

1 HOUR RATED ASSEMBLY ELEMENT ABOVE

ASPHALT SHINGLE ROOF

2x3 FLAT STYPE DOWNSPOUT

FLOOR DRAIN

WATER HEATER WITH FLOOR DRAIN BELOW - SEE PLUMBING DWGS

KEYNOTES 07-02

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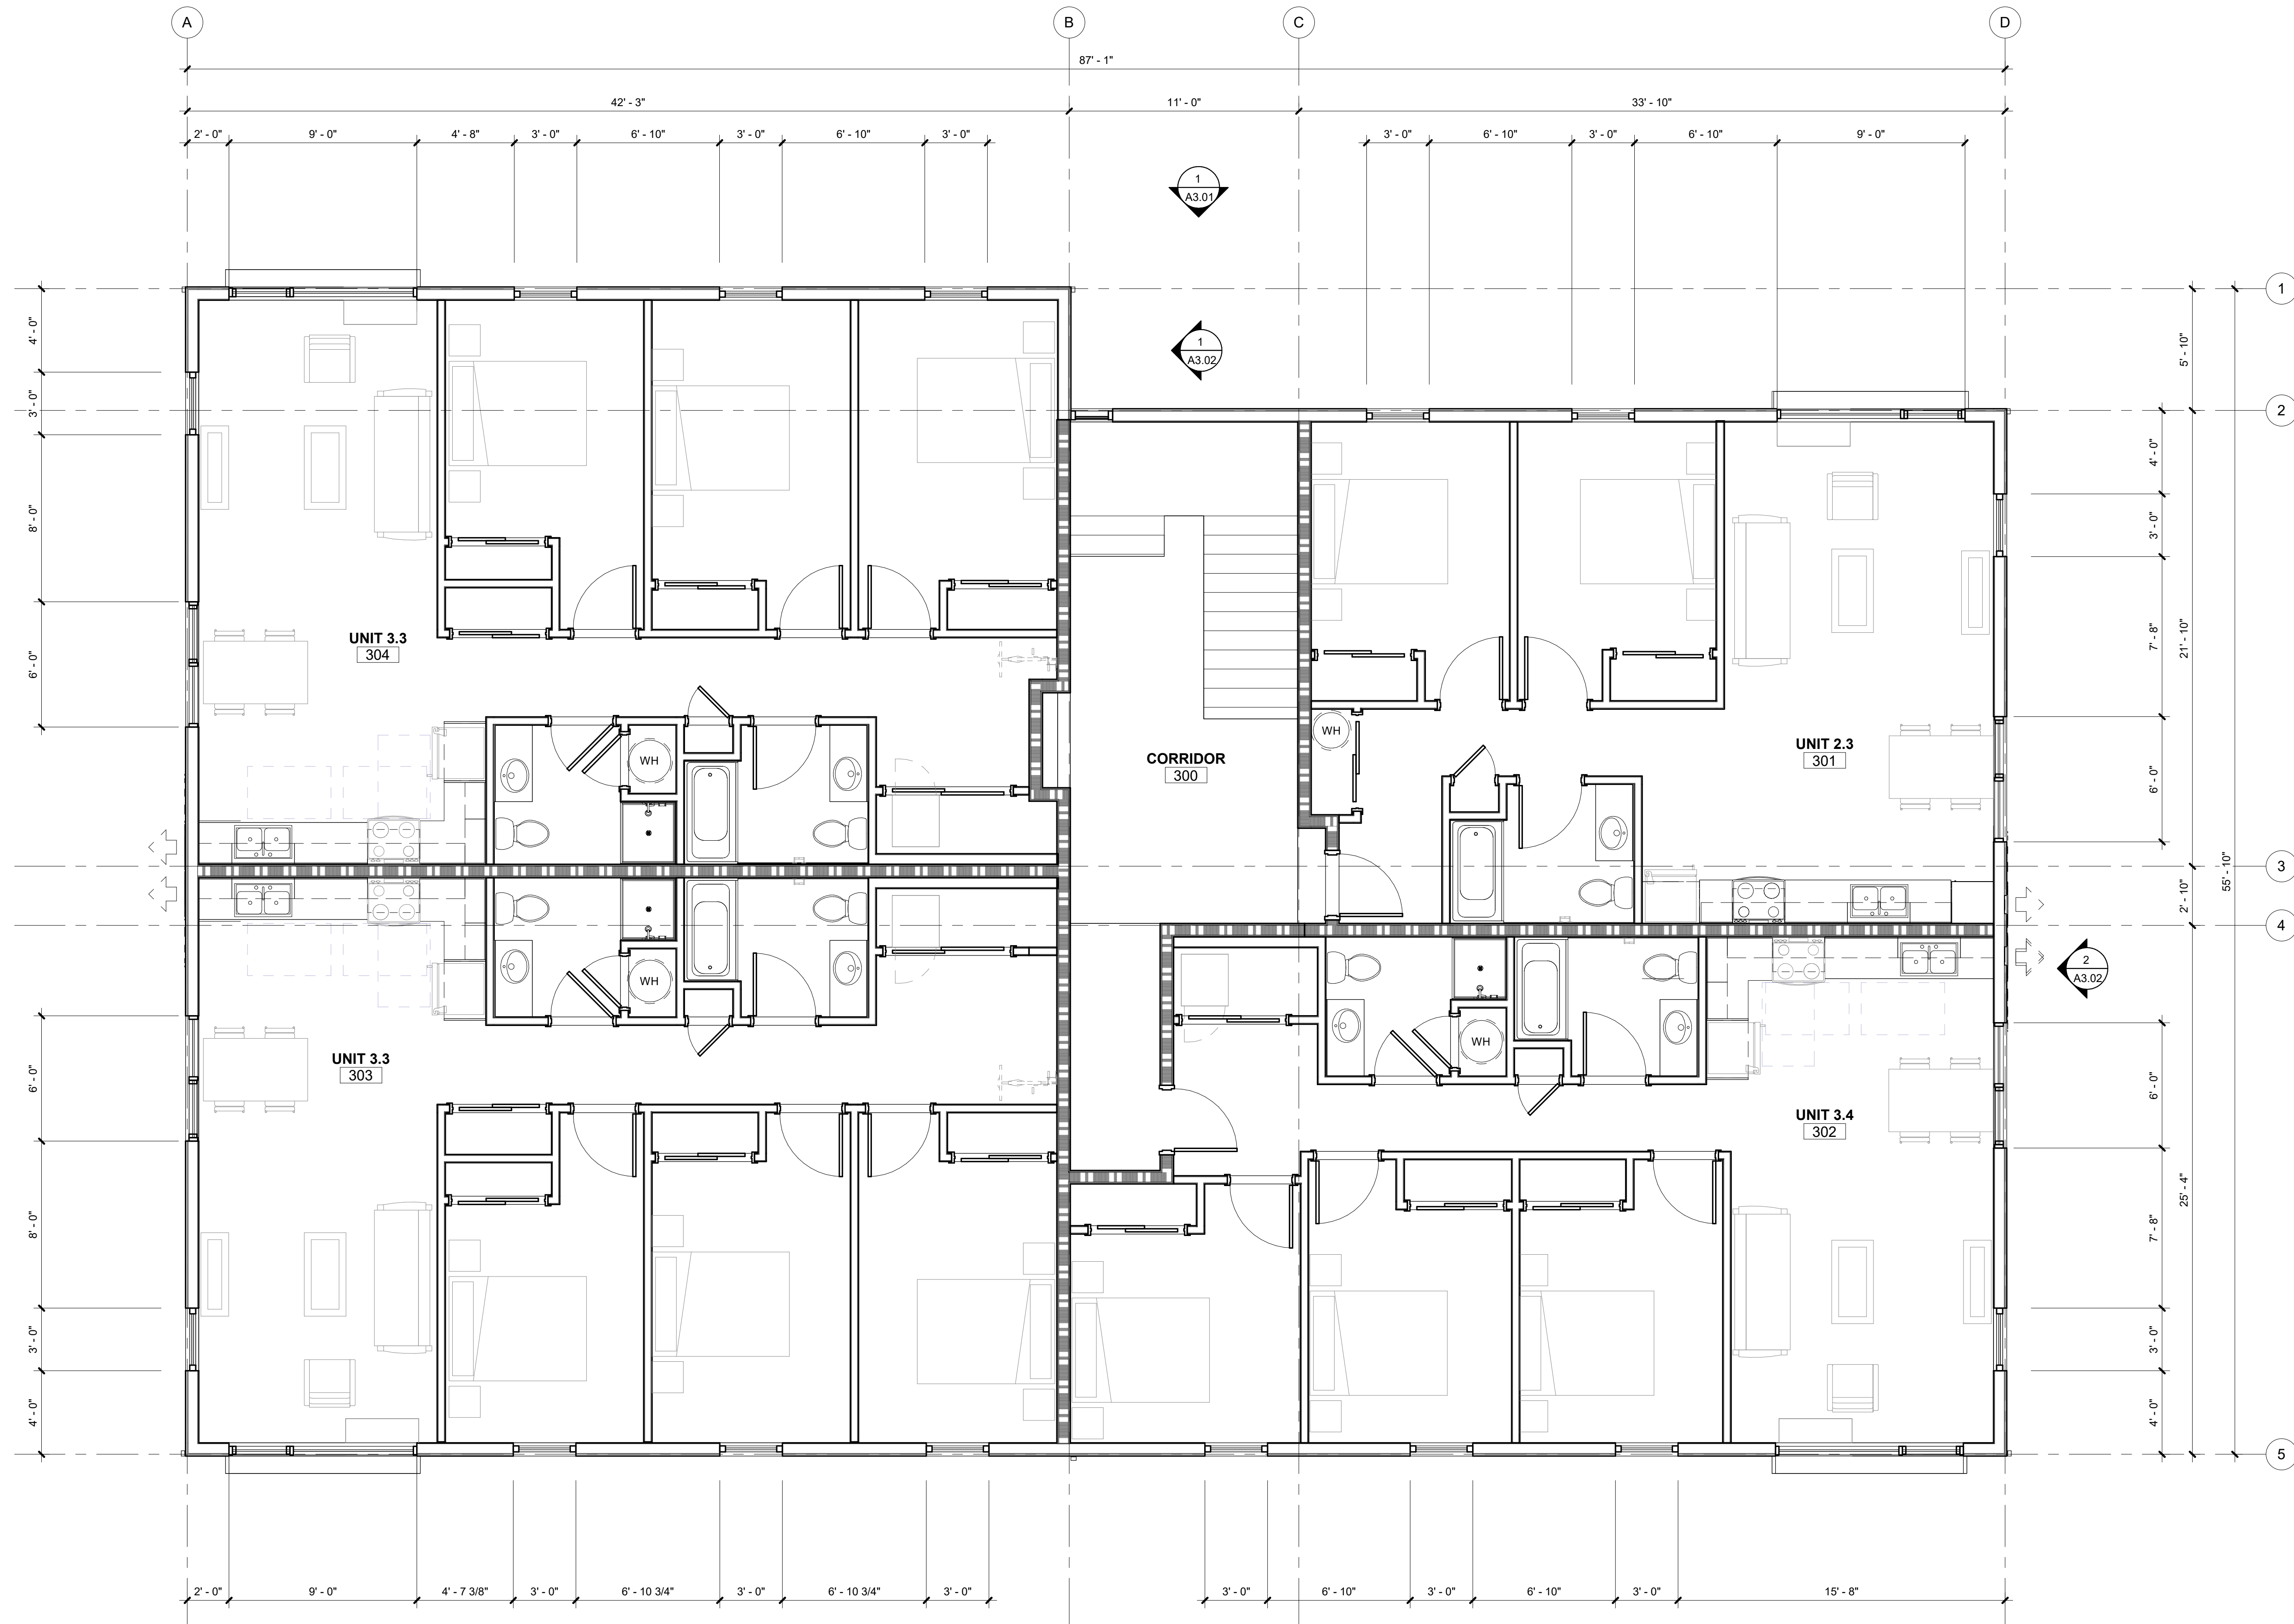
Drawing:
SECOND FLOOR PLAN

Sheet No:
Building A -

A2.12

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1 THIRD FLOOR PLAN
1/4" = 1'-0"

GENERAL SHEET NOTES

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B. ALL EXTERIOR GRID LINES SHOWN ARE TO FACE OF SHEATHING U.N.O. ALL INTERIOR GRID LINES ARE TO FACE OF STUD U.N.O.

C. ALL INTERIOR UNIT WALLS TO BE 1/2" X 1/2" X 1/2" CMU.

D. ALL DOOR AND WINDOW DIMENSIONS ARE TO CL OR OVERALL UNIT. REFERENCE SCHEDULES AND DOOR AND WINDOW TYPES.

E. REFERENCE STRUCTURAL DRAWINGS FOR GENERAL CONTROL JOINTS @ SLAB. COORDINATE FINAL LOCATIONS WITH ARCHITECT COMPATIBILITY WITH FLOOR FINISHES.

F. SEE DOOR SCHEDULE FOR DOOR TYPES AND INSTALLATION DETAILS CORRESPONDING TO DOOR NUMBERS.

G. SEE WINDOW SCHEDULE FOR WINDOW TYPES.

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LEGEND
REF A0.01 FOR GENERAL LEGENDS

1 HOUR RATED ASSEMBLY

ELEMENT ABOVE

R-1 ASPHALT SHINGLE ROOF

DS

2x3 FLAT STYPE DOWNSPOUT

FD

FLOOR DRAIN

WH

WATER HEATER WITH FLOOR DRAIN BELOW - SEE PLUMBING DWGS

KEYNOTES
07-02

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Job Number: 21031
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SALEM, OR 97306




LAND USE SUBMISSION ISSUE 03.11.2022 DATE

Drawing: THIRD FLOOR PLAN

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SEE MECHANICAL DRAWINGS FOR LOCATION OF
MECHANICAL UNITS AND ROOF PENETRATIONS

1 ROOF PLAN
1/4" = 1'-0"

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Drawing:

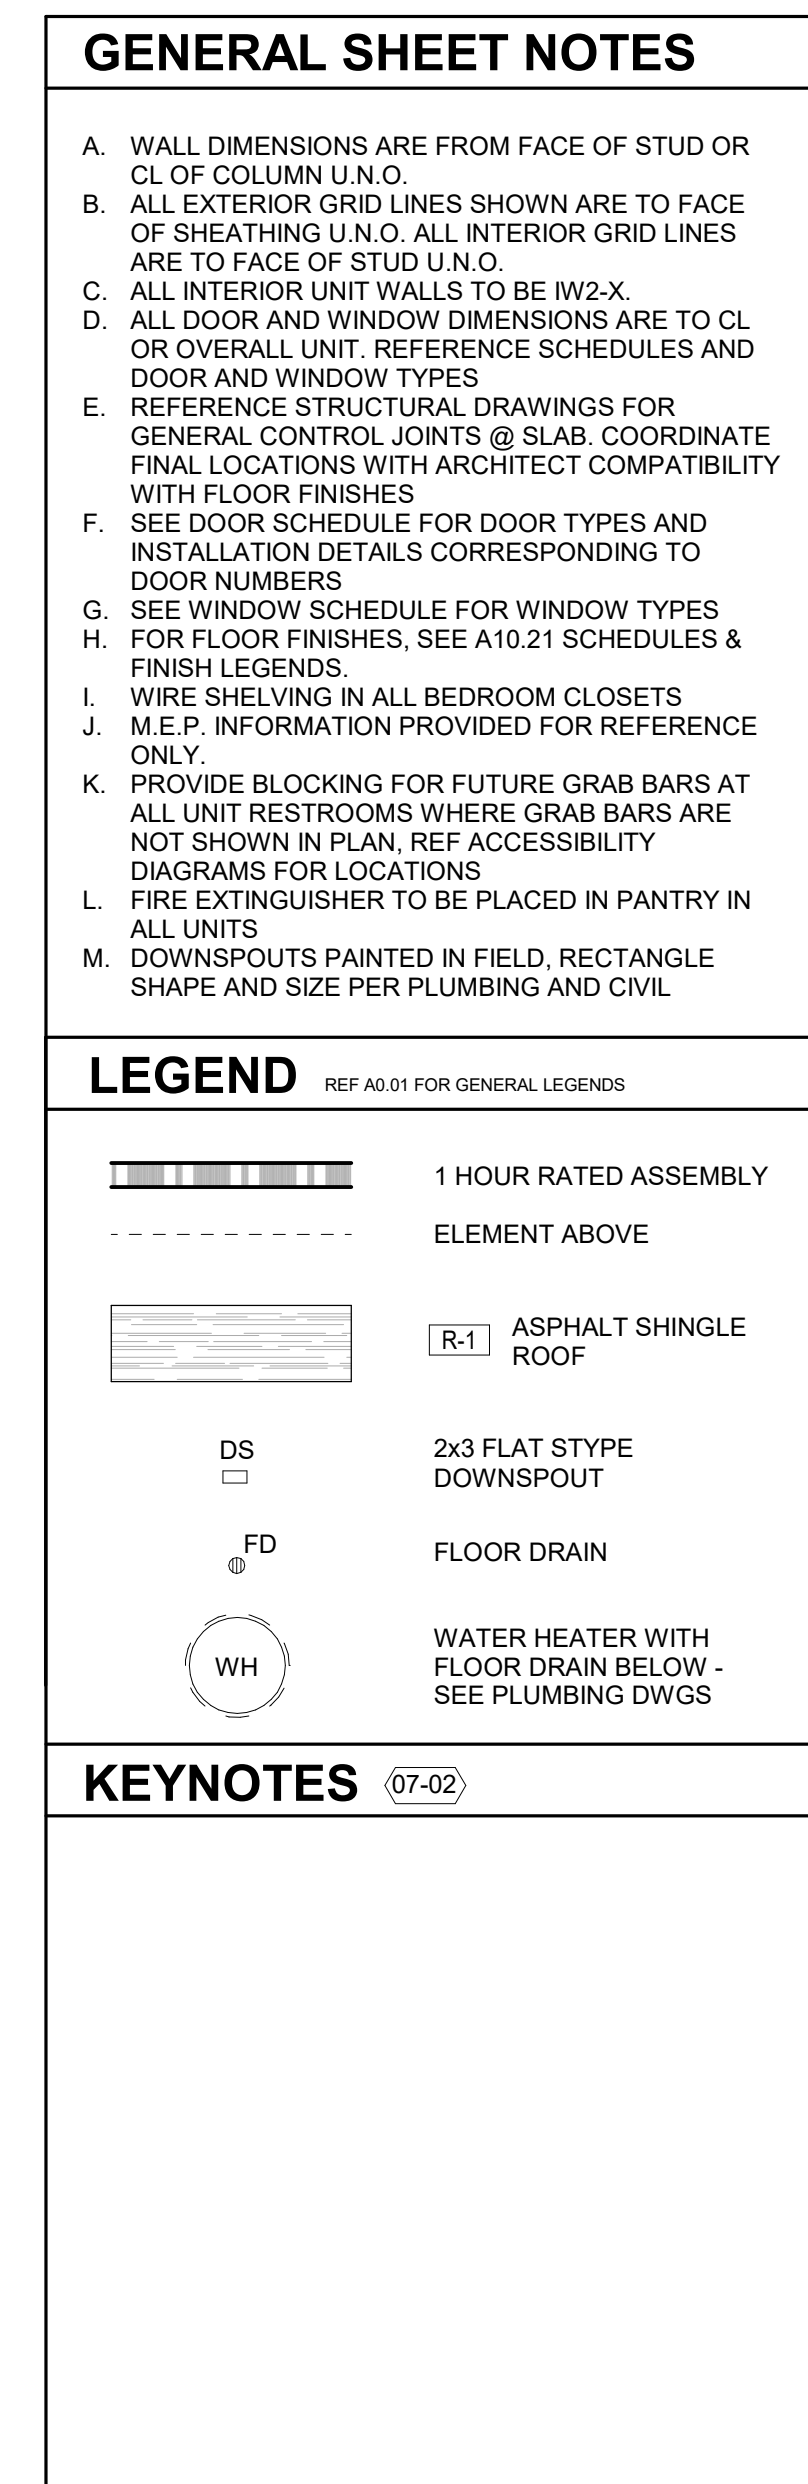ROOF

Sheet No:
Building A -

A2.21

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1 BUILDING ELEVATION
1/4" = 1'-0"



2 BUILDING ELEVATION
1/4" = 1'-0"

GENERAL SHEET NOTES

- REFERENCE FLOOR PLANS FOR DOOR AND WINDOW LOCATIONS.
- REFERENCE ELECTRICAL FOR EXTERIOR LIGHT APPLICATIONS.
- CONFIRM ALL EXHAUST OPENINGS ARE MINIMUM 3'-0" FROM OPERABLE OPENINGS.
- ALL EXTERIOR LOUVERS TO BE PAINTED TO MATCH THE EXTERIOR FINISH IT PENETRATES.
- PREFINISHED 22 GAUGE FORMED SHEET METAL WINDOW TRIM, JAMB, AND SILL AT WINDOWS.
- PREFINISHED 22 GAUGE METAL THROUGH WALL FLASHING AT WINDOW HEADS.
- TRANSITION BETWEEN FIBER CEMENT SIDING PROFILES TO FOLLOW MANUFACTURER DETAILING AND REQUIREMENTS.

LEGEND

- | | |
|--|---|
| | SHINGLE SIDING
PRODUCT: SHINGLE SIDING,
STRAIGHT EDGE PANEL
COLOR: TBD, LIGHT |
| | ASPHALT SHINGLE ROOF
PRODUCT: TBD
COLOR: TBD |
| | FLAT METAL PANEL
PRODUCT: TBD
FINISH: BLACK |
| | FLAT METAL PANEL, PERFORATED
PRODUCT: TBD
FINISH: BLACK |
| | VERTICAL WOOD SIDING
PRODUCT: TBD
FINISH: TBD |
| | CONCRETE STEM WALL |
| | X-VENT |
| | PTHP (BEYOND) |

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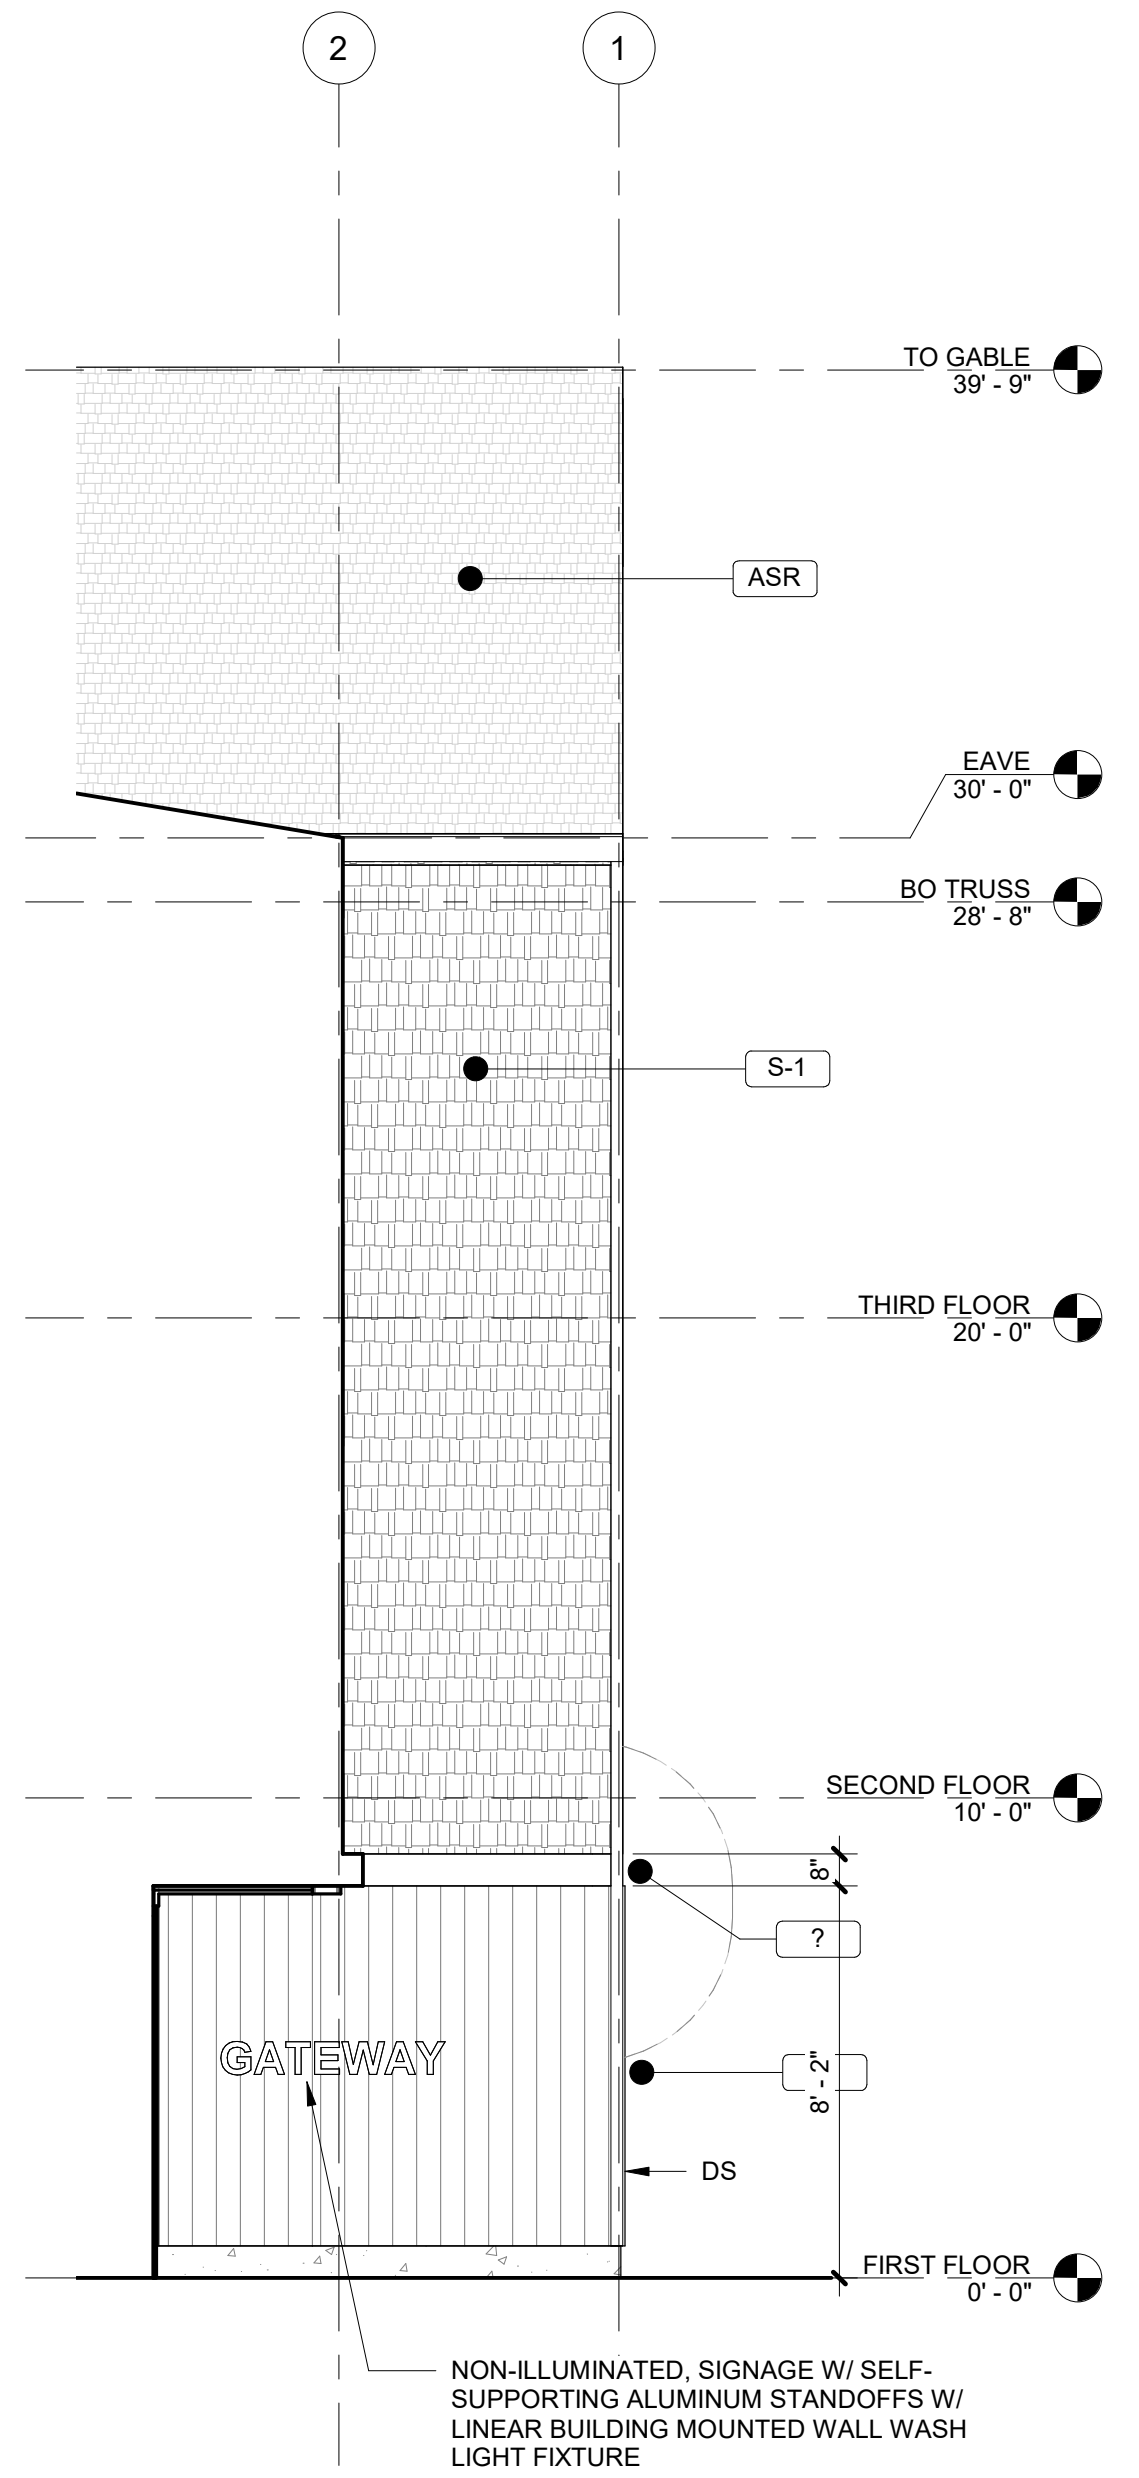
DATE

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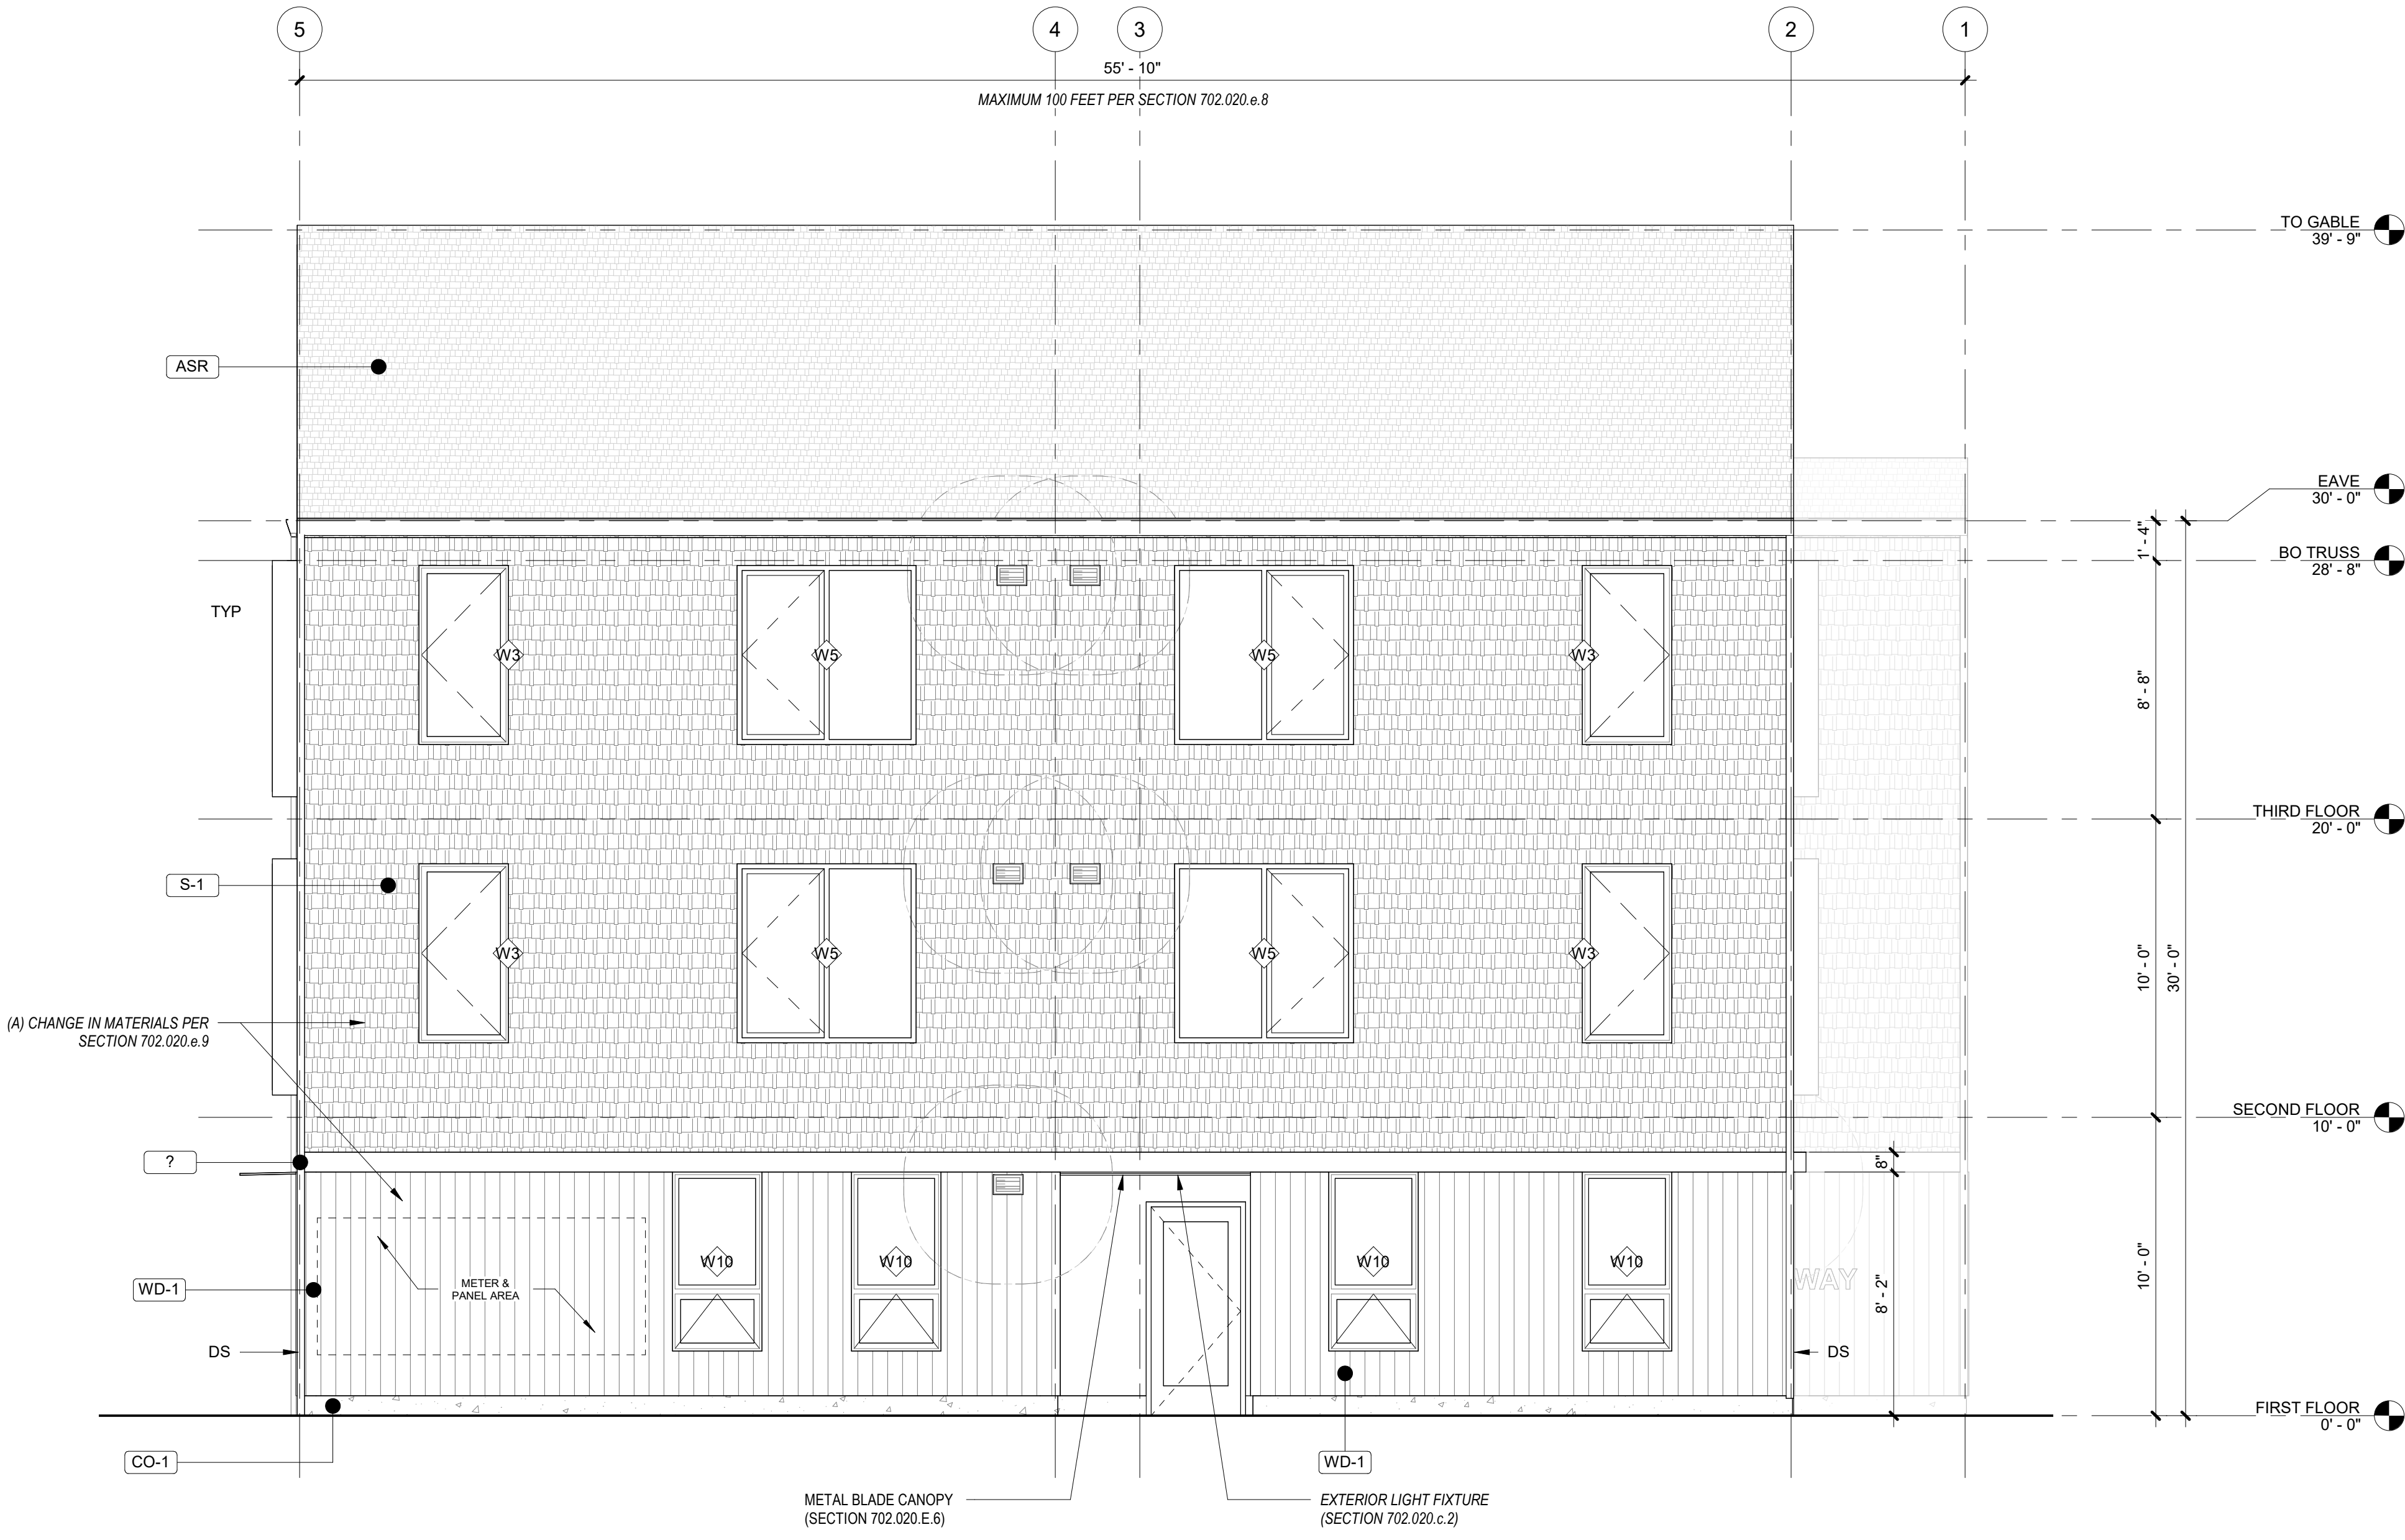
EXTERIOR
ELEVATIONS

Sheet No:
Building A -

A3.01



1 BUILDING ELEVATION
1/4" = 1'-0"



2 BUILDING ELEVATION
1/4" = 1'-0"



3 BUILDING ELEVATION
1/4" = 1'-0"

GENERAL SHEET NOTES

- REFERENCE FLOOR PLANS FOR DOOR AND WINDOW LOCATIONS.
- REFERENCE ELECTRICAL FOR EXTERIOR LIGHT APPLICATIONS.
- CONFIRM ALL EXHAUST OPENINGS ARE MINIMUM 3'-0" FROM OPERABLE OPENINGS.
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- TRANSITION BETWEEN FIBER CEMENT SIDING PROFILES TO FOLLOW MANUFACTURER DETAILING AND REQUIREMENTS.

LEGEND

	SHINGLE SIDING PRODUCT: SHINGLE SIDING, STRAIGHT EDGE PANEL COLOR: TBD, LIGHT
	ASPHALT SHINGLE ROOF PRODUCT: TBD COLOR: TBD
	FLAT METAL PANEL PRODUCT: TBD FINISH: BLACK
	FLAT METAL PANEL, PERFORATED PRODUCT: TBD FINISH: BLACK
	VERTICAL WOOD SIDING PRODUCT: TBD FINISH: TBD
	CONCRETE STEM WALL
	X-VENT
	PTHP (BEYOND)

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03.11.2022

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Drawing:

EXTERIOR
ELEVATIONS

Sheet No:
Building A -

A3.02

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BUILDING FACING COURTYARD 1


MATERIALS



VERTICAL WOOD SIDING
PRODUCT: TBD
FINISH: TBD




SHINGLE SIDING
PRODUCT: SHINGLE SIDING,
STRAIGHT EDGE PANEL
FINISH: TBD, LIGHT

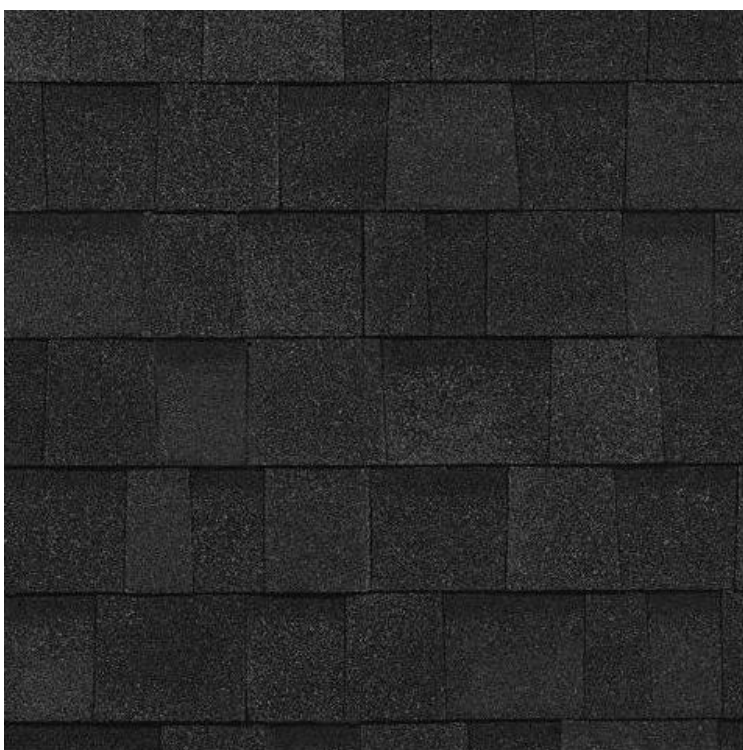

ASPHALT SHINGLE ROOF
PRODUCT: TBD
FINISH: TBD, DARK



FLAT METAL PANEL
PRODUCT: TBD
FINISH: TBD, DARK

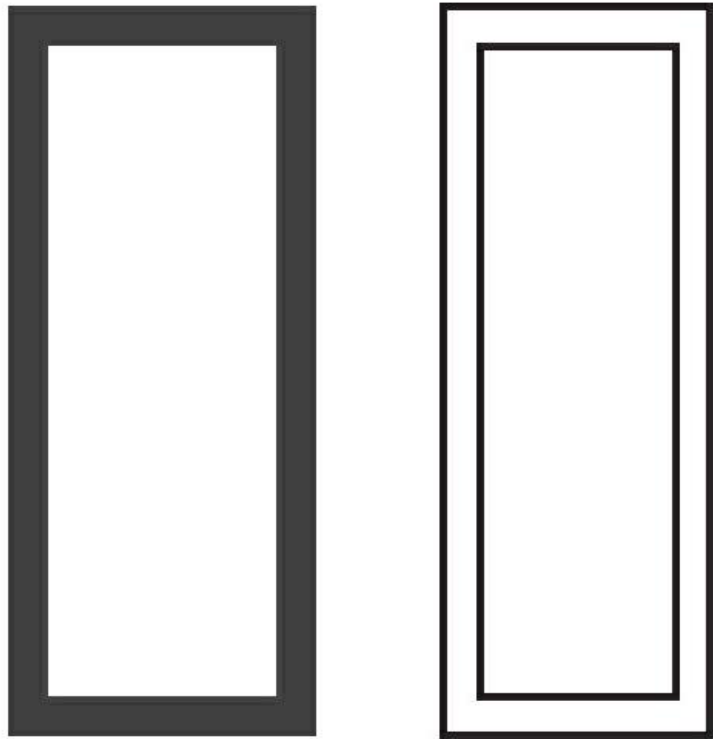

VINYL WINDOWS
PRODUCT: VPI ENDURANCE
FINISH: TBD, LIGHT & DARK



PATH FROM PARKING TO COURTYARD



BUILDING PATIOS



BUILDINGS ALONG SALAL ST.

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* SITE AND LANDSCAPING SHOWN FOR REFERENCE ONLY. SEE CIVIL AND LANDSCAPE DRAWINGS FOR FULL DESIGN.

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Drawing:

RENDERINGS


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Building A -

A3.10

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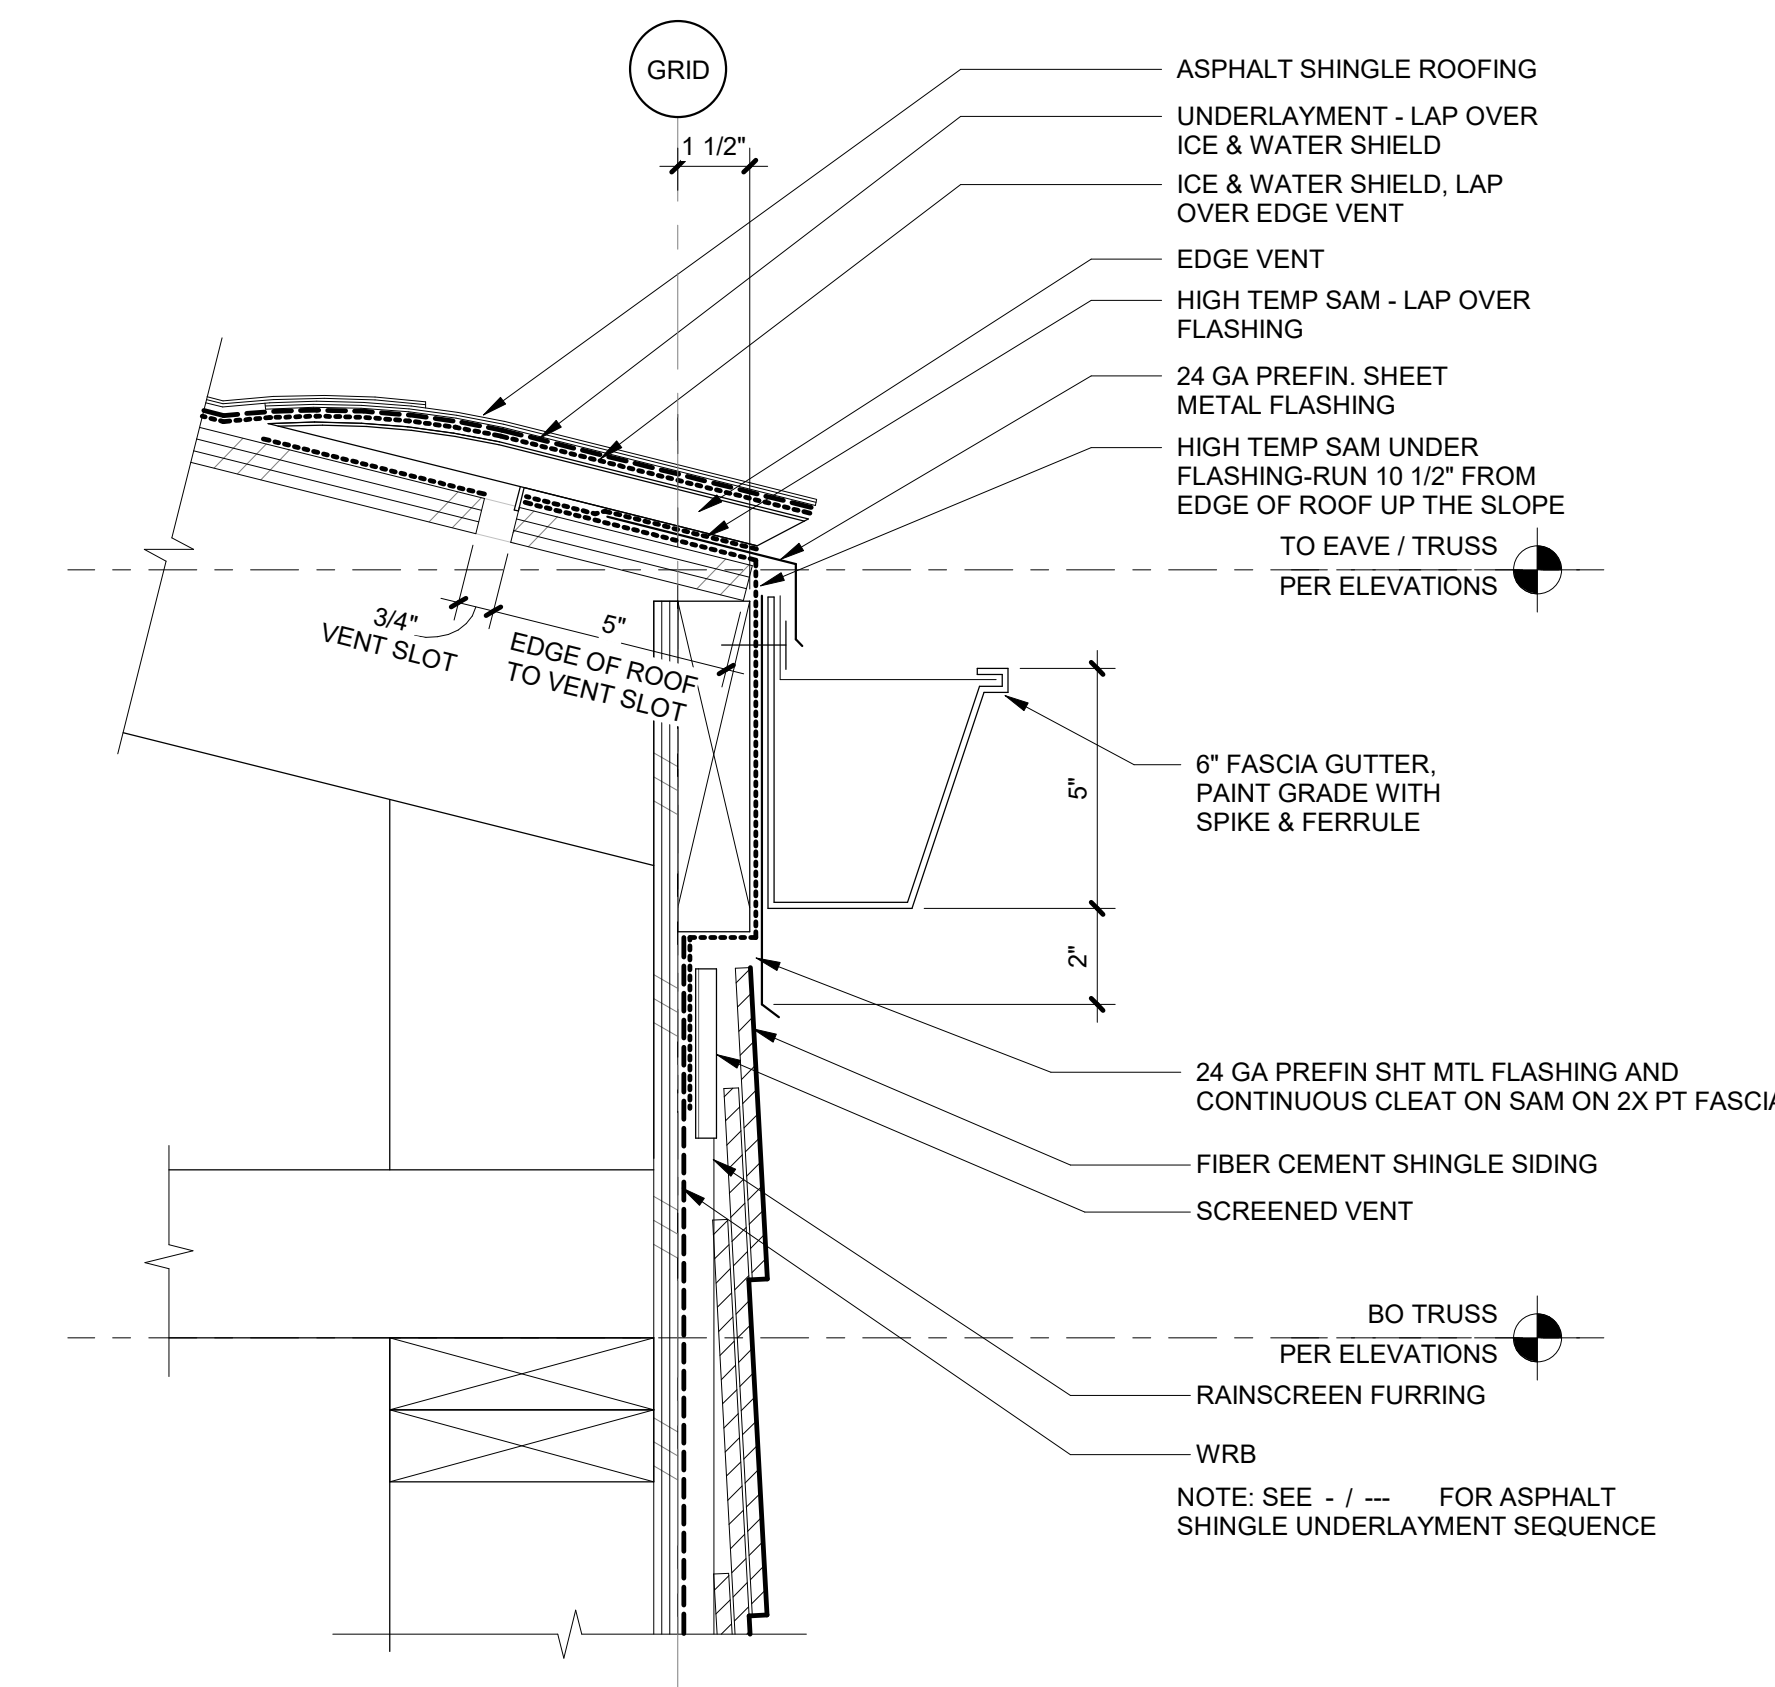
Drawing:

WALL SECTIONS


Sheet No:
Building A -

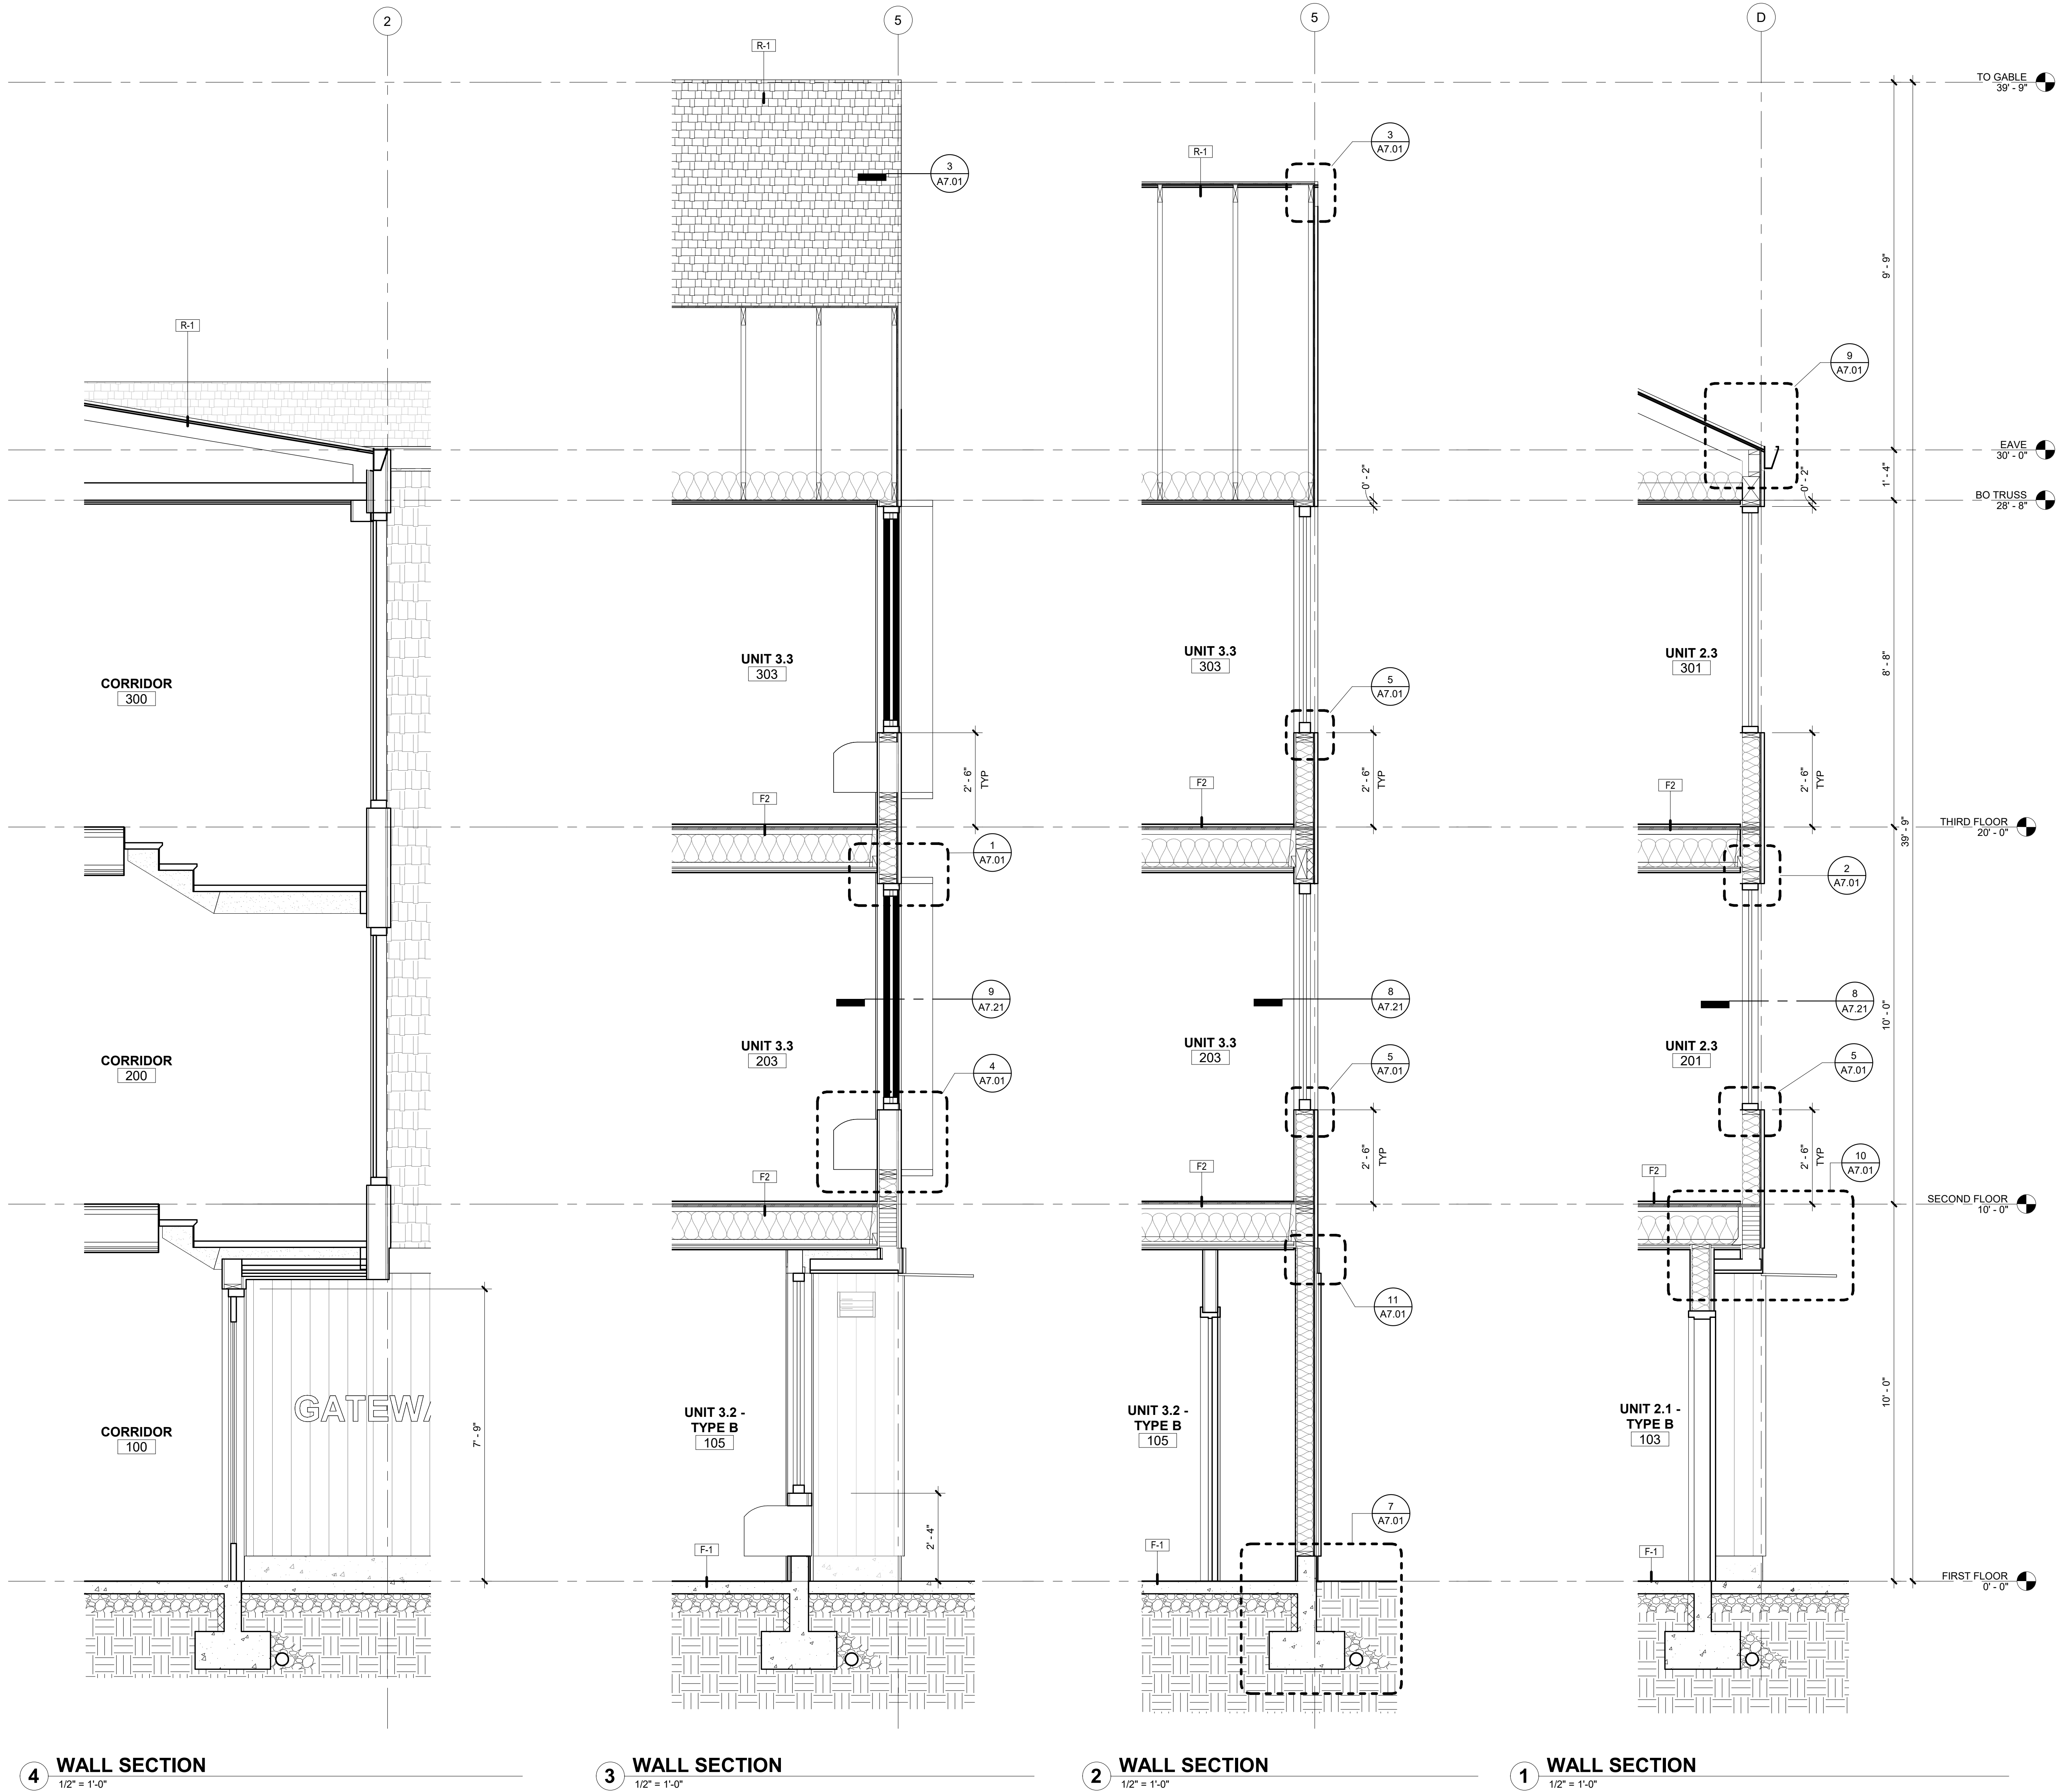A5.01


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9 TYPICAL EAVE




10 METAL BLADE CANOPY

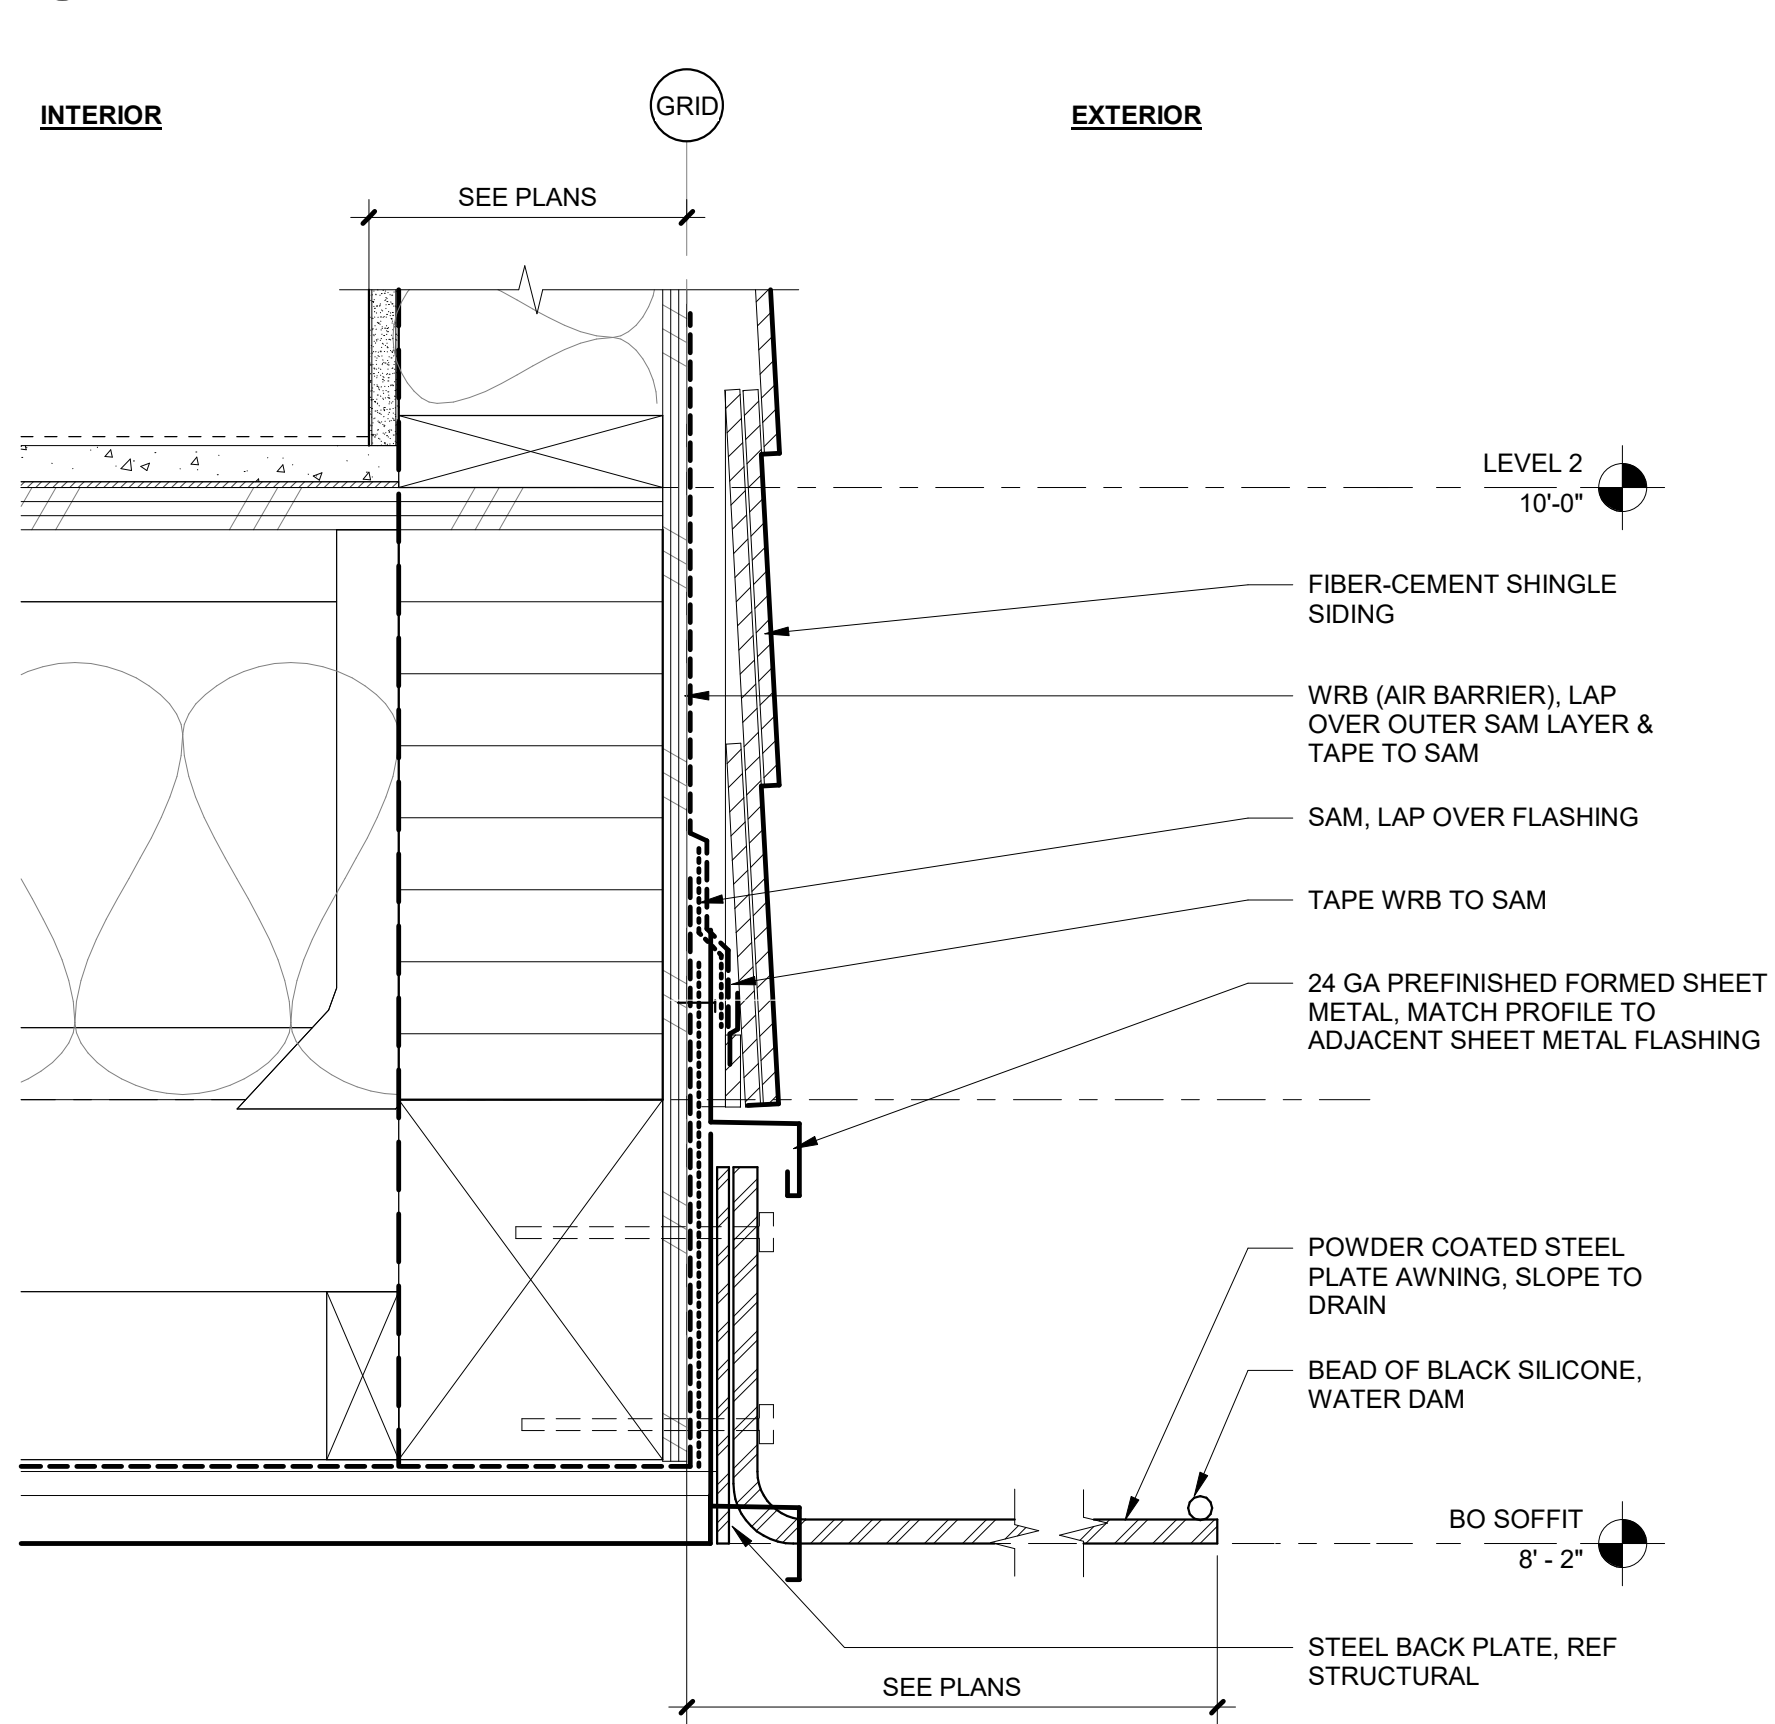

11 WOOD SIDING TO FIBER CEMENT SHINGLE

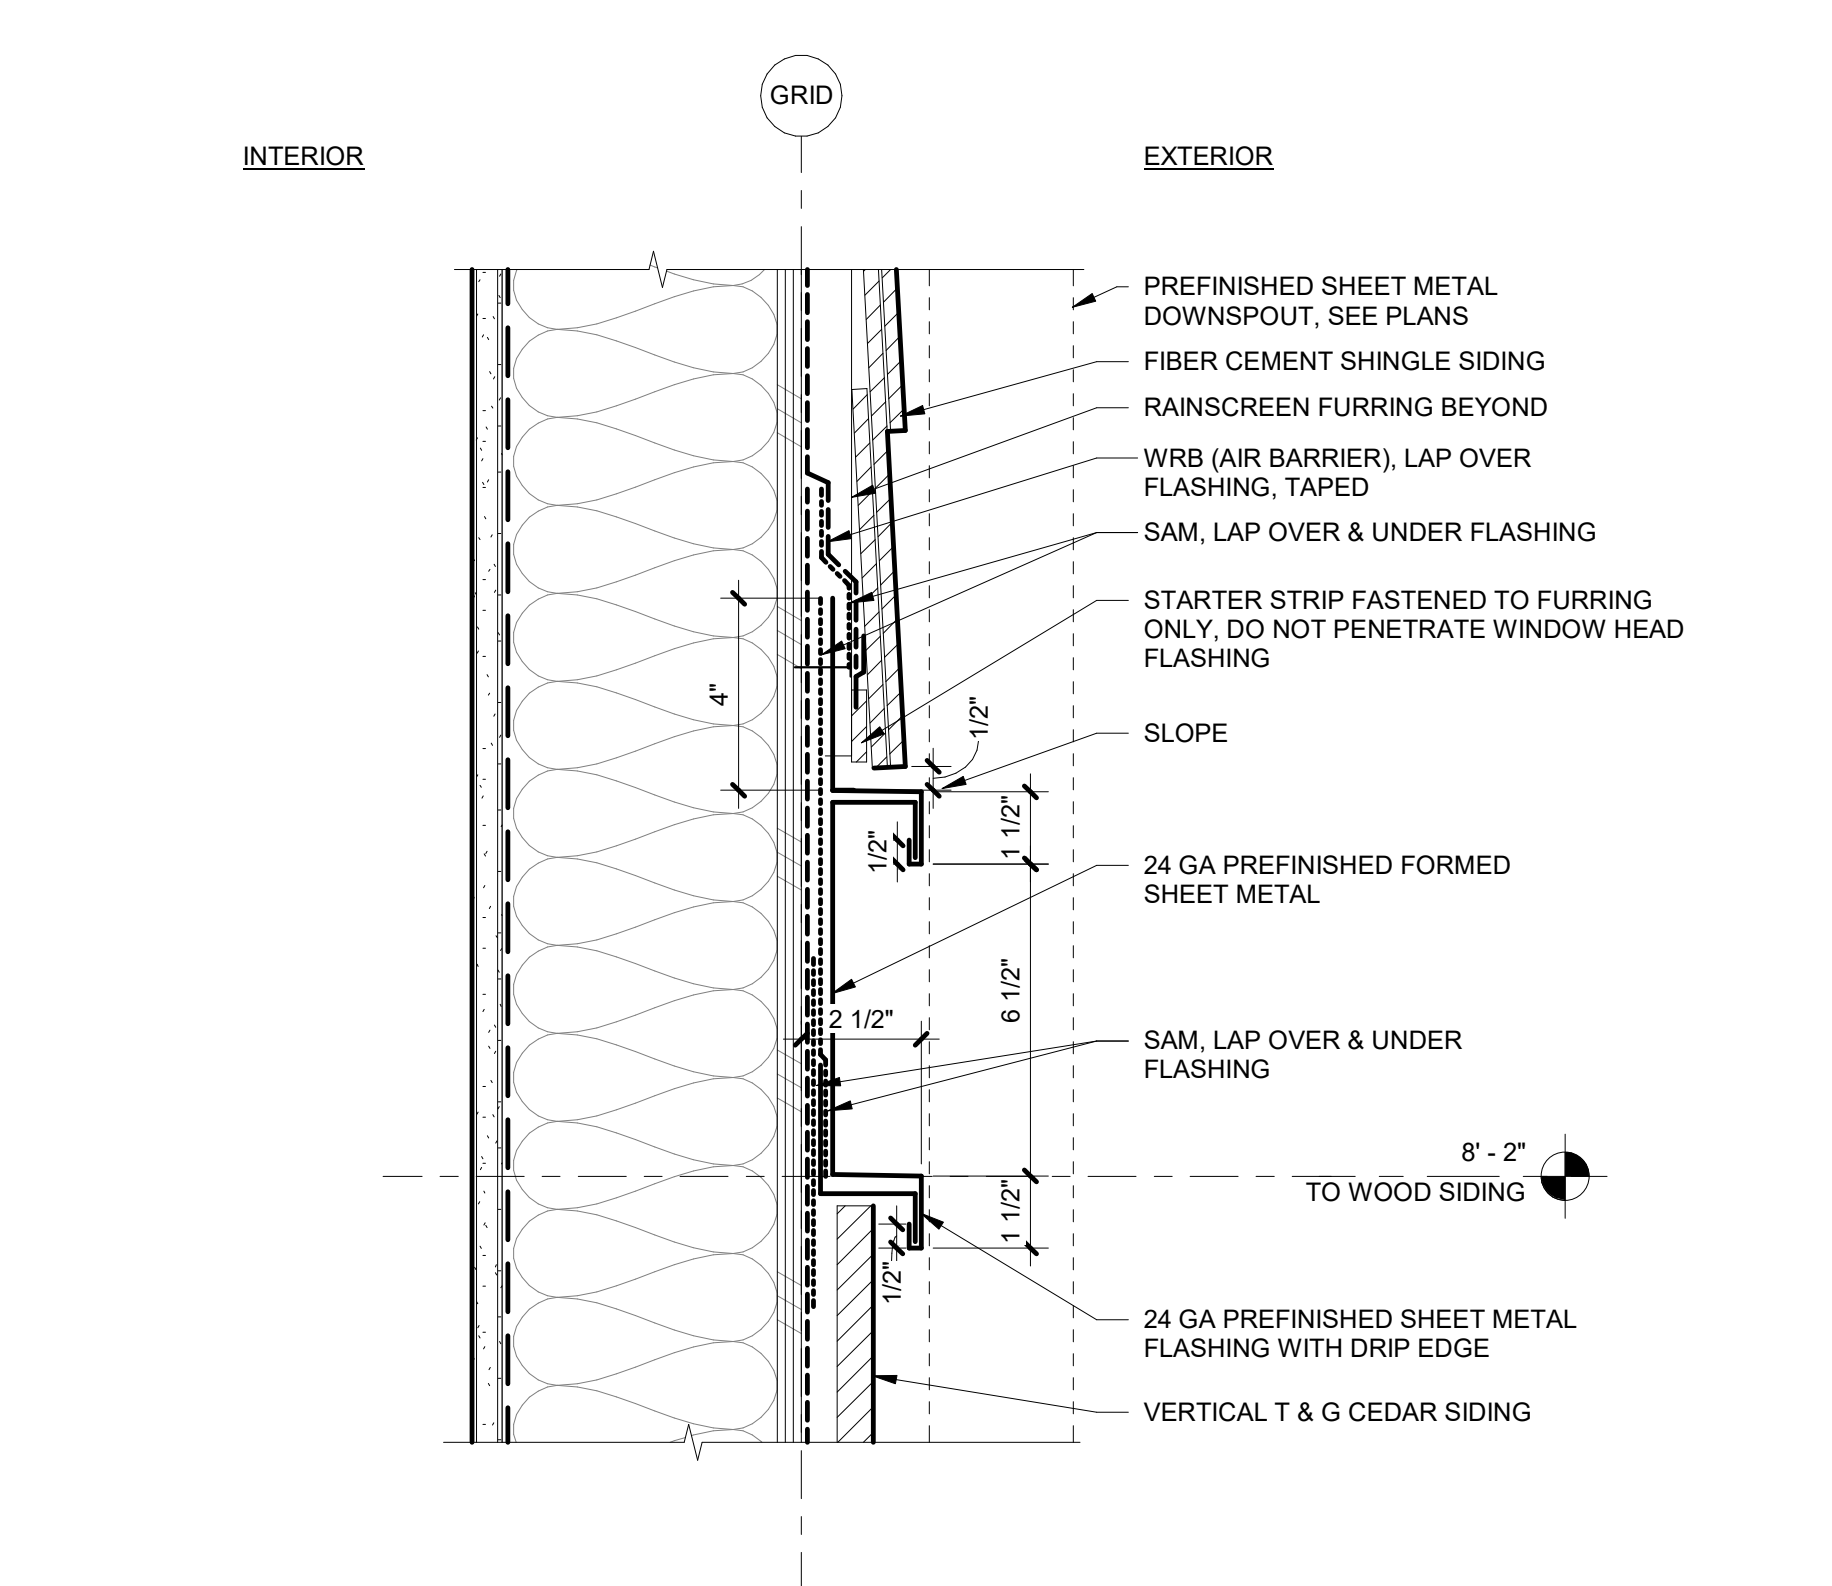3" = 1'-0"

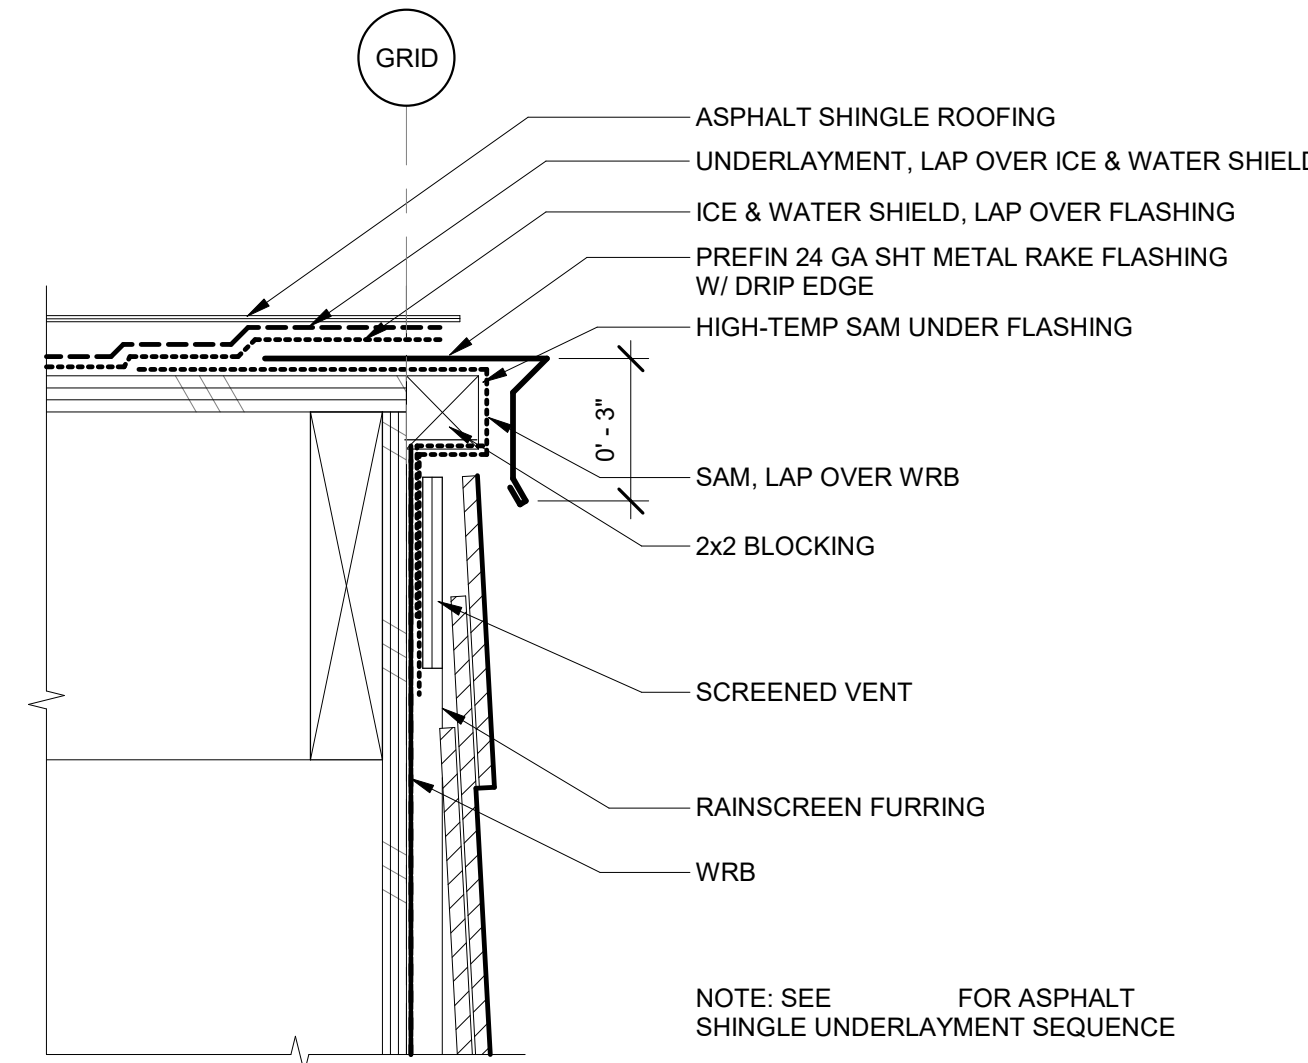


3 TYPICAL RAKE

3" = 1'-0"


2 WINDOW HEAD @ FIBER-CEMENT SIDING

3" = 1'-0"

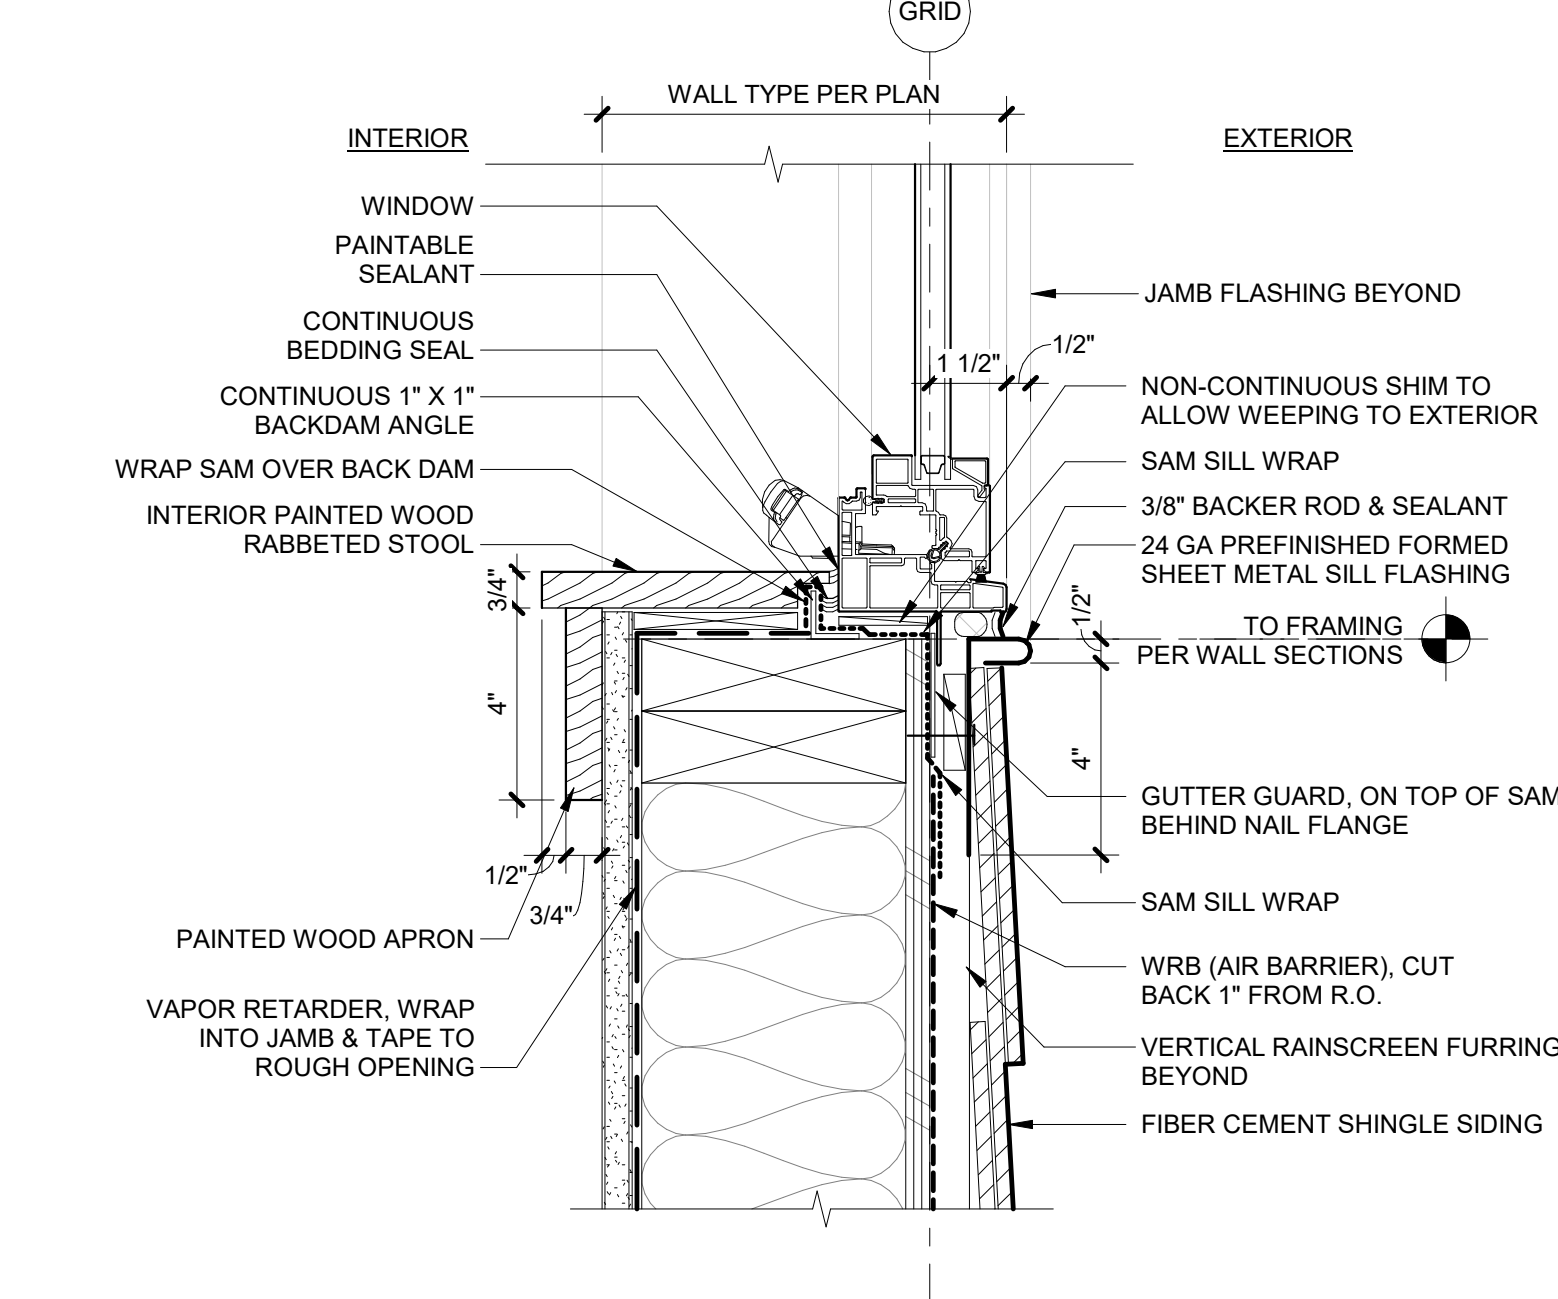


5 WINDOW SILL @ FIBER-CEMENT SIDING

3" = 1'-0"

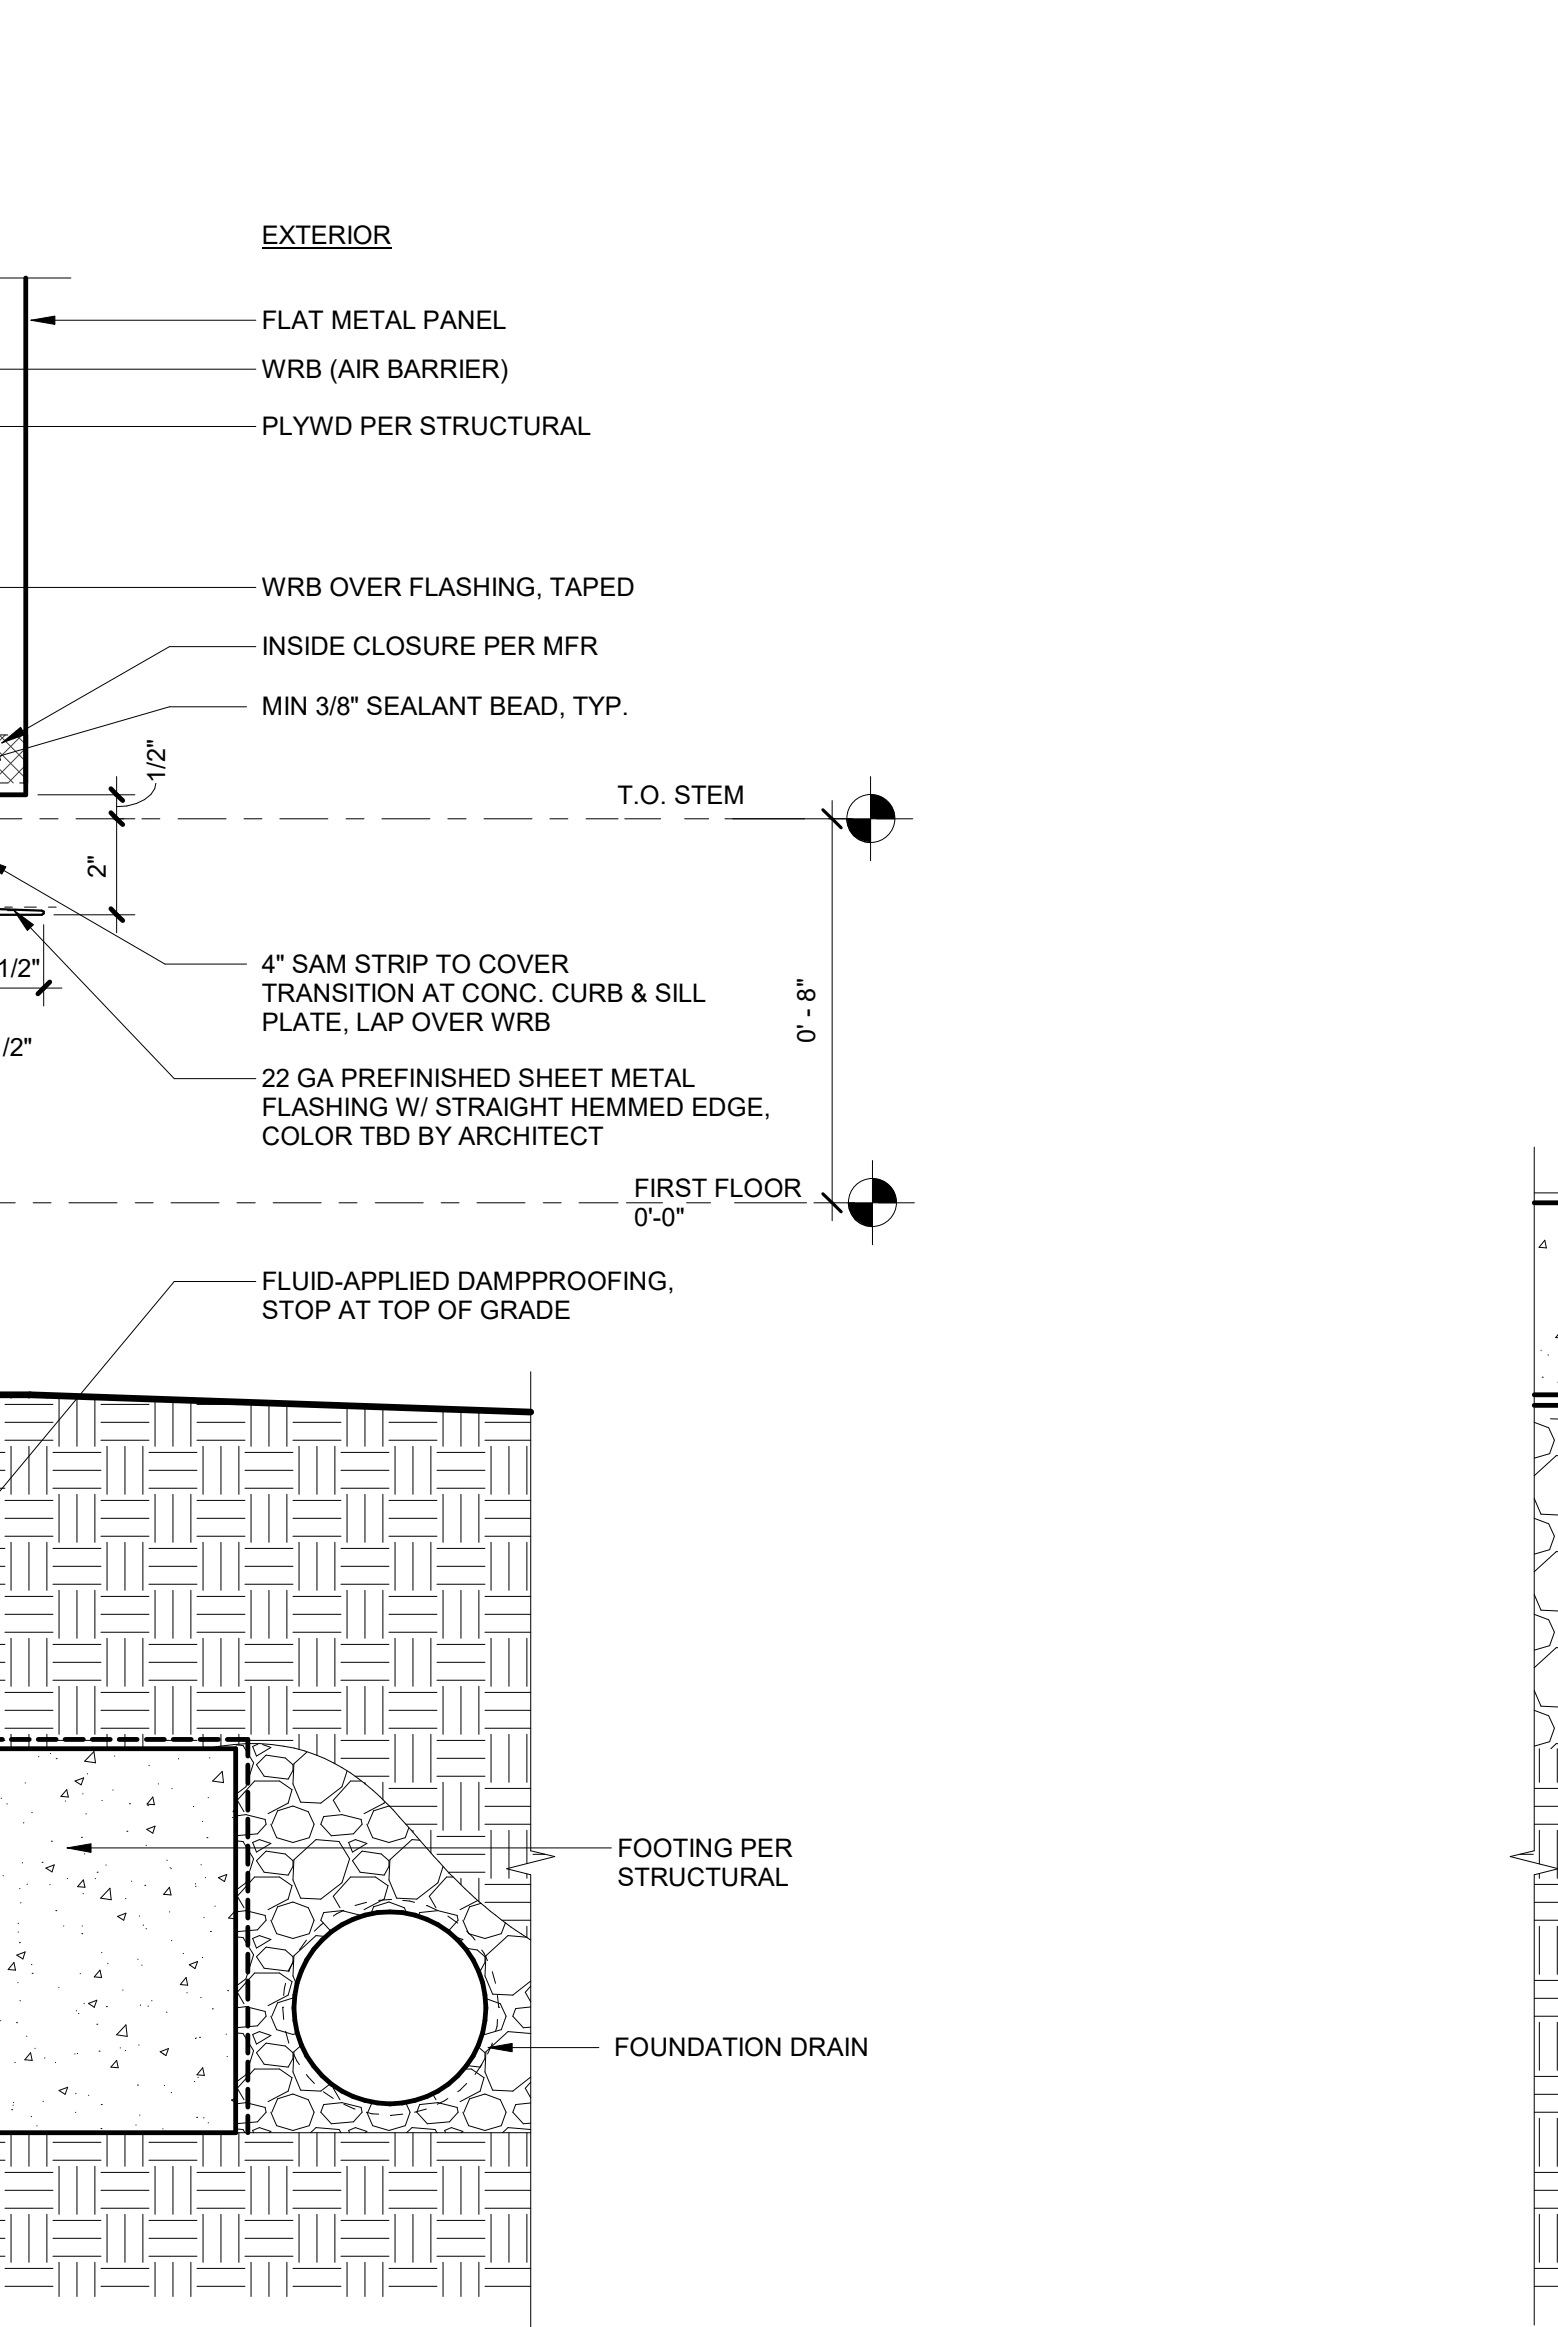

6 FIBER CEMENT SHINGLE OUTSIDE CORNER

3" = 1'-0"

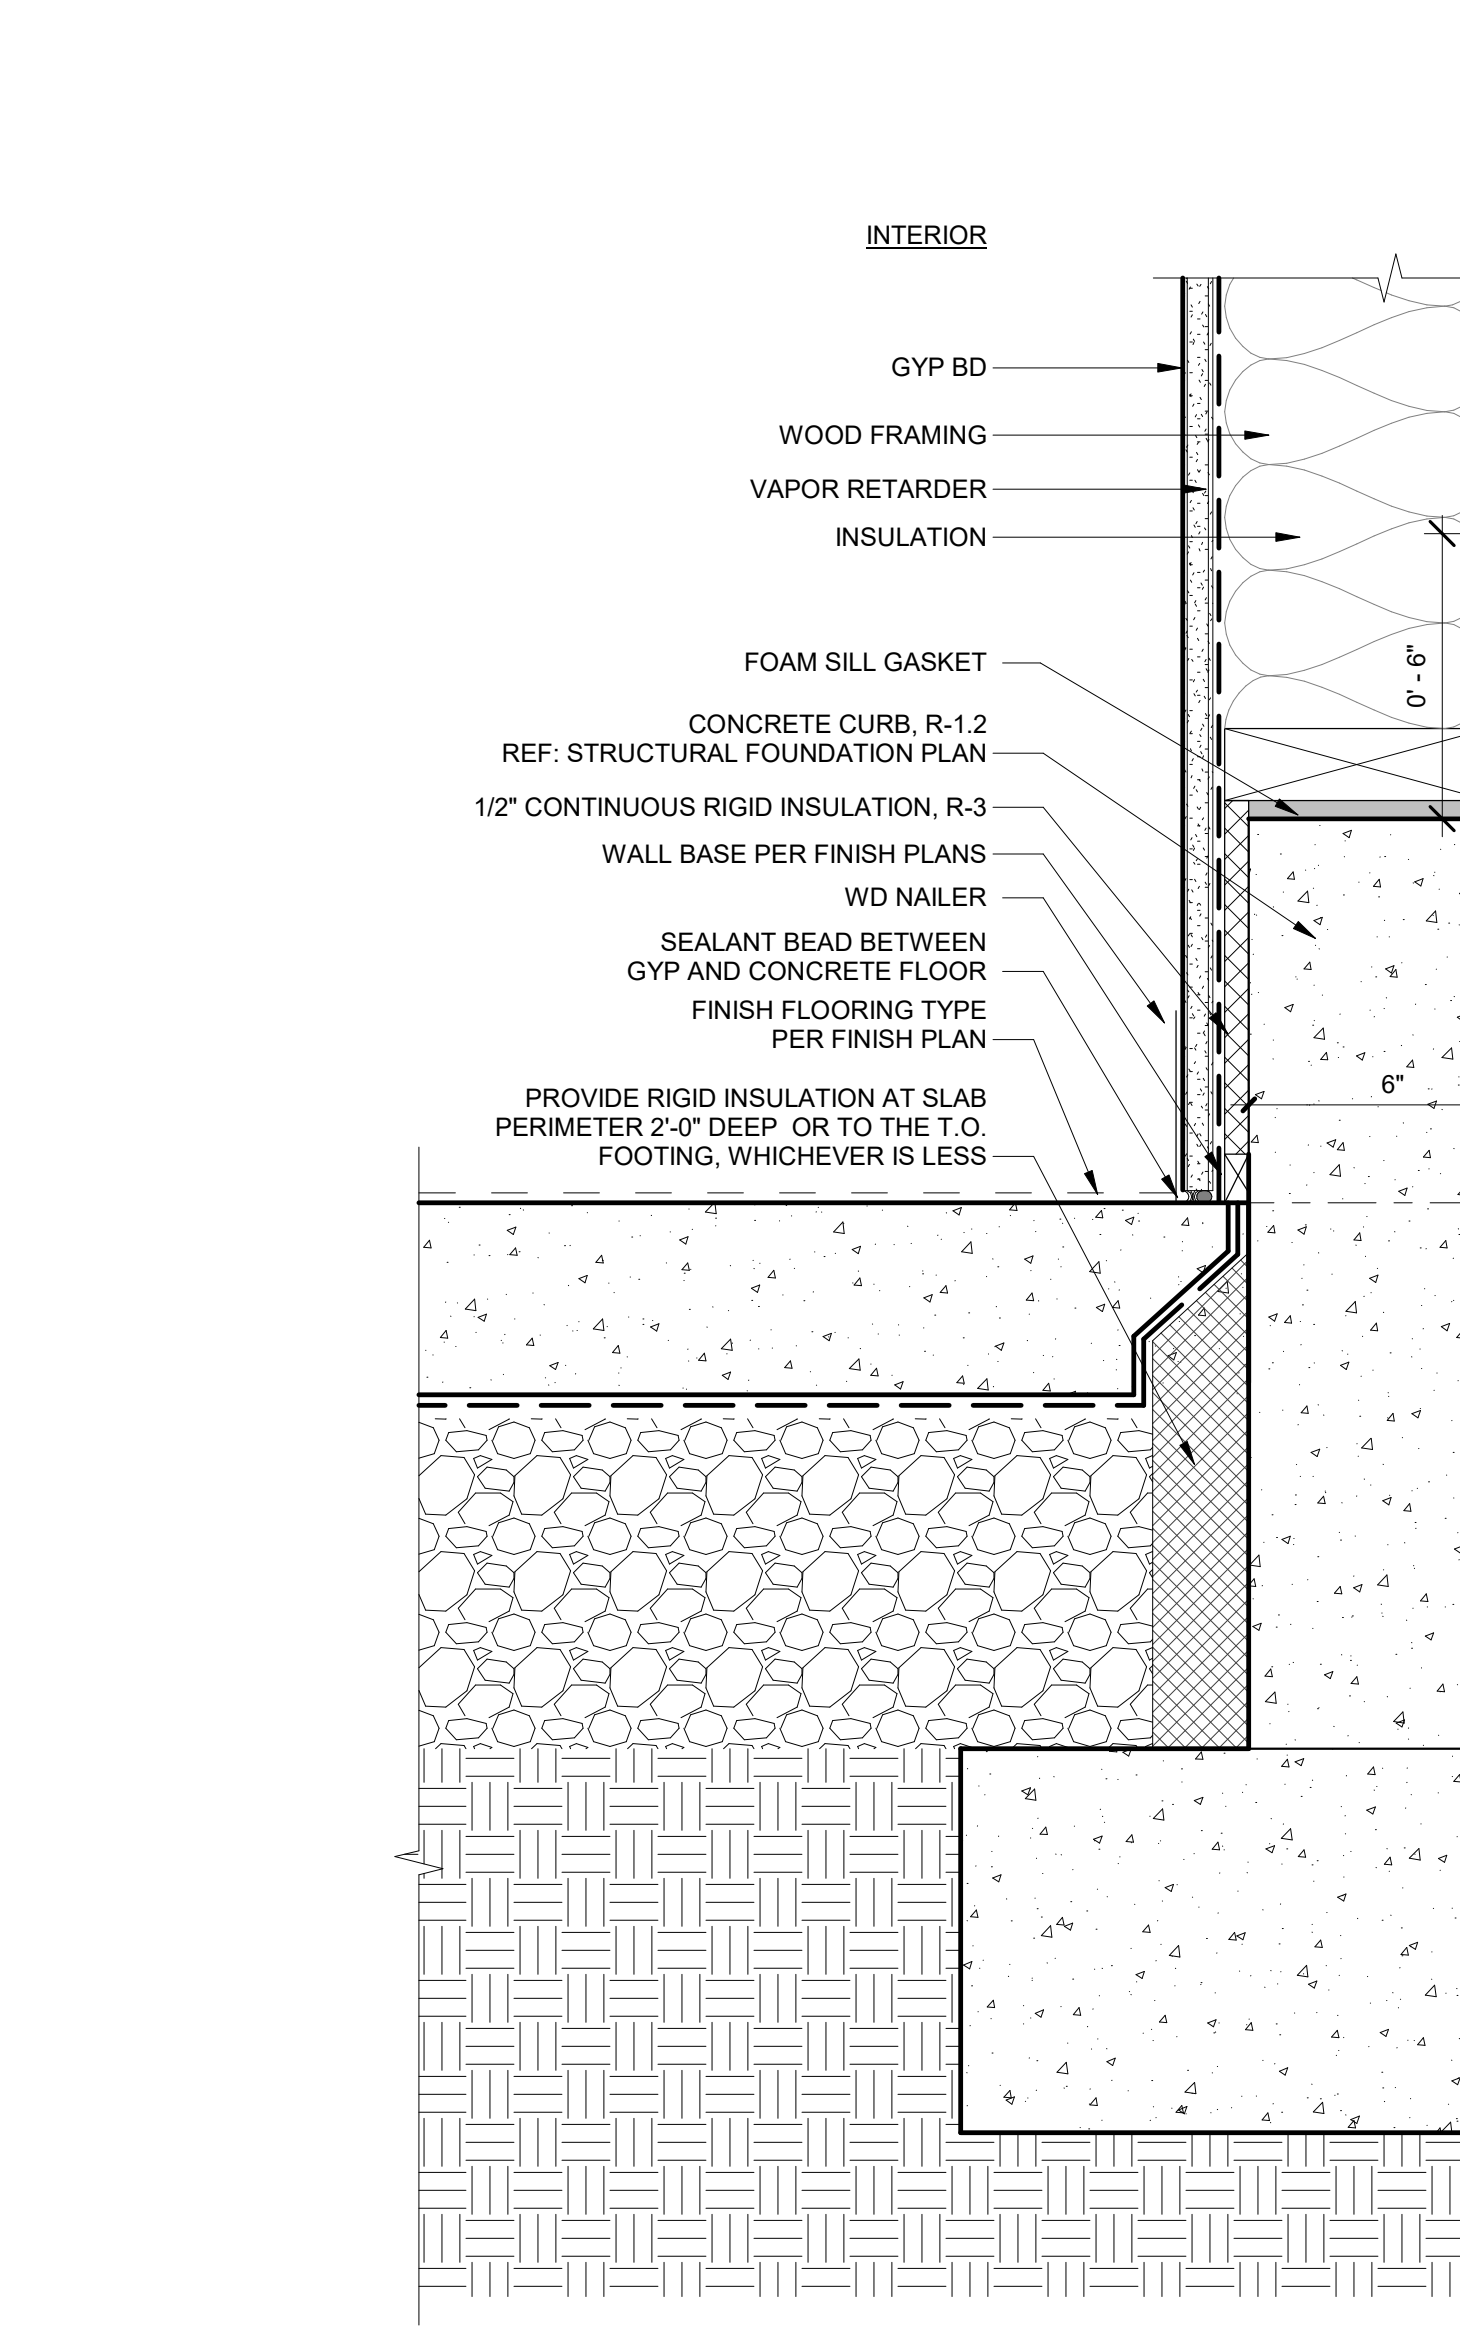


8 CURB AT METAL WALL PANEL

3" = 1'-0"


WINDOW HEAD @ FIBER-CEMENT SIDING W/ TRIM SURROUND

3" = 1'-0"

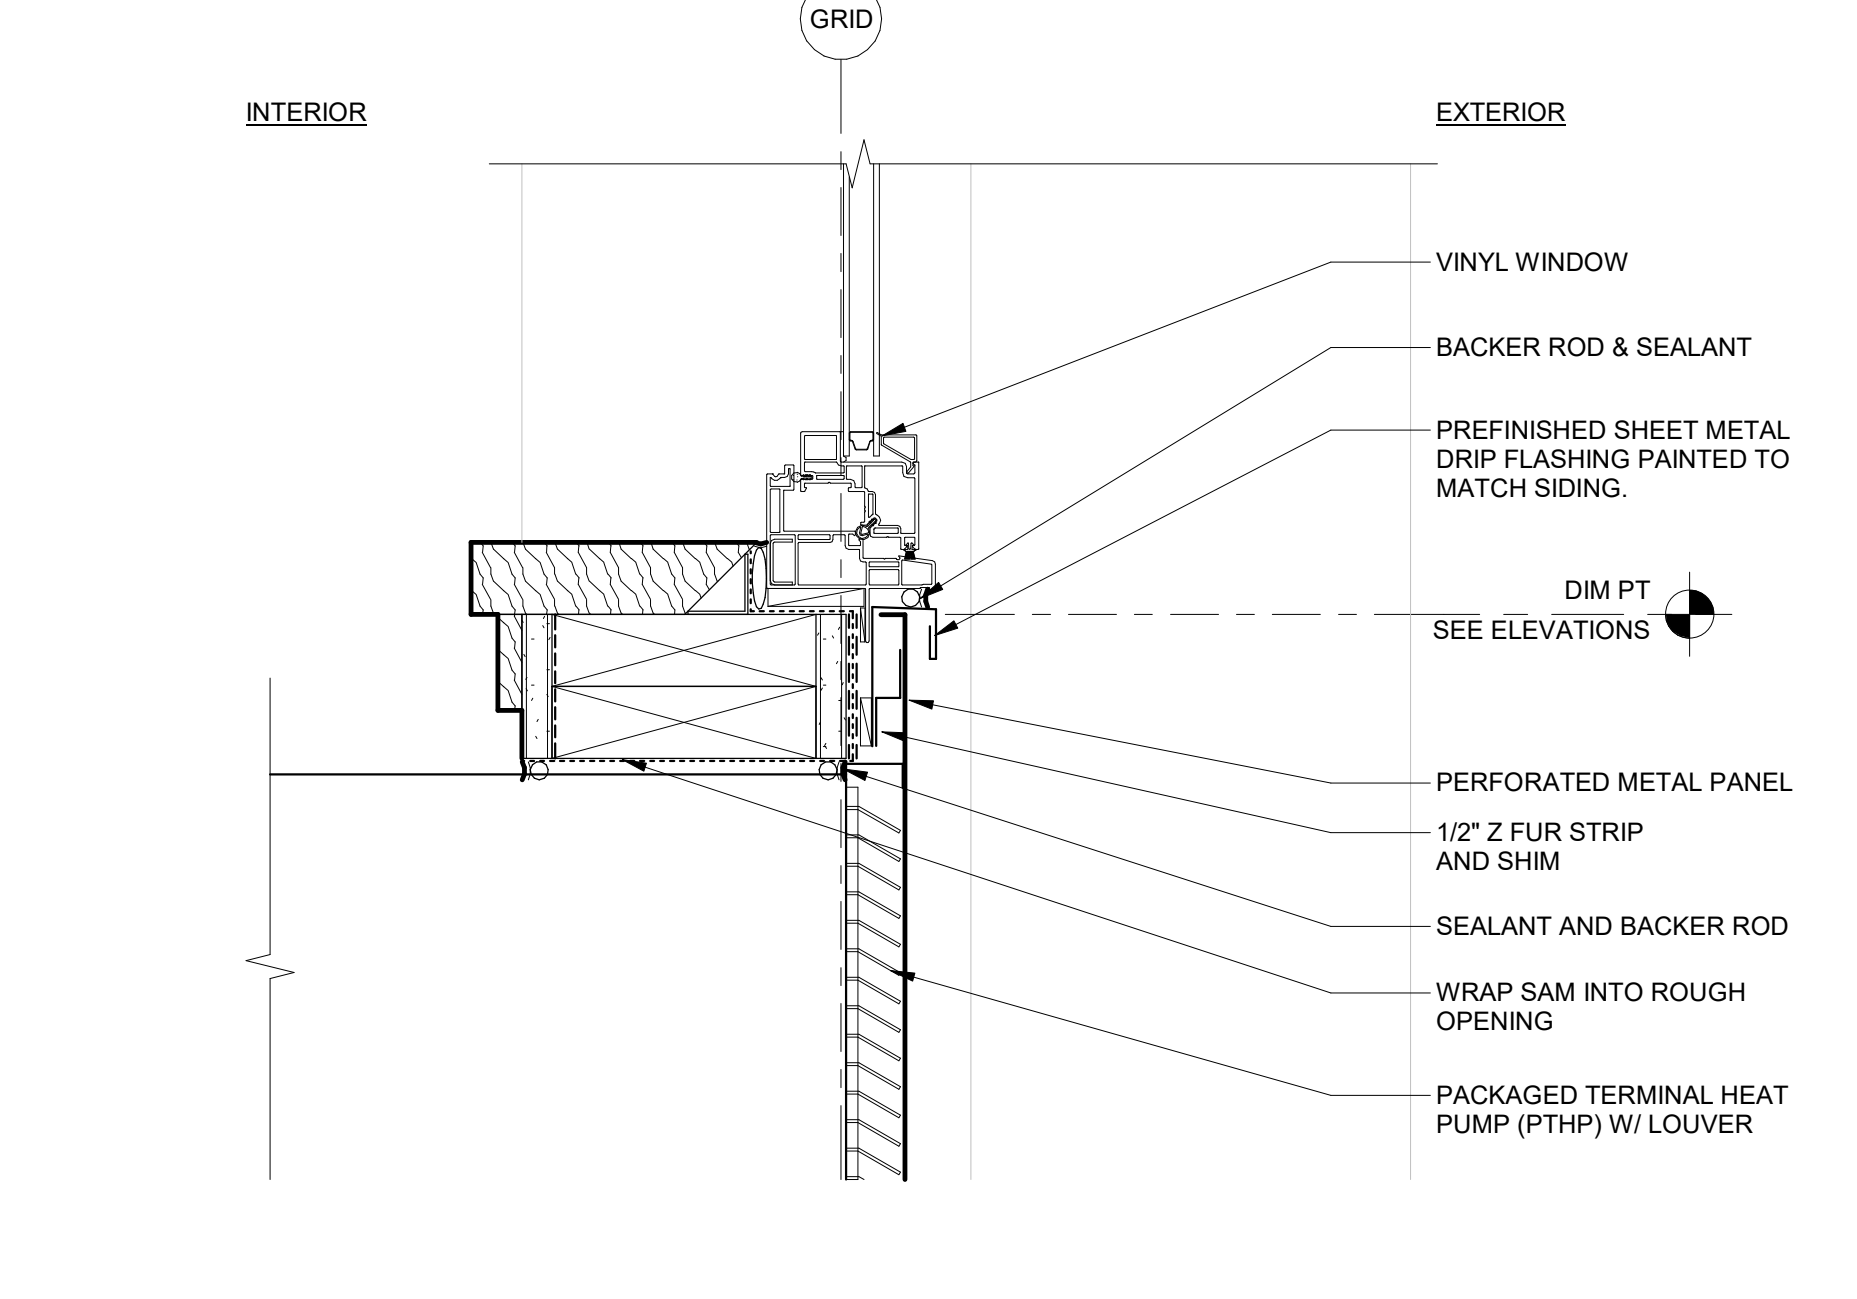

4 WINDOW SILL @ PTHP LEVELS 2-3

3" = 1'-0"

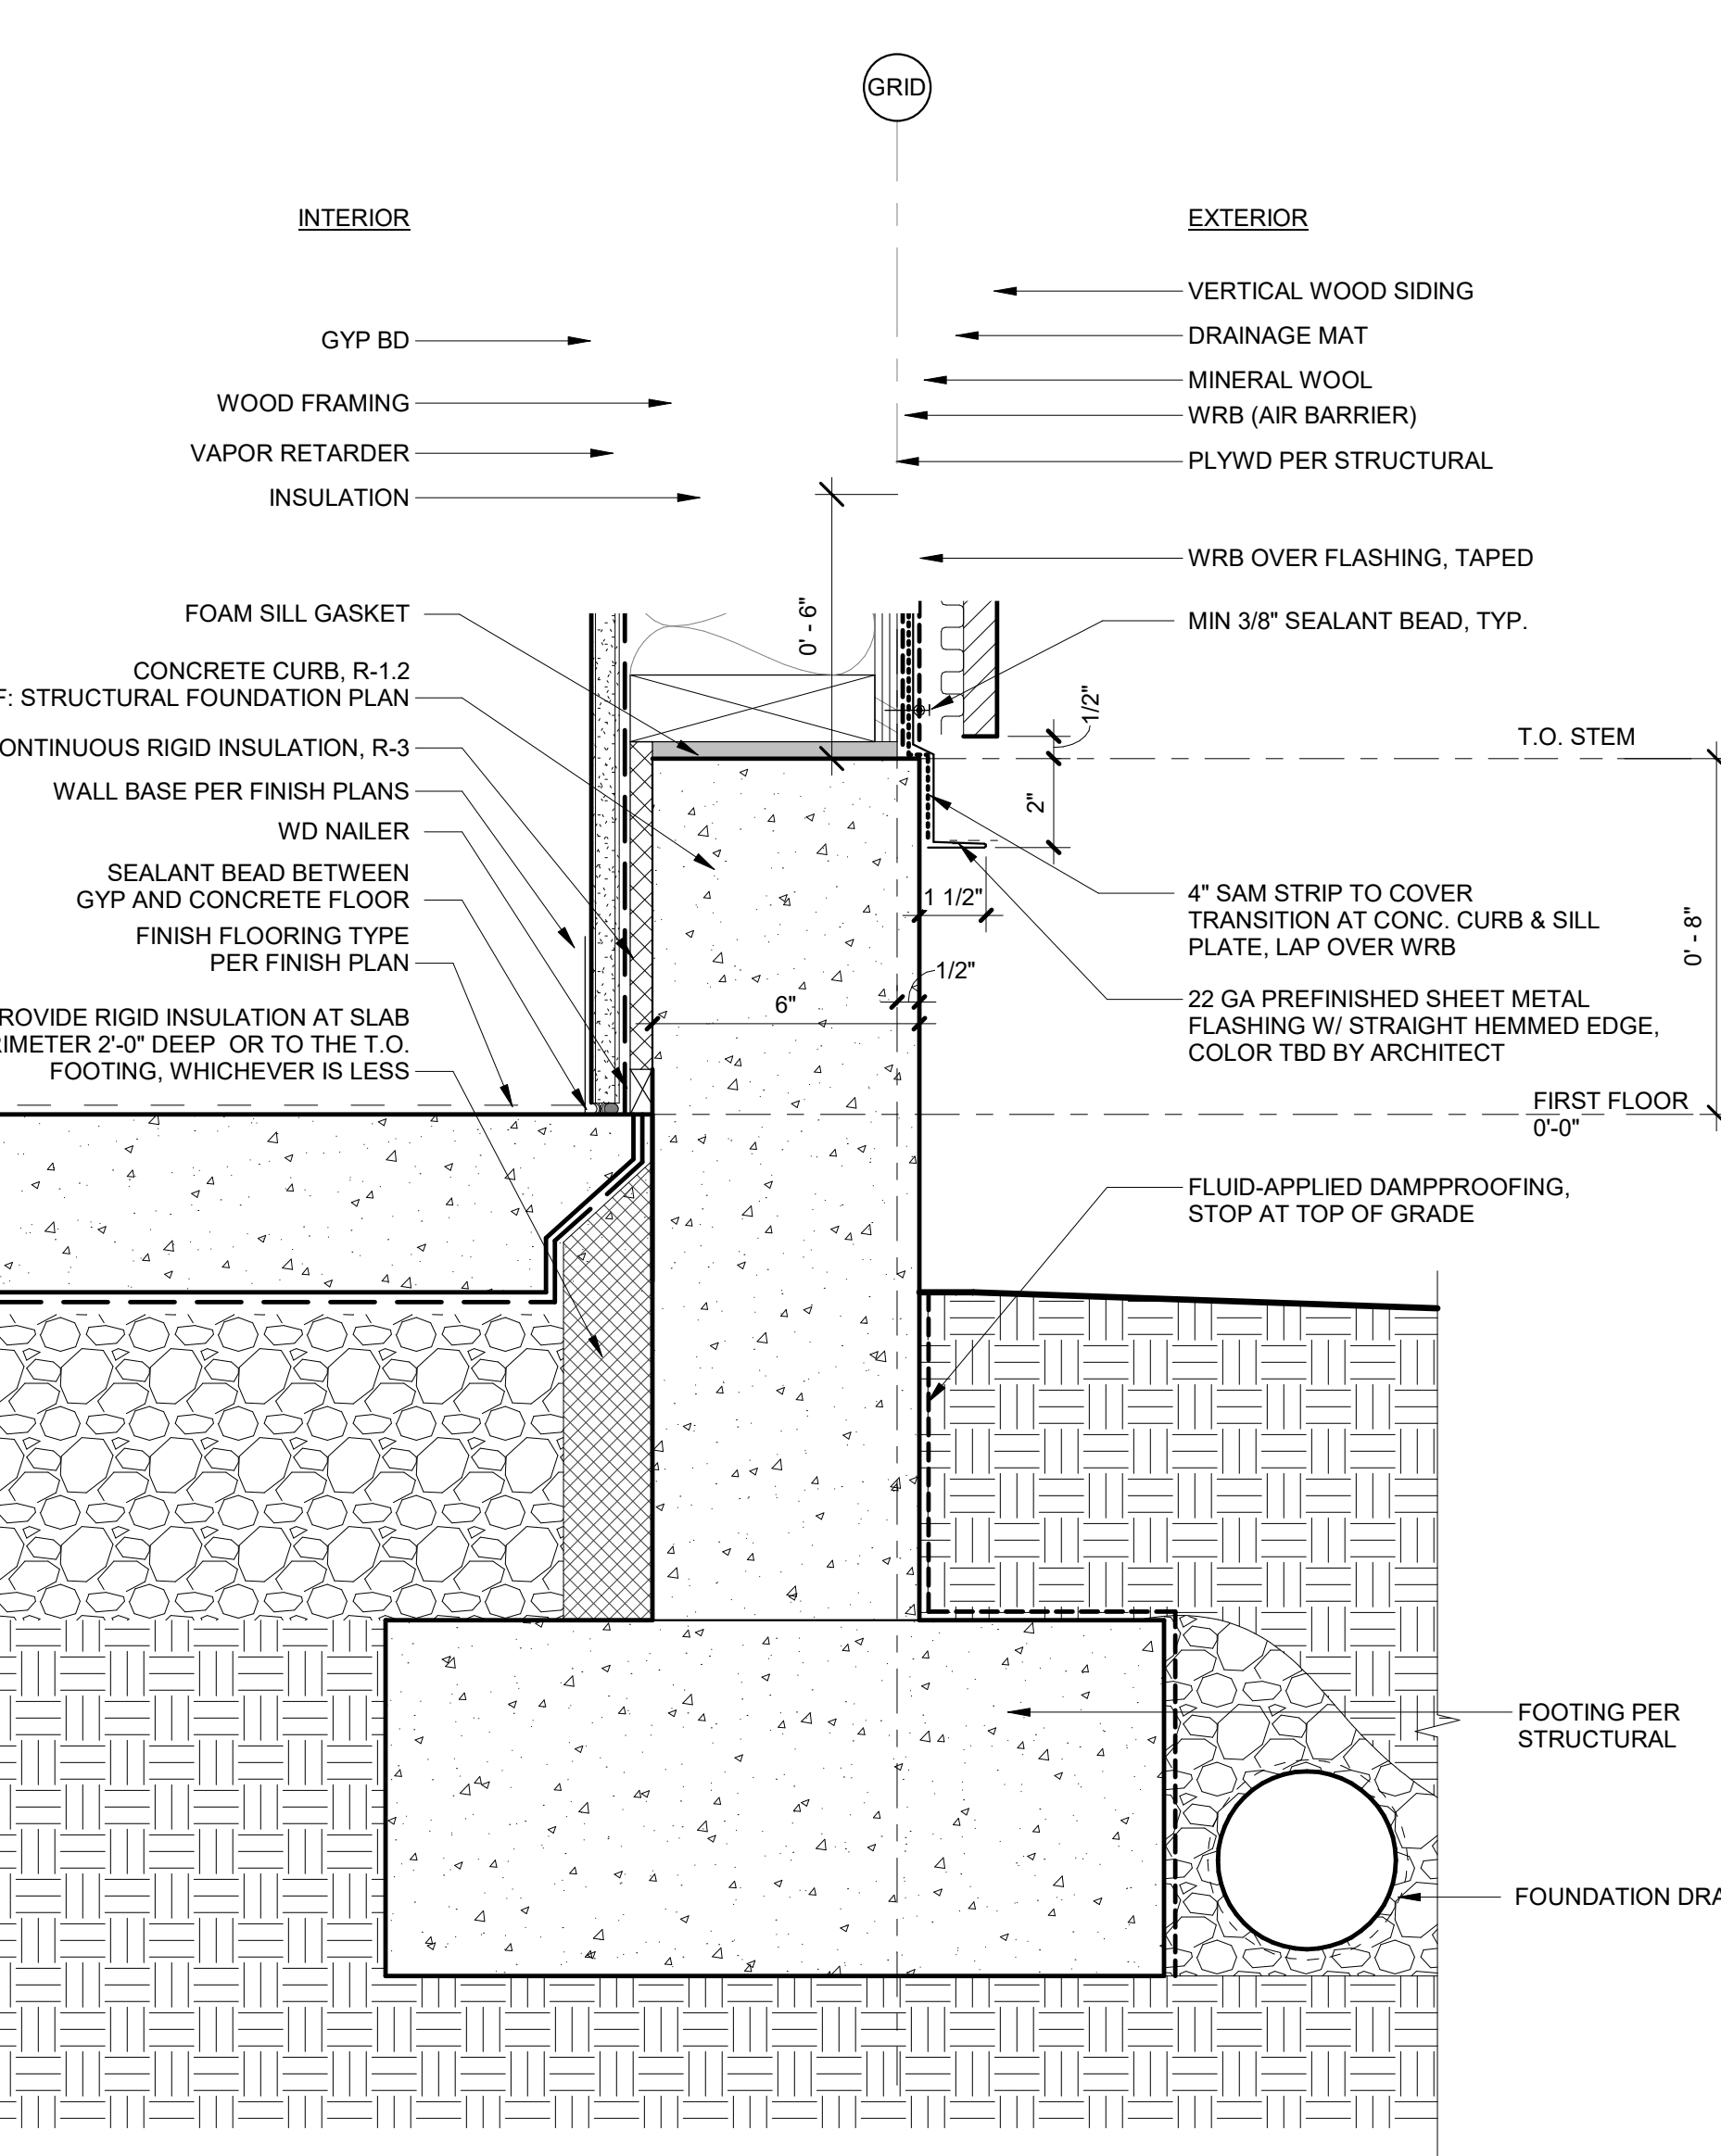

7 CURB AT WOOD SIDING

3" = 1'-0"

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Drawing:

EXTERIOR DETAILS

Sheet No:

A7.01

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