LAND USE SUBMISSION

03.11.2022



CDP SALEM - BUILDING A


5205 BATTLE CREEK RD SE SALEM, OR 97306



GENERAL PROJECT NOTES	PROJECT TEAM	PROJECT SUMMARY	SHEET INDEX
SENERAL PROJECT NOTES THE PROPERTY OF THE PROPERTY OF THE PALE SET OF CONTINUENCE AND SET OF THE PROPERTY OF THE PALE SET OF CONTINUENCE BELLOCAL CONTINUENCE OF SERVICE SET OF THE PALE SET OF CONTINUENCE AND SET OF THE PALE SET OF THE PALE SET OF CONTINUENCE AND SET OF THE PALE SET OF THE PALE SET OF CONTINUENCE AND SET OF THE PALE SET OF THE PALE SET OF CONTINUENCE AND SET OF THE PALE SET OF THE PALE SET OF THE PALE SET OF CONTINUENCE AND SET OF THE PALE SET OF THE PALE SET OF THE PALE SET OF CONTINUENCE BELLOCATION OF THE PALE SET OF THE PA	OWNER OWNER CEO GROOVI I STANS A BESTA ST SCO PRINT THAN STORY FINAL THAN STORY FINAL THAN STORY FINAL THAN STORY CONTRACTOR LOCAL THAN STORY LOCA	PROJECT SUMMARY FROUPT PERCENTION SECOND STATE PERMITS AND DEFERRED SUBMITTAL BIDDER DESIGN ITEMS CONTROL PROJECT SUMMARY FROUPT ADDRESS PROJECT ADDRESS	SHEET INDEX SHEET SHEET NAME GENERAL PROJECT INFORMATION GIO10 GENERAL PROJECT INFORMATION GIO11 GENERAL PROJECT INFORMATION GIO10 GENERAL PROJECT INFORMATION GIO11 GENERAL PROJECT INFORMATION GIO11 GENERAL PROJECT INFORMATION AD101 ARCHITECTURAL ARCHITECTURAL AD101 ARCHITECTURAL ARC



2525 E Burnside Street, Portland, OR 97214 phone: (503) 226-3617 www.seallp.com

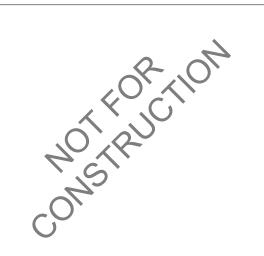

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21031

Job Number: 5205 BATTLE CREEK RD SE SALEM, OR 97306

LAND USE SUBMISSION ISSUE

Drawing:

GENERAL PROJECT INFORMATION

03.11.2022


DATE

BUILDING CODE SUMMARY


OCCUPANCY	R-2	TRUCTURAL OF LUIALTT CODE	CHAPTER TO. MEANS C						
CONSTRUCTION TYPE	V-B, SPRINKLERED PER NFPA		SECTION 1004	OCCUPANT LOAD (OL)		SEE OCCUPAN	T LOAD TABLE		
	13-R	ED ON OCCUDANCY AND USE	SECTION 1005.3.1 SECTION 1005.3.2	STAIRWAY EGRESS CAPAC		0.3 0.2			
OSSC REFERENCE SECTION 420.2	·	ED ON OCCUPANCY AND USE S SEPARATING DWELLING OR SLEEPING UNITS FROM EACH OTH	TABLE 1006.2.1	MAX OCCUPANT LOAD I MAX COMMON PATH OF		20 OCCUPANTS 125 FT	3		
SECTION 420.2	OR O' IN AC	THER OCCUPANCIES SHALL BE CONSTRUCTED AS FIRE PARTITIC CORDANCE WITH SECTION 708. R ASSEMBLIES SEPARATING DWELLING OR SLEEPING UNITS FR	TABLE 1006.3.2		MAX OCCUPANT LOAD PER STORY MIN NUMBER OF EXITS FOR STORY				
SECTION 420.4	EACH HORIZ	I OTHER OR OTHER OCCUPANCIES SHALL BE CONSTRUCTED AS ZONTAL ASSEMBLIES IN ACCORDANCE WITH SECTION 711. JP R OCCUPANCIES, REQUIRED PER 903.2.8		STORIES WITH ONE EXI		EMERGENCY E	SCAPE AND RE	ANCE / UP TO 3 STO SCUE OPENINGS P	
SECTION 420.5	FIRE & SMOKE ALARMS GROU	JP R-2, FIRE ALARM SYSTEMS REQUIRED PER SECTION 907.2.9				REQUIRED FOR	R STORIES WITH	I ONE EXIT	
	SMOR	KE ALARMS REQUIRED PER 907.2.10.2	TABLE 1017.2	EXIT ACCESS TRAVEL D	DISTANCE	250 FT			
CHAPTER 5: GENERAL F	BUILDING HEIGHTS AND AREA	us	TABLE 1020.1	CORRIDOR FIRE-RESIS [*]	TANCE RATING	0.5 HR			
TABLE 504.3	HEIGHT / STORIES / AREA FACTOR		TABLE 1020.2	MINIMUM CORRIDOR W	MINIMUM CORRIDOR WIDTH 44 INCHES * 36 INCHES WITHIN DWELLING UN OCCUPANT LOAD <50			N DWELLING UNIT C	OR WHERE
TABLE 504.4 TABLE 506.2			SECTION 1020.4	DEAD ENDS		20 FEET *LENGTH IS NO	T LIMITED WHE	RE LENGTH < 2.5x \	WIDTH
MODIFICATIONS SECTION 506.2.3	BUILDING AREA Aa	a = [At + (NS x lf)] x Sa	CHAPTER 11: ACCESSI	BILITY					
SINGLE-OCCUPANCY MULTIST EQUATION 5-2	FORY BUILDINGS =	[7000 SF + (7000 SF x 0.75)] x 3 12250 SF x 3 36750 SF	SECTION 1106.2	R-2 OCCUPANCIES WITH ACCESSIBLE, TYPE A OR TYPE B UNITS, AT LEAST 2% OF EACH TYPE OF PARKING PROVIDED SHALL BE ACCESSIBLE			OF PARKING		
SECTION 506.3	I	f = [F/P - 0.25] x W/30 f = [286/286 - 0.25] x 30/30 = 0.75		ACCESSIBLE SPACES REQUIRED: 16 ACCESSIBLE SPACES PROVIDED: 6		D: 6	167 167 x 2% = 4 6 1 PER 6 ACCESSIBLE SPACES		
	ACTUAL HEIGHT / STORIES	34' - 9" / 3 Story		VAN ACCESSIE	BLE SPACES PROV ONLY SPACES RE	/IDED: 1	101-200 SPACE		
		LDING AREA			ONLY SPACES PR		101 200 01 7102	.0	
	FLOOR LEVEL FIRST FLOOR	AREA (SF) Not Enclosed	SECTION 1107.6.2.2.1	R-2 OCCUPANCIES WITI R-2 UNITS ON A SITE SH	IALL BE CONSIDER				
	SECOND FLOOR THIRD FLOOR	Not Enclosed Not Enclosed		NUMBER OF TYPE A UN TYPE A UNITS	ITS REQUIRED (TOTAI	L FOR SITE): 184 :	x 2% = 4 UNITS		
		0 SF		TYPE A UNITS	PROVIDED (TOTAL PROVIDED (THIS E	L FOR SITE): 10 U	NITS		
SECTION 508.2	ACCESSORY OCCUPANCY	N/A	SECTION 1107.6.2.2.2		`	,		TYPE R LINITS AT A	MINIMI IM
SECTION 508.3 / 508.4	MIXED OCCUPANCY	N/A	EXCEPTION:			·	NG UNITS, ALL UNITS SHALL BE TYPE B UNITS AT A MINIMUM		
TABLE 509		SPRINKLERED, NO SEPARATION REQUIRED SPRINKLERED, NO SEPARATION REQUIRED	EXCELLION.	THE NUMBER OF TYPE A AND TYPE B UNITS IS PERMITTED TO BE REDUCED IN ACCORDANCE WITH SECTION 1107.7 1107.7.1.1, STRUCTURES WITHOUT ELEVATOR SERVICE, ONE STORY WITH TYPE B UNITS					
CHAPTER 6: TYPES OF (CONSTRUCTION / CONSTRUCT	TION CLASSIFICATION	ADDITIONAL ACCESSIB	ILITY REQUIREMENTS					
TABLE 601	FIRE RESISTANCE RATING REQUIR	MENTS FOR BUILDING ELEMENTS	APPLICABLE STANDARDS ANSI (APPLICABLE STANDARDS ANSI ICC A117.1 - 2009					
	BUILDING PRIMARY STRUCTURAL FRAME	G ELEMENT FIRE RATING * 0 HOUR	2010 A	NDA STANDARDS FOR ACCES ON 504	SIBLE DESIGN - TI	TLE II			
	BEARING WALLS EXTERIOR	0 HOUR	FAIR H	HOUSING ACCESSIBILITY GUID THA SAFE HARBOR DESIGN D		018			
	INTERIOR NON BEARING WALLS AND PARTI	0 HOUR		CORE DEVELOPMENT MANU		010			
	NON BEARING WALLS AND PARTI NON BEARING WALLS AND PARTI FLOOR CONSTRUCTION AND SEC ROOF CONSTRUCTION AND SECO	TIONS - INTERIOR 0 HOUR ONDARY MEMBERS 0 HOUR		UNITS WITH MOBILITY FEATO		184 x 5% = 10 UNIT 184 x 2% = 4 UNITS			
	* UNLESS OTHERWISE REQUIRED	BY THIS CODE	CHAPTER 13: ENERGY	EFFICIENCY 2021 O	REGON ENER	RGY EFFICIENC	Y SPECIALT	Y CODE (OEES	C)
TABLE 602		MENTS FOR EXTERIOR WALLS BASED ON FIRE SEPARATION DIST							
	X < 5'	ATION DISTANCE FIRE RATING 1 HOUR	OPAQUE ELEMENTS	ASSEMBLY	MAX.	RED MIN. R-VA	LUE	PROV	/IDED
	5' <= X < 10' 10' <= X < 30'	1 HOUR 0 HOUR	ROOFS INSULATION ENTIRELY AND DECK	BOVE N/A	\	N/A			
	X >= 30'	0 HOUR	METAL BUILDINGS	N/A		N/A		_	
CUADTED 7: FIDE AND S	MOKE PROTECTION FEATURI	=e	ATTIC AND OTHER WALLS (ABOVE GRADE)	U-0.0		R-49	21		-49
	WORL FROTECTION TEATOR		MASS METAL BUILDINGS STEEL-FRAMED	U-0.0 N/A		R-11.4 (N/A N/A	IJ.	K-11	I.4 CI
TABLE 705.2	MINIMUM DISTANCE OF PROJECTION	DN 40 INCHES	WOOD-FRAMED / OTHER		64	R-13 + 3.8 CI		R-	-23
TABLE 705.8	MAXIMUM AREA OF WALL OPENING	SS BASED ON FSD AND OPENING PROTECTION UNPROTECTED, NON-SPRINKLERED PROTECTION	WALLS (BELOW GRADE) FLOORS	C-0.0		R-10 C	·I		
	0 TO LESS THAN 3' 3 TO LESS THAN 5'	NOT PERMITTED NOT PE NOT PERMITTED 15%	RMITTED MASS STEEL JOIST	N/A N/A		N/A N/A			
	5 TO LESS THAN 10' 10 TO LESS THAN 15'	10% 25% 45%	WOOD FRAMED / OTHER SLAB-ON-GRADE FLOORS			R-30		R-	-30
	15 TO LESS THAN 20' 20 TO LESS THAN 25'	25% 75% 45% NO LIMI	HEATED UNHEATED	N/A F-0.5		N/A R-15 FOR 24"		R-15 FOR 24" U-0.370	
	25 TO LESS THAN 30' 30' OR GREATER	70% NO LIMI'NO LIMI'	T OPAQUE DOORS SWINGING	U-0.3					
705.8.1	ALLOWABLE AREA OF OPENINGS	EXCEPTION 2: BUILDINGS WHOSE EXTERIOR BEARING WA	NON-SWINGING	N/A				_	
. 55.5.1	OI DI LIVINGO	EXCEPTION 2. BUILDINGS WHOSE EXTERIOR BEARING WA EXTERIOR NONBEARING WALLS AND EXTERIOR PRIMARY STRUCTURAL FRAME ARE NOT REQUIRED TO BE FIRE-RE RATED SHALL BE PERMITTED TO HAVE UNLIMITED UNPRO OPENINGS.	FENESTRATION SISISTANCE OTECTED VERTICAL (0% - 40% OF WAL	. ′	REQUIRED MAX SHGC	MIN VTI/SHGC	MAX U	PROVIDED MAX SHGC	MIN VTI/SHGC
705.11	PARAPETS	EXCEPTION 1: WALL NOT REQUIRED TO BE FIRE-RESISTANCE RATED IN	FIXED OPERABLE ENTRANCE DOOR	U-0.36 U-0.45 U-0.63	0.36 0.33 0.33	1.10 1.10 1.10	U-0.36 U-0.45 U-0.63	0.36 0.33 0.33	1.10 1.10 1.10
		ACCORDANCE WITH TABLE 602 BECAUSE OF FIRE SEPAR DISTANCE.						<u> </u>	<u> </u>
TABLE 706.4	FIRE WALL FIRE RESISTANCE	N/A	CI = CONTINUOUS INSULATION	ON					
TABLE 707.3.10	FIRE BARRIER ASSEMBLIES AND HORIZONTAL ASSEMBLIES BTWN FIRE AREAS	1 HOUR, INTERIOR EXIT STAIR LESS THAN 4 STORIES	FC = FILLED CAVITY NR = NO REQUIREMENT NA = NOT APPLICABLE						
SECTION 708	FIRE PARTITIONS	1 HOUR 1/2 HOUR AT GROUP R-2 CORRIDORS PER TABLE 1020.1							
SECTION 709	SMOKE BARRIERS	NOT REQUIRED	CHAPTER 29: PLUMBIN						
SECTION 709	FLOOR AND ROOF ASSEMBLIES		R-2	TOTAL UNITS 12	1 WC / LA	AV / Tub or Shower pe	r unit required and	d provided	
	SUPPORTING CONSTRUCTION PER								
711.2.4.1 711.2.4.2	SEPARATING MIXED OCCUPANCIES SEPARATING FIRE AREAS	S N/A N/A							
711.2.4.3 711.2.4.4	DWELLING / SLEEPING UNITS SEPARATING SMOKE COMPARTME	1 HOUR NTS N/A							
711.2.4.5 711.2.4.6	SEPARATING INCIDENTAL USES OTHER SEPARATIONS	PER TABLE 509 N/A				FV/F + 2 2 2	ESS TO 1	DIOTANICE	
SECTION 713	SHAFT ENCLOSURES	NOT LESS THAN 1 HOUR CONNECTING LESS THAN 4 STO				ESS PATH NAMI FIRST FLOOR		L DISTANCE RESS PATH LEI 57' - 4"	NGTH
CHAPTER 8: INTERIOR F	INISHES	NOT LESS THAN 2 HOUR CONNECTING 4 STORIES OR MO	KE			SECOND FLOOR THIRD FLOOR		79' - 2" 129' - 6"	
	R WALL AND CEILING FNIISH REQUIRE	MENTS (FLAME SPREAD RATING)				0.000			
	R EXIT STAIRWAYS AND RAMPS AND E	,			LIFE SAFETY	OCCUPANT LOA TABL	AD SCHEDUI E 1004.1.2	LE	
CORRID	ORS AND ENCLOSURES FOR EXIT ACC AND ENCLOSED SPACES				AREA (SF)	FUNCTION OF SPACE	OCCI LOAD I	FACTOR I	CUPANT LOAD
CHAPTER 9: FIRE PROT	ECTION SYSTEMS			SECOND FLOOR THIRD FLOOR	4444 SF 4444 SF	Residential Residential		200 200	23 23 46
SPRINK	LERED PER NFPA 13R								

2019 OREGON STRUCTURAL SPECIALTY CODE


CHAPTER 10: MEANS OF EGRESS

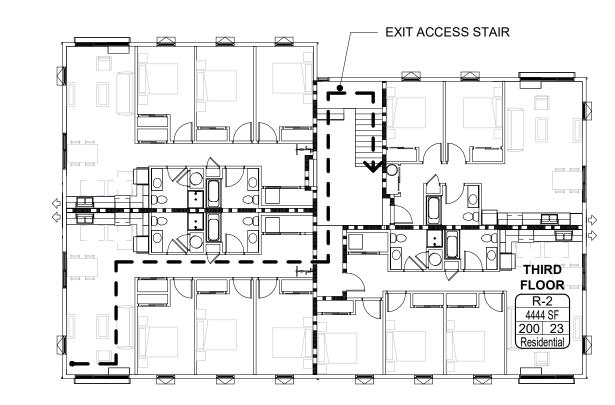


THIRD FLOOR LIFE SAFETY PLAN

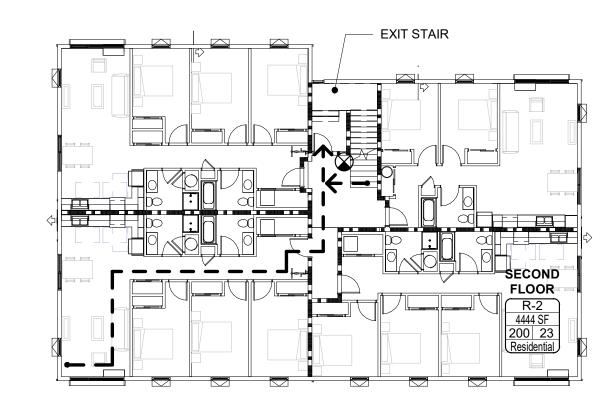


SECOND FLOOR LIFE SAFETY PLAN

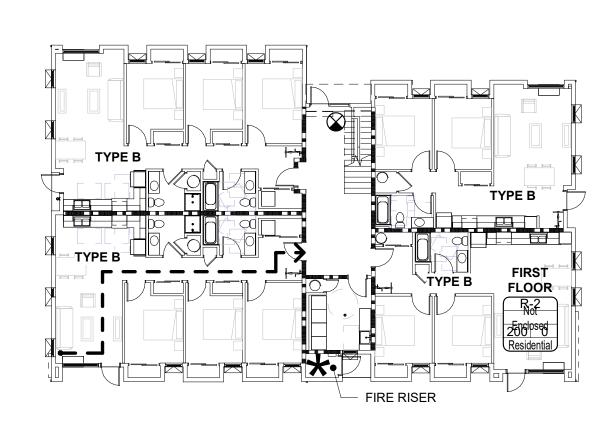

1 FIRST FLOOR LIFE SAFETY PLAN 1/16" = 1'-0"

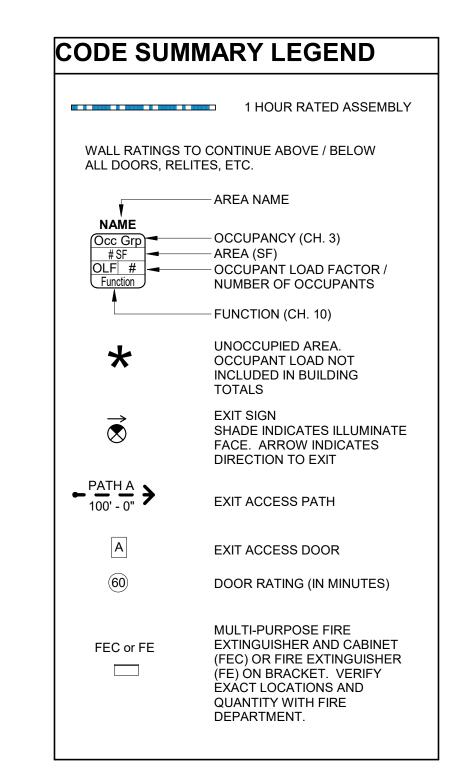

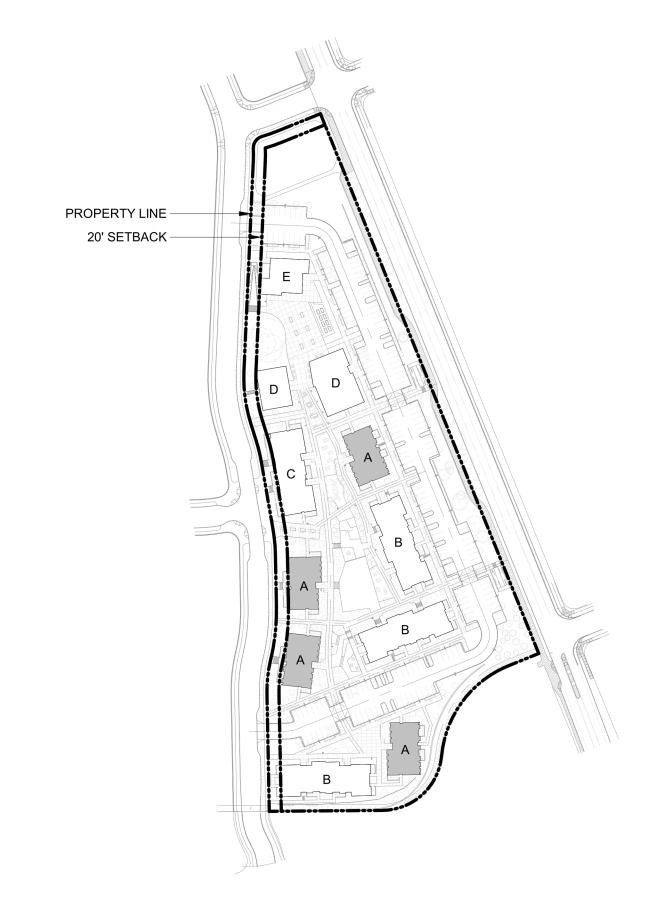

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CDP SALEM -BUILDING A Job Number: **5205 BATTLE CREEK RD SE SALEM, OR 97306**

SITE PLAN - ZONING DIAGRAM



702.020 MULTIPLE FAMILY DESIGN REVIEW STANDARDS

SECTION	REQUIRMENT MET OR ADJUSTMENT REQUESTED	SHEET NUMBER			
SITE SAFETY & SECURITY					
702.020.c.1	REQUIREMENT MET	A2.11-A2.13			
702.020.c.2	REQUIREMENT MET	A3.01-A3.02			
FACADE & BUILDING DESIGN					
702.020.e.1	REQUIREMENT MET	A2.11-A2.14			
702.020.e.8	REQUIREMENT MET	A3.02			
702.020.e.9	ADJUSTMENT REQUESTED	A3.01			
702.020.e.10	REQUIREMENT MET	A3.01-A3.02			



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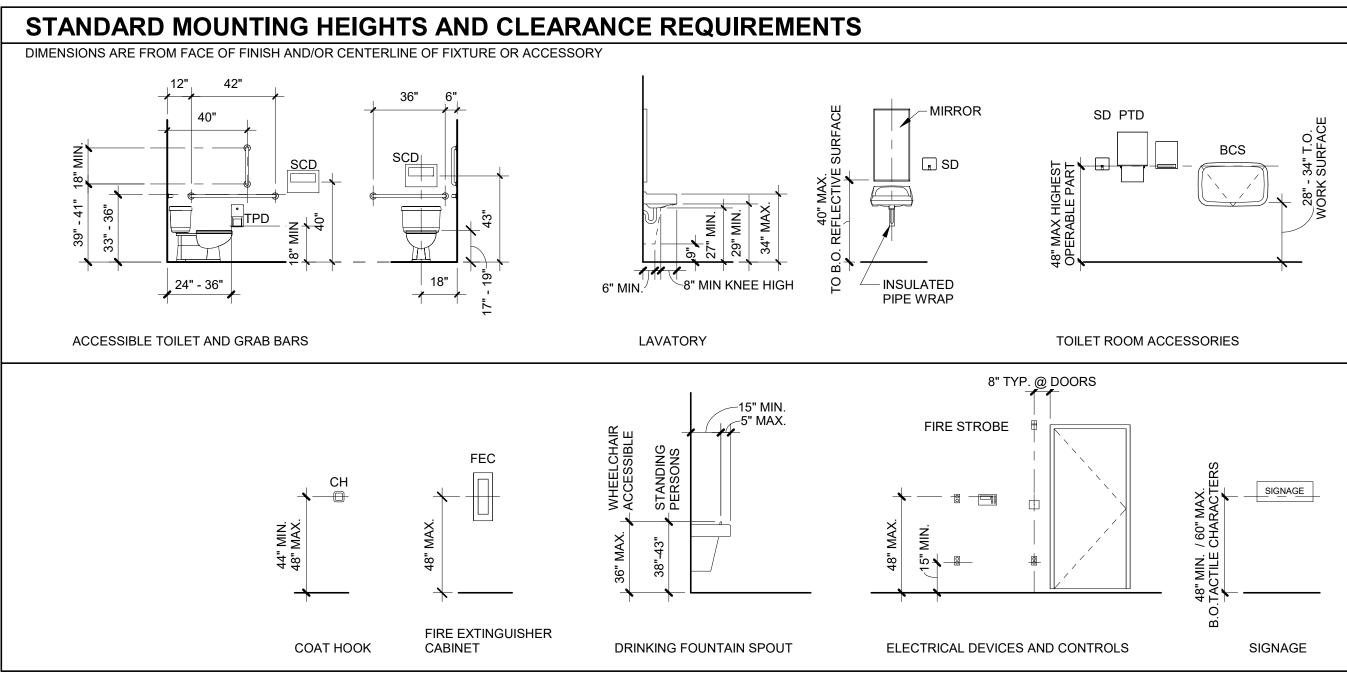
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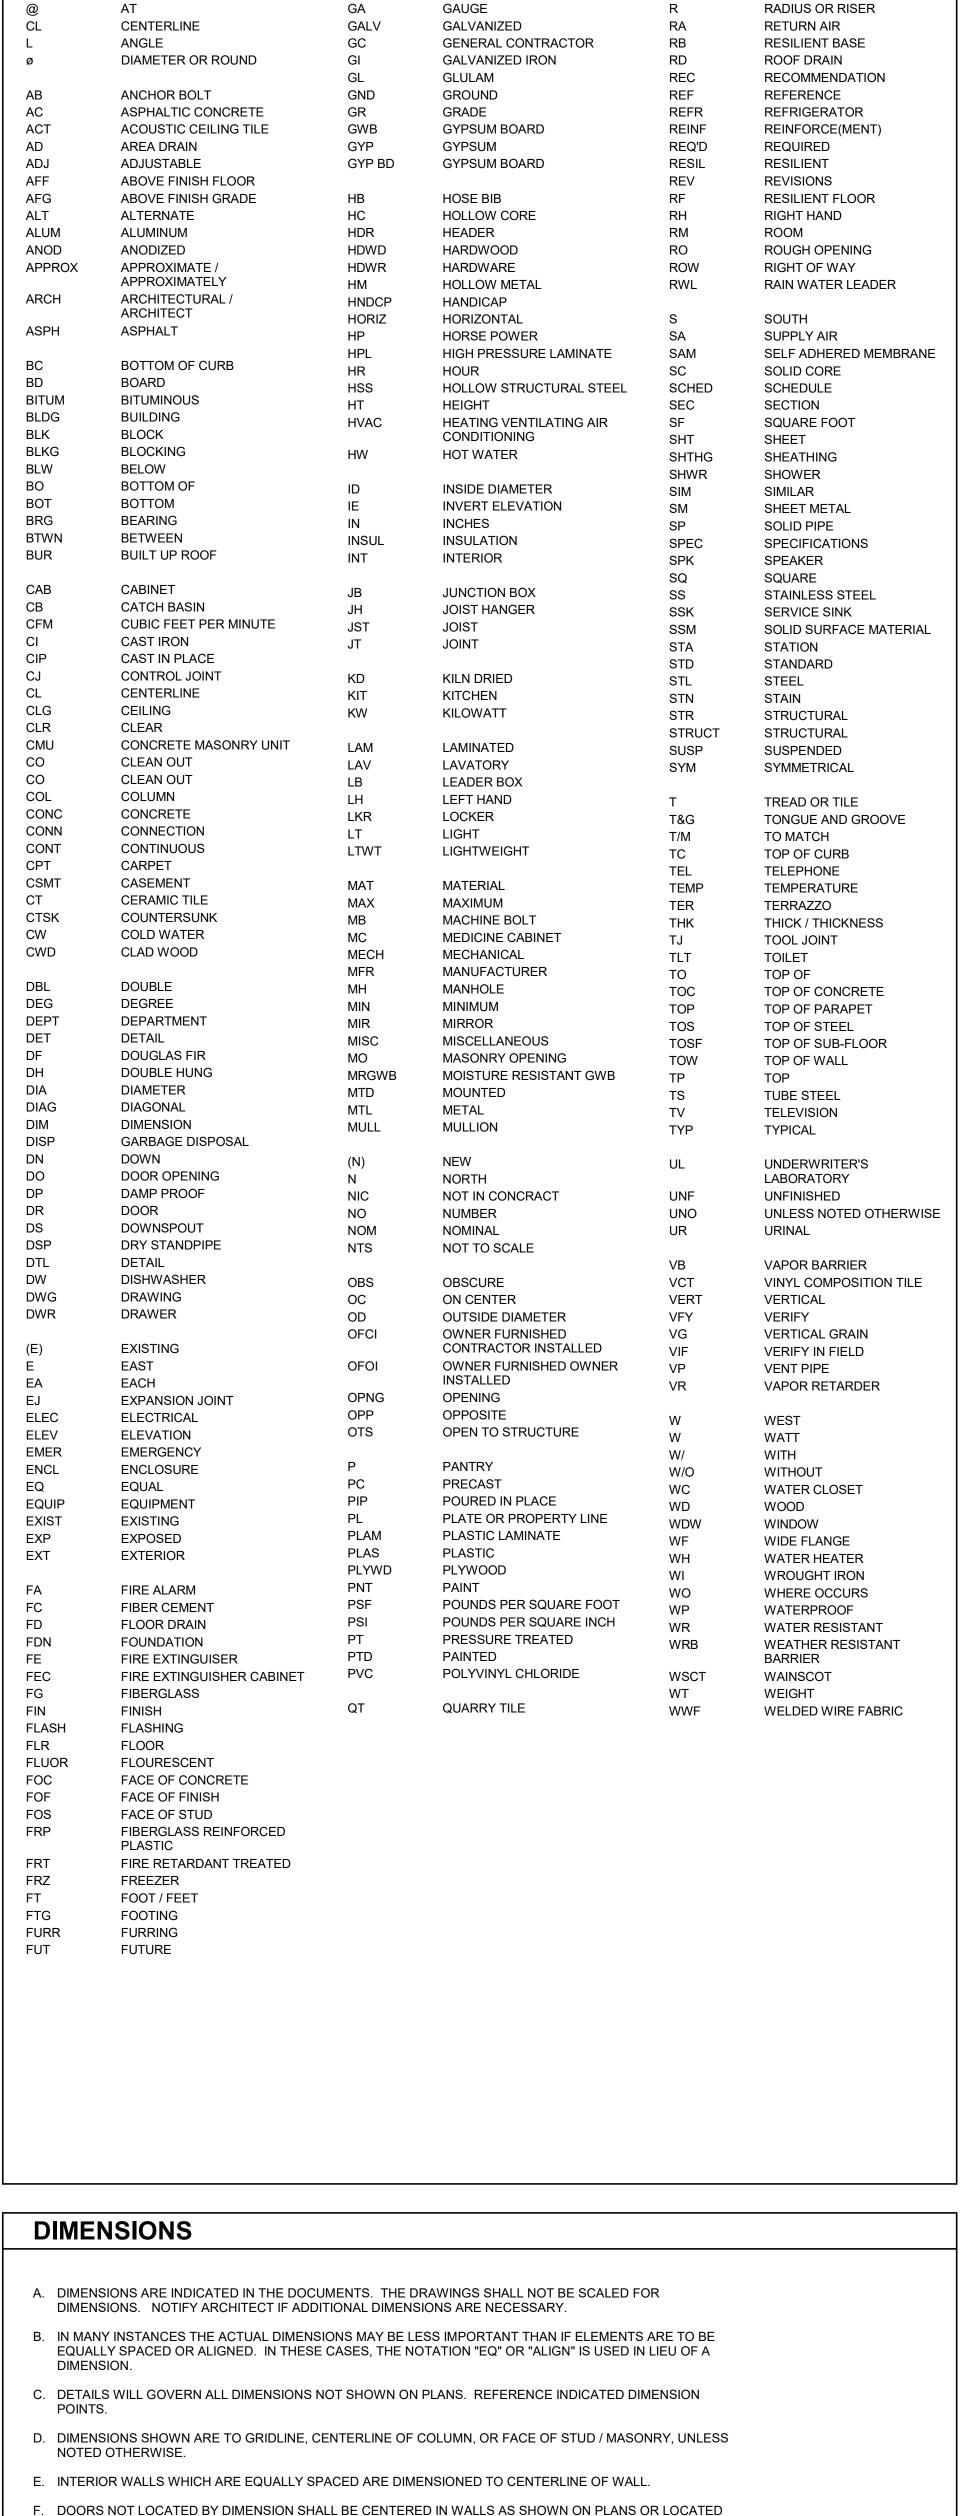
Drawing:

CODE SUMMARY

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CDP SALEM -**BUILDING A**

Job Number: **5205 BATTLE CREEK RD SE**

SALEM, OR 97306

Partners

BUILDING SECTION / WALL SECTION - DRAWING NUMBER \A4.01/ — — SHEET NUMBER INTERIOR ELEVATION → DRAWING NUMBER — SHEET NUMBER DETAIL CALLOUT - DRAWING NUMBER - SHEET NUMBER DOOR NUMBER - ROOM NUMBER — DOOR (101A)--CEILING HEIGHT - CEILING HEIGHT ABOVE LEVEL - ACCENT PAINT **COLOR WHERE** OCCURS WALL / ASSEMBLY TYPE - CONFIGURATION — WALL TYPE - MODIFIERS FLOOR / FLOOR-CEILING ASSEMBLY [F-#] CEILING ASSEMBLY [C-#] ROOF / ROOF-CEILING ASSEMBLY [R-#] - ASSEMBLY CATEGORY — ASSEMBLY NUMBER WINDOW TYPE ACCESSORY / EQUIPMENT TYPE 1 CASEWORK TYPE MATERIAL / FINISH - MATERIAL TYPE - MATERIAL NUMBER SPOT ELEVATION

GRAPHIC SYMBOLS

(1)— - — - —

NAME_ ELEVATION - -

- DRAWING

NUMBER

- SHEET NUMBER

NORTH

NORTH ARROW

GRID LINE

VERTICAL DATUM

ROOM NAME AND NUMBER

EXTERIOR ELEVATION

NAME

101

\A3.01/-

LAND USE 03.11.2022 SUBMISSION ISSUE DATE Drawing:

ARCHITECTURAL **GENERAL NOTES**



- SPECIFICATION

NOTE NUMBER

REVISION DOCUMENT

REVISION NUMBER

DIVISION NUMBER

X'-X" TC ─ TOP OF CURB HEIGHT


X'-X" BC
 BOTTOM OF CURB

KEYNOTE


REVISION


AND DIAGRAMS

Sheet No: Building A -

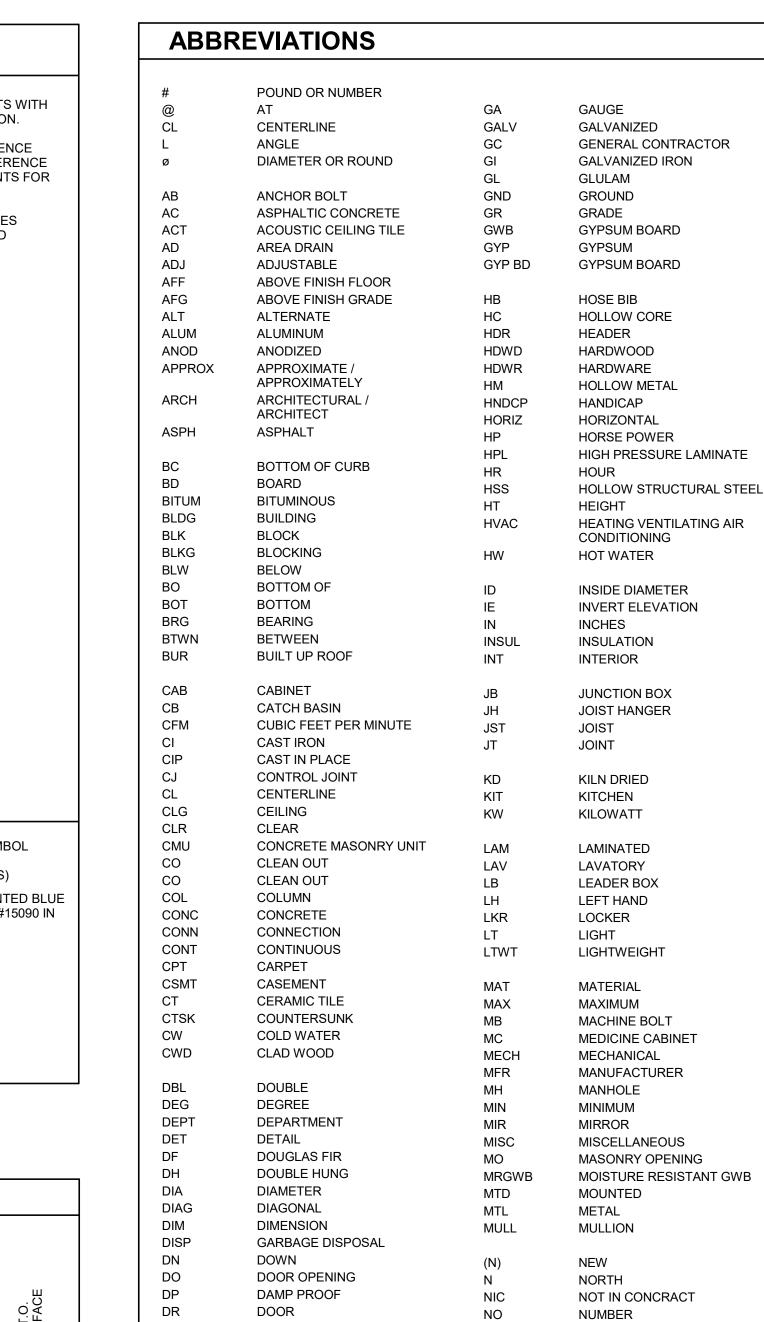


4 1/2" FROM FACE OF FINISH TO ROUGH OPENING.

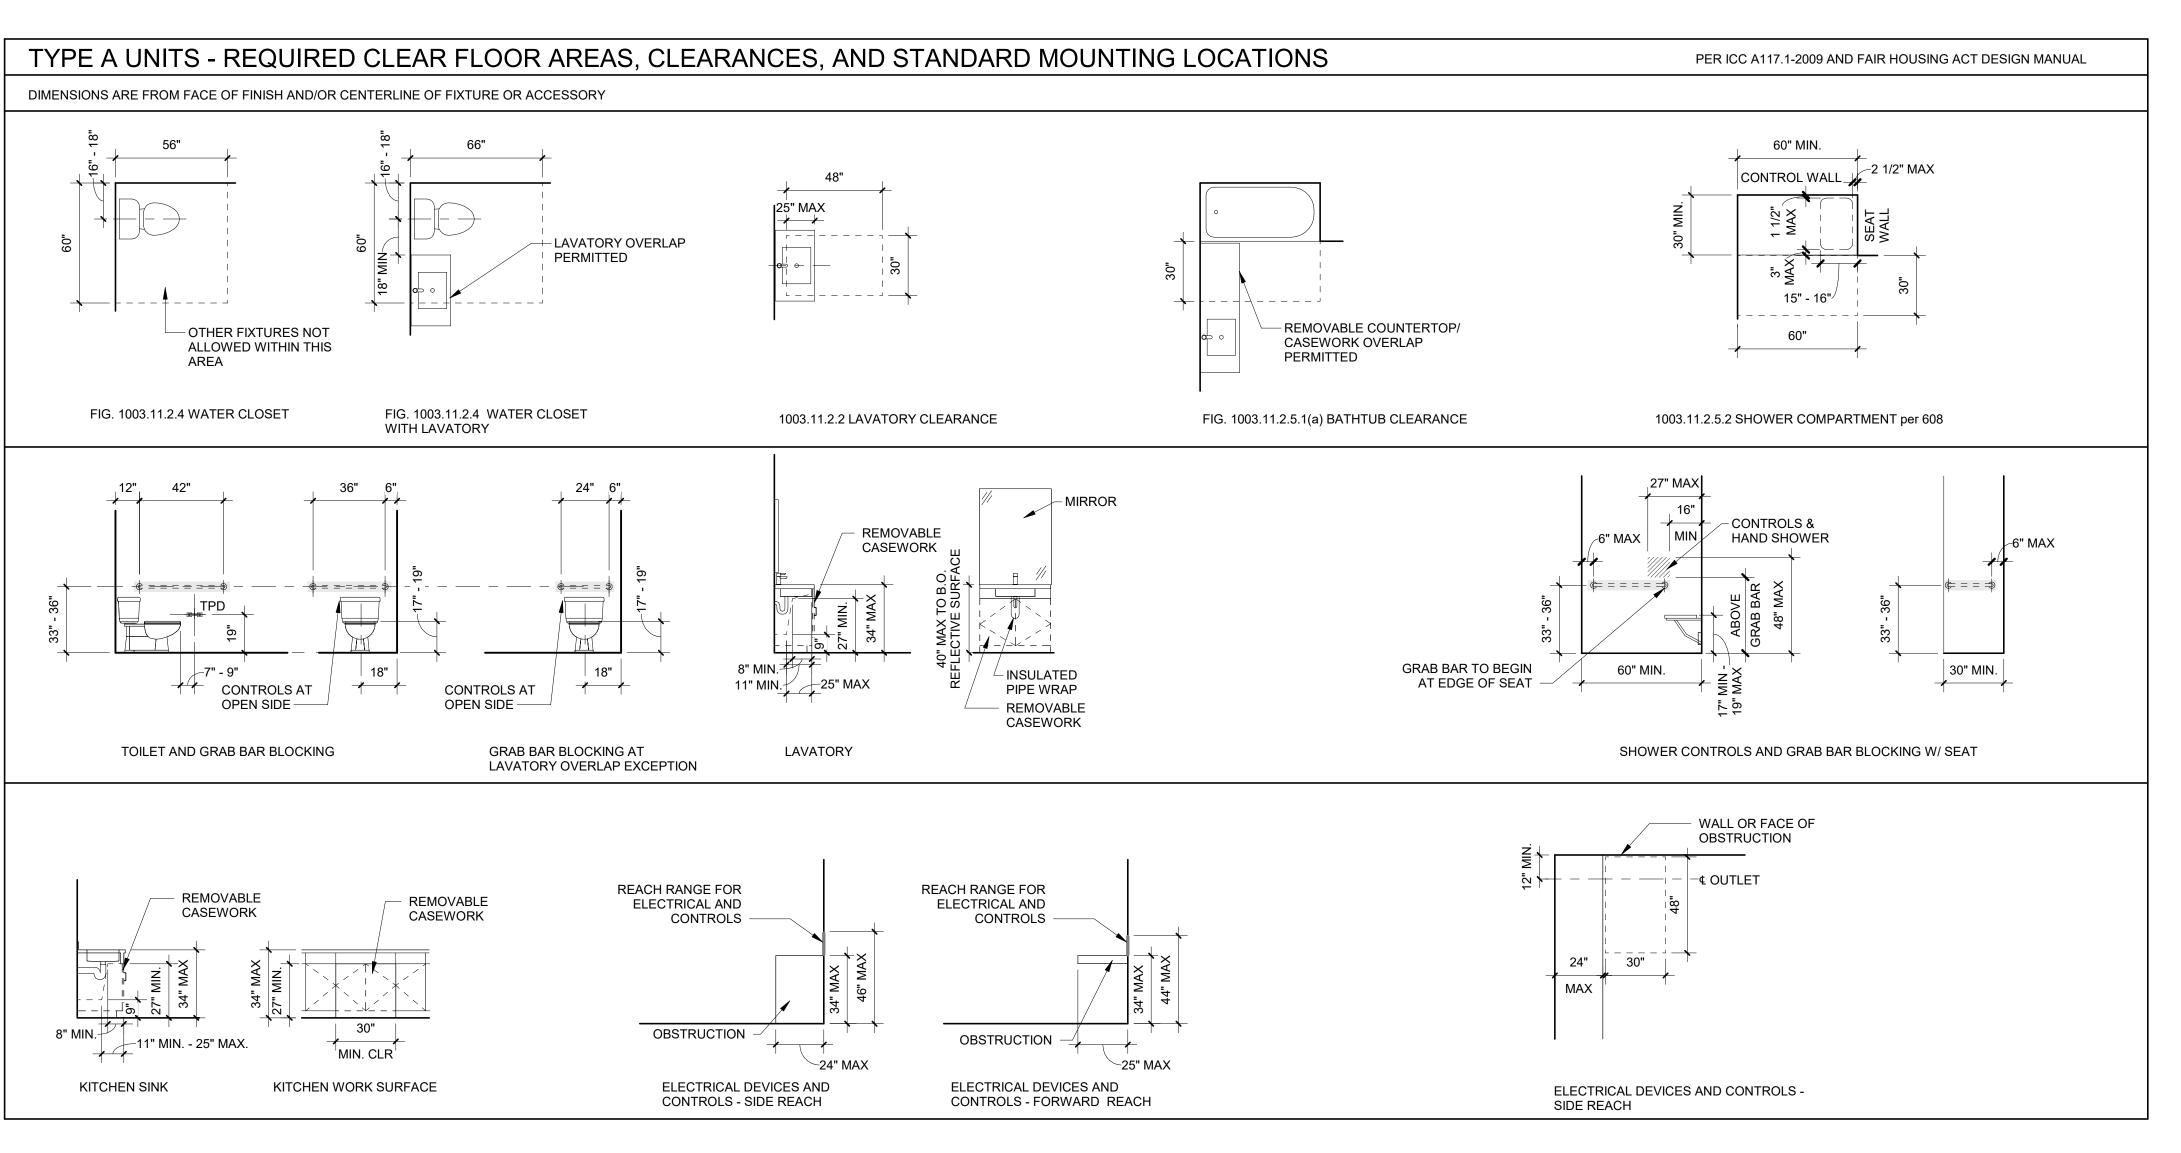

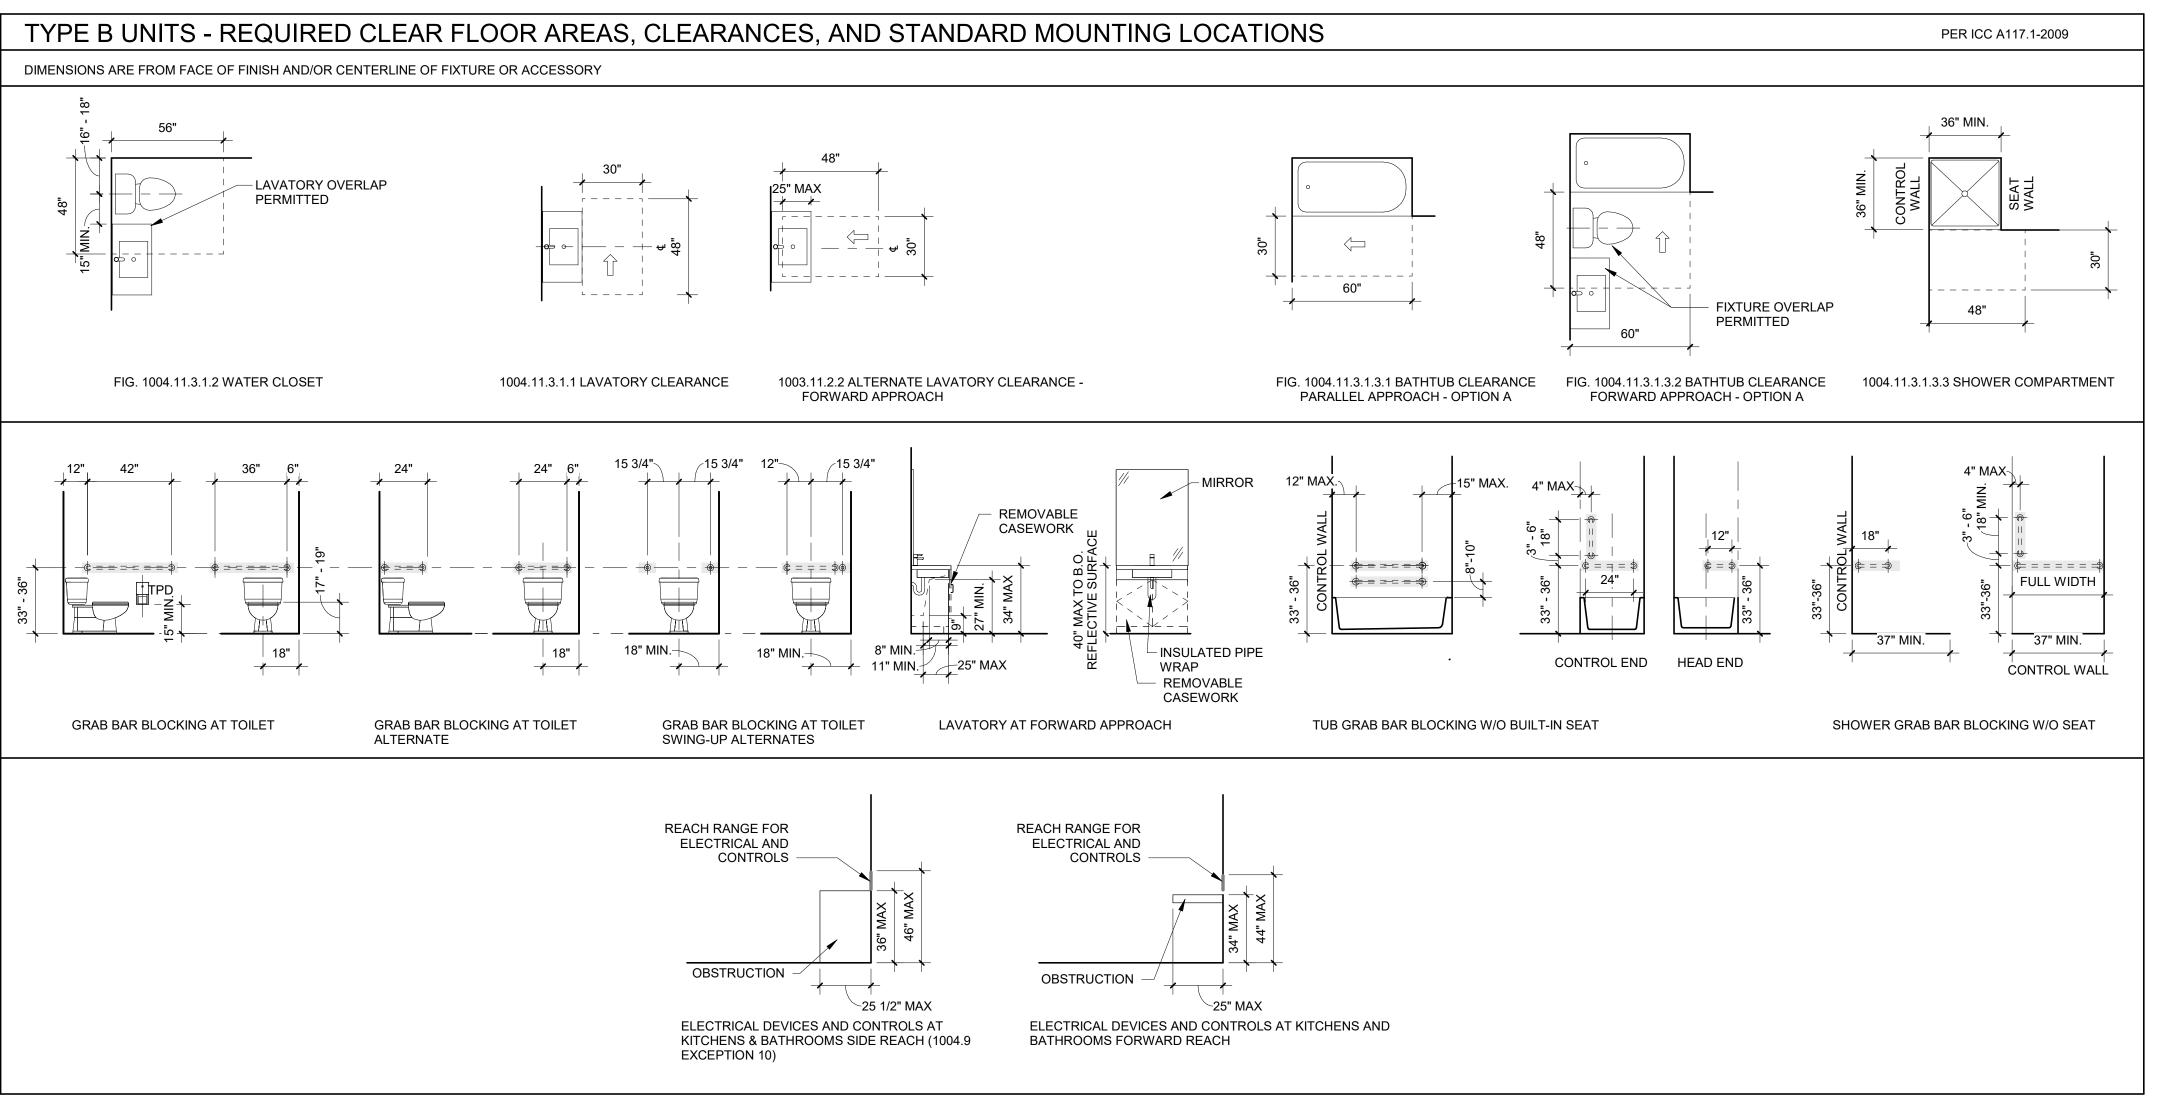



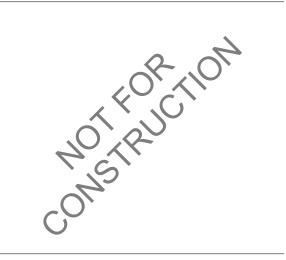

CDP SALEM -BUILDING A Job Number:

5205 BATTLE CREEK RD SE

SALEM, OR 97306



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ACCESSIBILITY DIAGRAMS -**RESIDENTIAL**

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PER ARCH

PLANS

— FLAT METAL PANEL

- 1/2" METAL Z-FURRING

- WRB (AIR BARRIER)

PER STRUCTURAL

PER STRUCTURAL

- VAPOR RETARDER

5/8" GYPSUM WALLBOARD

INSULATION

EXTERIOR FLAT METAL PANEL

- PLYWOOD SHEATHING

- WOOD STUD FRAMING

R-23 BLOWN-IN THERMAL

SAM STRIPS BEHIND FURRING

STRIP FASTENER PENETRATIONS

PLANS

EW4-X EXTERIOR FLAT PERFORATED METAL PANEL

— FLAT PERFORATED METAL PANEL

- SAM STRIPS BEHIND FURRING

STRIP FASTENER PENETRATIONS

1/2" METAL Z-FURRING

- WRB (AIR BARRIER)

PER STRUCTURAL

PER STRUCTURAL

- VAPOR RETARDER

INSULATION

- PLYWOOD SHEATHING

- WOOD STUD FRAMING

- R-23 BLOWN-IN THERMAL

GENERAL SHEET NOTES A. REFERENCE DETAILS FOR ASSEMBLIES NOT SHOWN HERE. B. SEE FINISH SCHEDULE, INTERIOR ELEVATIONS, AND DETAILS FOR SPECIAL CONDITIONS AND FIBER CEMENT SHINGLE APPLIED WALL FINISHES. MAINTAIN FIRE RATING OF WALLS AROUND FIRE **SCOTT EDWARDS** ARCHITECTURE LLP. - 1x4 PT WD VERT FURRING EXTINGUISHERS, CABINETS, AND OTHER RECESSED ITEMS. STRIPS TO ALIGN W/ FRAMING 2525 E Burnside Street, Portland, OR 97214 PROVIDE ACOUSTICAL SEALANT AT FLOOR / phone: (503) 226-3617 www.seallp.com CEILING/ WALL TRANSITIONS, RECESSED BOXES, - SAM STRIPS BEHIND FURRING AND PENETRATIONS OF SOUND RATED STRIP FASTENER PENETRATIONS ASSEMBLIES AND OTHER CONSTRUCTION AS REQUIRED TO ACHIEVE NOTED STC RATINGS. PROVIDE MOISTURE RESISTANT GYPSUM BOARD TYPICAL AT ALL RESTROOMS, BATHROOMS, AND - PLYWOOD SHEATHING PER KITCHEN WALLS. ALL FRAMING AND FINISHES OF INTERIOR WALLS TO EXTEND TO THE UNDERSIDE OF STRUCTURE - WOOD STUD FRAMING PER ABOVE UNLESS NOTED OTHERWISE. WHERE PARTITIONS ARE SOUND RATED OR FIRE RATED AND INCLUDE PROPRIETARY R-23 BLOWN-IN THERMAL MANUFACTURERS, NO SUBSTITUTIONS ARE H. ALL WOOD IN CONTACT WITH CONCRETE OR

MASONRY TO BE PRESSURE TREATED.

FOR ASSEMBLY DETAILS.

ASSEMBLY DETAILS.

WALL TYPE SYMBOL

WOOD FRAMING SIZES

ABBREVIATIONS

GA GYPSUM ASSOCIATION

 $4 = 2" \times 4"$

6 = 2" x 6"

 $8 = 2" \times 8"$

0 = MTL FURRING, 7/8" OR AS INDICATED

AT WALLS WITH RESILIENT CHANNELS SEE DETAIL

WHERE ACOUSTIC WALL IS INDICATED, SEE __ FOR

- WALL TYPE

SIZE

- PARTIAL HEIGHT / WALL

FIRE RATING (IN HOURS)

CONFIGURATION

FRAMING OR CONC

PER ARCH

PLANS

EXTERIOR FIBER CEMENT

EW1-X SHINGLE STRAIGHT

EDGE PANEL

STRAIGHT EDGE PANEL

- WRB (AIR BARRIER)

STRUCTURAL

STRUCTURAL

INSULATION

- VAPOR RETARDER

- 5/8" GYPSUM WALLBOARD

@ 16" O.C.

PLANS

- VERTICAL T&G CEDAR SIDING

- 1x4 PT WOOD FURRING,

SLOPED @ 45°

— WRB (AIR BARRIER)

PER STRUCTURAL

PER STRUCTURAL

VAPOR RETARDER

5/8" GYPSUM WALLBOARD

INSULATION

EXTERIOR VERTICAL WOOD

EW2-X SIDING

- PLYWOOD SHEATHING

— WOOD STUD FRAMING

- R-23 BLOWN-IN THERMAL

CDP SALEM -**BUILDING A** Job Number: **5205 BATTLE CREEK RD SE**

SALEM, OR 97306

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LAND USE

Drawing:

ASSEMBLIES

03.11.2022

DATE



CDP SALEM -BUILDING A

A. WALL DIMENSIONS ARE FROM FACE OF STUD OR CL OF COLUMN U.N.O.

C. ALL INTERIOR UNIT WALLS TO BE IW2-X.
D. ALL DOOR AND WINDOW DIMENSIONS ARE TO CL

E. REFERENCE STRUCTURAL DRAWINGS FOR

F. SEE DOOR SCHEDULE FOR DOOR TYPES AND

G. SEE WINDOW SCHEDULE FOR WINDOW TYPES H. FOR FLOOR FINISHES, SEE A10.21 SCHEDULES & FINISH LEGENDS.
WIRE SHELVING IN ALL BEDROOM CLOSETS J. M.E.P. INFORMATION PROVIDED FOR REFERENCE

INSTALLATION DETAILS CORRESPONDING TO

. FIRE EXTINGUISHER TO BE PLACED IN PANTRY IN

1 HOUR RATED ASSEMBLY

ELEMENT ABOVE

M. DOWNSPOUTS PAINTED IN FIELD, RECTANGLE SHAPE AND SIZE PER PLUMBING AND CIVIL

LEGEND REF A0.01 FOR GENERAL LEGENDS

OR OVERALL UNIT. REFERENCE SCHEDULES AND

GENERAL CONTROL JOINTS @ SLAB. COORDINATE FINAL LOCATIONS WITH ARCHITECT COMPATIBILITY

ARE TO FACE OF STUD U.N.O.

DOOR AND WINDOW TYPES


DIAGRAMS FOR LOCATIONS

WITH FLOOR FINISHES

DOOR NUMBERS

Job Number: 5205 BATTLE CREEK RD SE SALEM, OR 97306

R-1 ASPHALT SHINGLE ROOF 2x3 FLAT STYPE DOWNSPOUT Development Partners WATER HEATER WITH FLOOR DRAIN BELOW -SEE PLUMBING DWGS

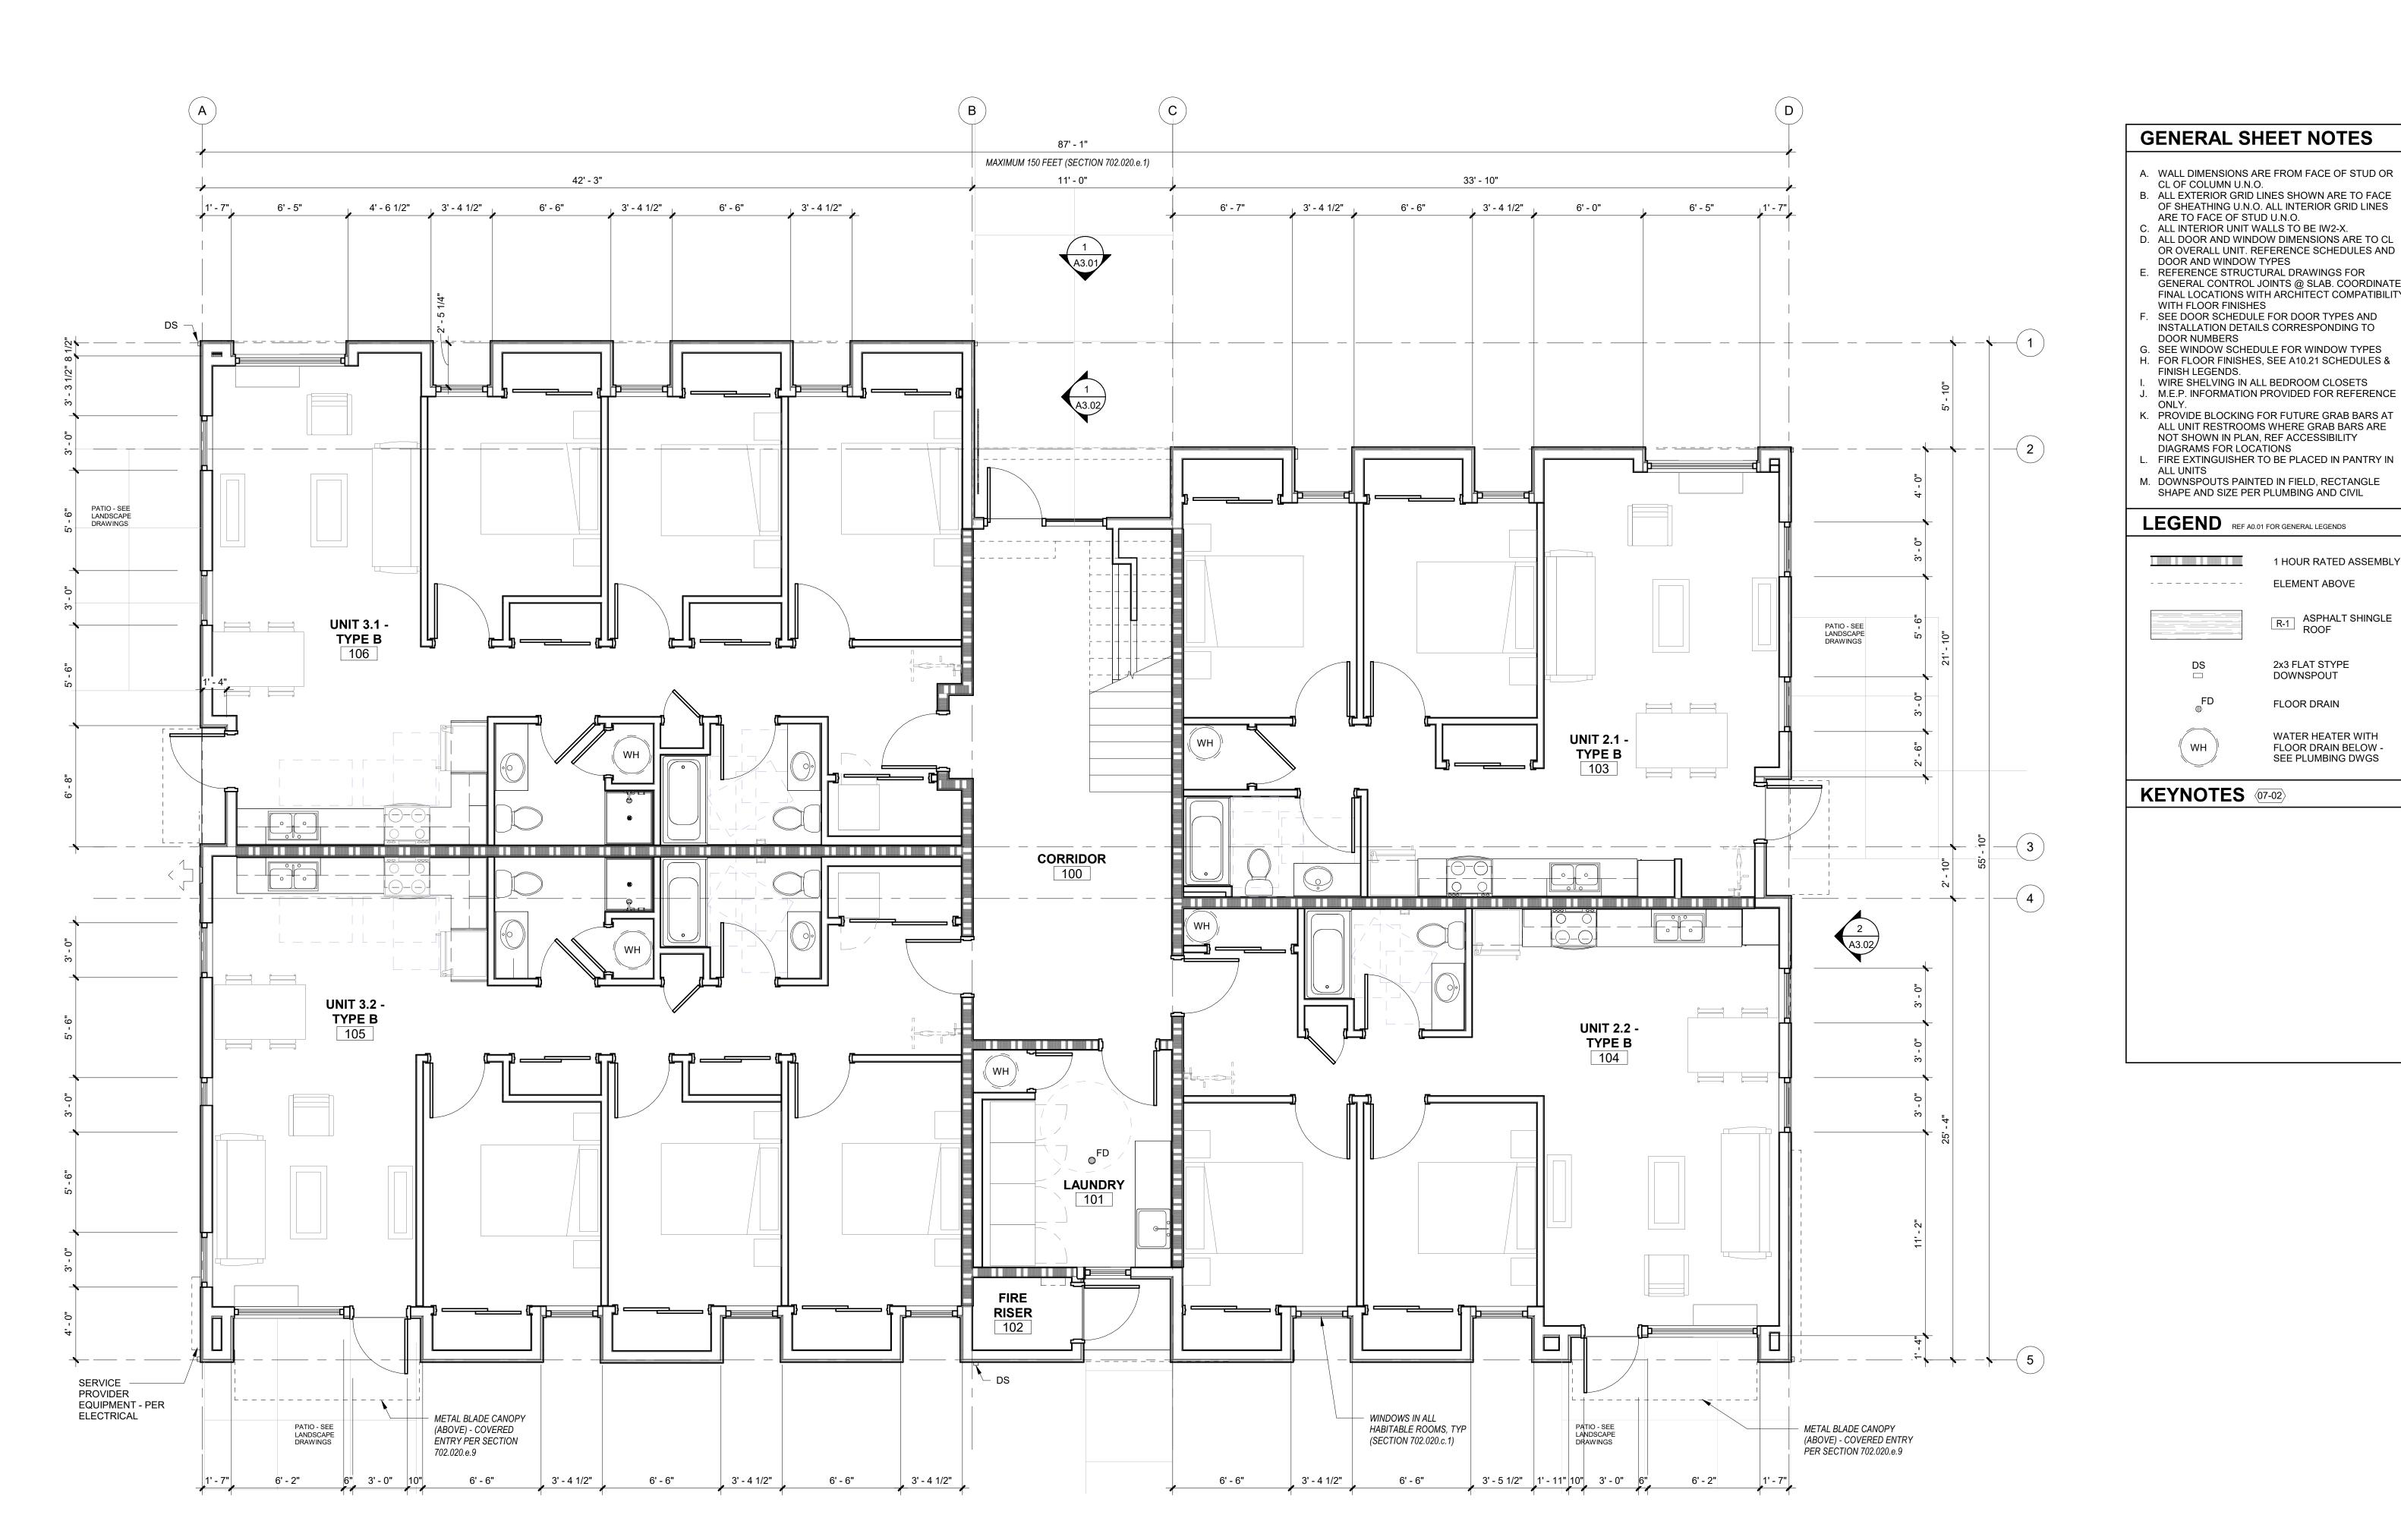


1 FIRST FLOOR PLAN
1/4" = 1'-0"

LAND USE SUBMISSION

Drawing:

FIRST FLOOR PLAN

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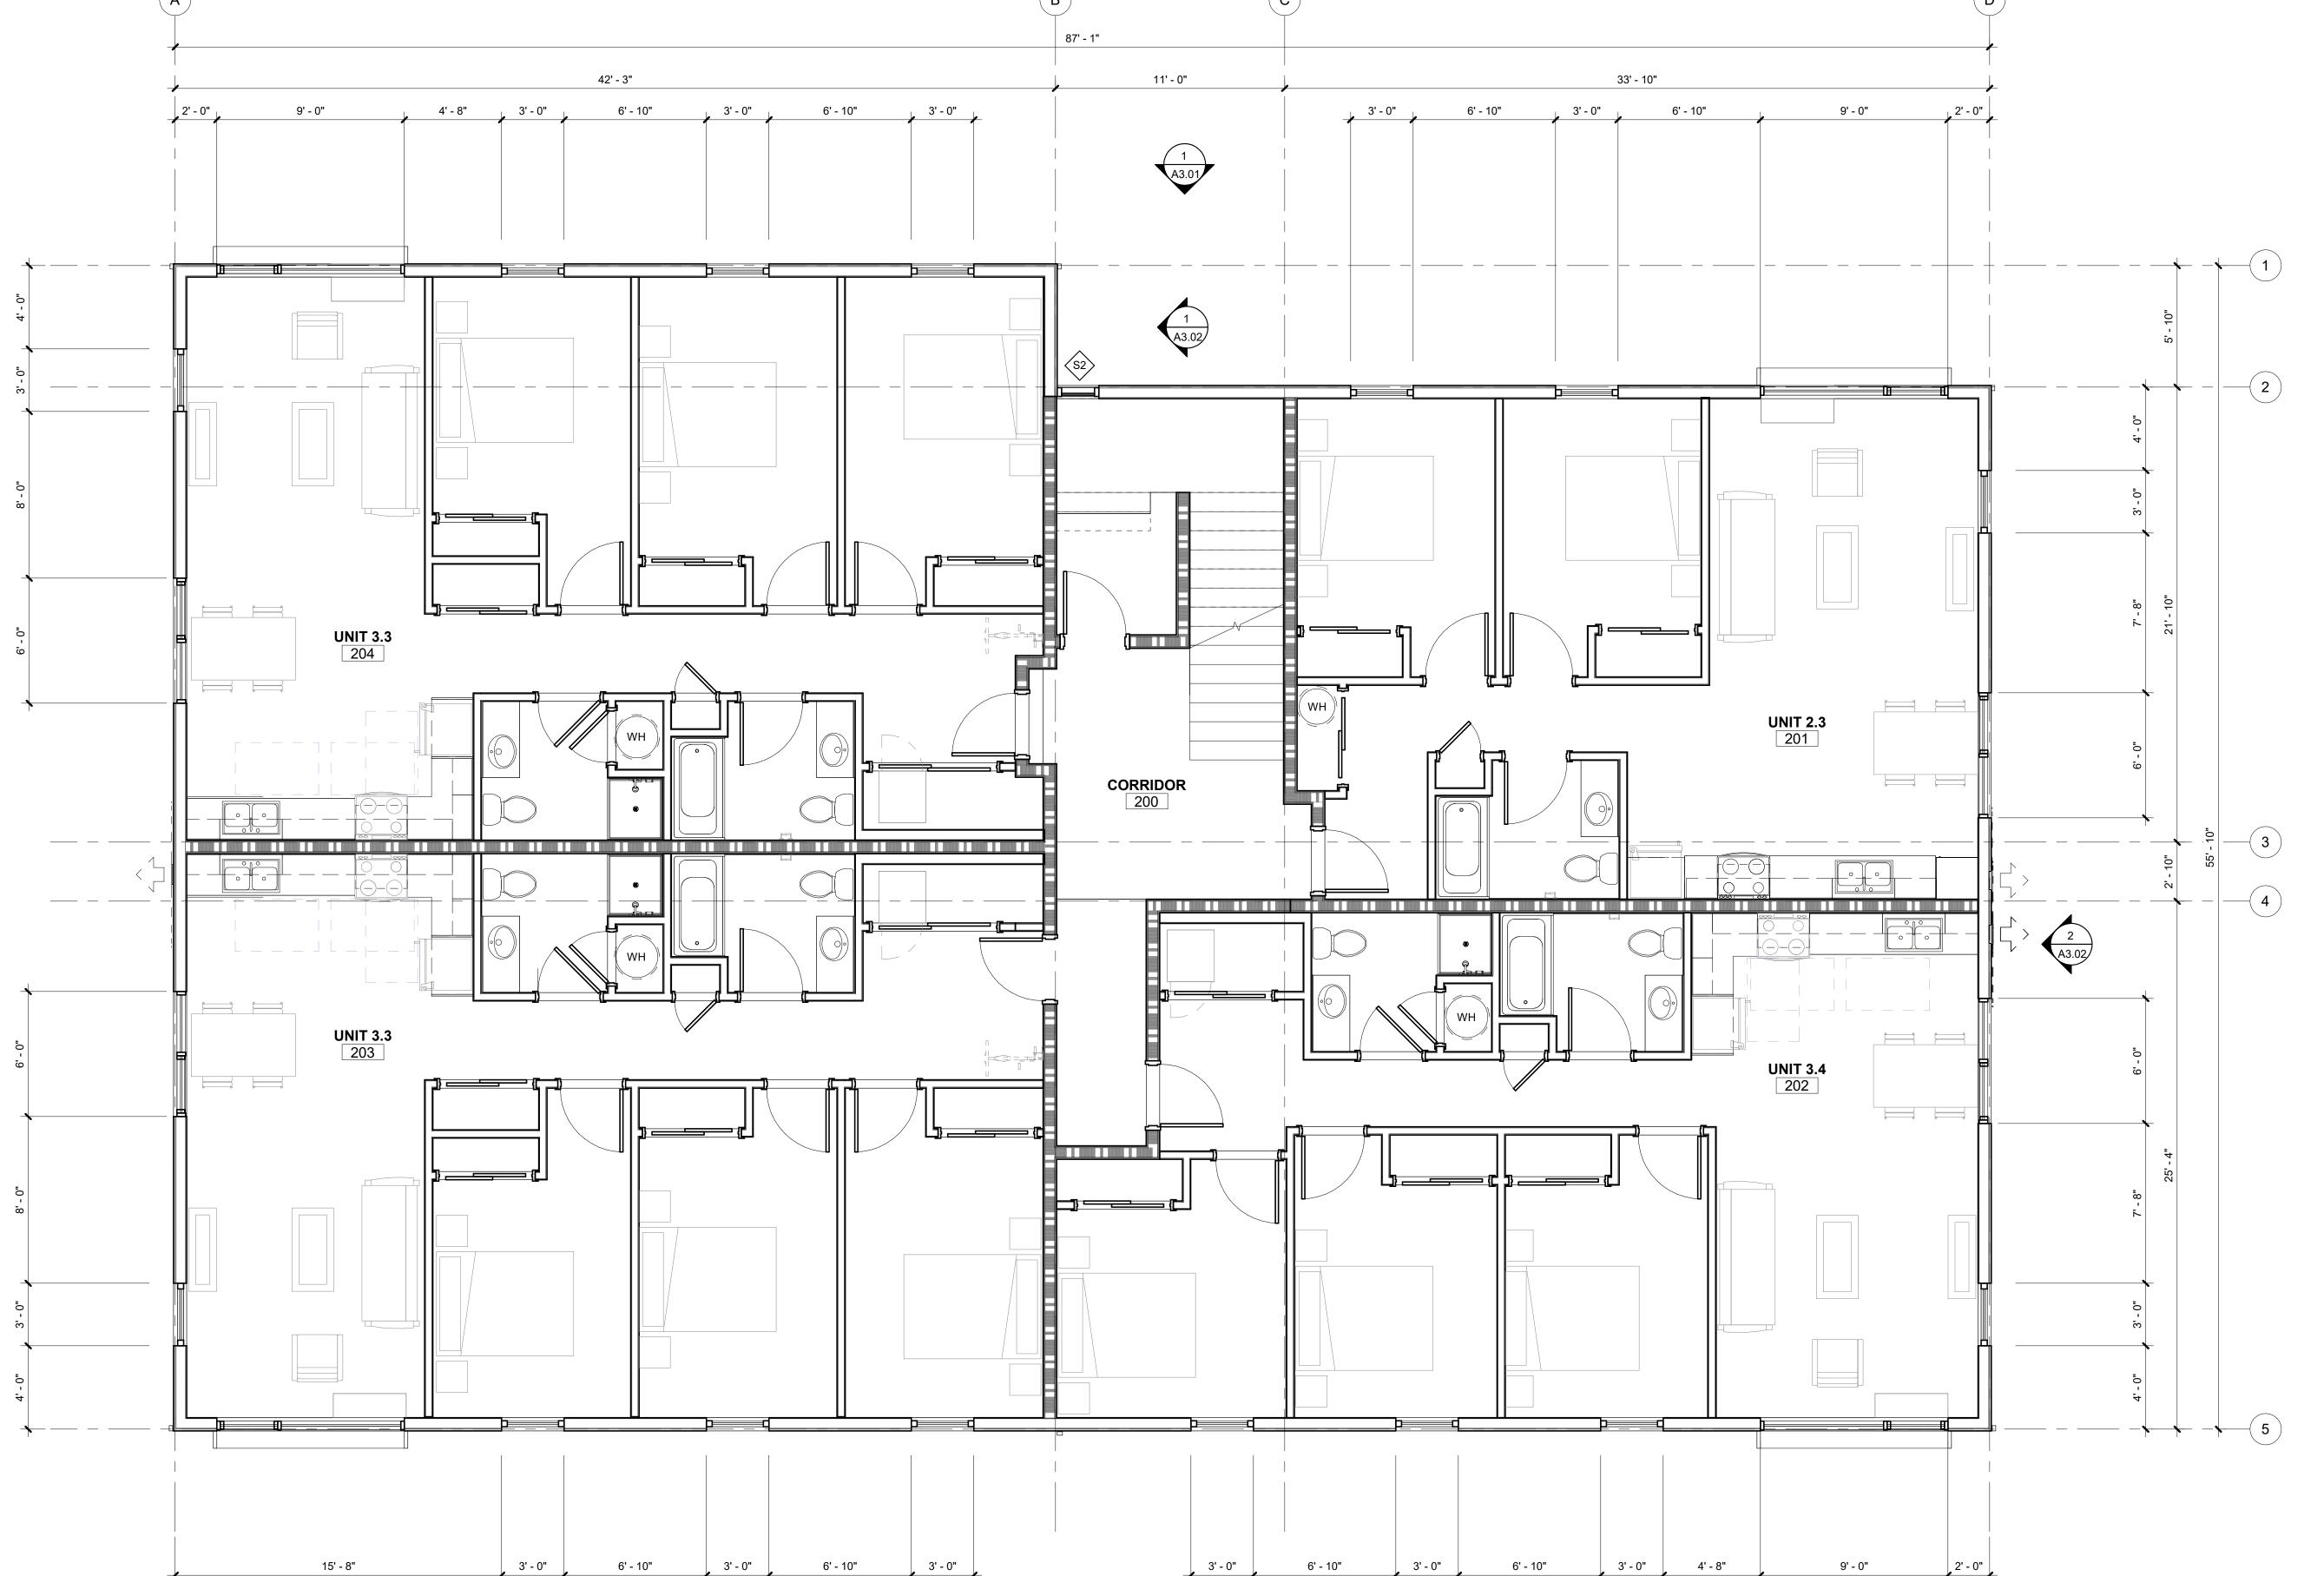
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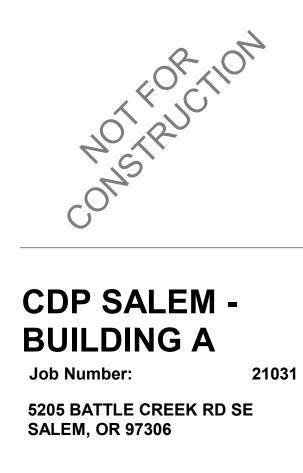
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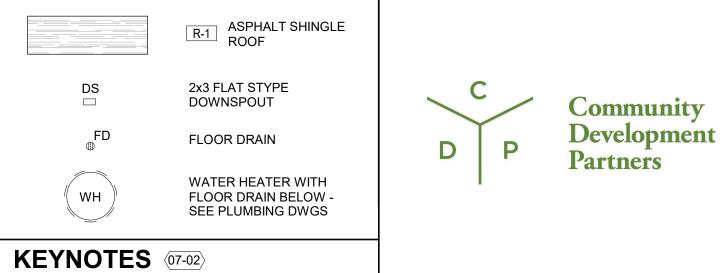
03.11.2022 DATE Drawing:

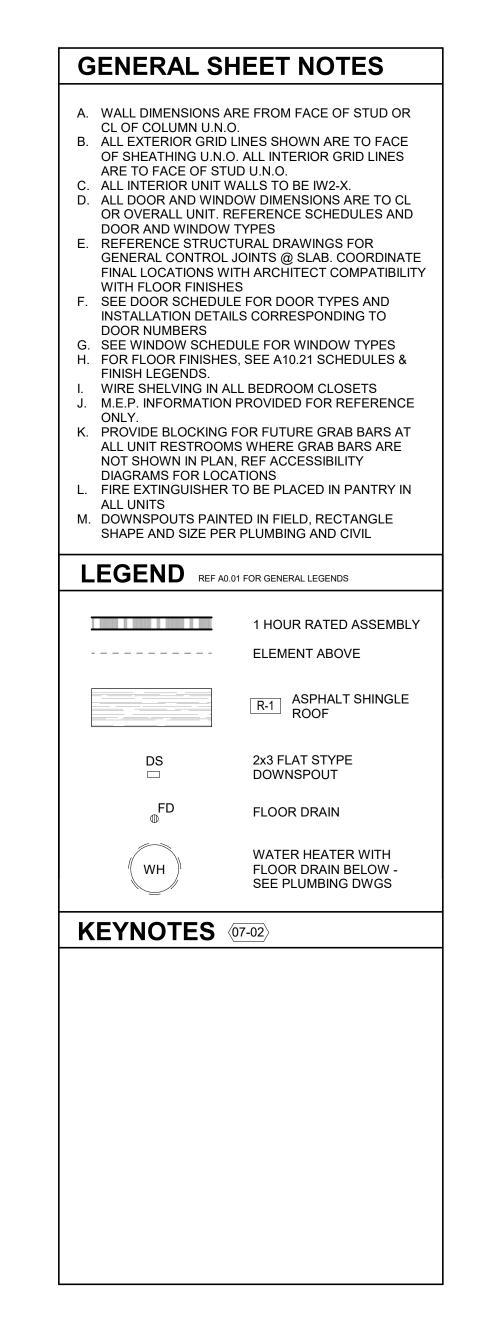SECOND FLOOR PLAN



SECOND FLOOR PLAN





GENERAL SHEET NOTES

A. WALL DIMENSIONS ARE FROM FACE OF STUD OR CL OF COLUMN U.N.O.

B. ALL EXTERIOR GRID LINES SHOWN ARE TO FACE OF SHEATHING U.N.O. ALL INTERIOR GRID LINES

C. ALL INTERIOR UNIT WALLS TO BE IW2-X.

D. ALL DOOR AND WINDOW DIMENSIONS ARE TO CL
OR OVERALL UNIT. REFERENCE SCHEDULES AND
DOOR AND WINDOW TYPES

GENERAL CONTROL JOINTS @ SLAB. COORDINATE FINAL LOCATIONS WITH ARCHITECT COMPATIBILITY

E. REFERENCE STRUCTURAL DRAWINGS FOR

F. SEE DOOR SCHEDULE FOR DOOR TYPES AND

G. SEE WINDOW SCHEDULE FOR WINDOW TYPES H. FOR FLOOR FINISHES, SEE A10.21 SCHEDULES & FINISH LEGENDS.

I. WIRE SHELVING IN ALL BEDROOM CLOSETS J. M.E.P. INFORMATION PROVIDED FOR REFERENCE

K. PROVIDE BLOCKING FOR FUTURE GRAB BARS AT ALL UNIT RESTROOMS WHERE GRAB BARS ARE NOT SHOWN IN PLAN, REF ACCESSIBILITY DIAGRAMS FOR LOCATIONS

L. FIRE EXTINGUISHER TO BE PLACED IN PANTRY IN

ALL UNITS

M. DOWNSPOUTS PAINTED IN FIELD, RECTANGLE
SHAPE AND SIZE PER PLUMBING AND CIVIL

1 HOUR RATED ASSEMBLY

ELEMENT ABOVE


LEGEND REF A0.01 FOR GENERAL LEGENDS

INSTALLATION DETAILS CORRESPONDING TO

ARE TO FACE OF STUD U.N.O.

WITH FLOOR FINISHES

DOOR NUMBERS

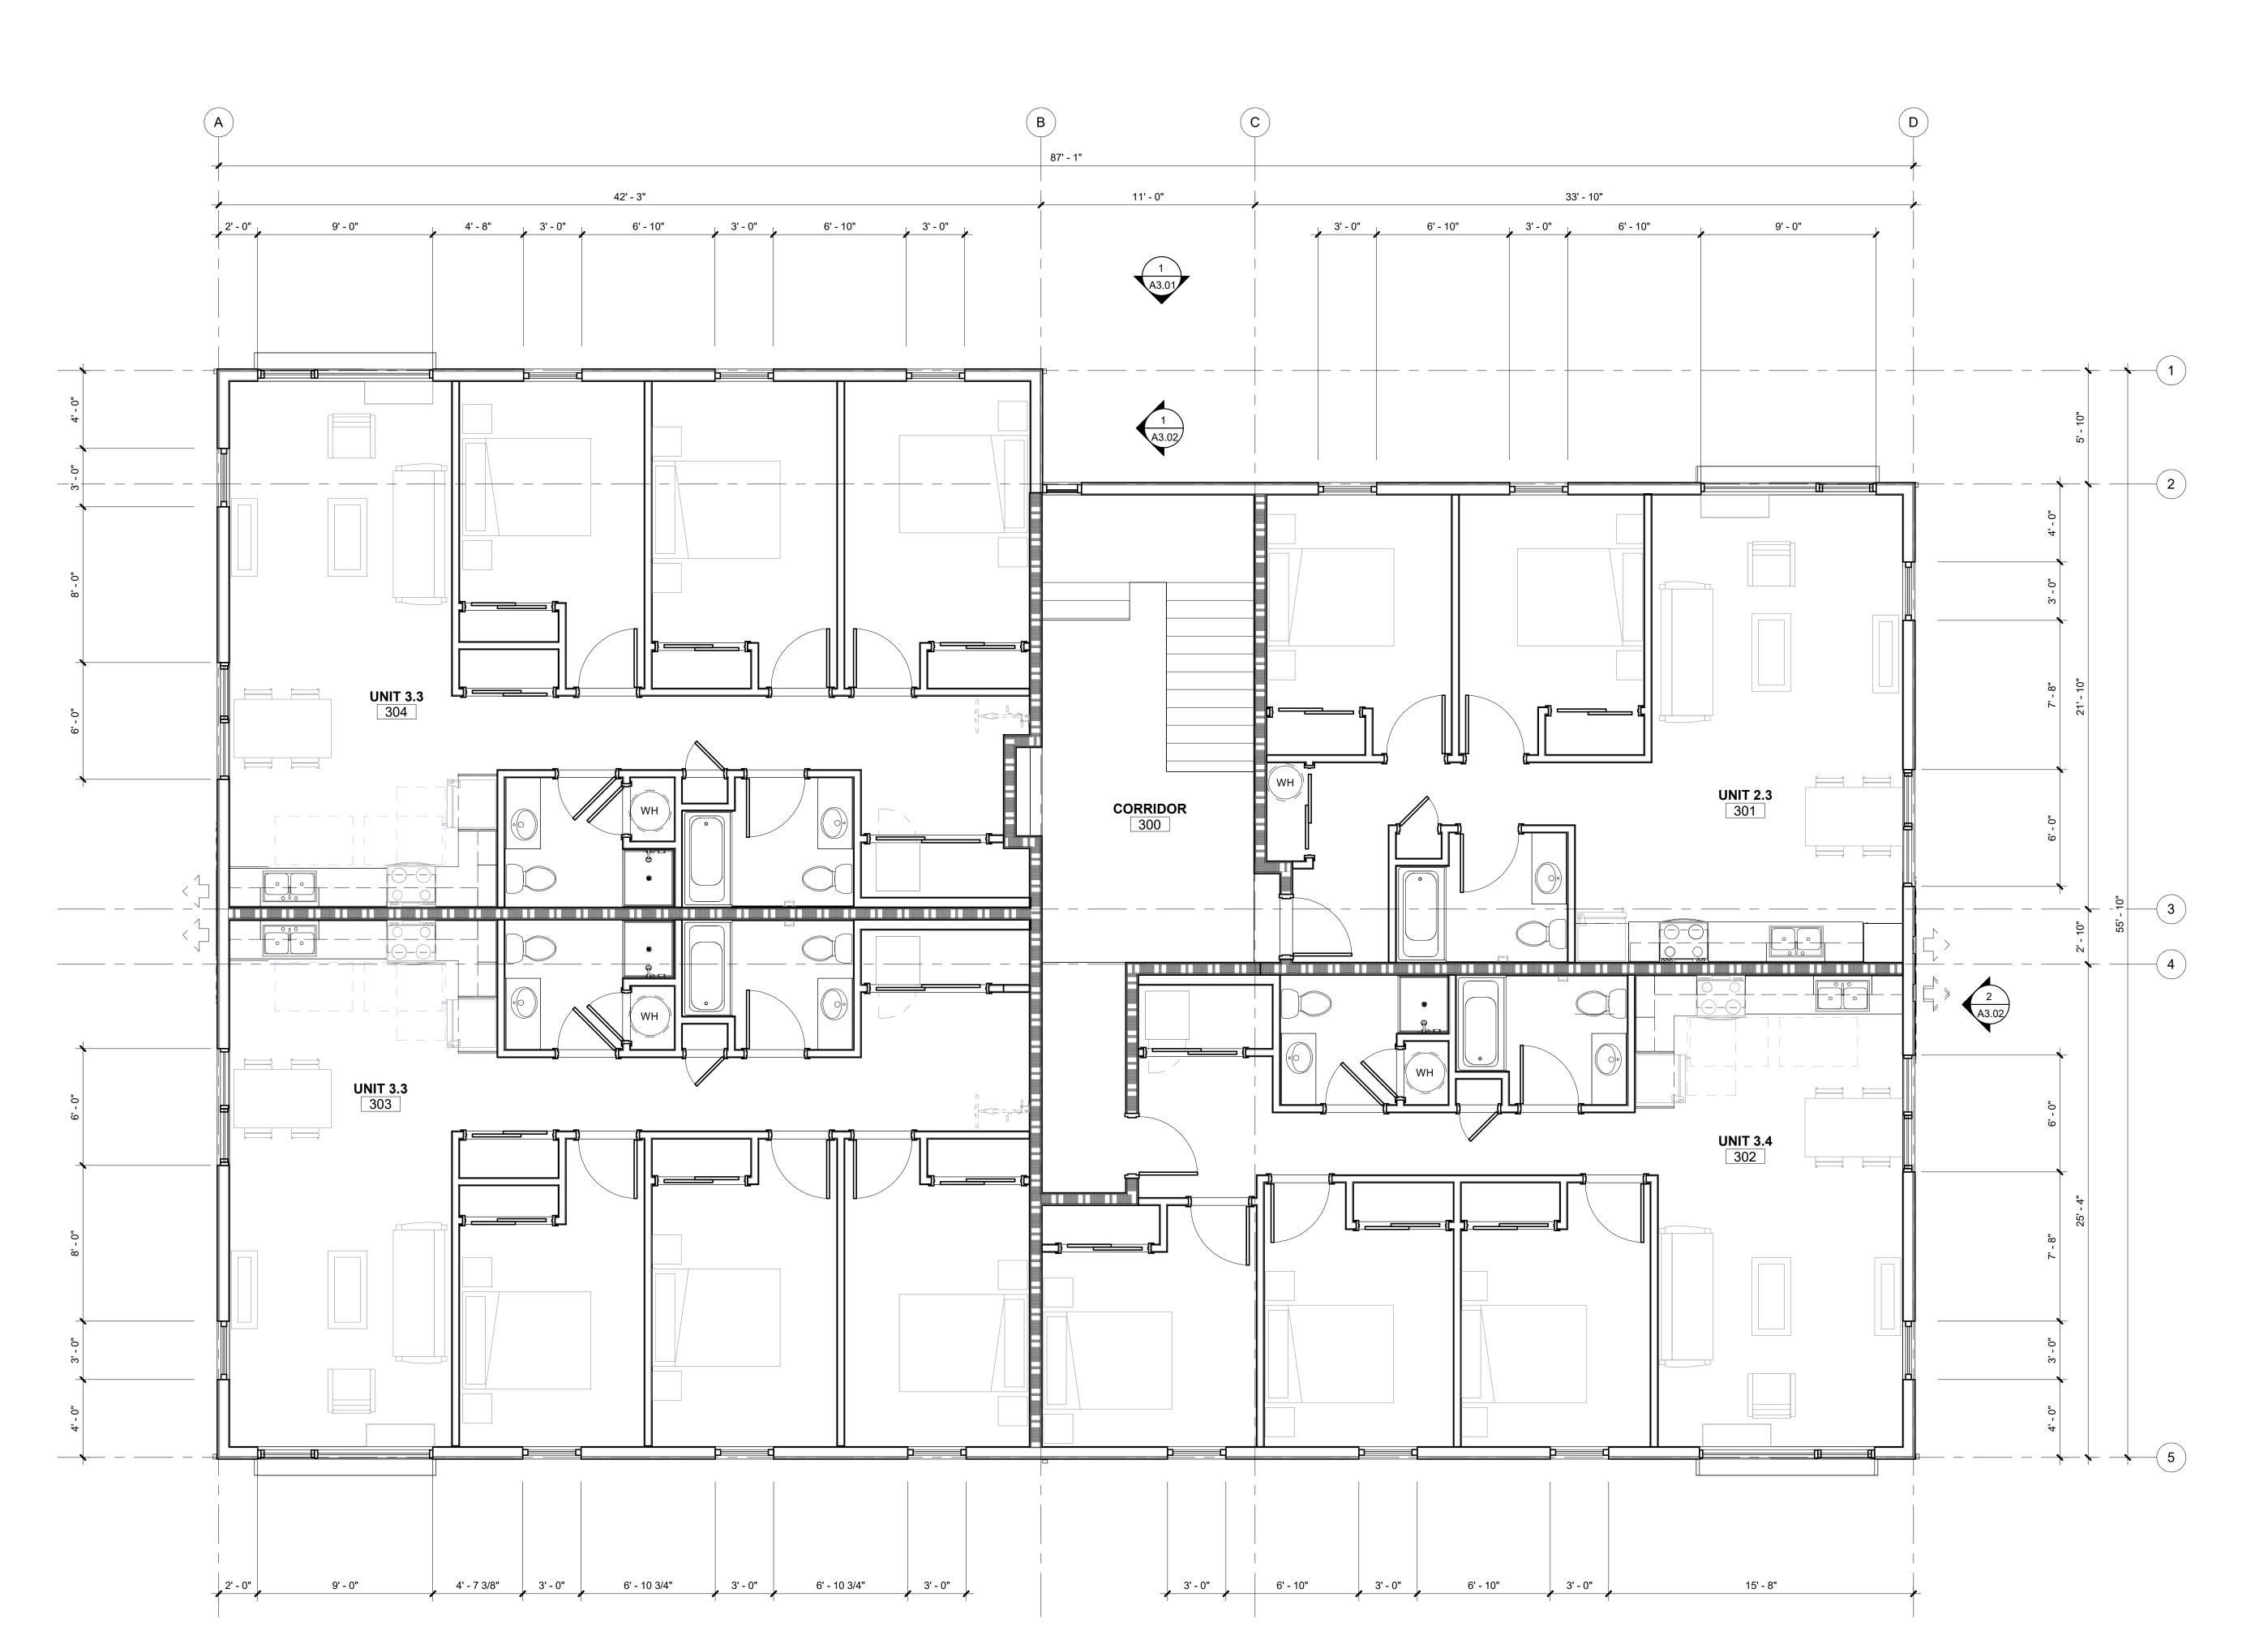

1 THIRD FLOOR PLAN
1/4" = 1'-0"

LAND USE SUBMISSION

THIRD FLOOR PLAN

03.11.2022

1 ROOF PLAN
1/4" = 1'-0"


CDP SALEM -

5205 BATTLE CREEK RD SE SALEM, OR 97306

Development Partners

BUILDING A

Job Number:

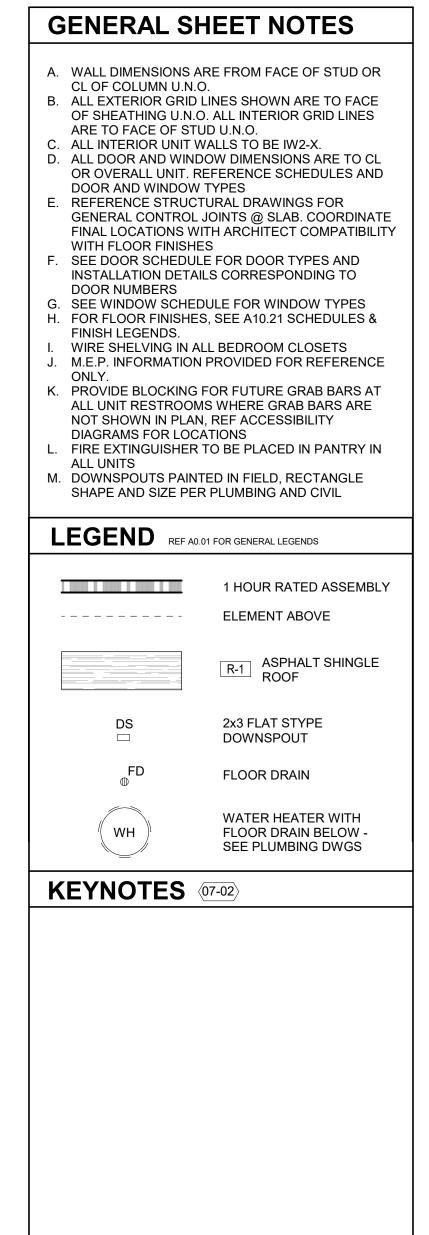


SEE MECHANICAL DRAWINGS FOR LOCATION OF MECHANICAL UNITS AND ROOF PENETRATIONS

MAXIMUM 150 FEET (SECTION 702.020.e.1) 11' - 0" 42' - 3" 33' - 10" DS $\overline{\ }$ RIDGELINE A3.02 5 1/2" / 1'-0" 5 1/2" / 1'-0" 5 1/2" / 1'-0" 5 1/2" / 1'-0"


LAND USE SUBMISSION ISSUE

Drawing: ROOF

03.11.2022

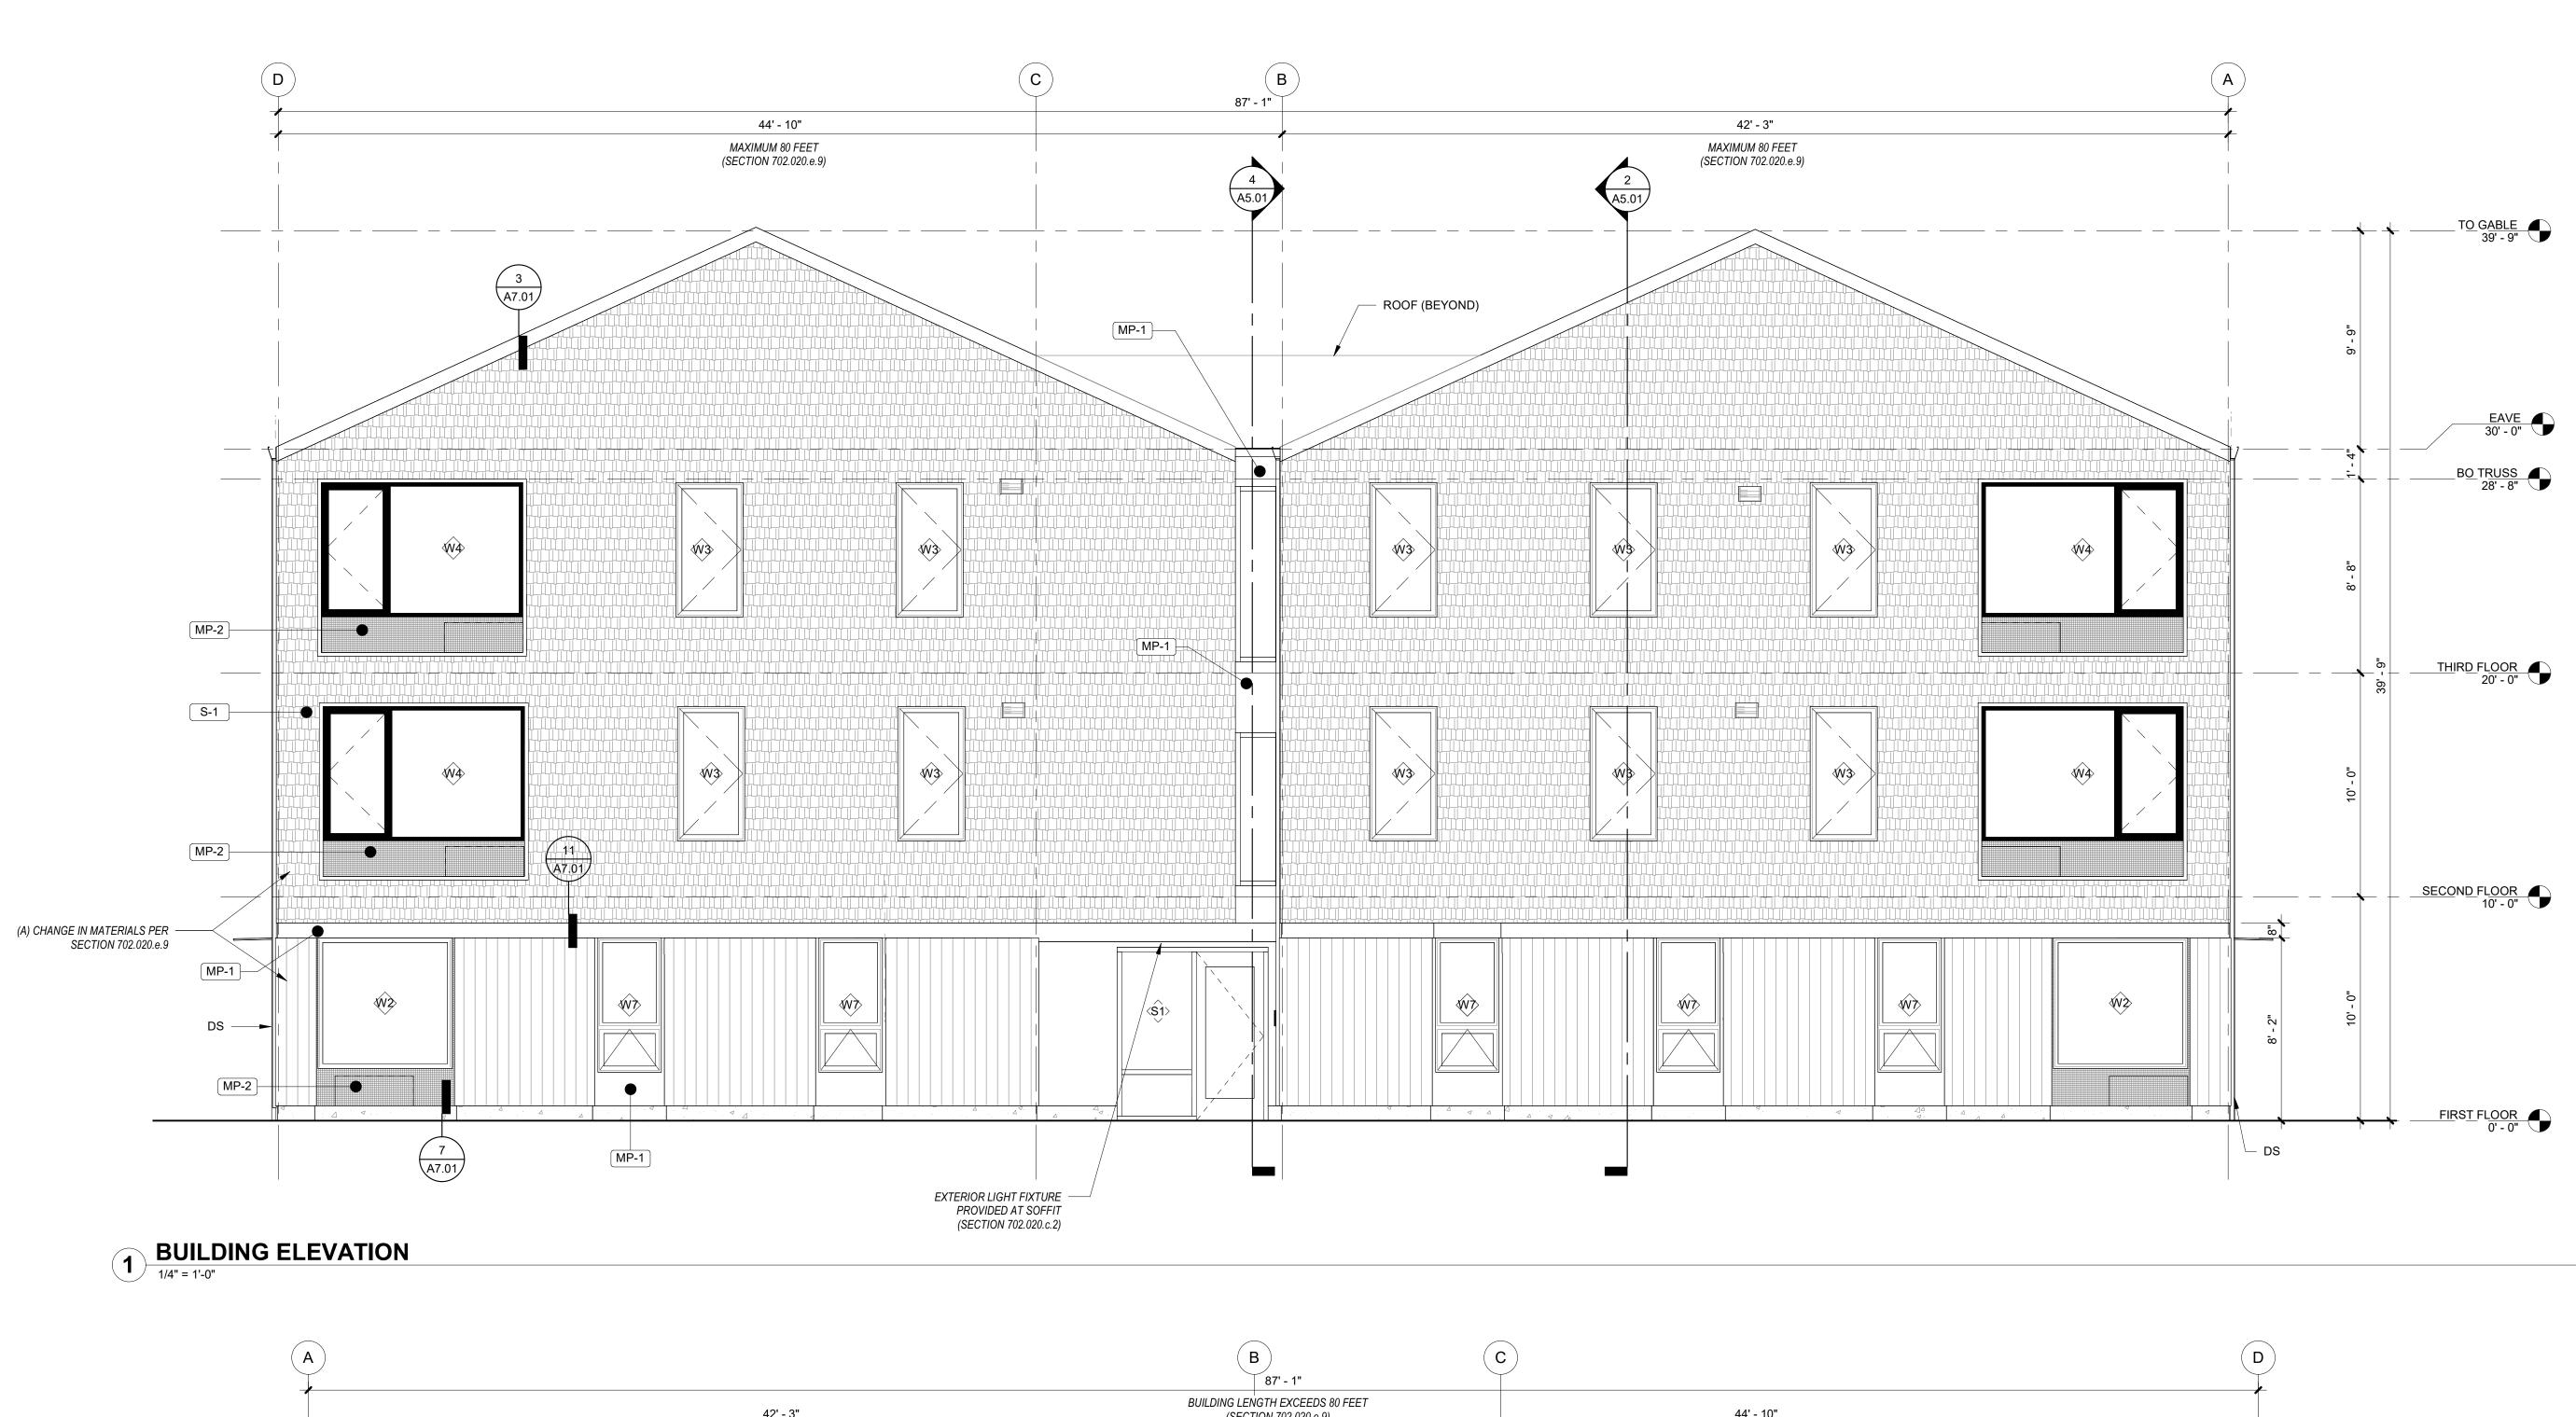



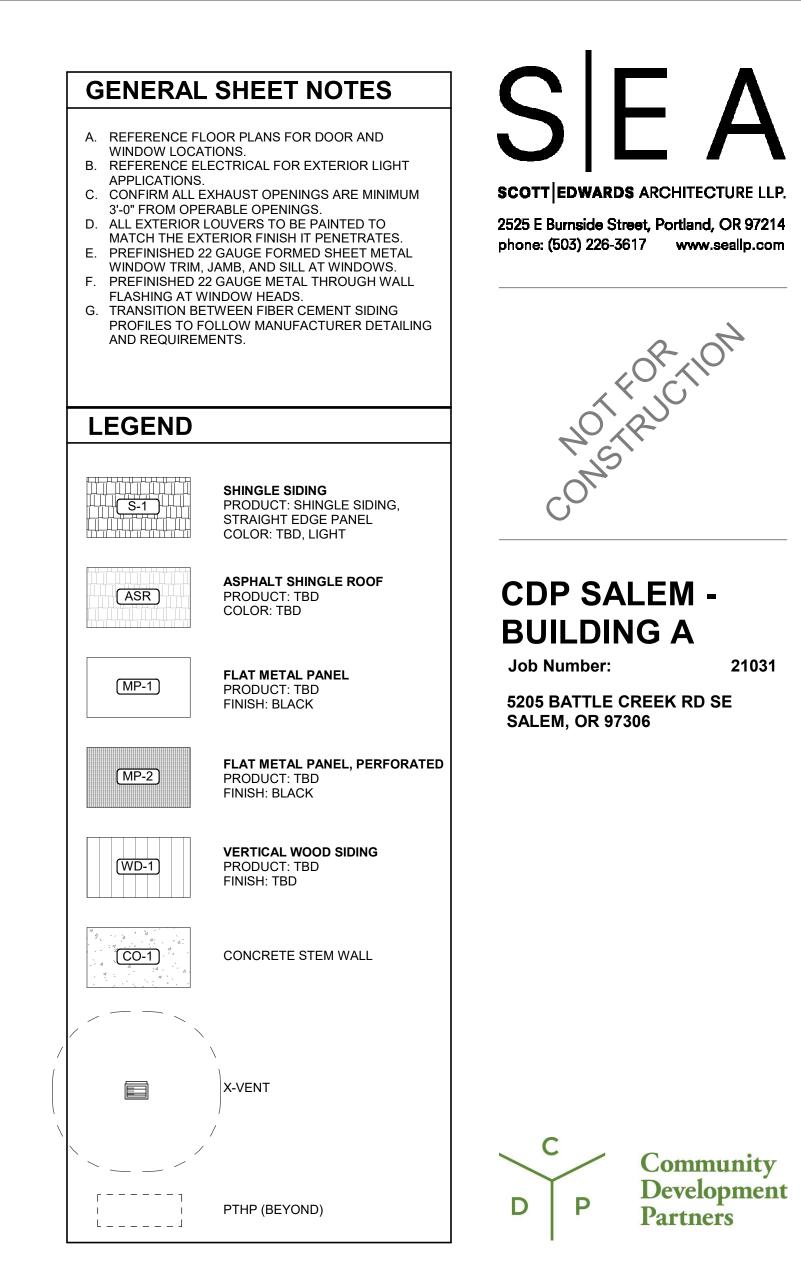


LAND USE SUBMISSION ISSUE

Drawing:


EXTERIOR ELEVATIONS

03.11.2022

DATE

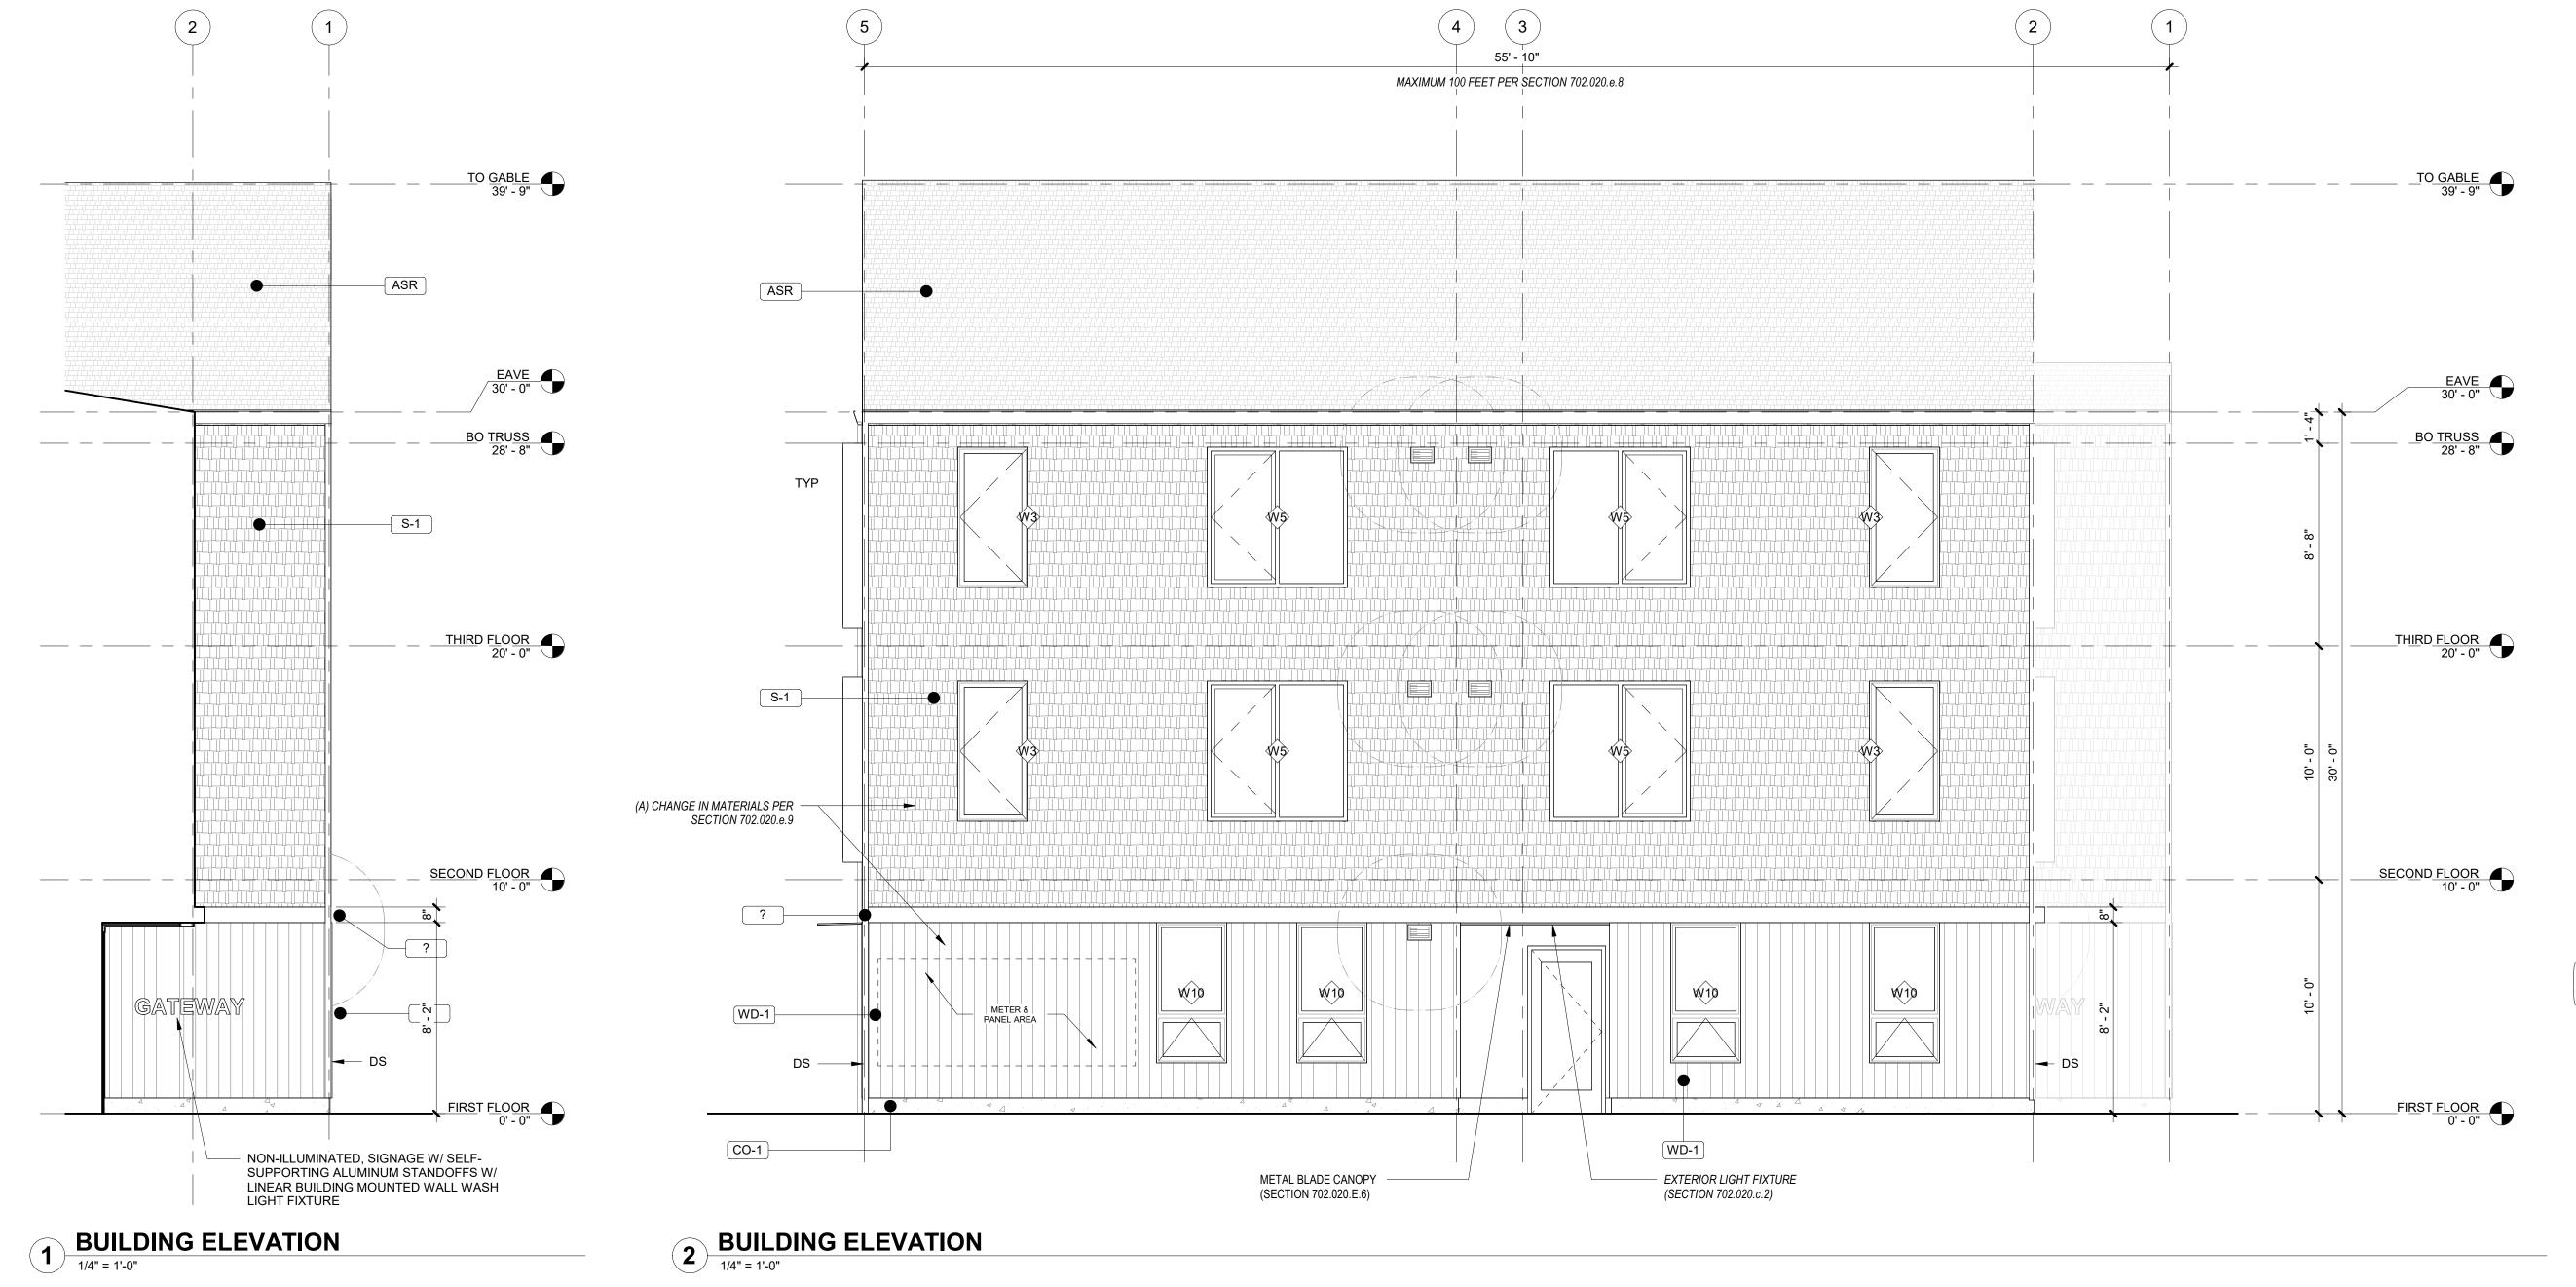



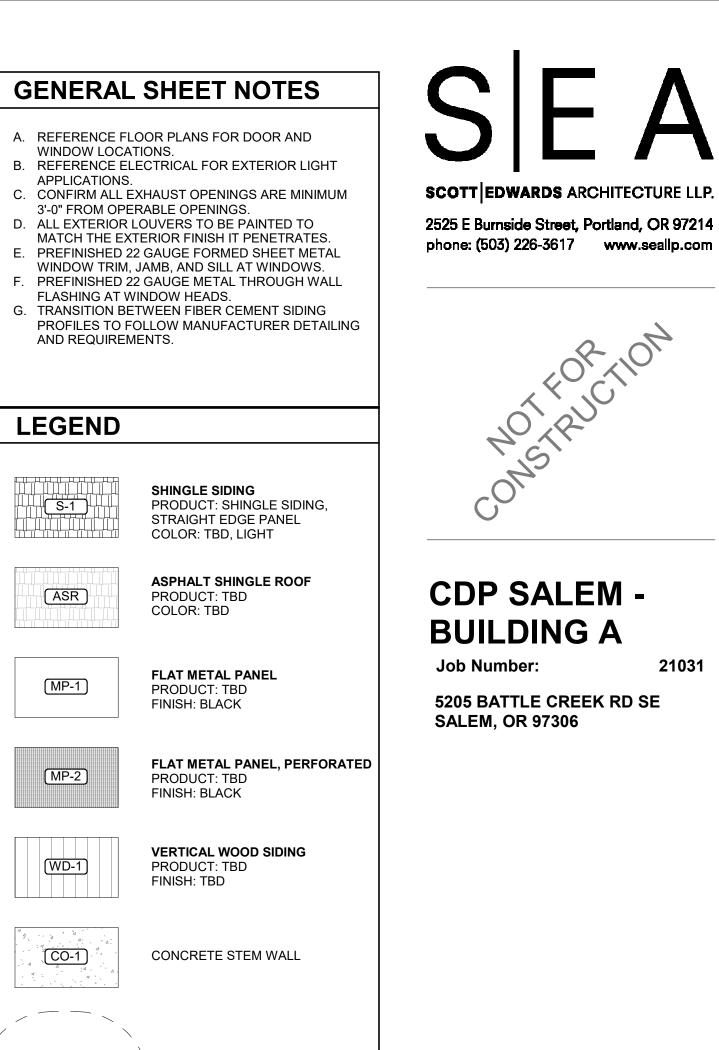

Development Partners

LEGEND

ASR

L _ _ _ _ J

PTHP (BEYOND)

LAND USE SUBMISSION ISSUE

Drawing:

EXTERIOR ELEVATIONS

Sheet No: Building A -

03.11.2022



BUILDING FACING COURTYARD 1

MATERIALS



VERTICAL WOOD SIDING PRODUCT: TBD FINISH: TBD

THESE DRAWINGS ARE THE ORIGINAL UNPUBLISHED WORK OF THE ARCHITECT AND MAY NOT BE DUPLICATED OR USED WITHOUT THE WRITTEN CONSENT OF THE ARCHITECT.




SHINGLE SIDING PRODUCT: SHINGLE SIDING, STRAIGHT EDGE PANEL FINISH: TBD, LIGHT



ASPHALT SHINGLE ROOF PRODUCT: TBD FINISH: TBD, DARK



FLAT METAL PANEL PRODUCT: TBD FINISH: TBD, DARK

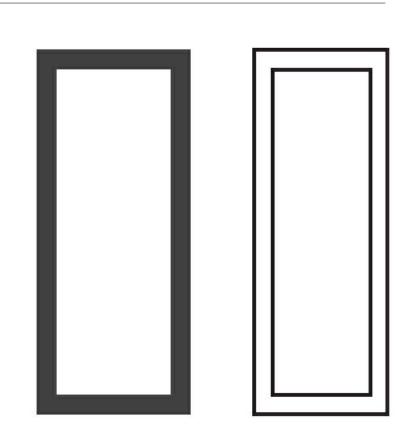

VINYL WINDOWS PRODUCT: VPI ENDURANCE FINISH: TBD, LIGHT & DARK

* SITE AND LANDSCAPING SHOWN FOR REFERENCE ONLY. SEE CIVIL AND LANDSCAPE DRAWINGS FOR FULL DESIGN.



PATH FROM PARKING TO COURTYARD



BUILDING PATIOS



BUILDINGS ALONG SALAL ST.

LAND USE SUBMISSION ISSUE

RENDERINGS

2525 E Burnside Street, Portland, OR 97214 phone: (503) 226-3617 www.seallp.com

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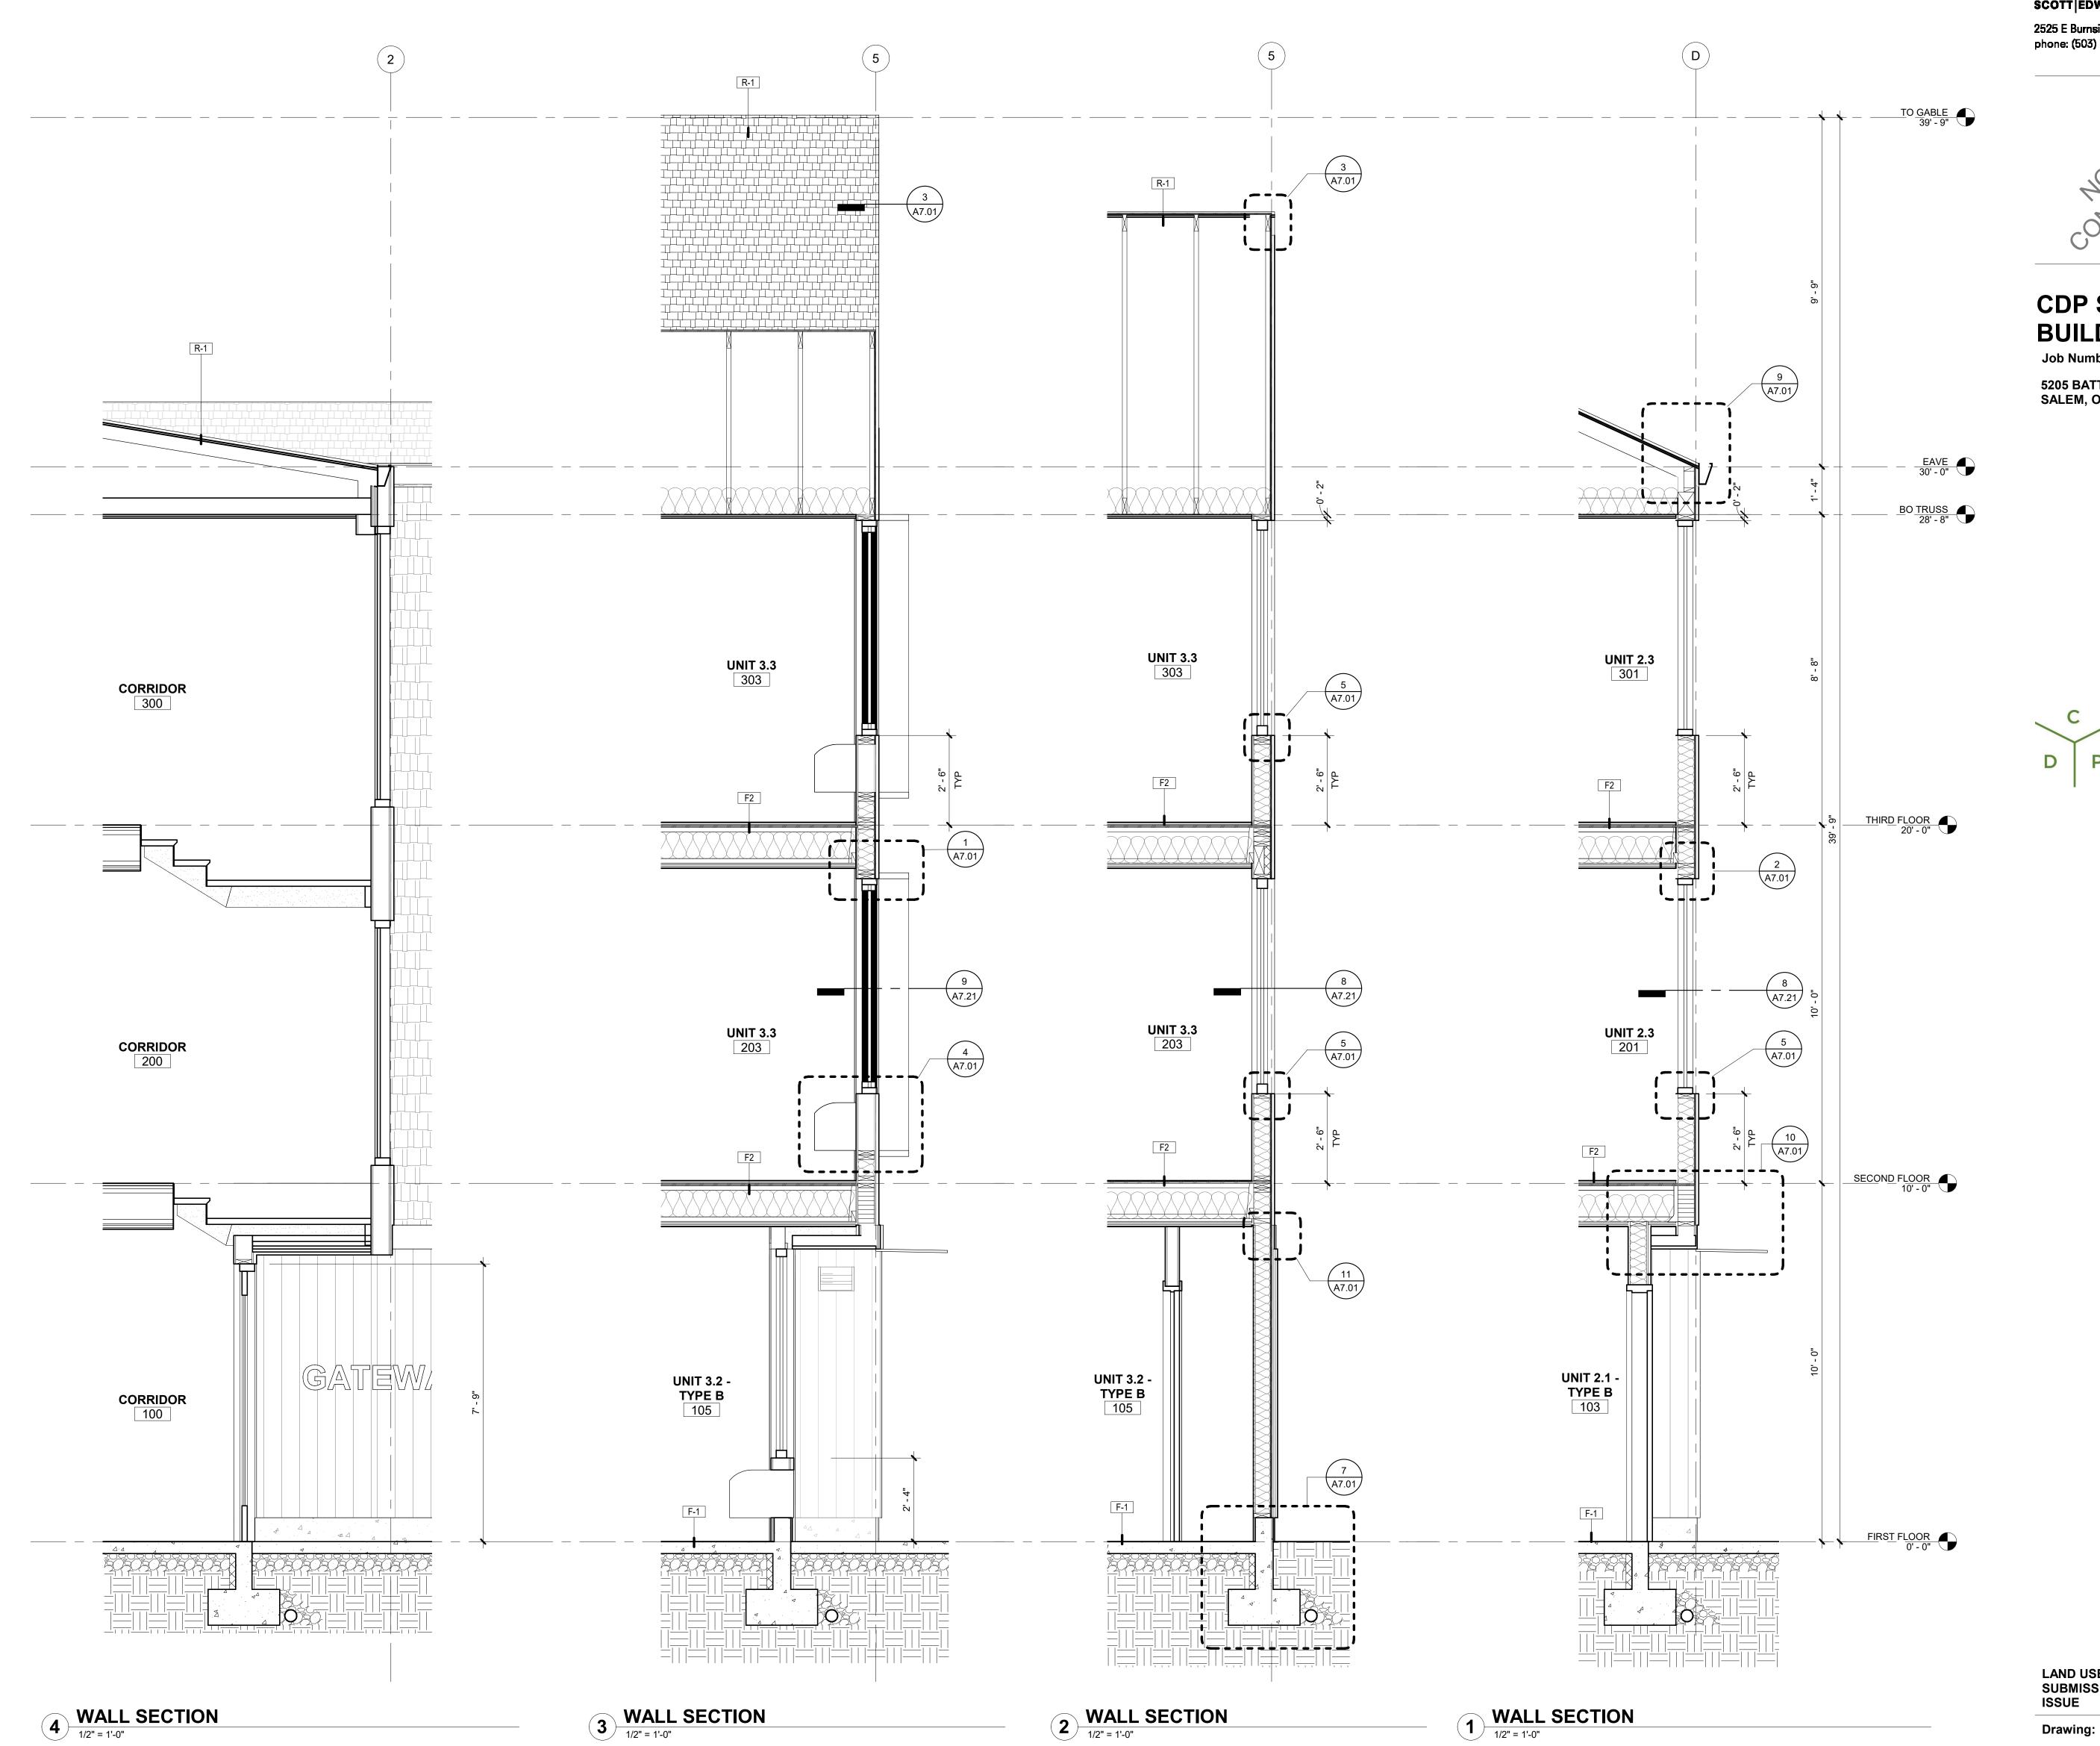
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BUILDING A

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Job Number:

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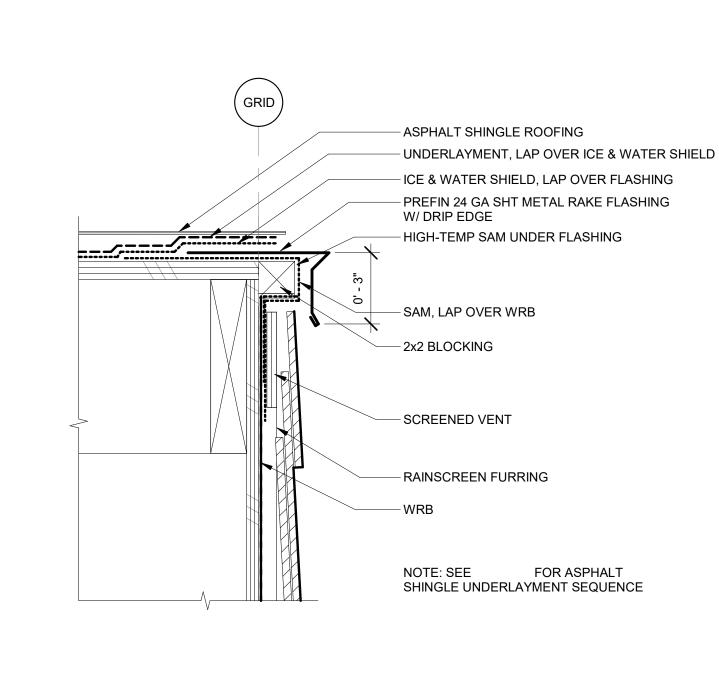
D P Development
Partners

LAND USE SUBMISSION

DATE


03.11.2022


WALL SECTIONS



8 CURB AT METAL WALL PANEL
3" = 1'-0"


3 TYPICAL RAKE

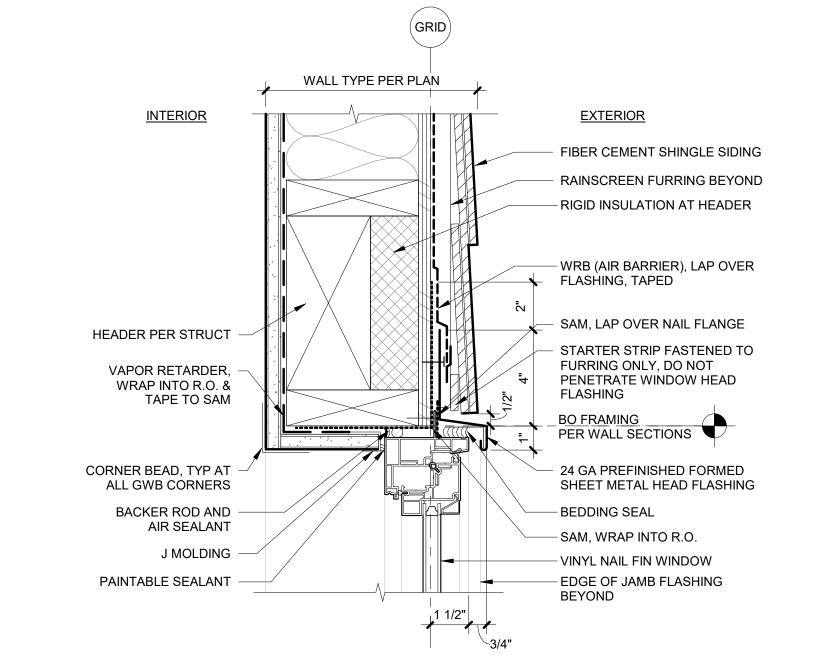

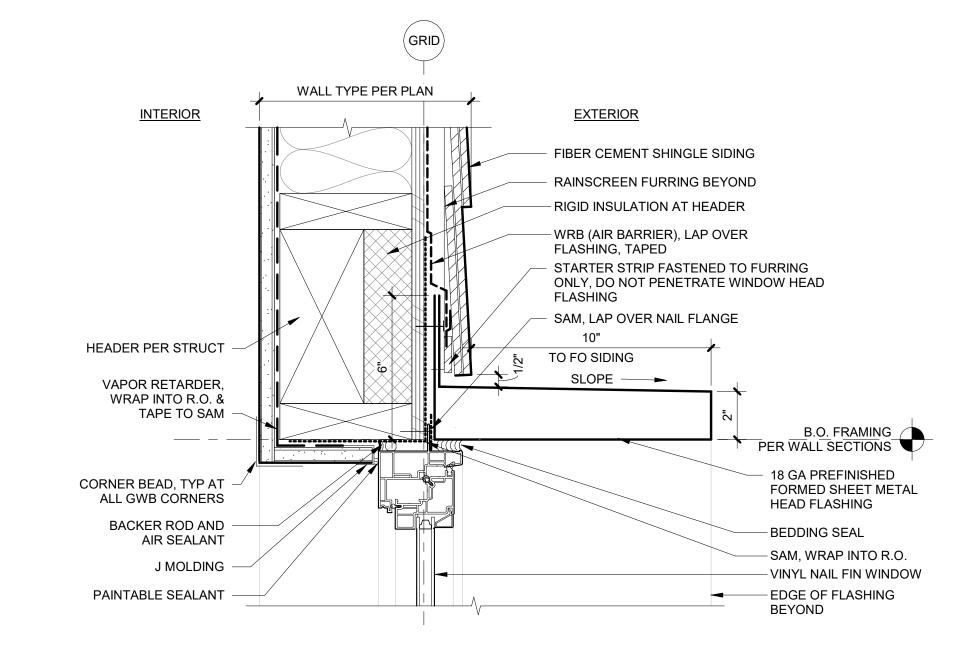

WINDOW HEAD @ FIBER-CEMENT SIDING W/ TRIM


SURROUND

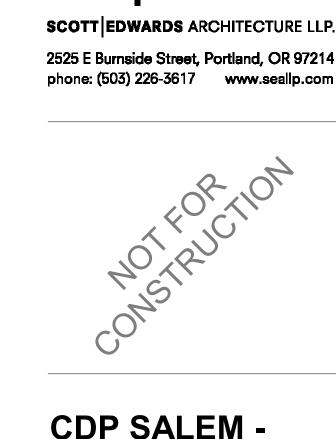






5205 BATTLE CREEK RD SE

SALEM, OR 97306

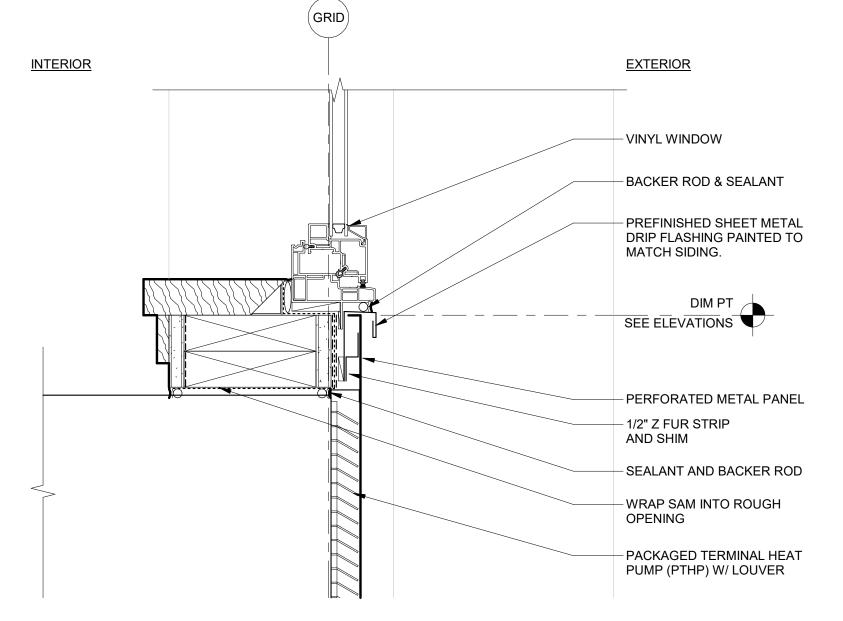

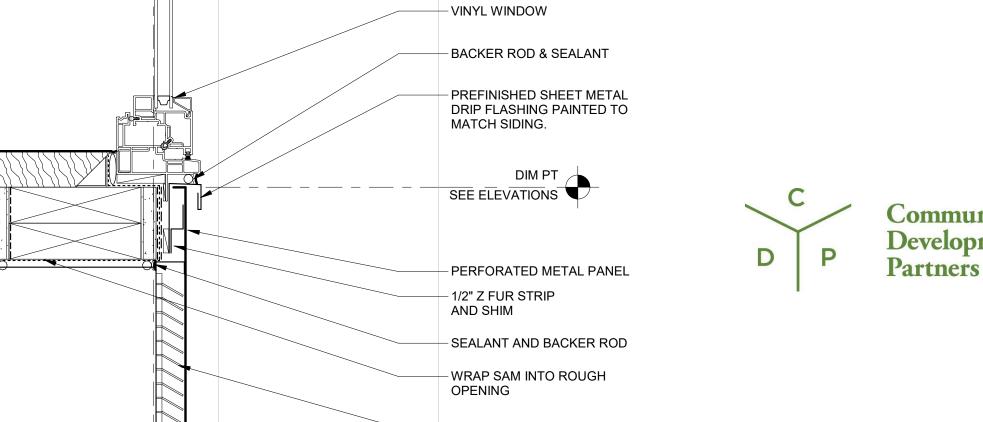

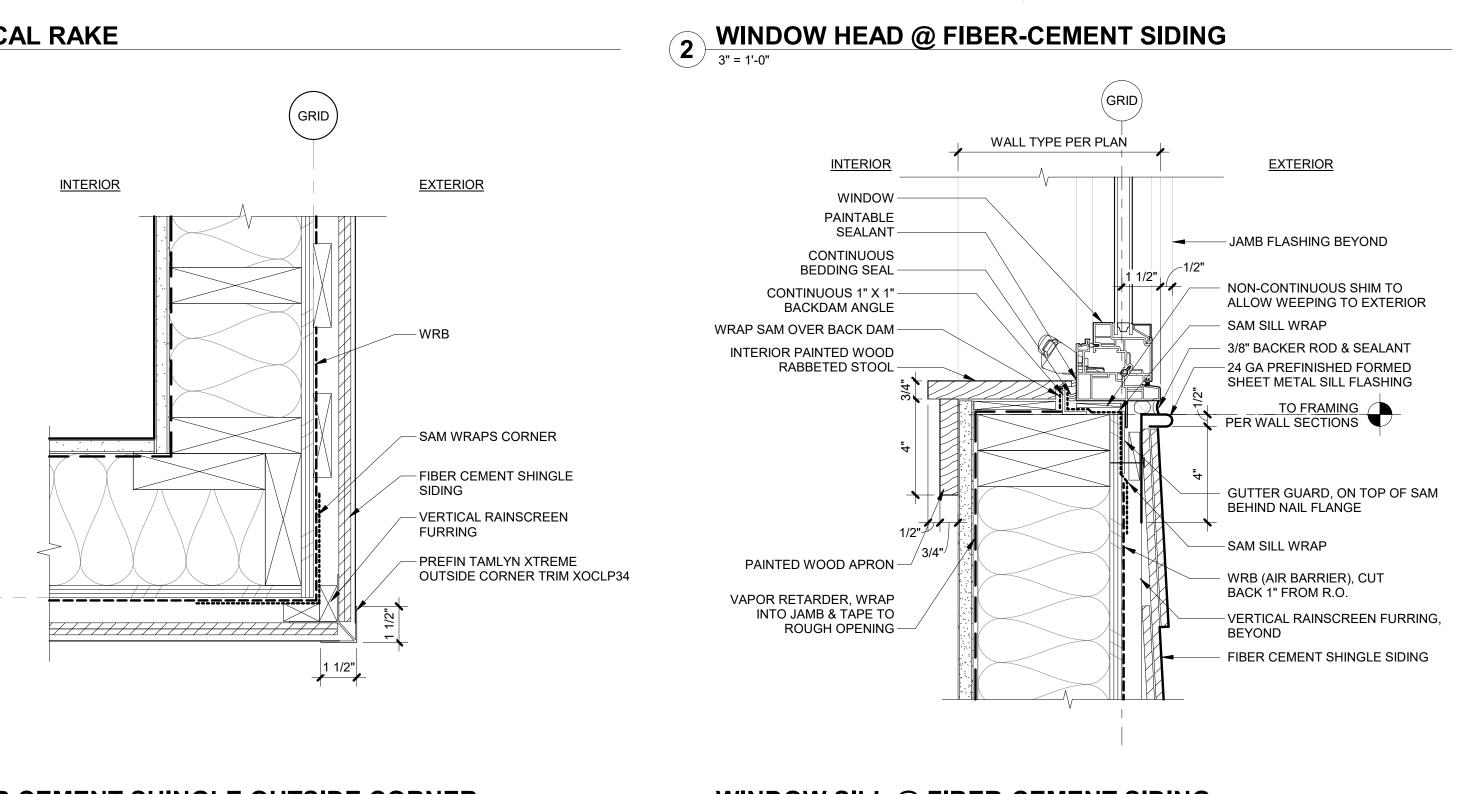

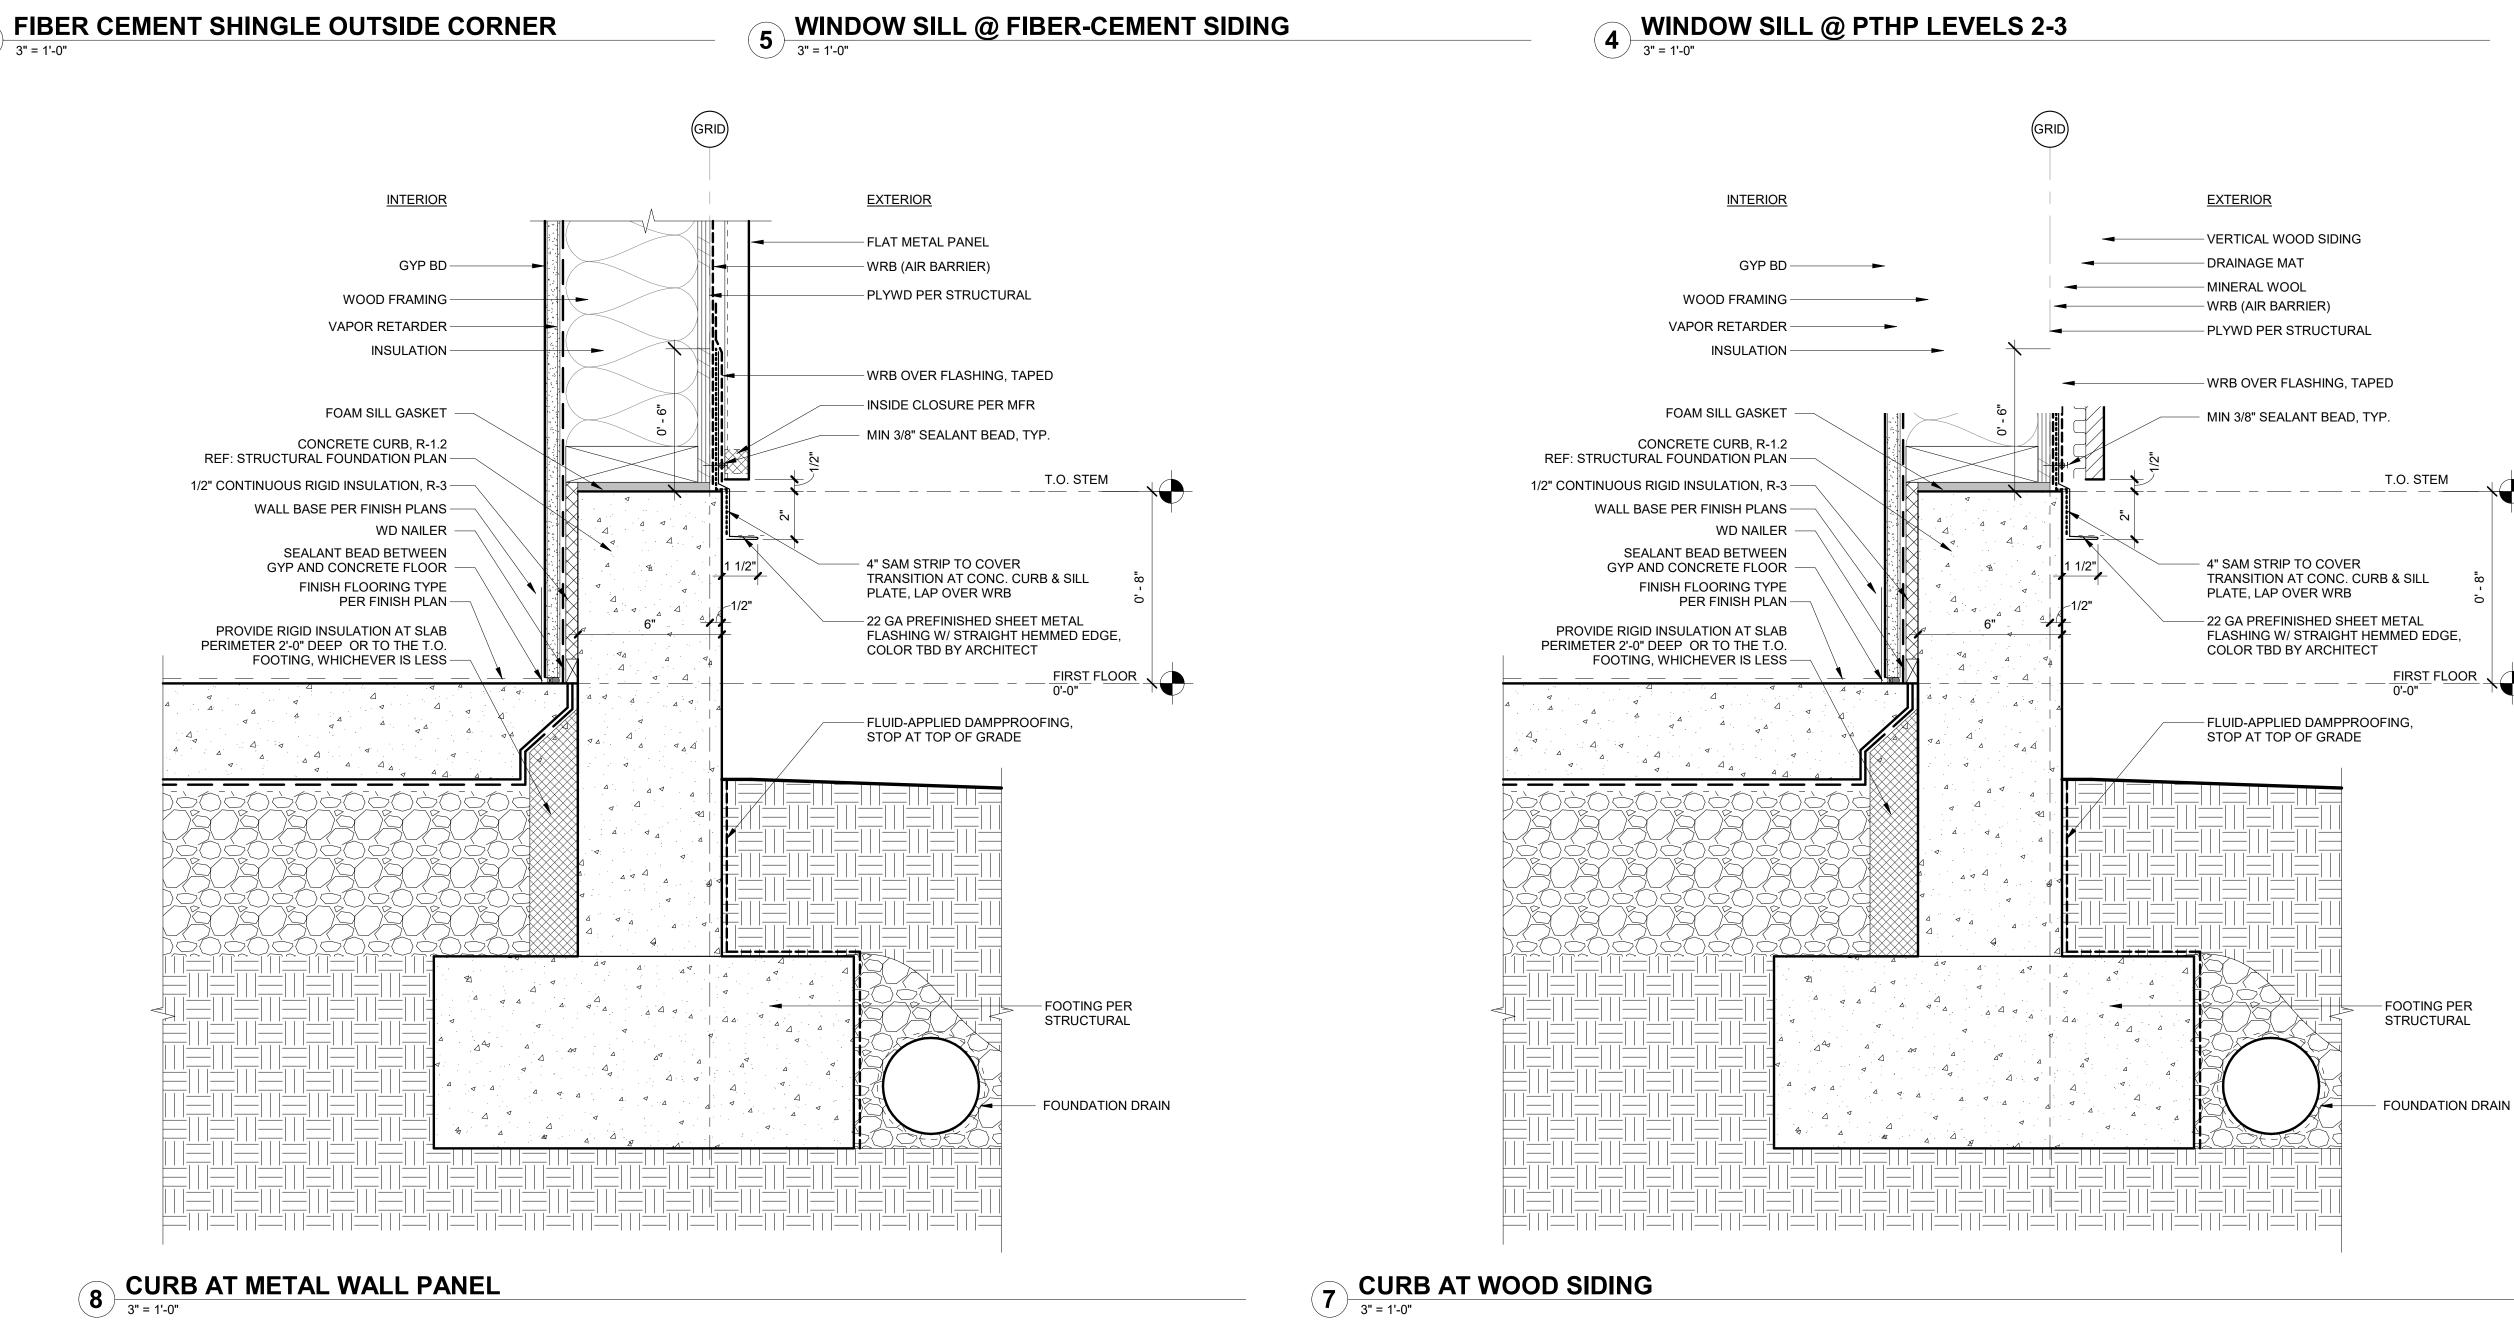

LAND USE **SUBMISSION** ISSUE Drawing:

EXTERIOR DETAILS

03.11.2022

DATE

Sheet No: