LAND USE SUBMISSION

01.11.2021



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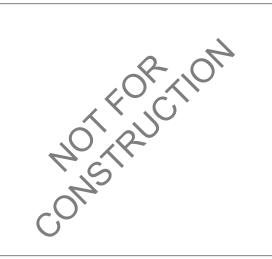
5205 BATTLE CREEK RD SE SALEM, OR 97306



GENERAL PROJECT NOTES	PROJECT TEAM	PROJECT SUMMARY	SHEET INDEX
BELER ID OWNER CONTINUED ON ADECUMENT TORS ON SOURCE CONTINUES. BELER ID OWNER CONTINUED ON ADECUMENT TO THE FALL SCI OF CONTRACT TO MANY SING OWNERS. I. CONTINUED ON INCLUDING UIT ON LIBRIDGE OF THE FALL SCI OF CONTINUED AND DODOLOMENT, INCLUDING UIT ON LIBRIDGE OF CONTINUED AND ADMINISTRATION	OWNER CONTRACTOR CONTRACTOR LIA DOMESTICATION CONTRACTOR LIA DOMESTICATION CONTRACTOR LIA DOMESTICATION LIA DOMESTICATION CONTRACTOR AROUTET CONTRACTOR AROUTET CONTRACTOR C	PROJECT DESCRIPTION AS DOT PROJECT DESCRIPTION AS DOT PROJECT SERVER BELLEVIEW BUILDING PROJECT DESCRIPTION GROSS AREA 42 (S.S.F.) PROJECT ADDRESS: GROSS AREA 42 (S.S.F.) GROSS AREA 42 (S.S.F.) LEGAL DESCRIPTION. CONTRACTOR BUILDING BUILD	SHEET INDEX SHEET # SHEET NAME GENERAL GOOT GENERAL PROJECT INFORMATION ODDE SUMMARY ARCHITECTURAL ADOLD ASSEMBLE SAME ASSEMBLE SAME SECOND FLOOR PLAN A2.12 FIRST FLOOR PLAN A2.13 THIRO FLOOR PLAN A2.16 FOURTH FLOOR PLAN A3.02 EXTERIOR ELEVATIONS A3.02 EXTERIOR DETAILS A7.02 EXTERIOR DETAILS A7.02 EXTERIOR DETAILS



2525 E Burnside Street, Portland, OR 97214 phone: (503) 226-3617 www.seallp.com



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21031

Job Number:

5205 BATTLE CREEK RD SE SALEM, OR 97306

SALEINI, OR 97306

C Community
Developmen
Partners

LAND USE SUBMISSION ISSUE

Drawing:

GENERAL PROJECT INFORMATION

01.11.2021

DATE

hoot No.

G0 01

BUILDING CODE	SUMMARY 20	19 OREGON STRUCTURAL SPECIALTY COL	DE	CHAPTER 10: MEANS OF E	GRESS			
OCCUPANCY	R-2 WITH ACCESSORY B OCC	UPANCY		SECTION 1004	OCCUPANT LOAD (OL)	SEE OCCUPANT LOAD TABLE	=	
CONSTRUCTION TYPE	V-A, SPRINKLERED NFPA 13				STAIRWAY EGRESS CAPACITY FACTOR	0.3		
CHAPTER 4: SPECIAL D	ETAILED REQUIREMENTS	BASED ON OCCUPANCY AND USE			OTHER EGRESS CAPACITY FACTOR	0.2		
OSSC REFERENCE					MAX OCCUPANT LOAD FOR ONE EXIT	20 OCCUPANTS		
SECTION 420.2	SEPARATION WALLS	WALLS SEPARATING DWELLING OR SLEEPING UNITS			MAX COMMON PATH OF EGRESS TRAVEL	. 125 FT		
		OR OTHER OCCUPANCIES SHALL BE CONSTRUCTED AS FIRE PARTITIONS IN ACCORDANCE WITH SECTION 708.		TABLE 1006.3.2	MAX OCCUPANT LOAD PER STORY	500		
SECTION 420.3 HORIZONTAL SEPA	HORIZONTAL SEPARATION	FLOOR ASSEMBLIES SEPARATING DWELLING OR SI EACH OTHER OR OTHER OCCUPANCIES SHALL BE O	CONSTRUCTED AS		MIN NUMBER OF EXITS FOR STORY	2		
050710114004	ODDINU(LED OVOTEM	HORIZONTAL ASSEMBLIES IN ACCORDANCE WITH S	ECTION 711.	TABLE 1006.3.3(1)	STORIES WITH ONE EXIT FOR R-2	4 UNITS / 125 FT TRAVEL DIS	TANCE / UP TO 3 STORIES	
SECTION 420.4 SECTION 420.5	SPRINKLER SYSTEM FIRE & SMOKE ALARMS	GROUP R OCCUPANCIES, REQUIRED PER 903.2.8 GROUP R-2, FIRE ALARM SYSTEMS REQUIRED PER 903.2.8	SECTION 007.2.0	TABLE 1017.2	EXIT ACCESS TRAVEL DISTANCE	B: 200 FT; R-2: 250 FT		
SECTION 420.5	FIRE & SWICKE ALARWIS	SMOKE ALARMS REQUIRED PER 907.2.10.2	SECTION 907.2.9	TABLE 1020.1	CORRIDOR FIRE-RESISTANCE RATING	B: 0; R-2: 1/2 HR		
				TABLE 1020.2	MINIMUM CORRIDOR WIDTH		HIN DWELLING UNIT OR WHERE	
CHAPTER 5: GENERAL	BUILDING HEIGHTS AND A	AREAS		SECTION 1020.4	DEAD ENDS	OCCUPANT LOAD <50 EXCEPTION 2, R-2 SPRINKLE	RED PER NEPA 13, 50 FEET	
TABLE 504.3 TABLE 504.4	HEIGHT / STORIES / AREA FAC	CTOR R-2: 70 FT / 4 STORY / 12000 SF		02011011 1020.4	DENO ENDO	*LENGTH IS NOT LIMITED WH	•	
TABLE 504.4 TABLE 506.2								
MODIFICATIONS				CHAPTER 11: ACCESSIBIL	TY			
SECTION 506.2.3	BUILDING AREA	Aa = [At + (NS x lf)] x Sa		SECTION 1106.2	R-2 OCCUPANCIES WITH ACCESSIBLE, TY	PE A OR TYPE B UNITS, AT LEAST	2% OF EACH TYPE OF PARKING	
SINGLE-OCCUPANCY MULTIS EQUATION 5-2		= [12000 SF + (12000 SF x 0.75)] x 3 = 21000 SF x 3			PROVIDED SHALL BE ACCESSIBLE			
		= 63000 SF			TOTAL SPACES PROVIDED:	163		
SECTION 506.3	FRONTAGE INCREASE	If = [F/P - 0.25] x W/30			ACCESSIBLE SPACES REQUIRED ACCESSIBLE SPACES PROVIDED			
		If = [283/283 - 0.25] x 30/30 = 0.75			VAN ACCESSIBLE SPACES REQUIVAN ACCESSIBLE SPACES PROV		E SPACES	
					WHEELCHAIR ONLY SPACES RE	QUIRED: 1 PER 101-200 SPAC	CES	
	ACTUAL HEIGHT / STORIES	45' - 0" / 4 Story			WHEELCHAIR ONLY SPACES PR			
	FLOOR LEVEL	BUILDING AREA AREA (SF)			R-2 OCCUPANCIES WITH GREATER THAN R-2 UNITS ON A SITE SHALL BE CONSIDER			
	FIRST FLOOR	10859 SF			NUMBER OF TYPE A UNITS TYPE A UNITS REQUIRED (TOTAL)	L FOR SITE): 184 x 2% = 4 UNITS	8	
	SECOND FLOOR THIRD FLOOR	10093 SF 11187 SF			TYPE A UNITS PROVIDED (TOTAL	L FOR SITE): 0 UNITS		
	FOURTH FLOOR	11187 SF 43326 SF			TYPE A UNITS PROVIDED (THIS E	BUILDING): 0 UNITS		
SECTION 508.2	ACCESSORY OCCUPANCY	В		SECTION 1107.6.2.2.2	WHERE THERE ARE FOUR OR MORE DWE	ELLING UNITS, ALL UNITS SHALL E	BE TYPE B UNITS AT A MINIMUM	
SECTION 508.3 / 508.4	MIXED OCCUPANCY	N/A						
TABLE 509	INCIDENTAL USES LAUNDRY ROOMS OVER 100	·						
	TRASH ROOMS OVER 100 SF	SPRINKLERED, NO SEPARATION REQUIRED		ADDITIONAL ACCESSIBILIT	Y REQUIREMENTS			
CHAPTER 6: TYPES OF	CONSTRUCTION / CONST	RUCTION CLASSIFICATION		APPLICABLE STANDARDS				
TABLE 601	EIDE DESISTANCE DATING DE	EQUIRMENTS FOR BUILDING ELEMENTS		ANSI ICC A		T. C. II		
TABLE 001				SECTION 5		ILE II		
	PRIMARY STRUCTURAL FRA	JILDING ELEMENT FIRE RATING ME 1 HOUR) *		ING ACCESSIBILITY GUIDELINES :AFE HARBOR DESIGN DOCUMENT: IBC 20	018		
	BEARING WALLS EXTERIOR	1 HOUR		OHCS COR	OHCS CORE DEVELOPMENT MANUAL			
	INTERIOR NON BEARING WALLS AND I	1 HOUR PARTITIONS - EXTERIOR PER TABLE 6	.03	ACCESSIBLE UNITS	COMUTE MODILITY FEATURES	404 50/ 01/04/07		
	NON BEARING WALLS AND	PARTITIONS - INTERIOR 0 HOUR	02		S WITH MOBILITY FEATURES S WITH COMMUNICATION FEATURES	184 x 5% = 0 UNITS 184 x 2% = 0 UNITS		
		D SECONDARY MEMBERS 1 HOUR SECONDARY MEMBERS 1 HOUR		CHAPTER 13: ENERGY EFFICIENCY 2021 OREGON ENERGY EFFICIENCY SPECIALTY CODE (OEESC)				
	* UNLESS OTHERWISE REQ	UIRED BY THIS CODE		CHAPTER 13. ENERGY EFF	ICIENCY 2021 OREGON ENER	GT EFFICIENCT SPECIAL	IT CODE (OEESC)	
TABLE 602	FIRE RESISTANCE RATING RE	EQUIRMENTS FOR EXTERIOR WALLS BASED ON FIRE SE	PARATION DISTANCE	OPAQUE ELEMENTS	REQUIF	DEN	PROVIDED	
17.022 002		EPARATION DISTANCE FIRE RATING			ASSEMBLY MAX.	MIN. R-VALUE	PROVIDED	
	X < 5'	1 HOUR	<u> </u>	ROOFS INSULATION ENTIRELY ABOVE	N/A	N/A		
	5' <= X < 10' 10' <= X < 30'	1 HOUR 1 HOUR		DECK METAL BUILDINGS	N/A	N/A		
	X >= 30'	0 HOUR		ATTIC AND OTHER	U-0.021	R-49	R-49	
				WALLS (ABOVE GRADE) MASS	U-0.090	R-11.4 CI		
CHAPTER 7: FIRE AND	SMOKE PROTECTION FEA	TURES		METAL BUILDINGS STEEL-FRAMED	N/A N/A	N/A N/A		
TABLE 705.2	MINIMUM DISTANCE OF PROJ	ECTION 40 INCHES		WOOD-FRAMED / OTHER WALLS (BELOW GRADE)	U-0.064 C-0.092	R-13 + 3.8 CI OR R-20 R-10 CI	R-23	
TABLE 705.8		ENINGS BASED ON FSD AND OPENING PROTECTION		FLOORS MASS		N/A		
IADLE 100.0		UNPROTECTED, SPRINKLERED (NFPA 13)	PROTECTED	STEEL JOIST	N/A N/A	N/A		
	0 TO LESS THAN 3' 3 TO LESS THAN 5'	NOT PERMITTED 15%	NOT PERMITTED 15%	WOOD FRAMED / OTHER SLAB-ON-GRADE FLOORS	U-0.033	R-30	R-30	
	5 TO LESS THAN 10'	25%	25%	HEATED UNHEATED	N/A F-0.520	N/A R-15 FOR 24"	R-15 FOR 24"	
	10 TO LESS THAN 15' 15 TO LESS THAN 20'	45% 75%	45% 75%	OPAQUE DOORS		K-13 FUK 24"		
	20 TO LESS THAN 25' 25 TO LESS THAN 30'	NO LIMIT NO LIMIT	NO LIMIT NO LIMIT	SWINGING NON-SWINGING	U-0.370 N/A		U-0.370	
	30' OR GREATER	NO LIMIT	NO LIMIT	FENESTRATION	REQUIRED	I	PROVIDED	
	DADADETS	PARAPETS EXCEPTION 1: WALL NOT REQUIRED TO BE FIRE-RESISTANCE RATED IN		LAZOTATION	MAX U MAX SHGC	MIN VTI/SHGC MAX U	MAX SHGC MIN VTI/SHG	
705.11	FANAFEIS		NCE RATED IN	\/EDTIOAL /00/ 400/ 0=1/111	l l		•	
705.11	PANAPLIS			VERTICAL (0% - 40% OF WALL ALI FIXED OPERABLE	l l	1.10		

ENTRANCE DOOR

FC = FILLED CAVITY


NR = NO REQUIREMENT NA = NOT APPLICABLE

CI = CONTINUOUS INSULATION

SKYLIGHT (0% - 3% OF ROOF ALLOWED)

CHAPTER 29: PLUMBING FIXTURES

1 WC / LAV / Tub or Shower per unit required and provided

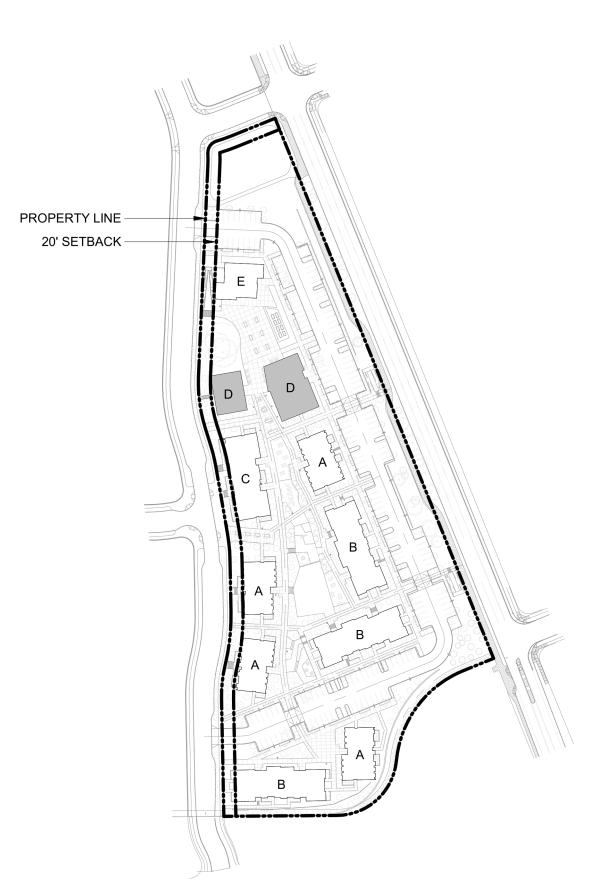


SITE PLAN - ZONING DIAGRAM



702.020 MULTIPLE FAMILY DESIGN REVIEW STANDARDS

SECTION	REQUIRMENT MET OR ADJUSTMENT REQUESTED	SHEET NUMBER	
SITE SAFETY & SEC	CURITY		
702.020.c.1	REQUIREMENT MET	A2.11-A2.14	
702.020.c.2	REQUIREMENT MET	A3.01-A3.02	
FACADE & BUILDIN	IG DESIGN		
702.020.e.1	REQUIREMENT MET	A2.11-A2.15	
702.020.e.7	REQUIREMENT MET	A2.15, A3.01-A3.02	
702.020.e.8	REQUIREMENT MET	A2.15	
702.020.e.9	REQUIREMENT MET	A2.13-A2.14	
702.020.e.10	REQUIREMENT MET	A3.01-A3.02	



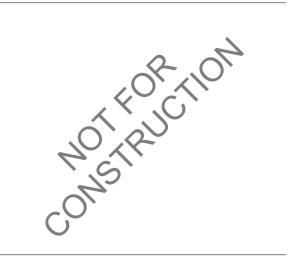

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Job Number: 2103

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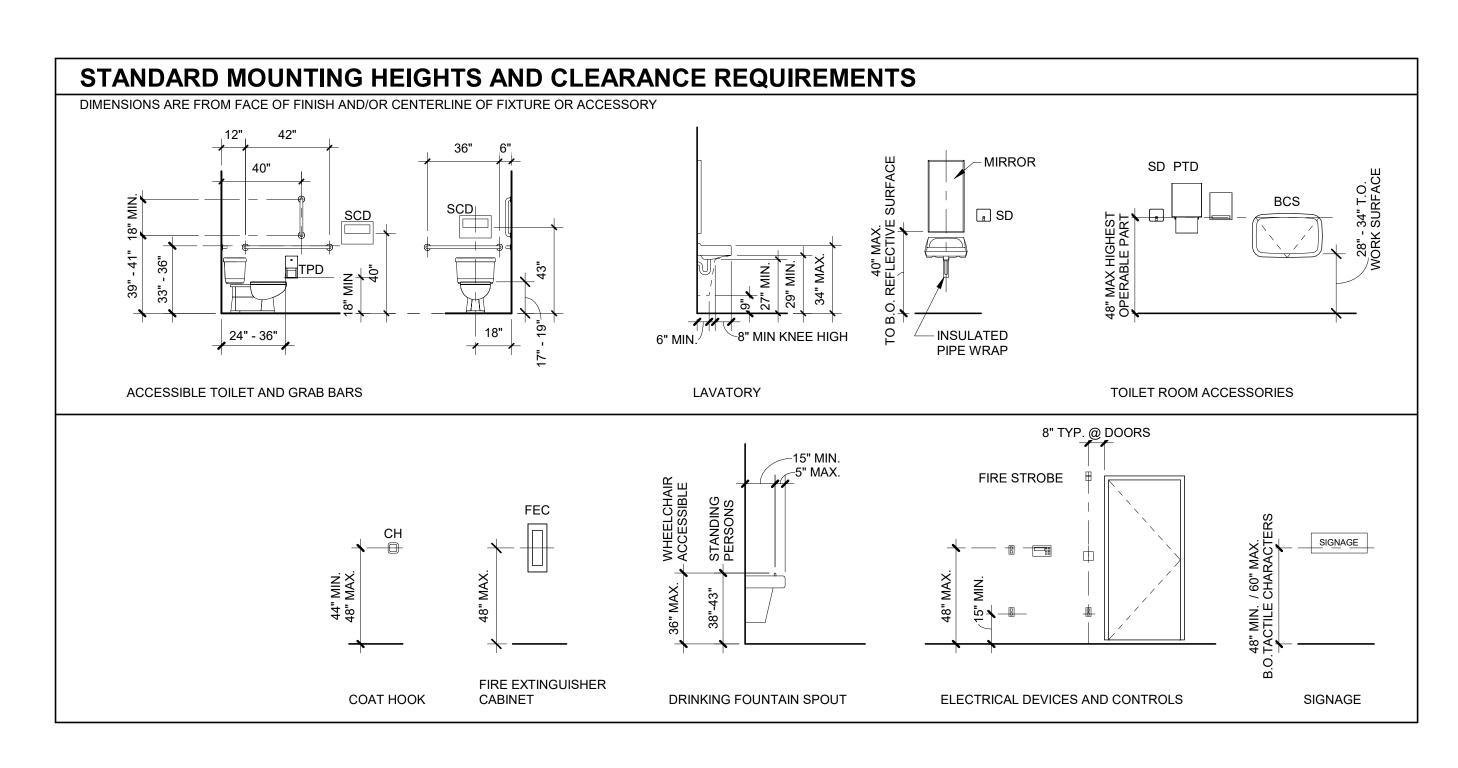
CODE SUMMARY


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Sheet No: Building D -

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CDP SALEM -**BUILDING D**

Job Number:

- DRAWING

NUMBER

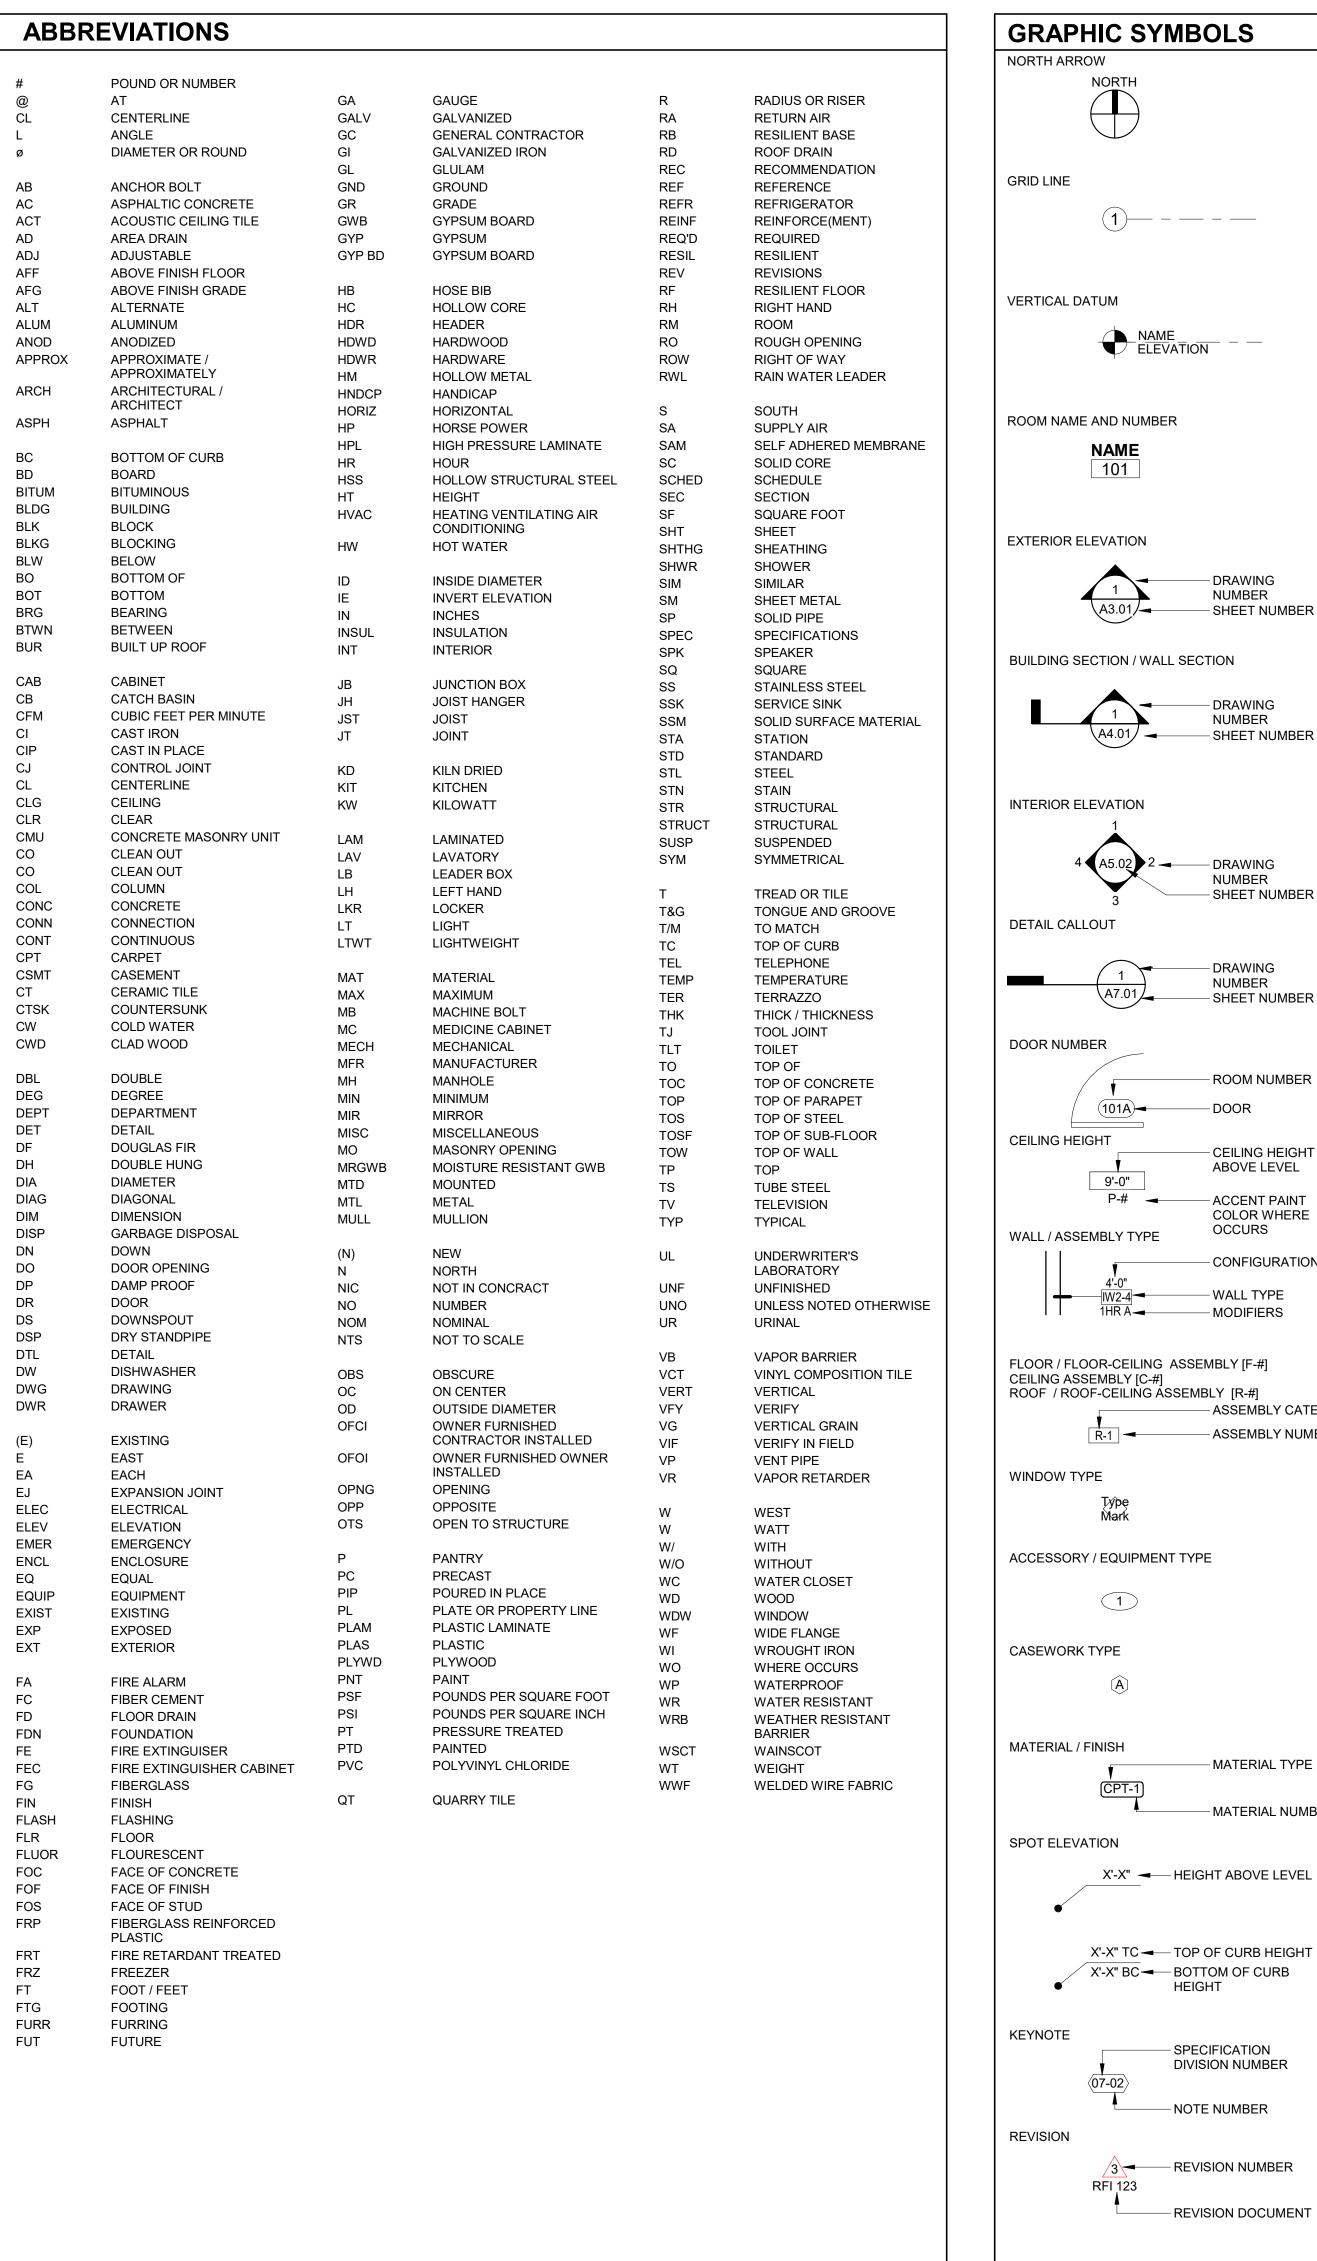— DRAWING

NUMBER

NUMBER

- DRAWING

NUMBER

- SHEET NUMBER

- ROOM NUMBER

- CEILING HEIGHT

ABOVE LEVEL

- ACCENT PAINT

OCCURS

— WALL TYPE

- MODIFIERS

COLOR WHERE

- CONFIGURATION

ASSEMBLY CATEGORY

— ASSEMBLY NUMBER

- MATERIAL TYPE

- MATERIAL NUMBER

– DOOR

— SHEET NUMBER

— SHEET NUMBER

- SHEET NUMBER

5205 BATTLE CREEK RD SE SALEM, OR 97306

Partners

DIMENSIONS

- UNIVERSAL HC SYMBOL

- BACKGROUND PAINTED BLUE

TO MATCH COLOR #15090 IN

PAINTED HIGHWAY

REFERENCE ONLY

WHITE (TWO COATS)

A. DIMENSIONS ARE INDICATED IN THE DOCUMENTS. THE DRAWINGS SHALL NOT BE SCALED FOR

DIMENSIONS. NOTIFY ARCHITECT IF ADDITIONAL DIMENSIONS ARE NECESSARY. B. IN MANY INSTANCES THE ACTUAL DIMENSIONS MAY BE LESS IMPORTANT THAN IF ELEMENTS ARE TO BE EQUALLY SPACED OR ALIGNED. IN THESE CASES, THE NOTATION "EQ" OR "ALIGN" IS USED IN LIEU OF A

C. DETAILS WILL GOVERN ALL DIMENSIONS NOT SHOWN ON PLANS. REFERENCE INDICATED DIMENSION

D. DIMENSIONS SHOWN ARE TO GRIDLINE, CENTERLINE OF COLUMN, OR FACE OF STUD / MASONRY,

UNLESS NOTED OTHERWISE. E. INTERIOR WALLS WHICH ARE EQUALLY SPACED ARE DIMENSIONED TO CENTERLINE OF WALL. F. DOORS NOT LOCATED BY DIMENSION SHALL BE CENTERED IN WALLS AS SHOWN ON PLANS OR

LOCATED 4 1/2" FROM FACE OF FINISH TO ROUGH OPENING.



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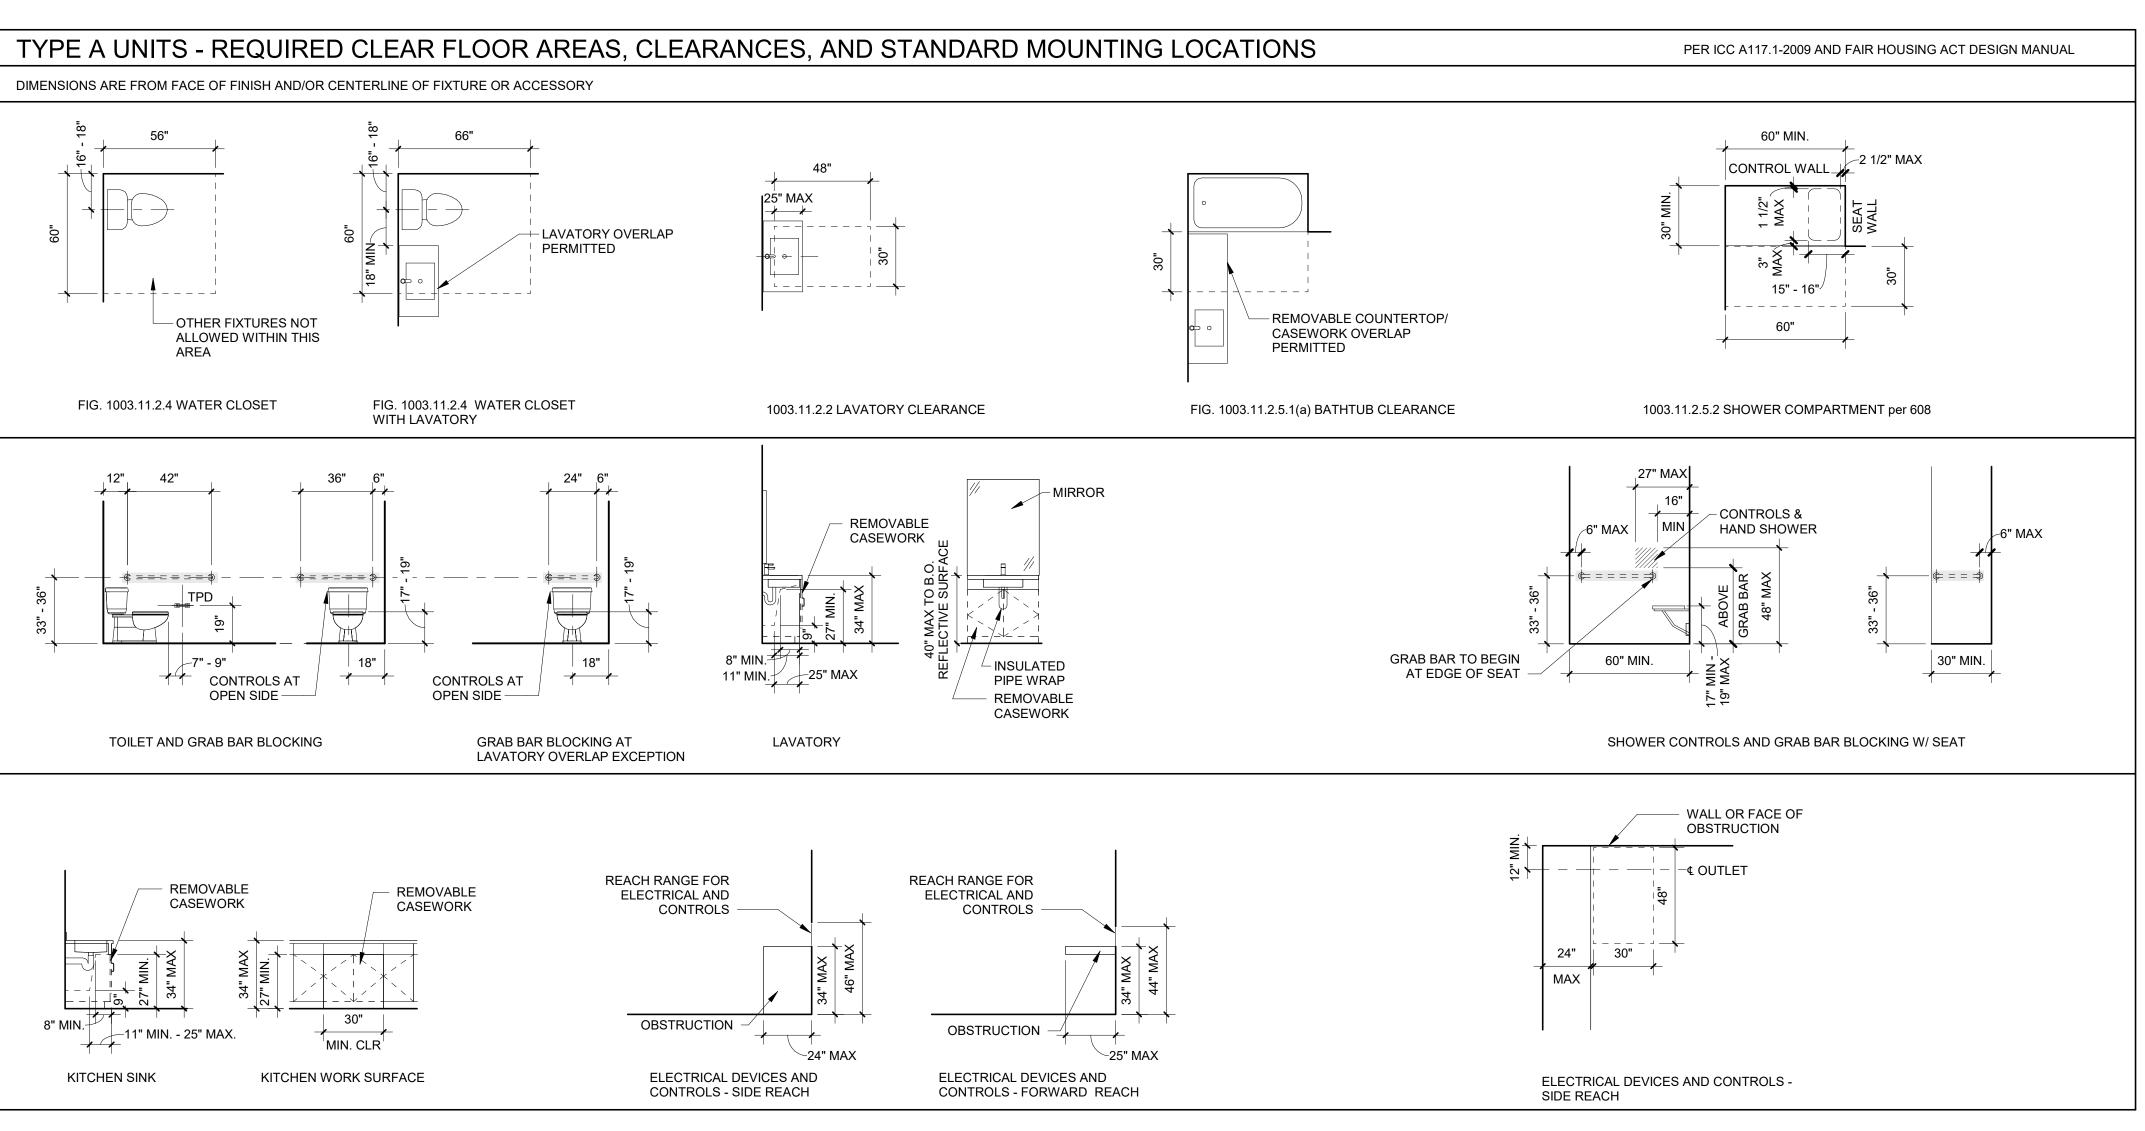
ISSUE Drawing:


ARCHITECTURAL GENERAL NOTES AND DIAGRAMS

01.11.2021

DATE

Sheet No:



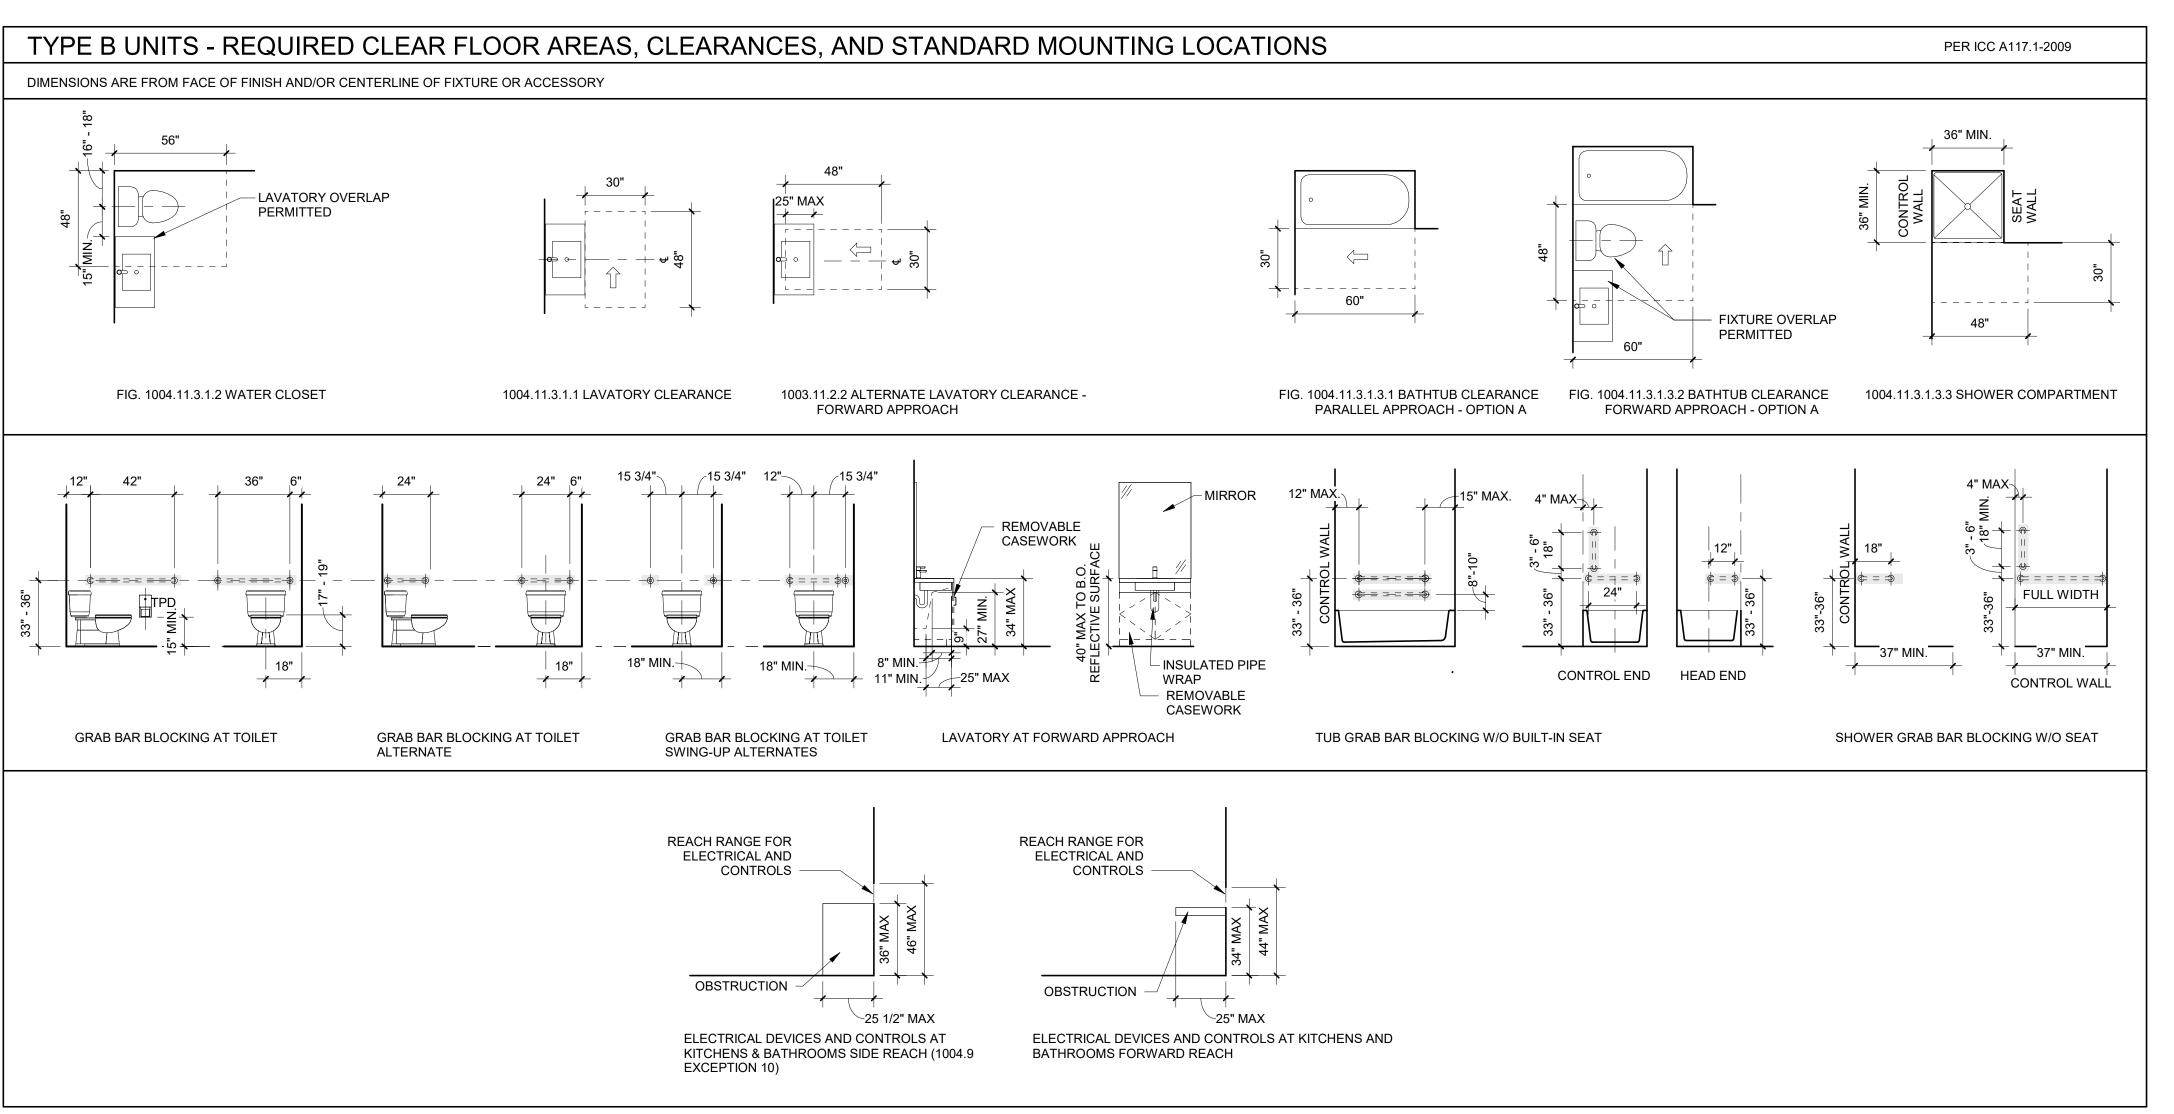





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SALEM, OR 97306



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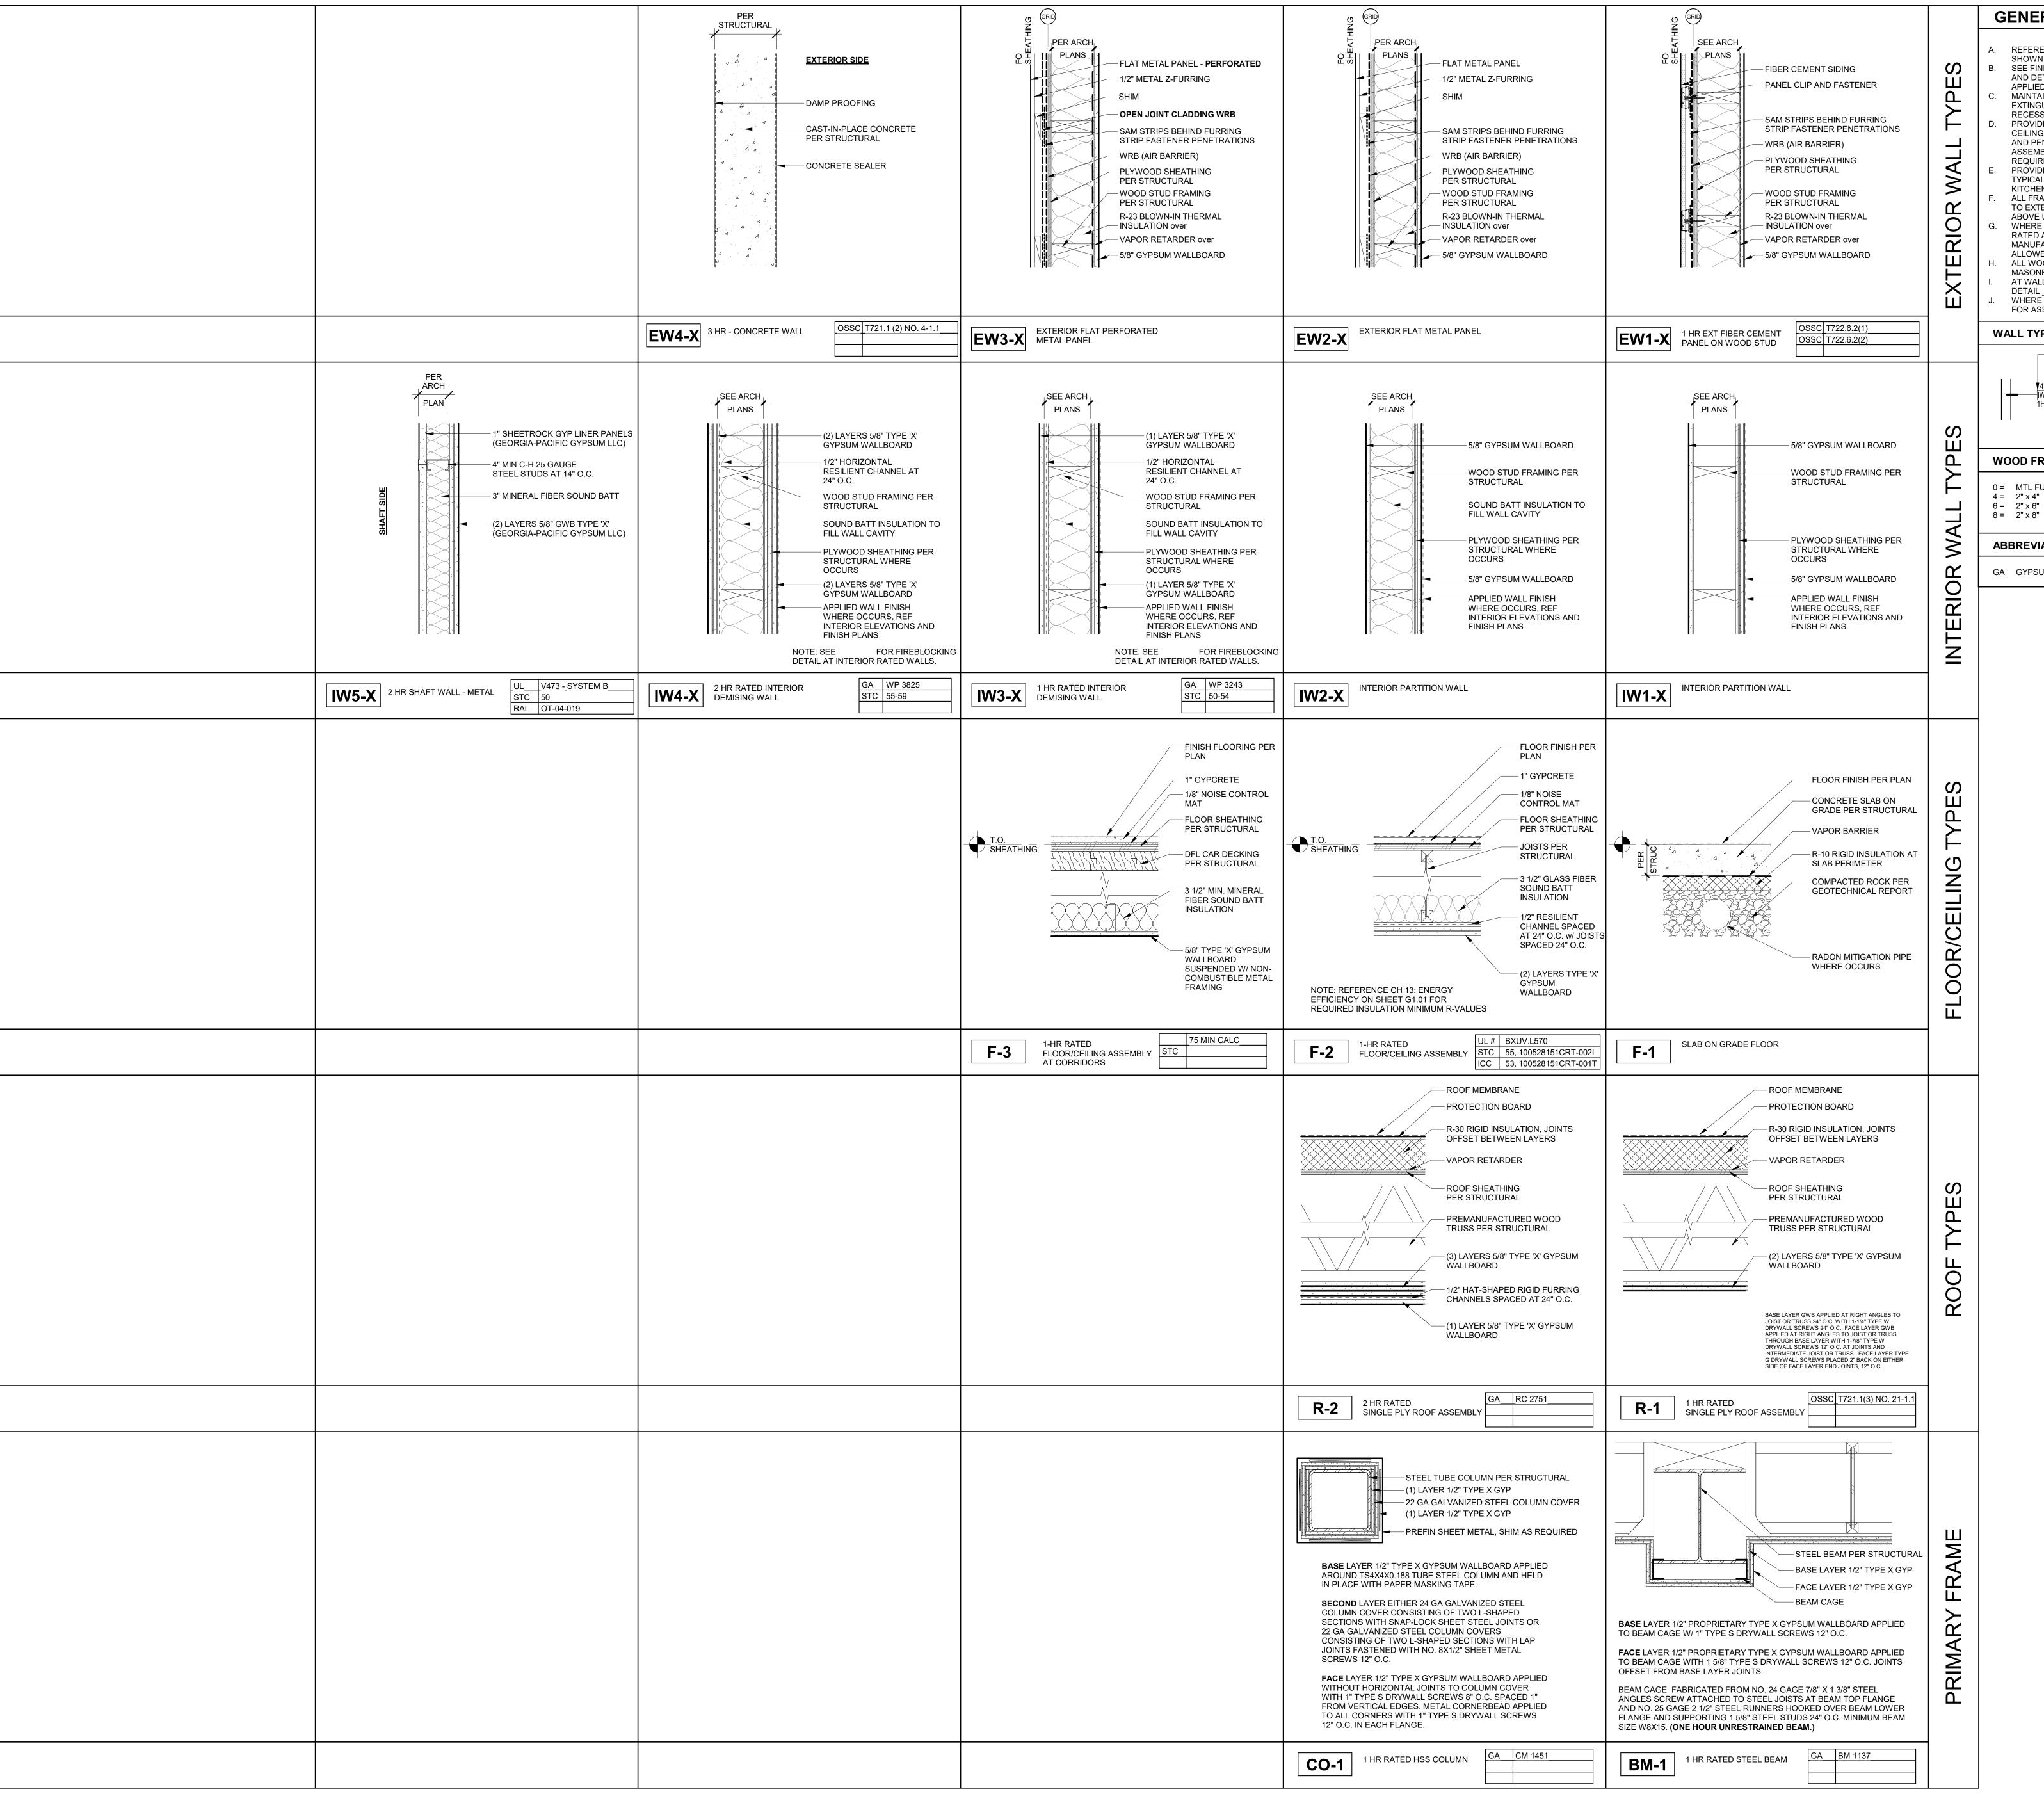
ACCESSIBILITY DIAGRAMS -**RESIDENTIAL**

01.11.2021

DATE

Sheet No: Building D -





GENERAL SHEET NOTES

REFERENCE DETAILS FOR ASSEMBLIES NOT SHOWN HERE. SEE FINISH SCHEDULE, INTERIOR ELEVATIONS, AND DETAILS FOR SPECIAL CONDITIONS AND

APPLIED WALL FINISHES. MAINTAIN FIRE RATING OF WALLS AROUND FIRE EXTINGUISHERS, CABINETS, AND OTHER RECESSED ITEMS.

PROVIDE ACOUSTICAL SEALANT AT FLOOR / CEILING/ WALL TRANSITIONS, RECESSED BOXES, AND PENETRATIONS OF SOUND RATED ASSEMBLIES AND OTHER CONSTRUCTION AS REQUIRED TO ACHIEVE NOTED STC RATINGS. PROVIDE MOISTURE RESISTANT GYPSUM BOARD

TYPICAL AT ALL RESTROOMS, BATHROOMS, AND KITCHEN WALLS. ALL FRAMING AND FINISHES OF INTERIOR WALLS TO EXTEND TO THE UNDERSIDE OF STRUCTURE ABOVE UNLESS NOTED OTHERWISE. WHERE PARTITIONS ARE SOUND RATED OR FIRE RATED AND INCLUDE PROPRIETARY MANUFACTURERS, NO SUBSTITUTIONS ARE

ALL WOOD IN CONTACT WITH CONCRETE OR MASONRY TO BE PRESSURE TREATED. AT WALLS WITH RESILIENT CHANNELS SEE DETAIL __ FOR ASSEMBLY DETAILS. WHERE ACOUSTIC WALL IS INDICATED, SEE _ FOR ASSEMBLY DETAILS.

WALL TYPE SYMBOL

- WALL TYPE - PARTIAL HEIGHT / WALL CONFIGURATION FRAMING OR CONC SIZE FIRE RATING (IN HOURS)

WOOD FRAMING SIZES 0 = MTL FURRING, 7/8" OR AS INDICATED 4 = 2" x 4"

ABBREVIATIONS

6 = 2" x 6"

GA GYPSUM ASSOCIATION

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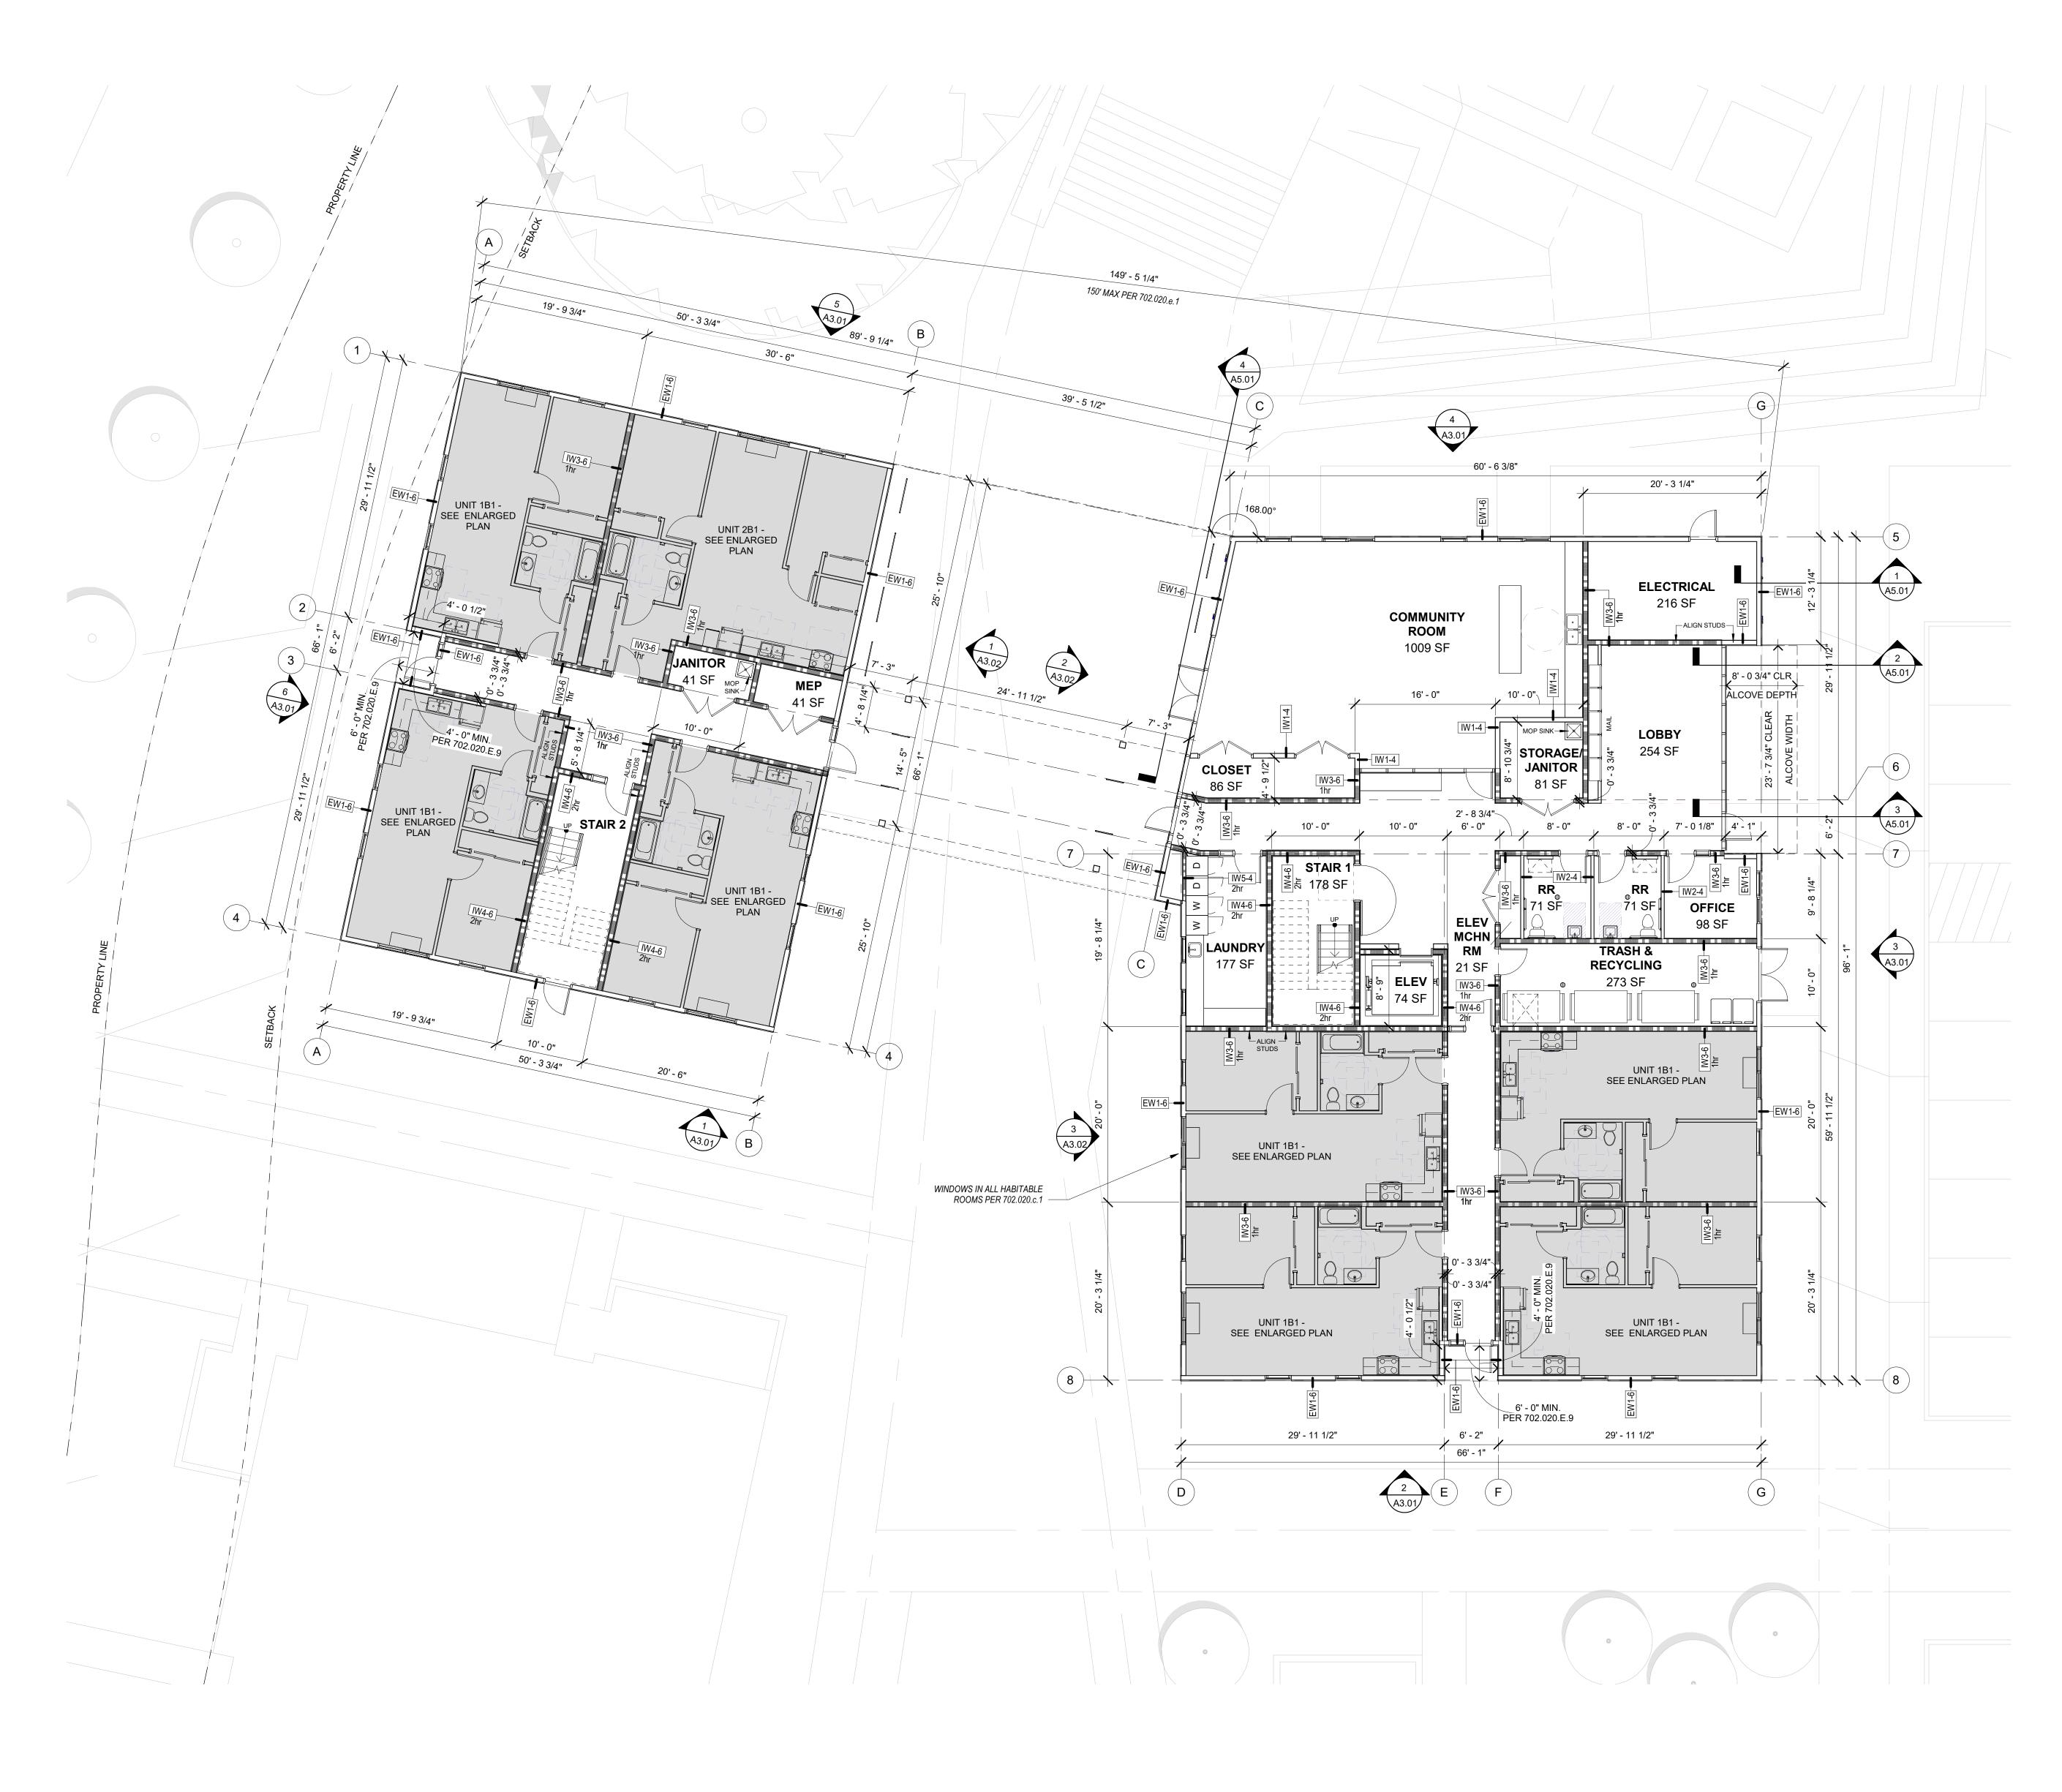
Drawing:

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DATE

ASSEMBLIES

Sheet No: Building D -



1 FIRST FLOOR PLAN
1/8" = 1'-0"

GENERAL SHEET NOTES

- WALL DIMENSIONS ARE FROM FACE OF STUD OR CL OF COLUMN U.N.O.
 ALL EXTERIOR GRID LINES SHOWN ARE TO FACE OF SHEATHING U.N.O. ALL INTERIOR GRID LINES
- ARE TO FACE OF STUD U.N.O.
- ARE TO FACE OF STUD U.N.O.

 ALL DOOR AND WINDOW DIMENSIONS ARE TO CL
 OR OVERALL UNIT. REFERENCE SCHEDULES AND
 DOOR AND WINDOW TYPES

 REFERENCE STRUCTURAL DRAWINGS FOR
 GENERAL CONTROL JOINTS @ SLAB.
 COORDINATE FINAL LOCATIONS WITH
 ARCHITECT COMPATIBILITY WITH FLOOR **FINISHES**
 - E. SEE DOOR SCHEDULE FOR DOOR TYPES AND INSTALLATION DETAILS CORRESPONDING TO DOOR NUMBERS
- F. SEE WINDOW SCHEDULE FOR WINDOW TYPES
 G. FOR FLOOR FINISHES, SEE FLOOR FINISH PLAN H. WIRE SHELVING IN ALL BEDROOM CLOSETS M.E.P. INFORMATION PROVIDED FOR REFERENCE ONLY. SEE M.E.P. DRAWINGS.
- J. PROVIDE BLOCKING FOR FUTURE GRAB BARS AT ALL UNIT RESTROOMS WHERE GRAB BARS ARE NOT SHOWN IN PLAN, REF ACCESSIBILITY DIAGRAMS FOR LOCATIONS

 K. FIRE EXTINGUISHER TO BE PLACED IN PANTRY IN
- ALL UNITS
- DOWNSPOUTS PAINTED IN FIELD, RECTANGLE SHAPE AND SIZE PER PLUMBING AND CIVIL M. WHERE WALLS, DOORS AND WINDOWS ARE NOT DIMENSIONED, ALIGN WITH THOSE ON THE FLOOR BELOW, TYP. SEE SECTIONS AND EXTERIOR ELEVATIONS.

LEGEND


1 HOUR RATED ASSEMBLY 2 HOUR RATED ASSEMBLY

- - - - - ELEMENT ABOVE

R-1 ASPHALT SHINGLE ROOF

KEYNOTES (07-02)

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Job Number:

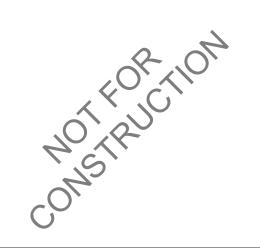5205 BATTLE CREEK RD SE **SALEM, OR 97306**



LAND USE

01.11.2021 DATE

Drawing: FIRST FLOOR PLAN



SEE ENLARGED PLAN

UNIT 1B1 -SEE ENLARGED PLAN

UNIT 2B1 -SEE ENLARGED // PLAN

UNIT 1B1 -SEE ENLARGED PLAN

GENERAL SHEET NOTES

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- M. WHERE WALLS, DOORS AND WINDOWS ARE NOT DIMENSIONED, ALIGN WITH THOSE ON THE FLOOR BELOW, TYP. SEE SECTIONS AND EXTERIOR ELEVATIONS.

LEGEND

149' - 5 1/4"

150' MAX PER 702.020.e.1

PEOPLE-WATCHING

WINDOWS IN ALL HABITABLE ROOMS PER 702.020.c.1 —

A3.02

20' - 0"

SEE ENLARGED

20' - 0"

UNIT 1B1 -SEE ENLARGED PLAN

UNIT 1B1 -SEE ENLARGED PLAN

29' - 11 1/2"

UNIT 1B1 -SEE ENLARGED PLAN

20' - 3 1/4"

UNIT 1B1 - EW1-6 PLAN

4' - 0" MIN. PER 702.020.E.9

SEE ENLARGED PLAN

UNIT 1B1 SEE ENLARGED PLAN

UNIT 1B1 -SEE ENLARGED PLAN

29' - 11 1/2"

1 HOUR RATED ASSEMBLY 2 HOUR RATED ASSEMBLY ---- ELEMENT ABOVE

R-1 ASPHALT SHINGLE ROOF

KEYNOTES (07-02)

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SECOND FLOOR **PLAN**

01.11.2021

THESE DRAWINGS ARE THE ORIGINAL UNPUBLISHED WORK OF THE ARCHITECT AND MAY NOT BE DUPLICATED OR USED WITHOUT THE WRITTEN CONSENT OF THE ARCHITECT.

UNIT 1B1 -

SEE ENLARGED

80' MAX PER 702.020.e.9

SEE ENLARGED

SEE ENLARGED PLAN

149' - 5 1/4"

150' MAX PER 702.020.e.1

60' - 6 3/8"

SEE ENLARGED

≥ = 20' - 9 1/4"

UNIT 2B1 SEE ENLARGED PLAN

UNIT 1B1 SEE ENLARGED

29' - 11 1/2"

UNIT 1B1 - EW1-6

- ALCOVE 4' DEEP MIN. AND 6'

WIDE MIN. PER 702.020.e.9

29' - 11 1/2"

1 THIRD FLOOR PLAN
1/8" = 1'-0"

GENERAL SHEET NOTES

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LEGEND


1 HOUR RATED ASSEMBLY 2 HOUR RATED ASSEMBLY ---- ELEMENT ABOVE

EXTERIOR ELEVATIONS.

R-1 ASPHALT SHINGLE ROOF

KEYNOTES (07-02)

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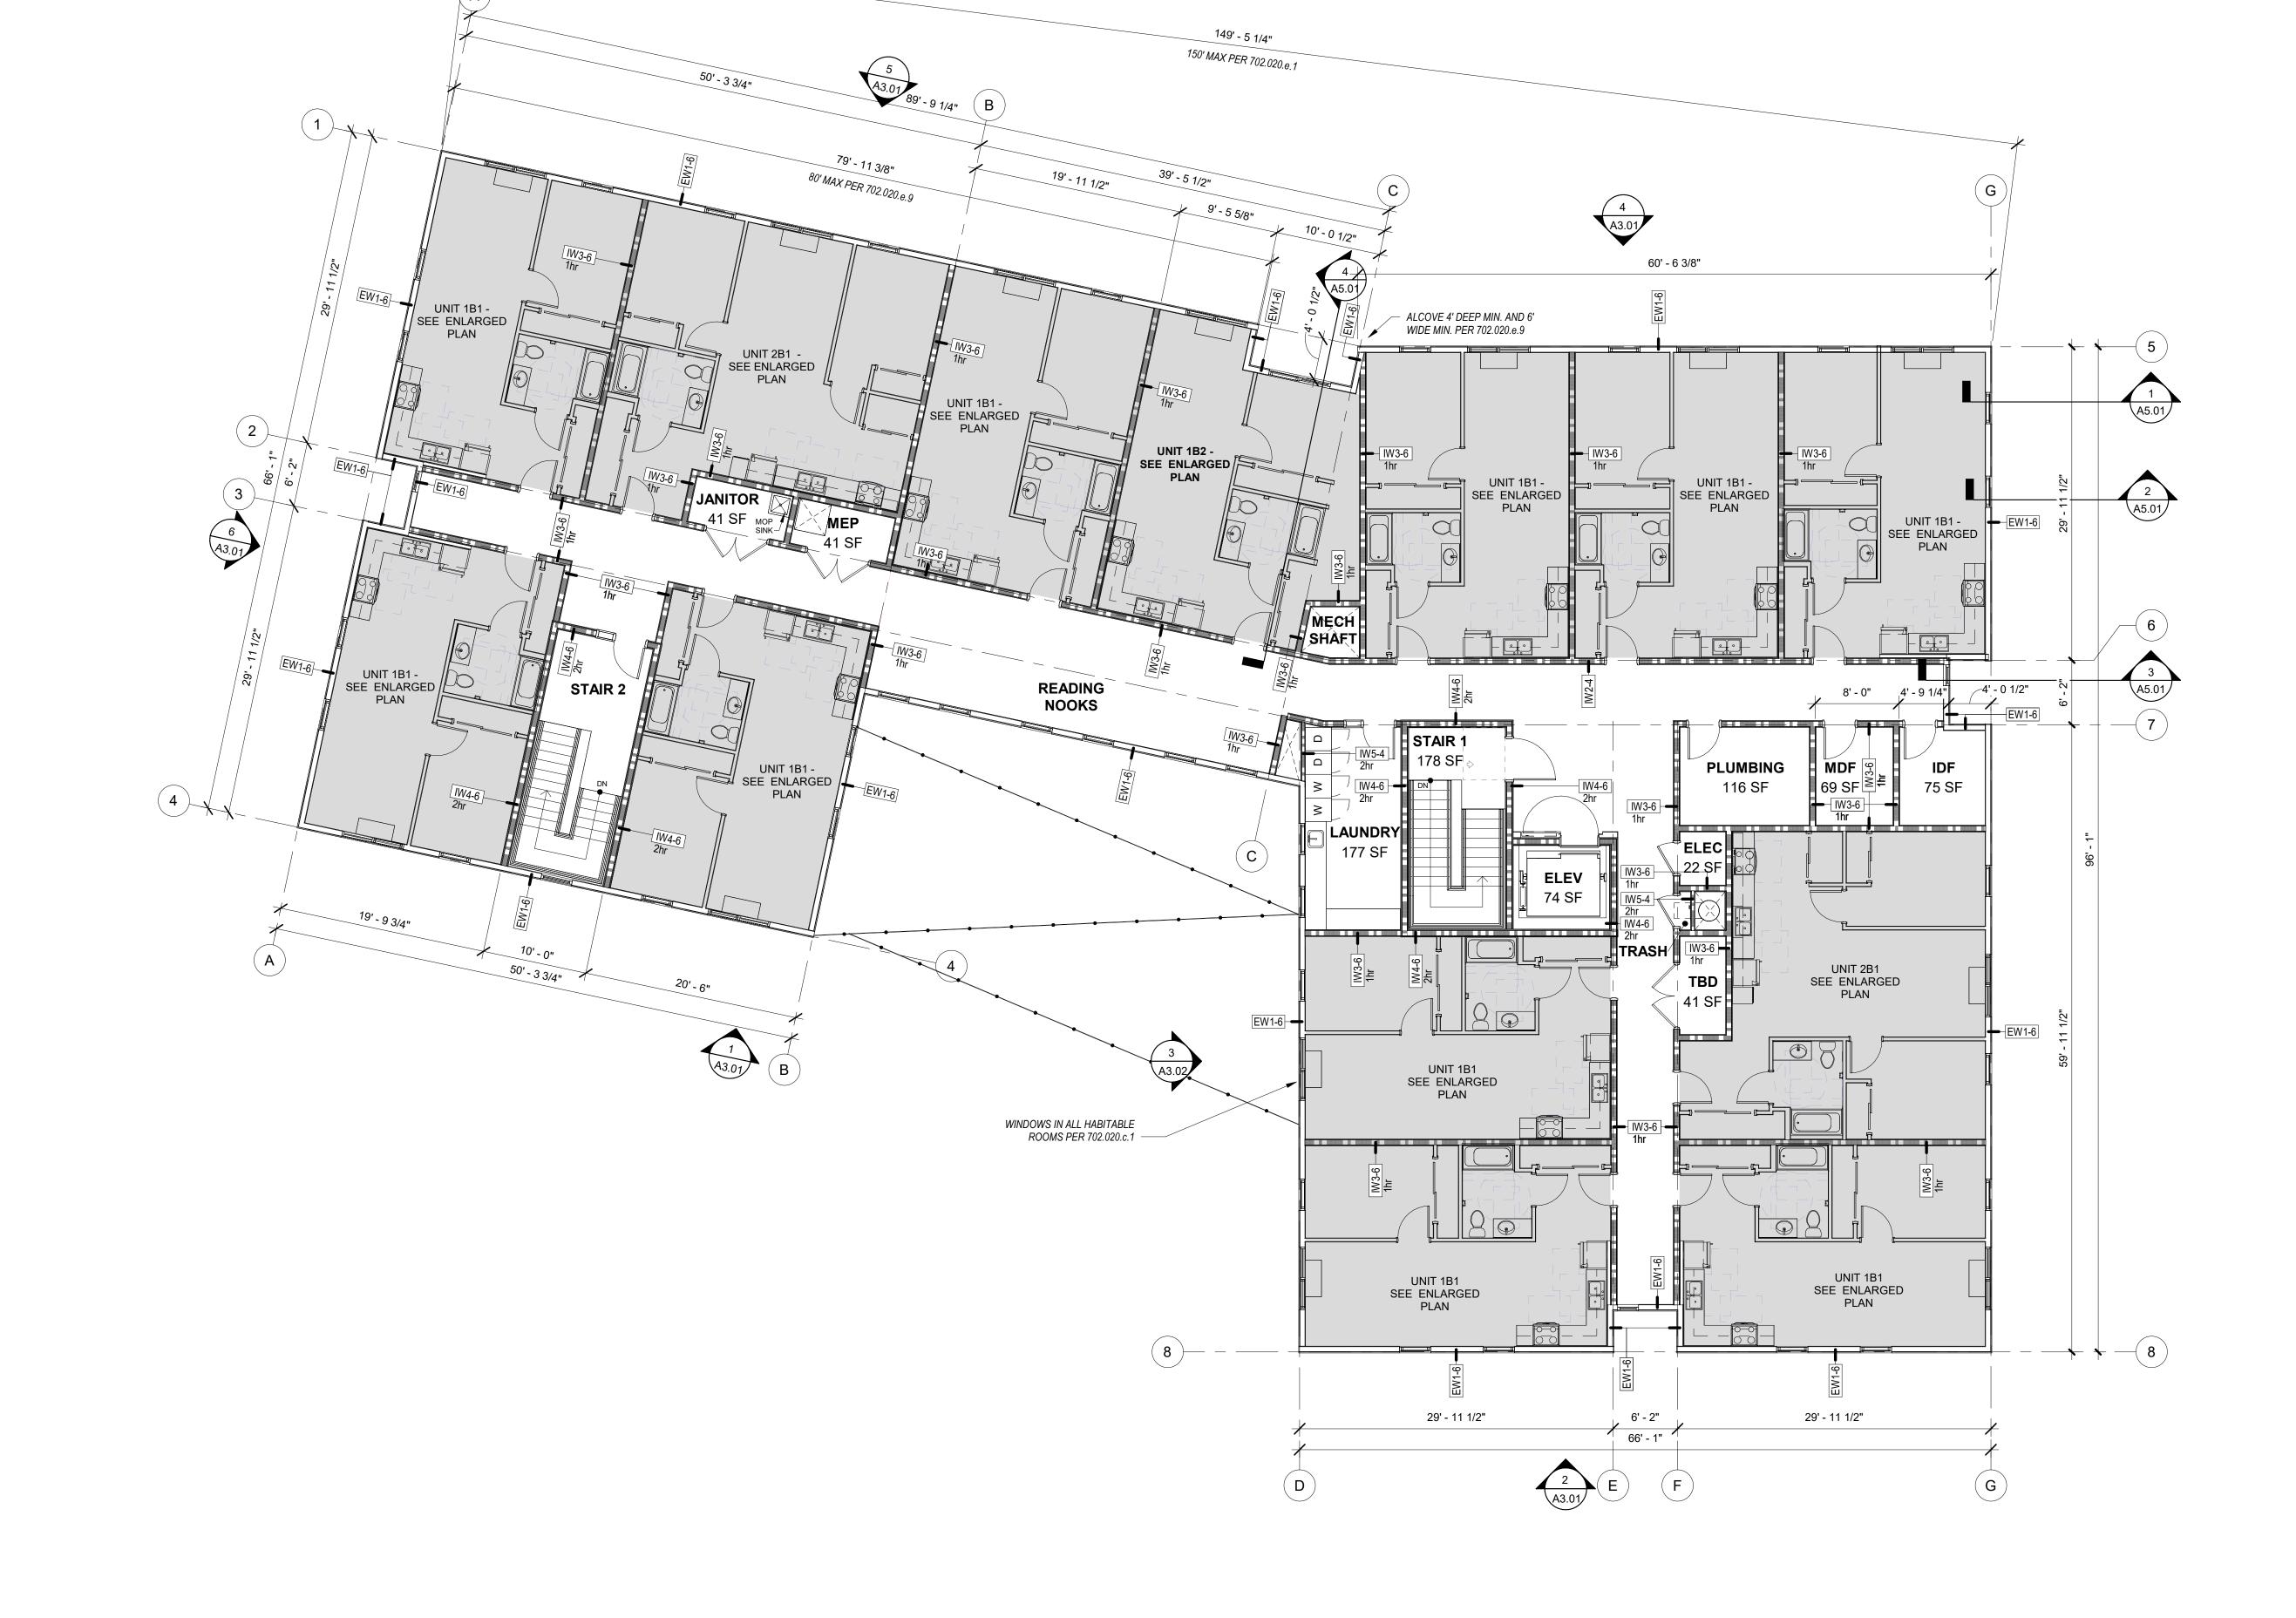


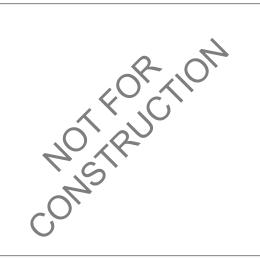LAND USE SUBMISSION

Drawing:

THIRD FLOOR PLAN

01.11.2021



4 FOURTH FLOOR PLAN

1/8" = 1'-0"

GENERAL SHEET NOTES

- A. WALL DIMENSIONS ARE FROM FACE OF STUD OR CL OF COLUMN U.N.O.
- B. ALL EXTERIOR GRID LINES SHOWN ARE TO FACE OF SHEATHING U.N.O. ALL INTERIOR GRID LINES
- ARE TO FACE OF STUD U.N.O. ALL DOOR AND WINDOW DIMENSIONS ARE TO CL OR OVERALL UNIT. REFERENCE SCHEDULES AND DOOR AND WINDOW TYPES
 REFERENCE STRUCTURAL DRAWINGS FOR

GENERAL CONTROL JOINTS @ SLAB.

DOOR NUMBERS

- COORDINATE FINAL LOCATIONS WITH ARCHITECT COMPATIBILITY WITH FLOOR FINISHES E. SEE DOOR SCHEDULE FOR DOOR TYPES AND INSTALLATION DETAILS CORRESPONDING TO
- SEE WINDOW SCHEDULE FOR WINDOW TYPES G. FOR FLOOR FINISHES, SEE FLOOR FINISH PLAN H. WIRE SHELVING IN ALL BEDROOM CLOSETS M.E.P. INFORMATION PROVIDED FOR
- REFERENCE ONLY. SEE M.E.P. DRAWINGS. PROVIDE BLOCKING FOR FUTURE GRAB BARS AT
- ALL UNIT RESTROOMS WHERE GRAB BARS ARE NOT SHOWN IN PLAN, REF ACCESSIBILITY DIAGRAMS FOR LOCATIONS K. FIRE EXTINGUISHER TO BE PLACED IN PANTRY IN ALL UNITS
- L. DOWNSPOUTS PAINTED IN FIELD, RECTANGLE SHAPE AND SIZE PER PLUMBING AND CIVIL M. WHERE WALLS, DOORS AND WINDOWS ARE NOT DIMENSIONED, ALIGN WITH THOSE ON THE FLOOR BELOW, TYP. SEE SECTIONS AND EXTERIOR ELEVATIONS.

LEGEND

1 HOUR RATED ASSEMBLY 2 HOUR RATED ASSEMBLY ---- ELEMENT ABOVE

R-1 ASPHALT SHINGLE ROOF

KEYNOTES (07-02)

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Job Number:

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LAND USE SUBMISSION ISSUE

01.11.2021 DATE

Drawing: **FOURTH FLOOR PLAN**

1 ROOF PLAN
1/8" = 1'-0"


GENERAL SHEET NOTES

REFERENCE MECHANICAL, PLUMBING, AND ELECTRICAL DRAWINGS FOR ADDITIONAL ROOF PENETRATIONS NOT SHOWN HERE.

 MINIMUM SLOPE OF CRICKETS TO BE 1/4" PER FT UNLESS NOTED OTHERWISE. CONTRACTOR TO PROVIDE ALL CRICKETS REQ'D TO PROVIDE POSITIVE DRAINAGE TO DRAINS.


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LEGEND

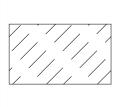

LOW SLOPE MEMBRANE ROOF

BUILT UP CRICKET



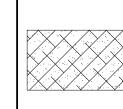

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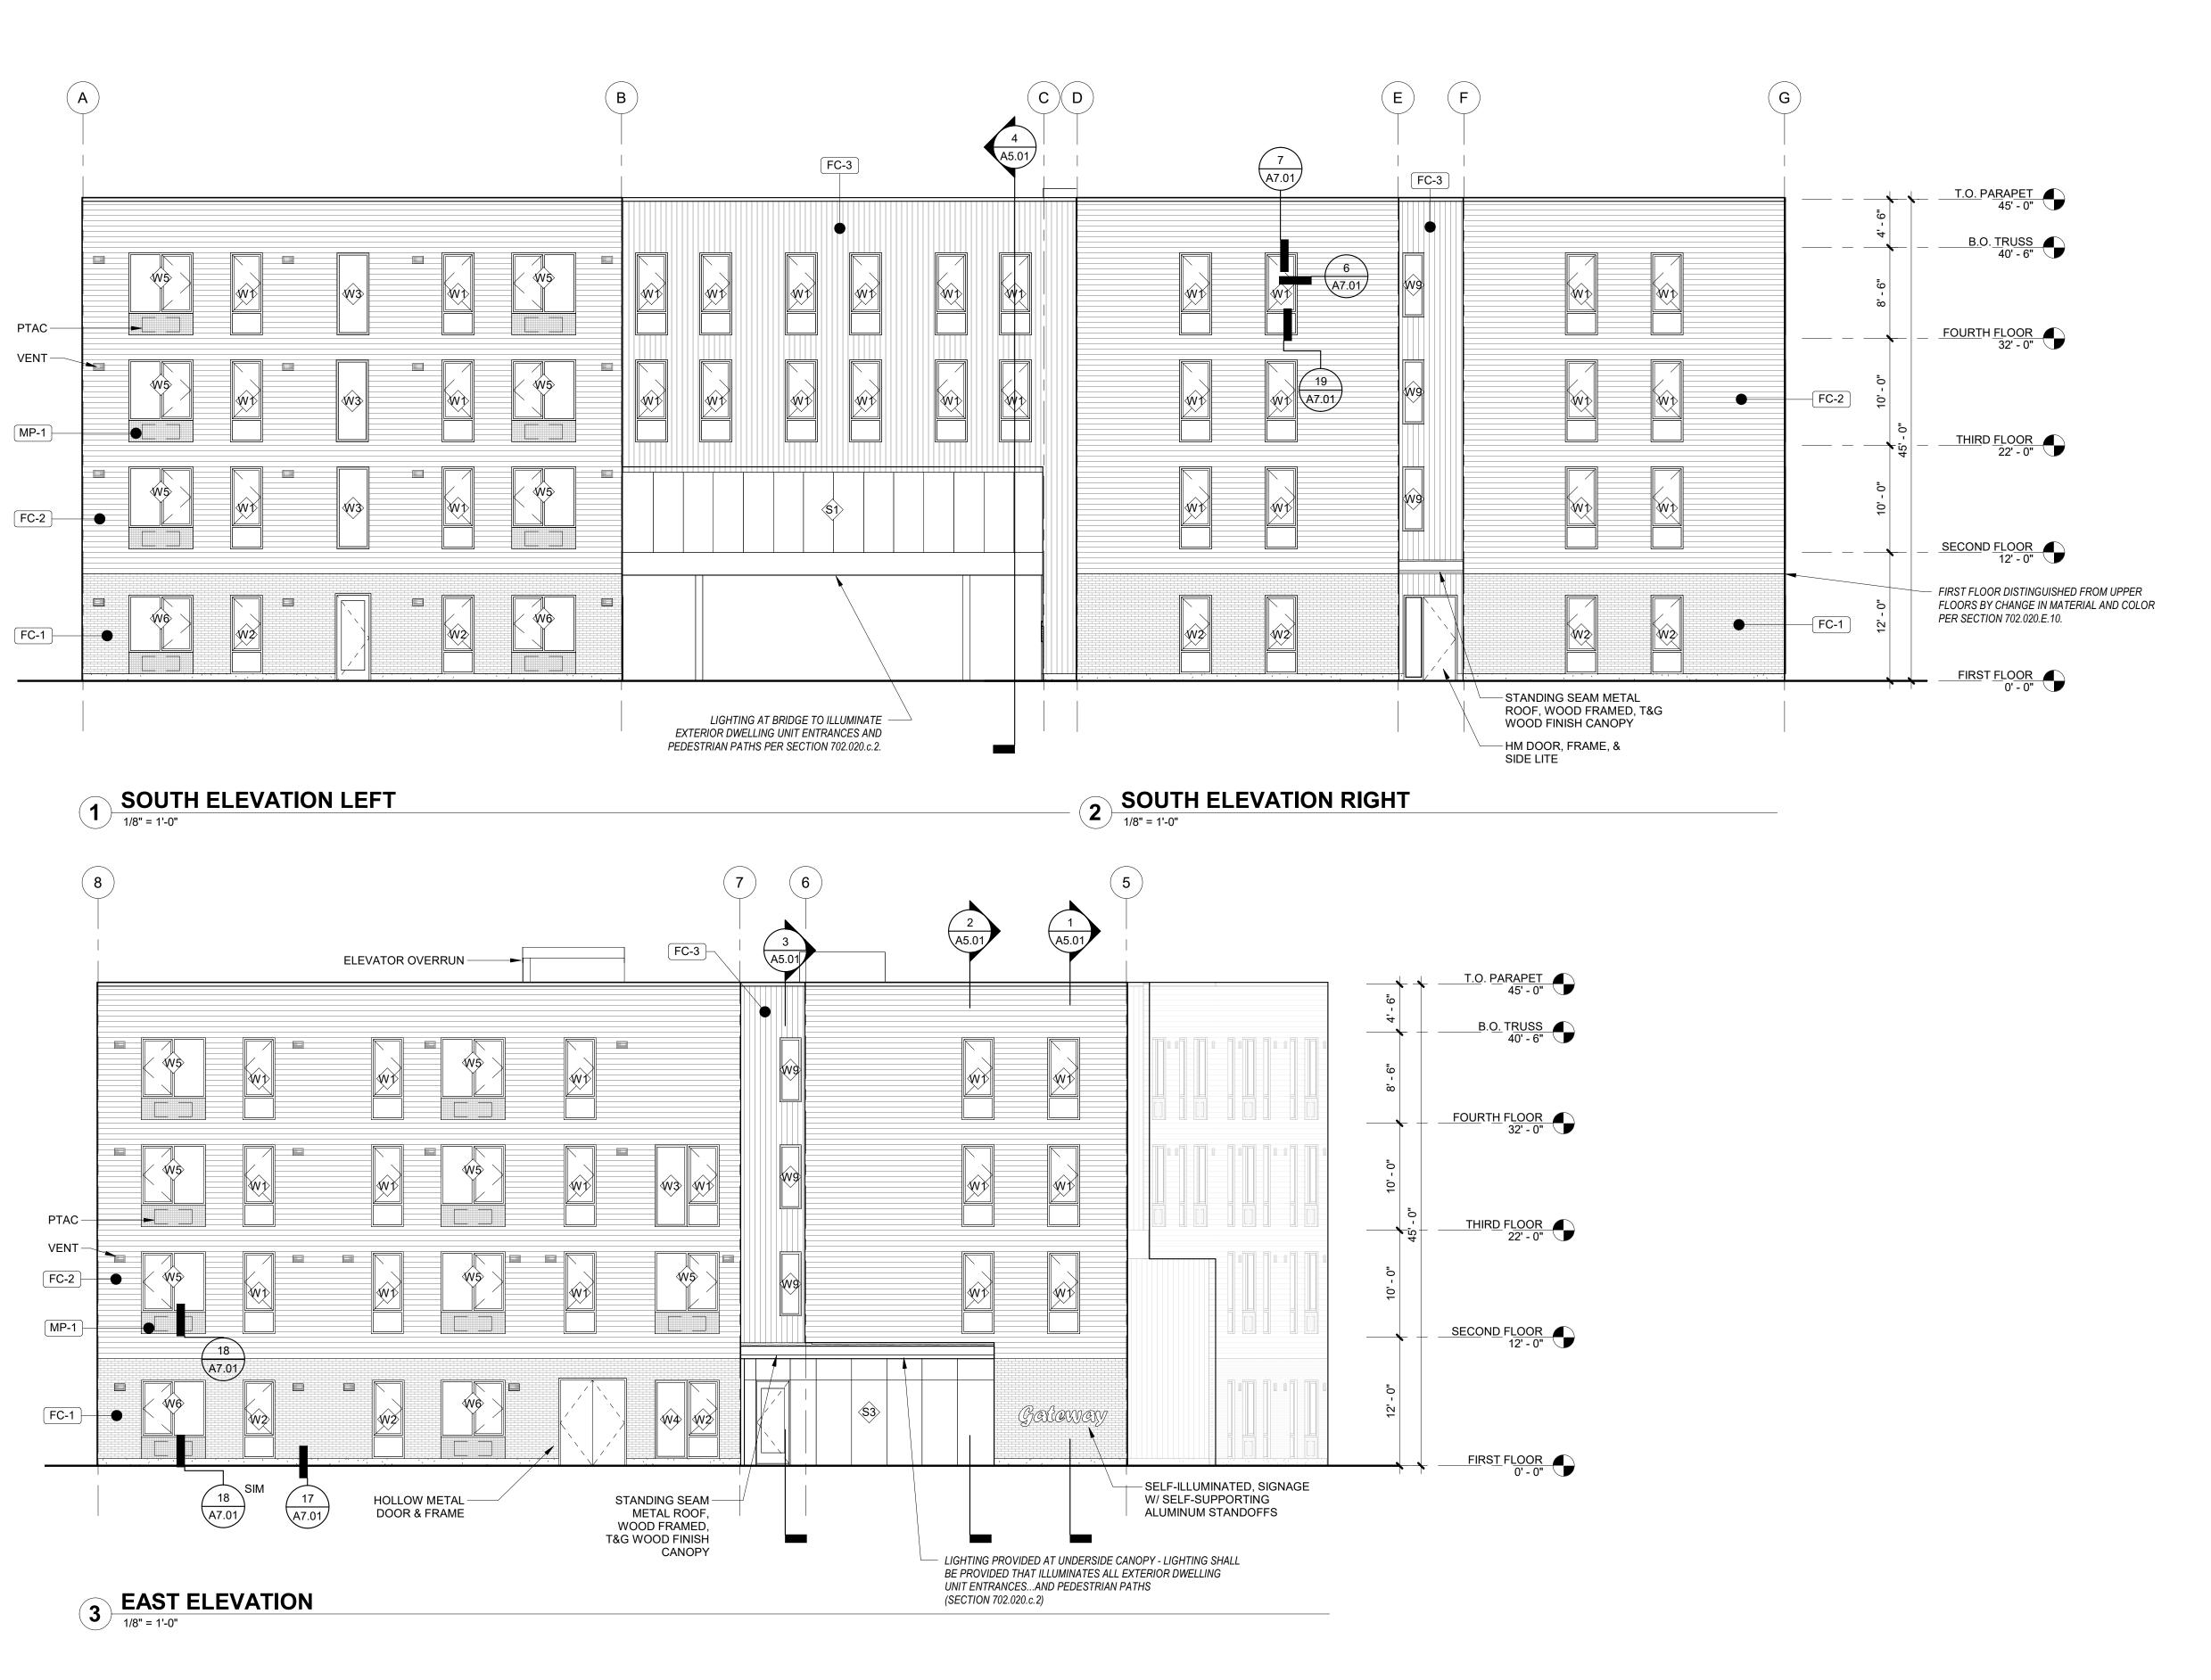
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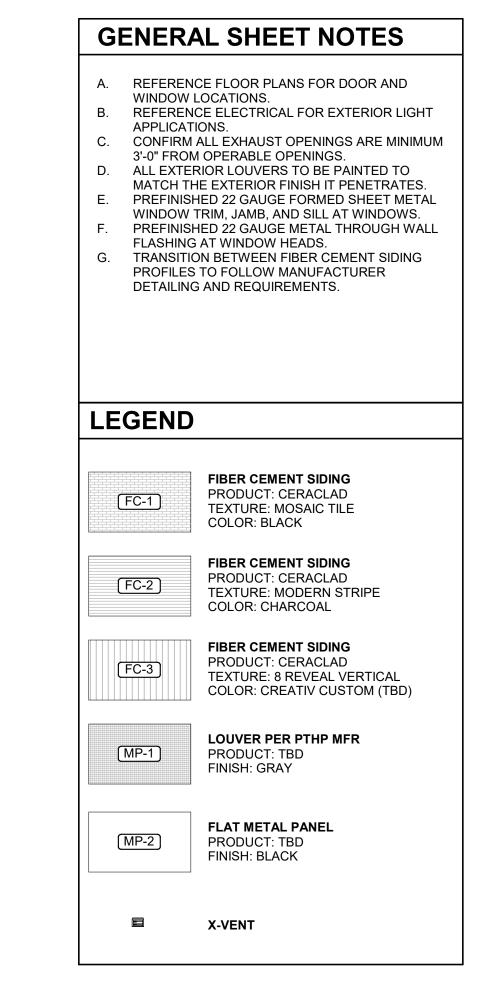
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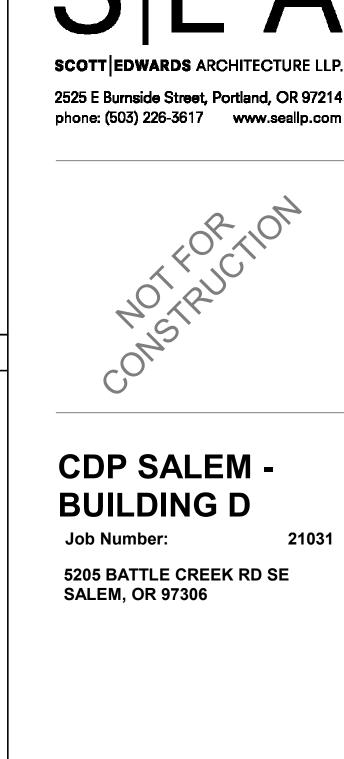
ROOF PLAN

Sheet No:
Building D -


01.11.2021









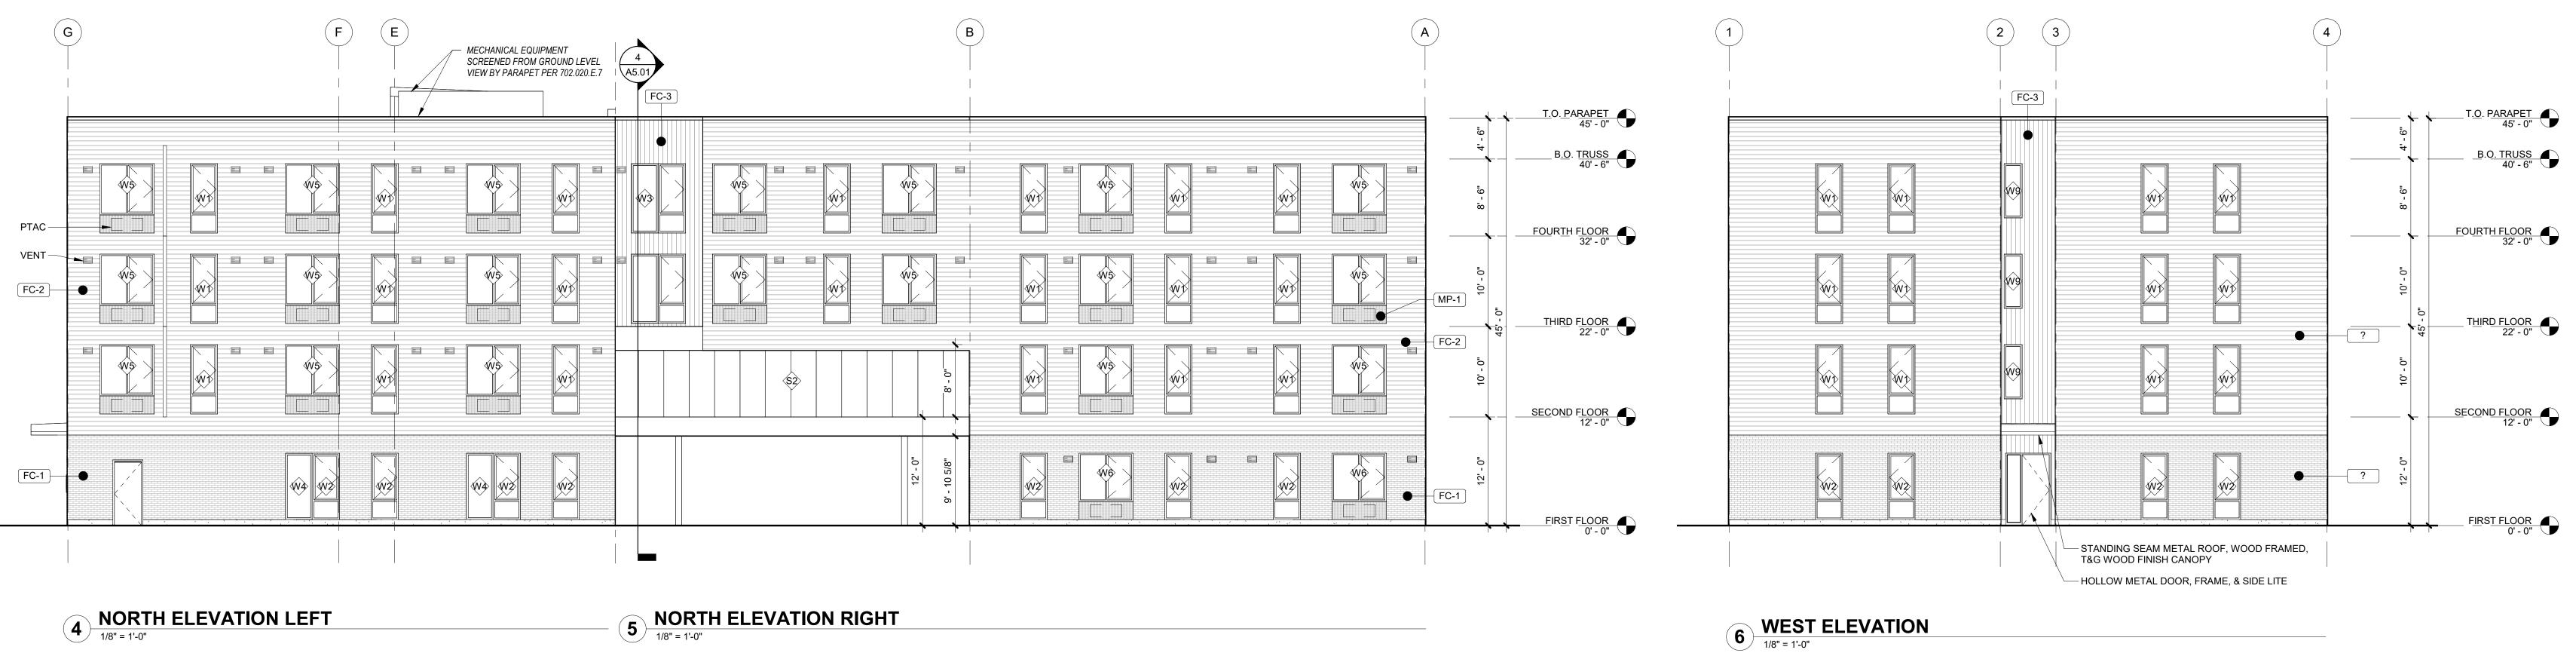



LAND USE SUBMISSION 01.11.2021 DATE ISSUE Drawing:

EXTERIOR ELEVATIONS


Sheet No: Building D -A3.01



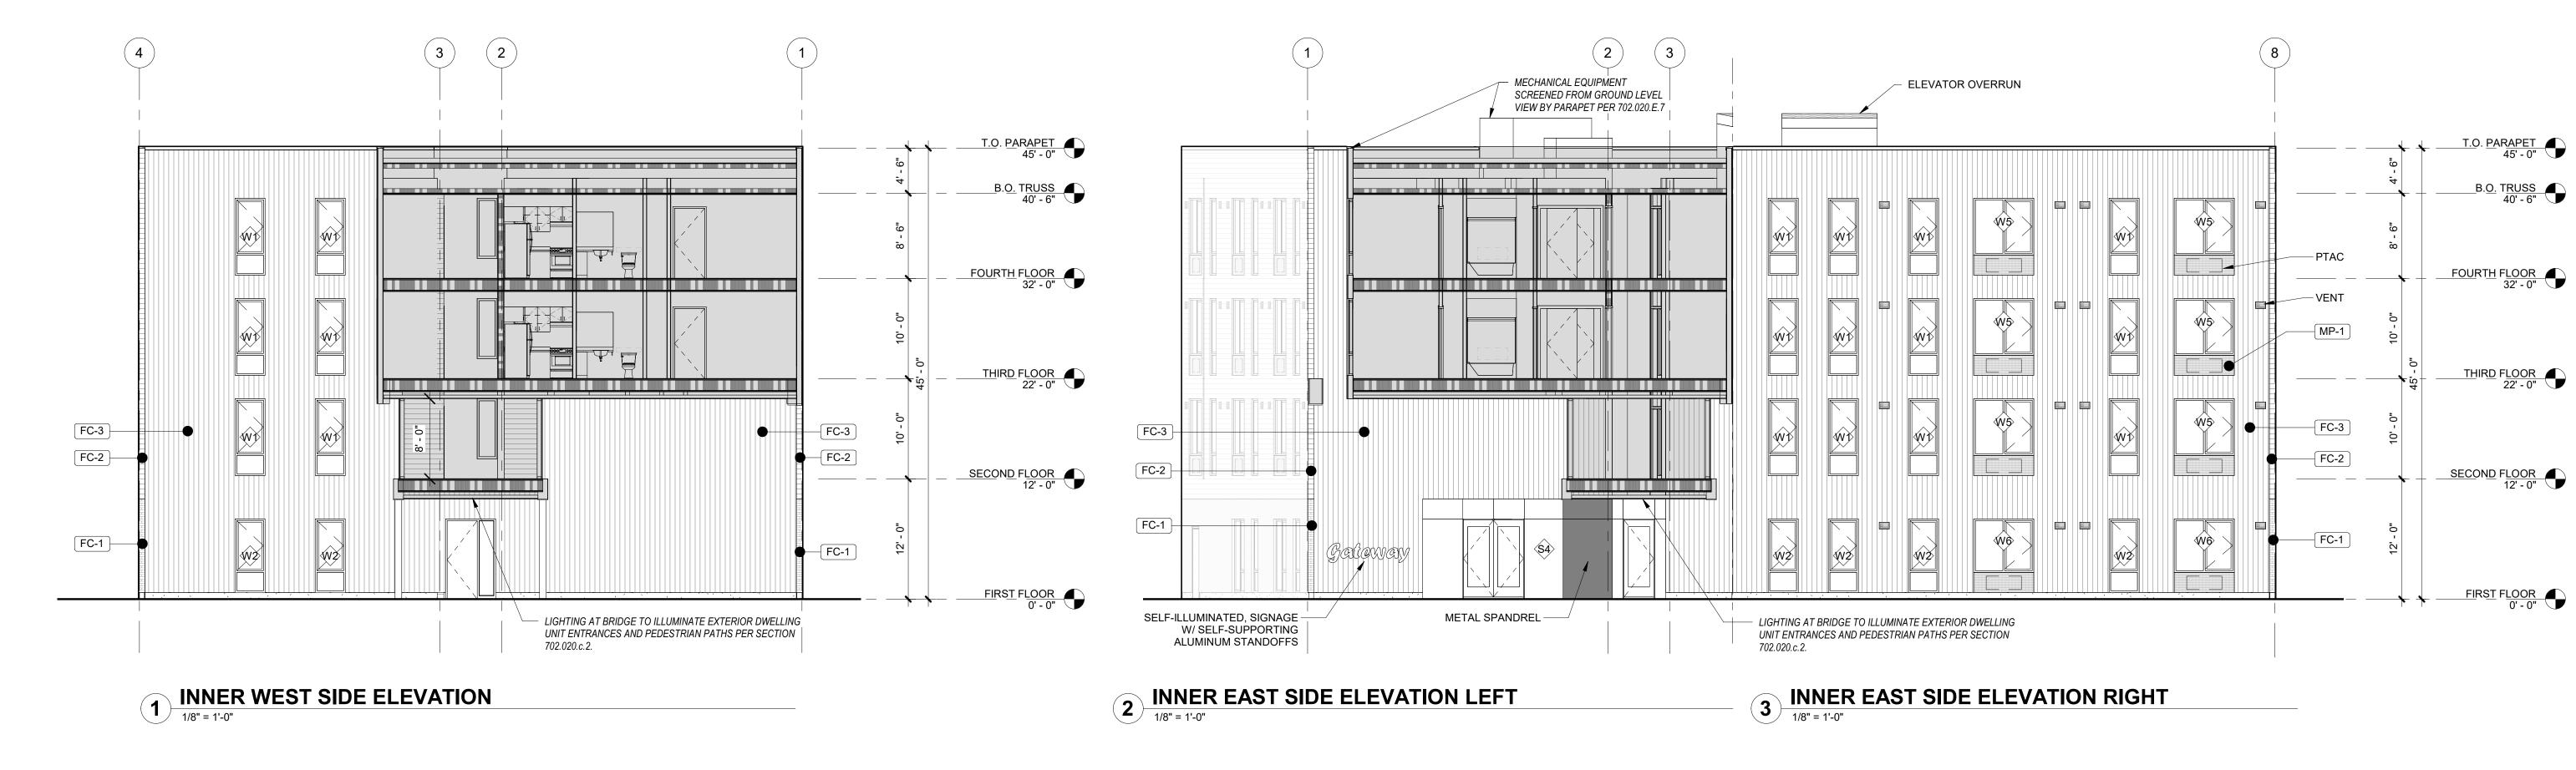

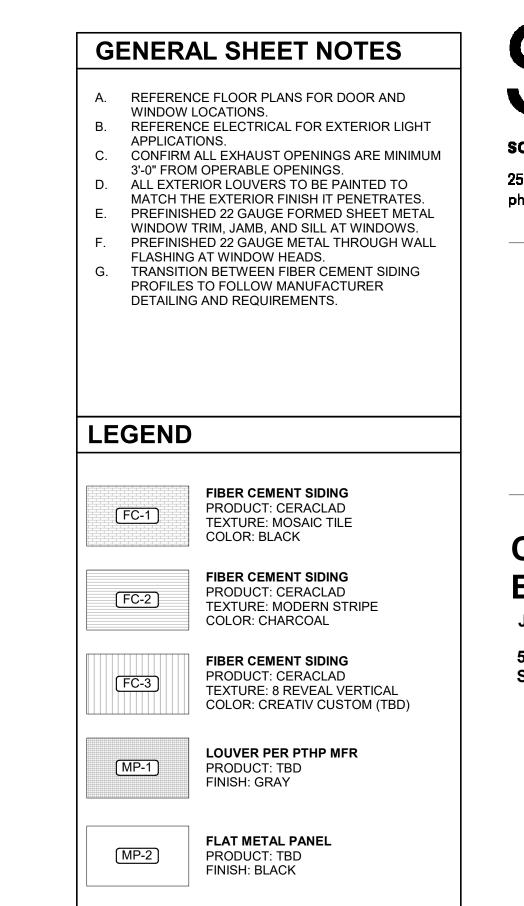

X-VENT

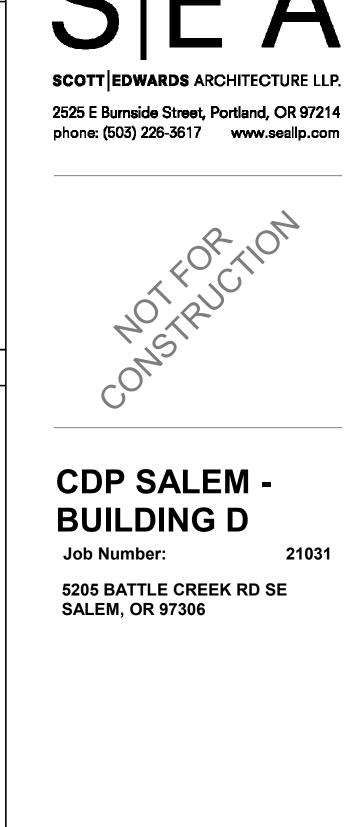



LAND USE SUBMISSION ISSUE

01.11.2021 DATE

Drawing:

EXTERIOR

ELEVATIONS

Sheet No: Building D -

\3.02





NORTH FACADE


MATERIALS




FIBER CEMENT SIDING 1 PRODUCT: CERACLAD TEXTURE: MOSAIC TILE COLOR: BLACK LOCATION: GROUND LEVEL




FIBER CEMENT SIDING 2 PRODUCT: CERACLAD TEXTURE: MODERN STRIPE COLOR: CHARCOAL LOCATION: LEVELS 2-4

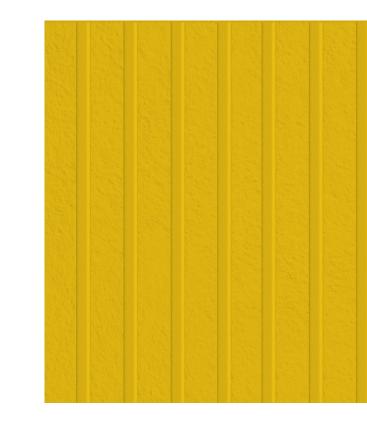

FIBER CEMENT SIDING 3 PRODUCT: CERACLAD TEXTURE: 8-REVEAL COLOR: CREATIV CUSTOM LOCATION: ALCOVES

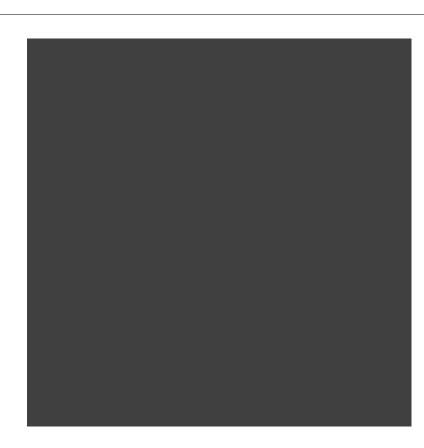

FLAT METAL PANEL PRODUCT: TBD FINISH: TBD, DARK GRAY LOCATION: BELOW WINDOWS

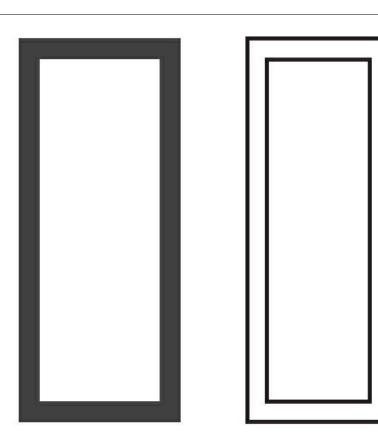

VINYL WINDOWS PRODUCT: VPI ENDURANCE FINISH: BLACK





NORTHWEST CORNER VIEWED FROM SALAL



NORTH VIEW OF UNDERPASS & "PEOPLE WATCHING" BRIDGE



EAST FACADE

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CDP SALEM -

5205 BATTLE CREEK RD SE SALEM, OR 97306

Development Partners

BUILDING D

Job Number:

RENDERINGS



CDP SALEM -BUILDING D Job Number:

5205 BATTLE CREEK RD SE SALEM, OR 97306

Community Development Partners

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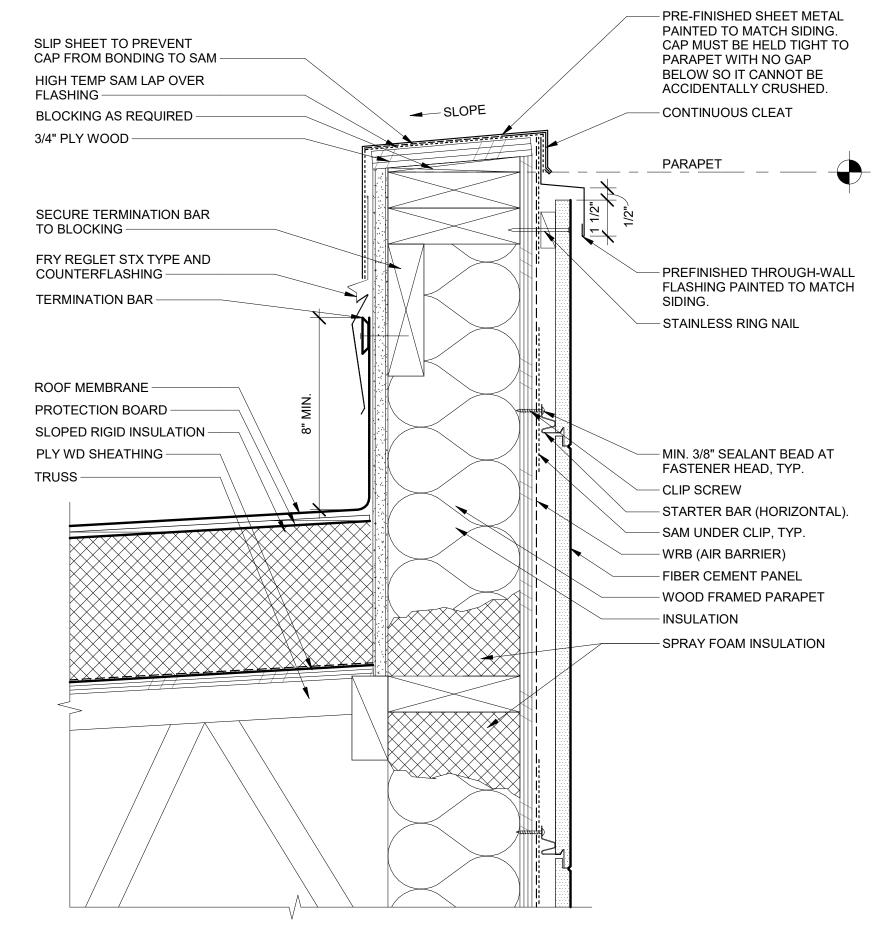
Drawing: **WALL SECTIONS**


01.11.2021


DATE


Sheet No: Building D -A5.01






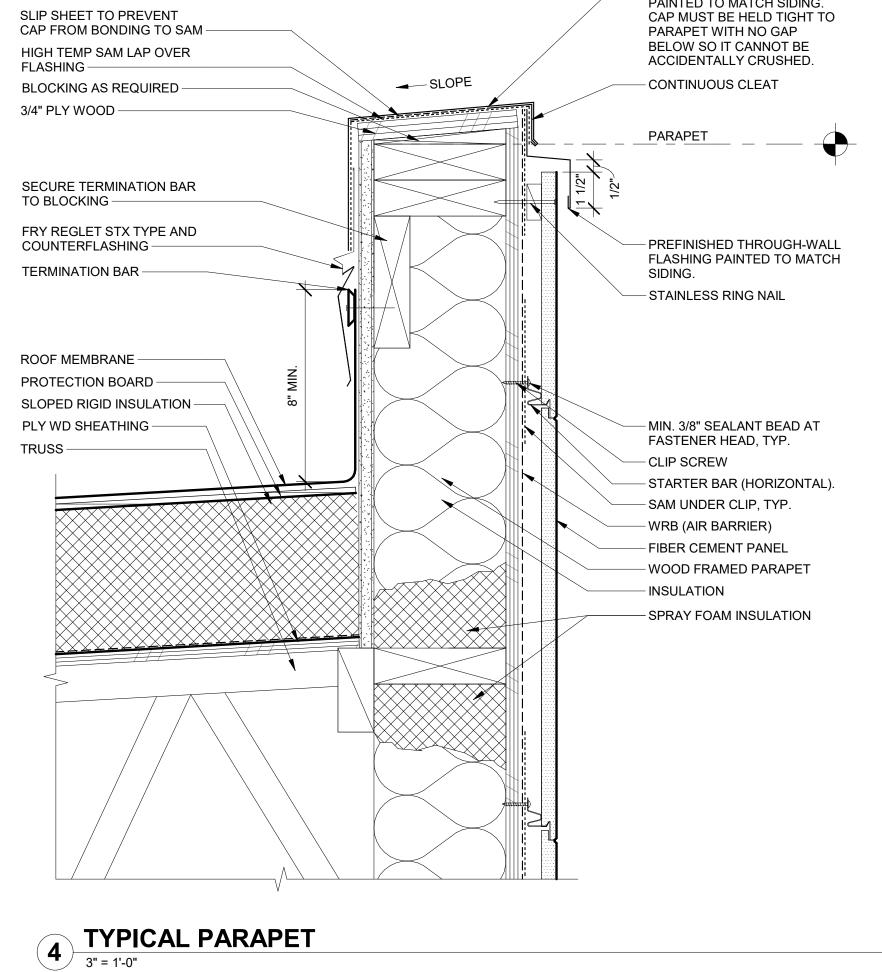

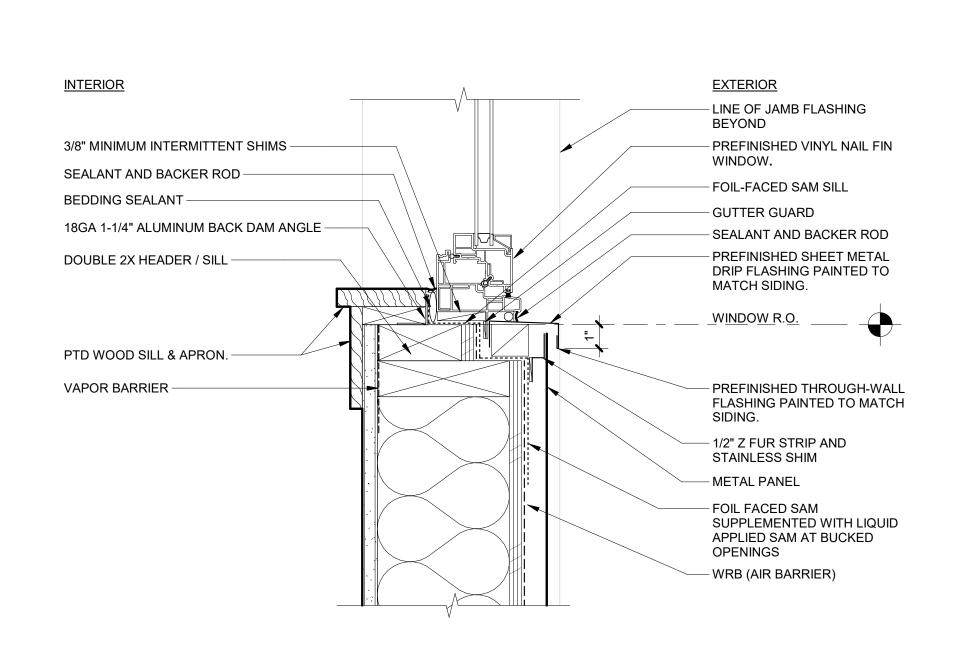

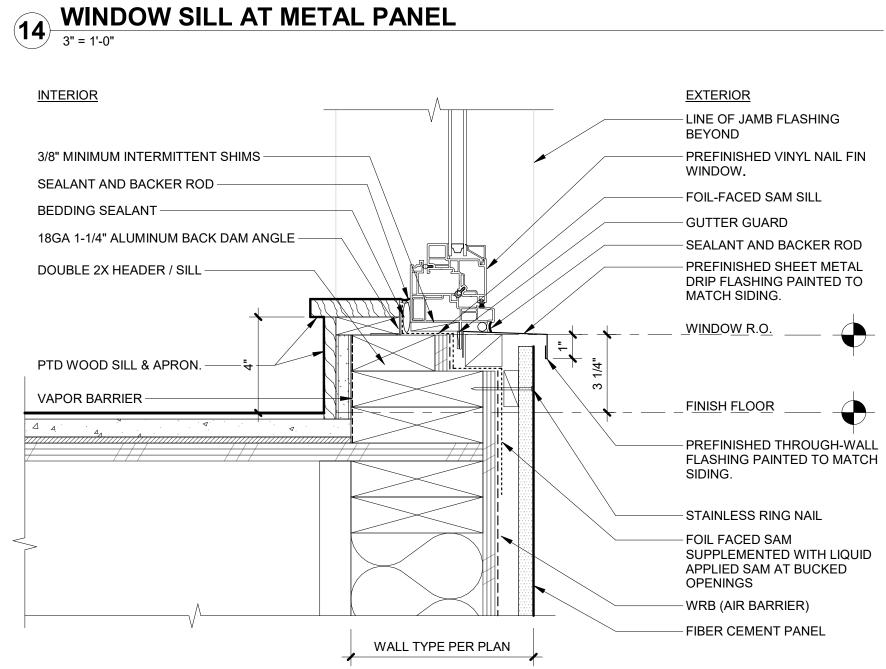



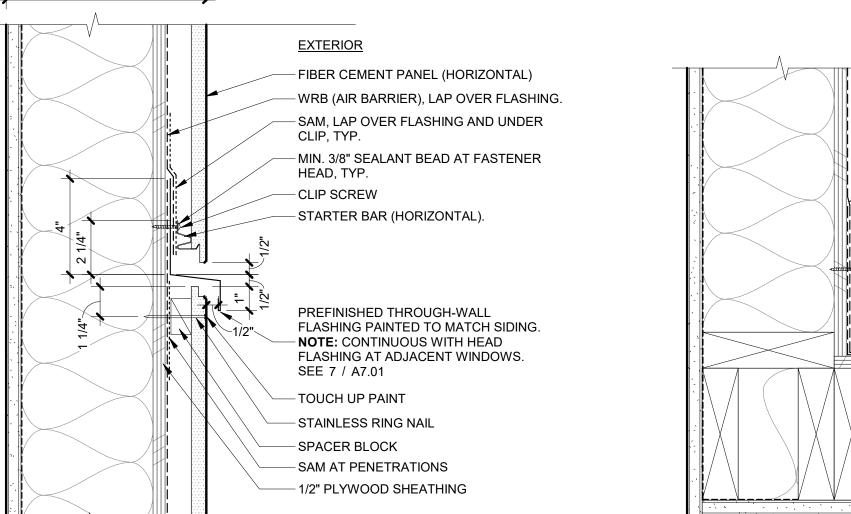

EXTERIOR

- HEADER, SEE STRUCTURAL

WRB (AIR BARRIER) OVER

HEAD FLASHING

- 1/2" Z FUR STRIP AND

PERFORATED METAL PANEL

SEALANT AND BACKER ROD

FOIL FACED SAM AT HEAD

- PREFINISHED VINYL NAIL FIN

MANUFACTURER DOES NOT

ALLOW OTHER MATERIALS TO BE FASTENED THROUGH

- SAM OVER NAIL FIN

WINDOW. NOTE:

NAILING FLANGE

SEALANT -

L-MTL BEAD -

SEALANT

STAINLESS SHIM

SAM PATCH


_____B.O. FRAMING

FLASHING PAINTED TO MATCH SIDING.


NOTE: SET BACK FROM THROUGH-

PREFINISHED THROUGH-WALL

WALL FLASHING ON 3 / A7.01

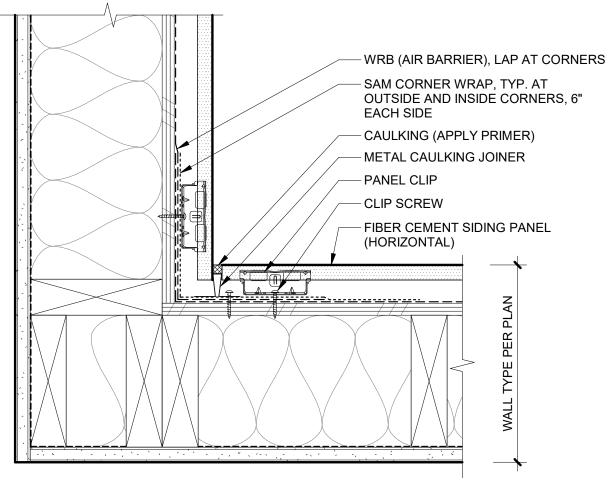

FIBER CEMENT SIDING INSIDE CORNER

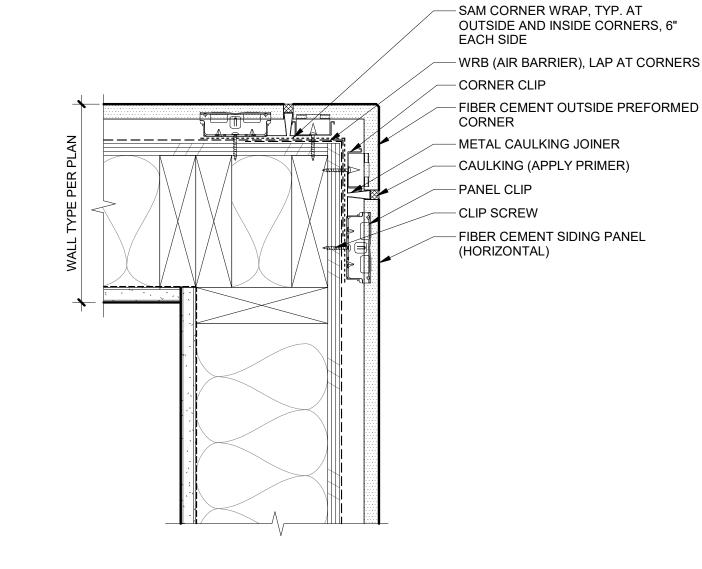


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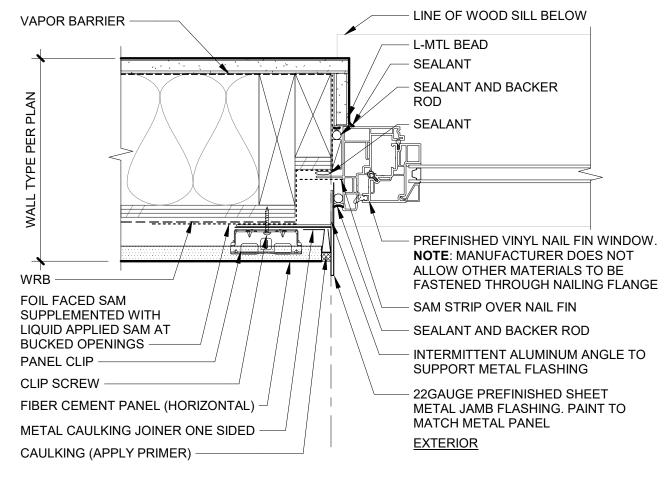
CDP SALEM -BUILDING D

Job Number: **5205 BATTLE CREEK RD SE**

SALEM, OR 97306

FIBER CEMENT SIDING OUTSIDE CORNER



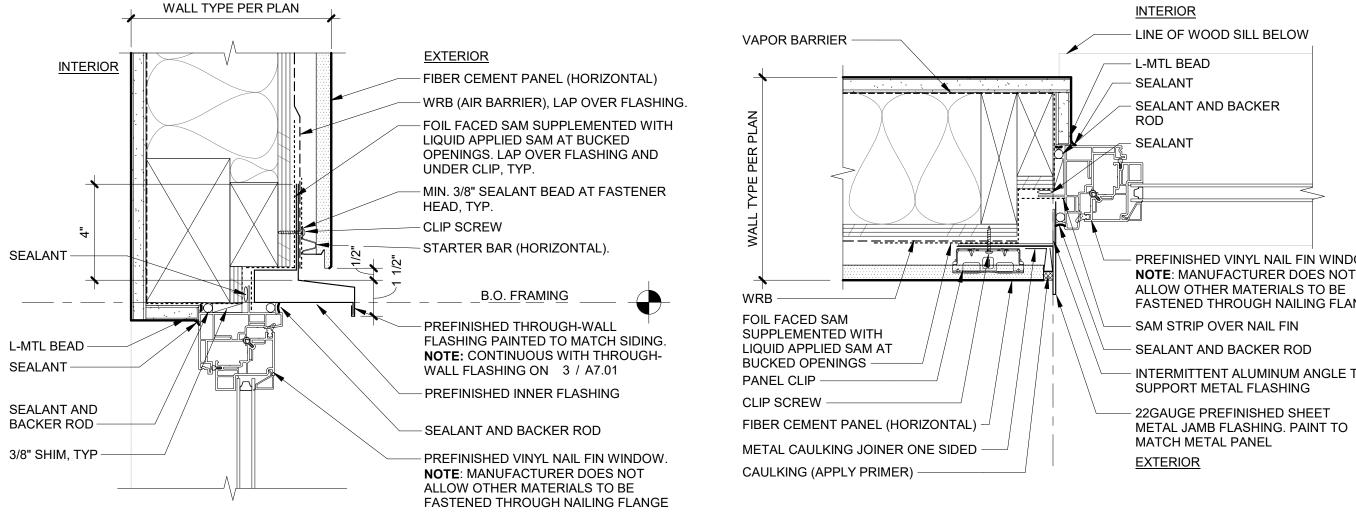



WINDOW SILL AT PTHP
3" = 1'-0"

3 FIBER CEMENT SIDING THROUGH-WALL FLASHING

LWALL TYPE PER PLAN

<u>INTERIOR</u>

SEALANT -

L-MTL BEAD -

SEALANT AND


BACKER ROD —


3/8" SHIM, TYP -

SEALANT

VAPOR BARRIER -

WALL TYPE PER PLAN

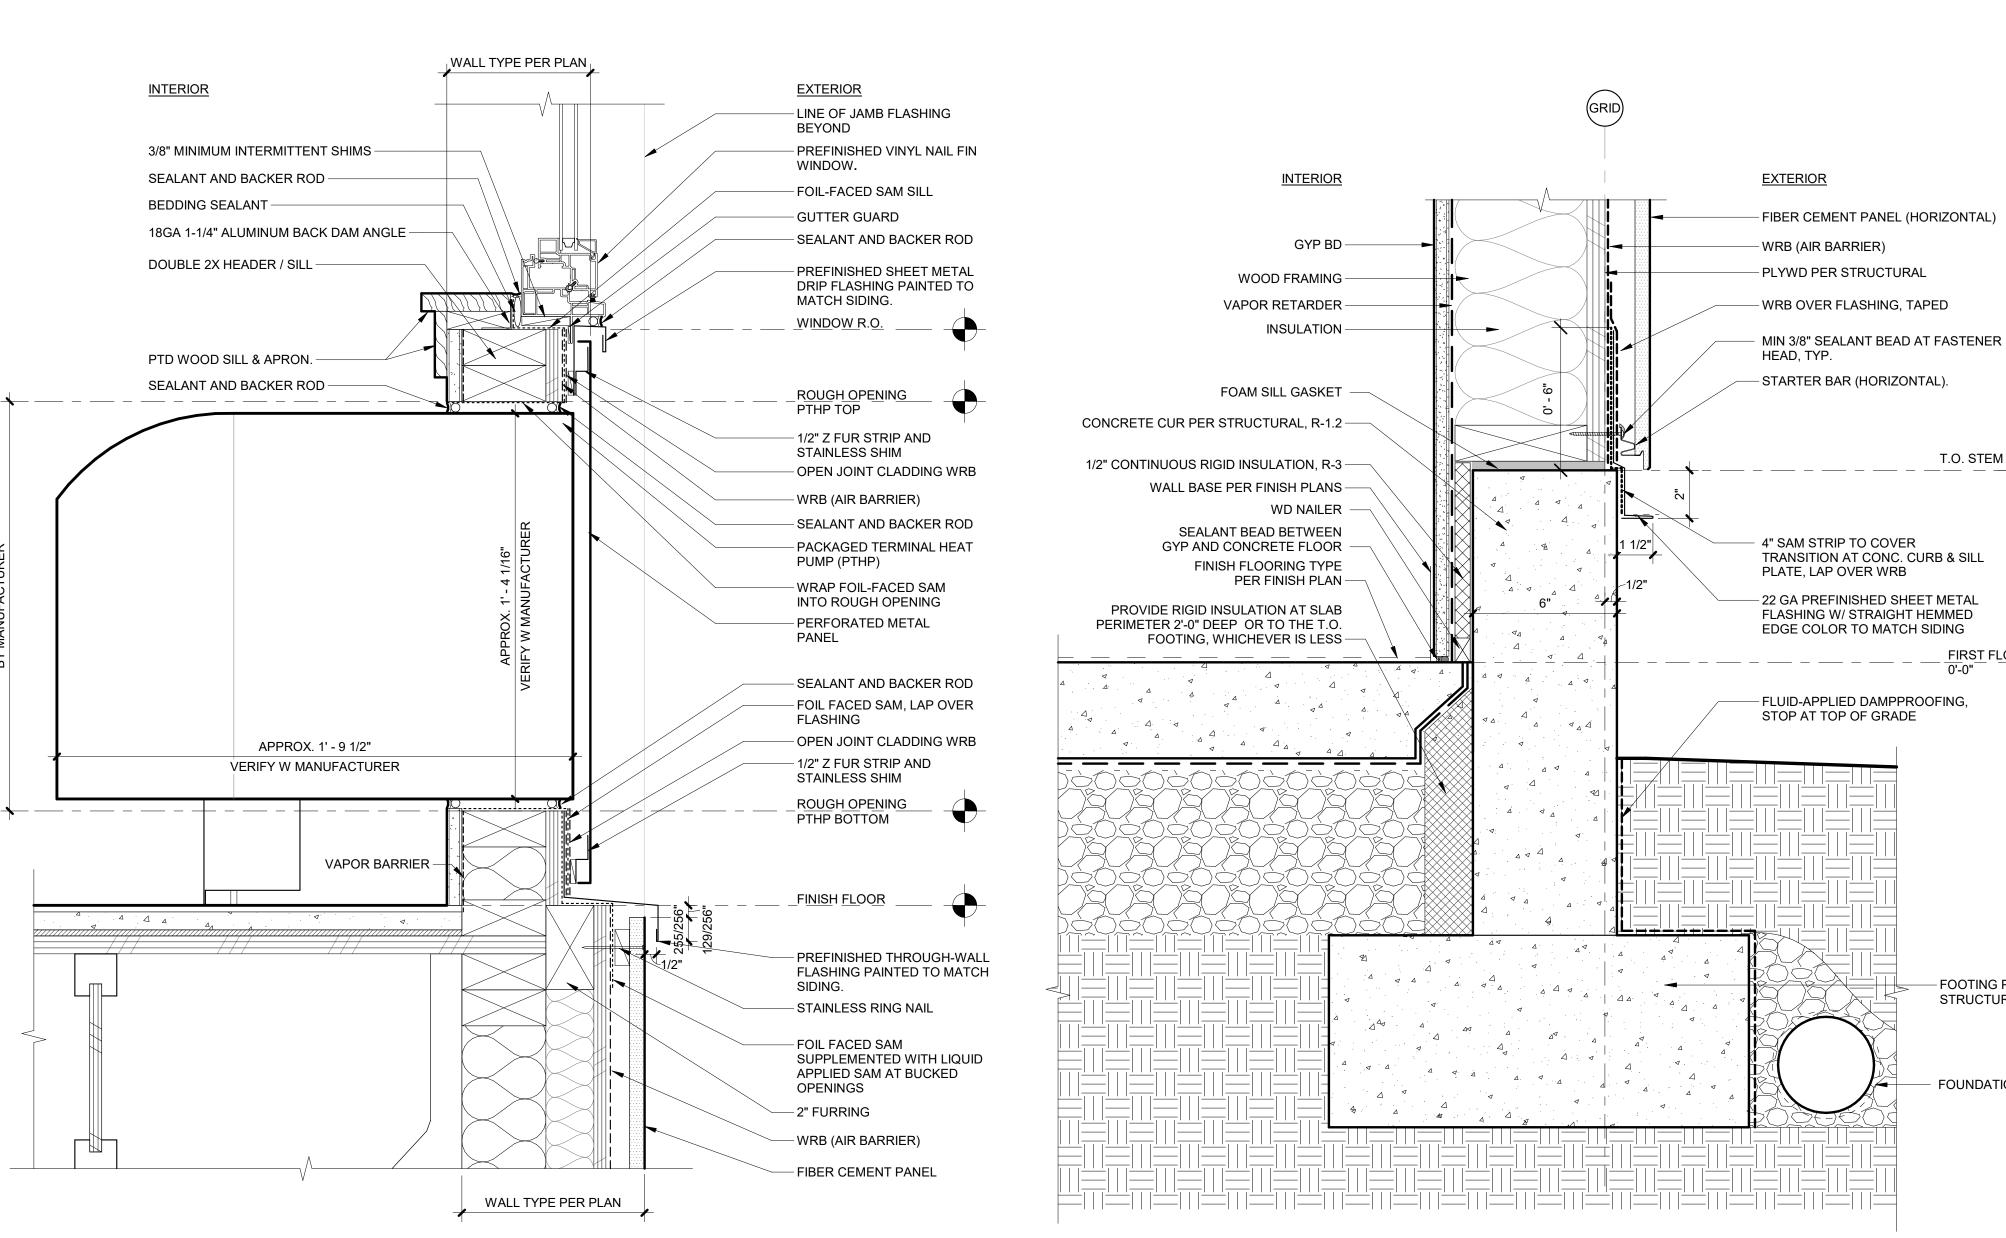

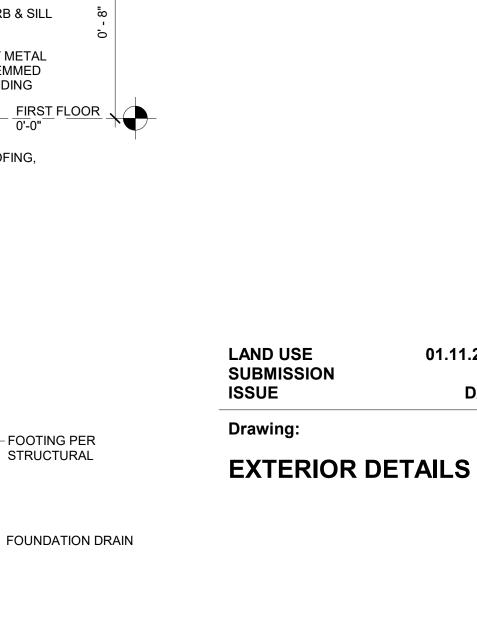

- FOOTING PER


STRUCTURAL


CURB AT EXT FIBER CEMENT PANEL WALL
3" = 1'-0"

Sheet No:

Building D -

01.11.2021

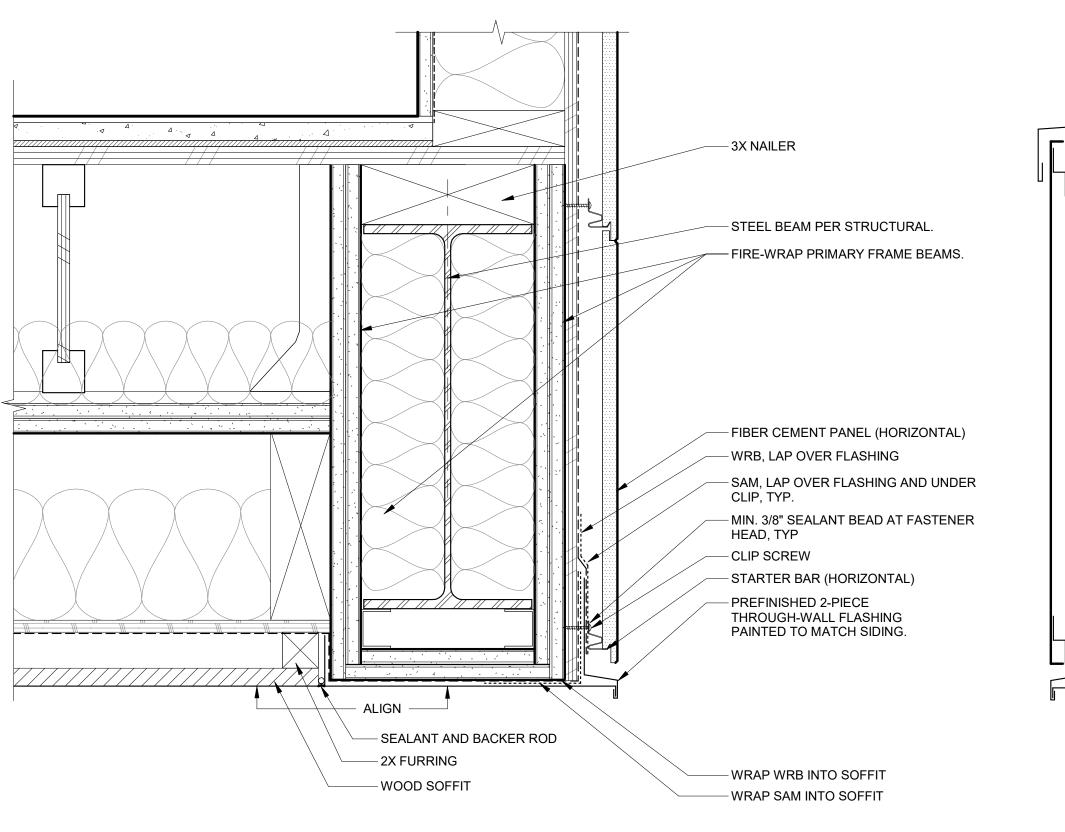

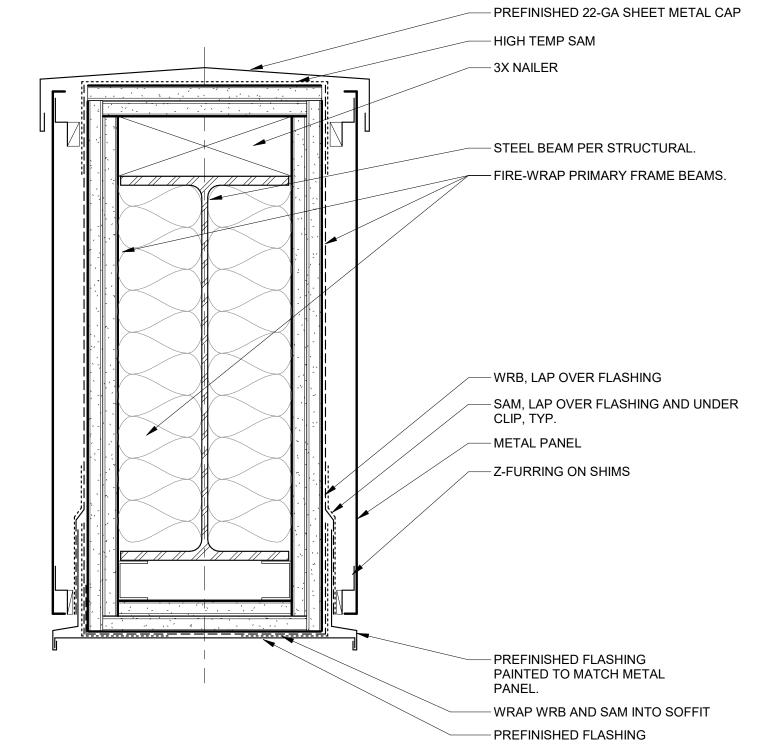

2 1 HOUR BEAM AT SOFFIT OUTSIDE CORNER
3" = 1'-0"

1 HOUR BEAM AT EXTERIOR

3" = 1'-0"

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EXTERIOR DETAILS

Sheet No:
Building D -