LAND USE SUBMISSION

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CDP SALEM - BUILDING B


5205 BATTLE CREEK RD SE SALEM, OR 97306



| GENERAL PROJECT NOTES | PROJECT TEAM | PROJECT SUMMARY | SHEET INDEX |
|--|--|---|--|
| REFER TO OWNER-CONTRACTOR AGREEMENT FOR GENERAL CONDITIONS. WHERE THERE IS A CONFLICT BETWEEN THE CONTRACT AND NOTES HEREIN, THE CONTRACT TAKES PRECEDENCE. 1. GENERAL CONTRACTOR IS RESPONSIBLE FOR THE FULL SET OF CONSTRUCTION DOCUMENTS, INCLUDING BUT NOT LIMITED TO DRAWINGS, SPECIFICATIONS, AND ADDENDA. 2. THE CONTRACTOR SHALL FIELD VERIFY ALL CONDITIONS AND DIMENSIONS PRIOR TO ANY WORK AND SHALL BE RESPONSIBLE FOR ALL WORK AND MATERIALS INCLUDING THOSE FURNISHED BY SUBCONTRACTORS. 3. DIMENSIONS TAKE PRECEDENCE OVER DRAWINGS: DO NOT SCALE DRAWINGS TO DETERMINE ANY LOCATIONS. THE ARCHITECT SHALL BE NOTIFIED OF ANY DISCREPANCY PRIOR TO CONTINUING WITH WORK. 4. GENERAL CONTRACTOR SHALL KEEP THE CONSTRUCTION SITE IN A BROOM CLEAN | OWNER CDP OREGON LLC 126 NE ALBERTA ST #202 PORTLAND, OR 97211 TEL: 971.533.7466 FAX: N/A CONTACT: THOMAS ELDRIDGE EMAIL: THOMAS@COMMUNITYDEVPARTNERS.COM CONTRACTOR LMC CONSTRUCTION 19200 SW TETON AVE TUALATIN, OR 97062 TEL: 503.646.0521 FAX: 503.646.6823 CONTACT: CHRIS DUFFIN EMAIL: CHRISD@IMCCONSTRUCTION.COM | PROJECT SUMIWARY PROJECT SUMIWARY 3-STORY, WOOD FRAMED MULTIFAMILY BUILDING FEATURING 24 RESIDENTIAL UNITS GROSS AREA: 22,739 SF PROJECT ADDRESS: 5205 BATTLE CREEK RD SE SALEM, OR 97306 LEGAL DESCRIPTION: 083W14/ 118 AND 300 ZONING: RM-II | SHEET # SHEET NAME GENERAL G0.01 GENERAL PROJECT INFORMATION G1.01 CODE SUMMARY ARCHITECTURAL A0.01 ARCHITECTURAL GENERAL NOTES AND DIAGRAMS A0.10 ACCESSIBILITY DIAGRAMS - RESIDENTIAL A0.20 ASSEMBLIES |
| CONDITION AT ALL TIMES DURING THE PROJECT. 5. THE CONTRACTOR SHALL REPORT TO THE ARCHITECT ANY ERRORS, INCONSISTENCIES OR OMISSIONS HE OR SHE MAY DISCOVER. BRING UNFORSEEN CONDITIONS TO ATTENTION OF ARCHITECT UPON DISCOVERY AT ANY POINT. THE MEANS OF CORRECTING ANY ERROR OR UNFORSEEN CONDITION SHALL FIRST BE APPROVED BY THE ARCHITECT. 6. ALL REQUIRED CITY AND/OR COUNTY LICENSE SHALL BE ACQUIRED AND PAID FOR BY THE INDIVIDUAL TRADE. 7. THE ARCHITECT WILL REVIEW SHOP DRAWINGS AND SAMPLES FOR CONFORMANCE WITH THE DESIGN CONCEPT OF THE PROJECT. THE ARCHITECT'S REVIEW OF A SEPARATE ITEM SHALL NOT INDICATE APPROVAL OF AN ASSEMBLY IN WHICH THE ITEM FUNCTIONS. 8. IT SHALL BE THE RESPONSIBILITY OF THE CONTRACTOR TO VERIFY LOCATION OF ALL EXISTING UTILITIES WHETHER SHOWN HEREIN OR NOT AND TO PROTECT THEM FROM DAMAGE. THE CONTRACTOR SHALL BEAR ALL EXPENSES OF REPAIR OR REPLACEMENT OF UTILITIES OR OTHER PROPERTY DAMAGED BY OPERATIONS IN CONJUNCTION WITH THE EXECUTION OF THE WORK. | ARCHITECT SCOTT EDWARDS ARCHITECTS, LLP 2525 E. BURNSIDE STREET PORTLAND, OREGON 97214 TEL: 503.226.3617 FAX: 503.226.3715 CONTACT: DAVE MOJICA EMAIL: DMOJICA@SEALLP.COM CIVIL WES TECH ENGINEERING SALEM, OR 97302 TEL: 503.585.2474 FAX: N/A CONTACT: STEVE WARD EMAIL: SWARD@WESTECH-ENG.COM | | A2.11 OVERALL FIRST & SECOND FLOOR PLANS A2.12 OVERALL THIRD & ROOF PLANS A3.01 EXTERIOR ELEVATIONS A3.02 EXTERIOR ELEVATIONS A3.10 RENDERINGS A5.01 WALL SECTIONS A7.01 EXTERIOR DETAILS |
| CITY APPROVED PLANS SHALL BE KEPT IN A SECURE PLACE AND SHALL NOT BE USED BY WORKERS. THE CONTRACTOR SHALL BE RESPONSIBLE THAT ALL SUBCONTRACTORS' CONSTRUCTION SETS REFLECT THE SAME INFORMATION. THE CONTRACTOR SHALL ALSO MAINTAIN, IN GOOD CONDITION, ONE COMPLETE SET OF STAMPED CITY APPROVED PLANS WITH ALL REVISIONS, ADDENDUMS, AND CHANGE ORDERS ON THE PREMISES AT ALL TIMES. THESE ARE TO BE UNDER THE CARE OF THE JOB SUPERINTENDENT AND MUST BE MADE AVAILABLE TO BUILDING AND FIRE INSPECTIONS FOR REFERENCE DURING CONSTRUCTION. THE CONTRACTOR SHALL BE RESPONSIBLE FOR THE COMPLETE SECURITY OF THE | LANDSCAPE ARCHITECT PLACE 735 NW 18TH AVENUE PORTLAND, OR 97209 TEL: 503 334 2080 FAX: N/A CONTACT: MAURICIO VILLARREAL EMAIL: MAURICIO.VILLARREAL@PLACE.LA | SEPARATE PERMITS AND DEFERRED SUBMITTAL BIDDER DESIGN ITEMS CONTRACTOR SHALL PROVIDE DESIGN, ENGINEERING, FURNISHING AND INSTALLATION OF A COMPLETE, FUNCTIONING SYSTEM(S) BASED ON THE SCHEMATIC LAYOUT SHOWN ON THE ARCHITECTURAL DRAWINGS, DESCRIBED HEREIN AND IN COMPLIANCE WITH PREVAILING | |
| SITE WHILE THE JOB IS IN PROGRESS AND UNTIL JOB COMPLETION. 11. THE CONTRACTOR SHALL TAKE ALL NECESSARY PRECAUTIONS TO ENSURE THE SAFETY OF THE OCCUPANTS AND WORKERS AT ALL TIMES. 12. THE CONTRACTOR IS SOLELY RESPONSIBLE FOR ALL CONSTRUCTION MEANS AND METHODS AND SHALL MAINTAIN THE STRUCTURAL INTEGRITY OF ANY CONSTRUCTION. 13. THE CONTRACTOR SHALL BE RESPONSIBLE FOR AND SHALL REPLACE OR REMEDY ANY FAULTY, IMPROPER, OR INFERIOR MATERIALS OR WORKMANSHIP WHICH SHALL APPEAR WITHIN ONE (1) YEAR AFTER THE COMPLETION AND ACCEPTANCE OF THE WORK UNDER THIS CONTRACT. | STRUCTURAL STONEWOOD STRUCTURAL ENGINEERS, INC 2001 NW 19TH SUITE 103A PORTLAND, OR 97209 TEL: 360.216.1704 FAX: N/A CONTACT: D. SCOTT NYSETH EMAIL: SCOTT.NYSETH@STONEWOODSTRUCTURAL.COM MEP INTERFACE | CODE. THE CONTRACTOR SHALL BE RESPONSIBLE FOR FINAL ORDERING OF ALL DEVICES AND FIXTURES TO ENSURE PROPER OPTIONS, ACCESSORIES AND CONFIGURATIONS. CONTRACTOR SHALL PROVIDE COMPLETE DESIGN AND DOCUMENTATION AS REQUIRED FOR SUBMISSION TO, AND APPROVAL OF ARCHITECT, OWNER, AND GOVERNING BUILDING DEPARTMENT. UPON COMPLETION OF REVIEW BY THE ARCHITECT OR ENGINEER OF RECORD, THE CONTRACTOR SHALL BE RESPONSIBLE FOR ROUTING DOCUMENTS TO PERMIT AGENCY FOR PLANS REVIEW AND PAYING ANY PLANS CHECK AND PERMIT FEES. | |
| CONTRACTOR TO PROVIDE BACKING OR BLOCKING AS REQUIRED FOR MOUNTING ALL WALL MOUNTED SHELVES, EQUIPMENT, ACCESSORIES, CABINETS, ETC. CONTRACTOR TO PROTECT ALL TREES AND ROOTS NOT SLATED FOR REMOVAL DURING CONSTRUCTION. GENERAL CONTRACTOR RESPONSIBLE FOR MAINTENANCE OF STAGING AREA AND TO ENSURE THAT MATERIALS DELIVERY AND STORAGE DOES NOT INTERFERE WITH DAILY OPERATION OF ADJACENT PROPERTIES OR PUBLIC RIGHT OF WAY. GENERAL CONTRACTOR RESPONSIBLE FOR CONSTRUCTION STAKING. | ENGINEER 100 SW MAIN STREET, SUITE 1600 PORTLAND, OR 97204 TEL: 503.382.2266 FAX: 503.382.2262 CONTACT: KIM W EMAIL: KIMW@INTERFACEENG.COM | SEPARATE PERMITS: 1. DEMOLITION PERMIT 2. SIGNAGE PERMIT DEFERRED SUBMITTALS: | |
| | | ELEVATOR FIRE SPRINKLER SYSTEM FIRE DETECTION AND ALARM SYSTEM FIRE DEPARTMENT ACCESS KEY BOX HANGERS AND SUPPORT FOR HVAC VIBRATION AND SEISMIC CONTROLS FOR HVAC LATERAL BRACING AND ANCHORAGE OF MECHANICAL AND ELECTRICAL EQUIPMENT WEIGHING MORE THAN 75 LBS (EXCEPTIONS PER ASCE 7, SECTION 13.1.4) PRE-ENGINEERED MANUFACTURED TRUSSES WOOD CHORD METAL WEB TRUSSES STAIR FRAMING CURTAINWALL SYSTEMS PHOTO VOLTAIC PANEL ATTACHMENT AND BALLAST SEE SPECIFICATIONS FOR ADDITIONAL REQUIREMENTS NOT LISTED HERE AND ADDTIONAL BIDDER DESIGN ITEMS. | |
| | | ALTERNATES IN ADDITION TO THE BASE BUILDING BID, THE CONTRACTOR SHALL PROVIDE THE FOLLOWING ALTERNATES: | |
| | | SEE ARCHITECTURAL DRAWINGS AND PROJECT MANUAL FOR ADDITIONAL SCOPE OF ALTERNATES. DEDUCTIVE ALTERNATES: 1. FIBER CEMENT SHINGLE "S-1" IN LIEU OF METAL PANEL UNDER WINDOWS 2. FLAT TPO ROOFING WITH PARAPET IN LIEU OF STANDING SEAM METAL ROOF AT COMMON STAIRS | |
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| | | | |
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| | | | |
| | | | |
| | VICINITY MAP | | |
| | PROJECT SITE NORT | | |



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CDP SALEM -BUILDING B

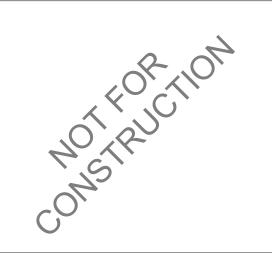21031

Job Number:

5205 BATTLE CREEK RD SE SALEM, OR 97306



LAND USE SUBMISSION ISSUE

Drawing:

GENERAL PROJECT INFORMATION


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| OCCUPANCY | | | | F EGRESS | | | | |
|--|---|--|--|--|---|--|--|--|
| | R-2 | | SECTION 1004 | SECTION 1004 OCCUPANT LOAD (OL) SEE OCCUPANT LOAD TABLE | | | | |
| CONSTRUCTION TYPE | V-B, SPRINKLERED PER NFPA 13-R | | SECTION 1005.3.1 SECTION 1005.3.2 | STAIRWAY EGRESS CAPACITY FACTOR OTHER EGRESS CAPACITY FACTOR | 0.3 | | | |
| _ | DETAILED REQUIREMENTS BASED | O ON OCCUPANCY AND USE | TABLE 1006.2.1 | MAX OCCUPANT LOAD FOR ONE EXIT | 0.2 20 OCCUPANTS | | | |
| OSSC REFERENCE SECTION 420.2 | SEPARATION WALLS WALLS S | SEPARATING DWELLING OR SLEEPING UNITS FROM EACH OTHER | TABLE 1000.2.1 | MAX COMMON PATH OF EGRESS TRAVEL | 125 FT | | | |
| | | ER OCCUPANCIES SHALL BE CONSTRUCTED AS FIRE PARTITIONS PROBLEM WITH SECTION 708. | TABLE 1006.3.2 | MAX OCCUPANT LOAD PER STORY | 500 | | | |
| SECTION 420.3 | EACH OT | ASSEMBLIES SEPARATING DWELLING OR SLEEPING UNITS FROM THER OR OTHER OCCUPANCIES SHALL BE CONSTRUCTED AS | | MIN NUMBER OF EXITS FOR STORY | 2 | | | |
| SECTION 420.4 | | NTAL ASSEMBLIES IN ACCORDANCE WITH SECTION 711. R OCCUPANCIES, REQUIRED PER 903.2.8 | TABLE 1006.3.3(1) | STORIES WITH ONE EXIT FOR R-2 | 4 UNITS / 125 FT TRAVEL DISTA EMERGENCY ESCAPE AND RE | SCUE OPENINGS PER 1030 | | |
| SECTION 420.5 | FIRE & SMOKE ALARMS GROUP F | R-2, FIRE ALARM SYSTEMS REQUIRED PER SECTION 907.2.9 ALARMS REQUIRED PER 907.2.10.2 | | | REQUIRED FOR STORIES WITH | 1 ONE EXIT | | |
| | SMOKE | ALARMS REQUIRED PER 907.2.10.2 | TABLE 1017.2 | EXIT ACCESS TRAVEL DISTANCE | 250 FT | | | |
| CHAPTER 5: GENERAL | BUILDING HEIGHTS AND AREAS | | TABLE 1020.1 | CORRIDOR FIRE-RESISTANCE RATING MINIMUM CORRIDOR WIDTH | 0.5 HR 44 INCHES * 36 INCHES WITHIN | NI DWELLING LINIT OR WHERE | | |
| TABLE 504.3 TABLE 504.4 | HEIGHT / STORIES / AREA FACTOR | R-2: 60 FT / 3 STORY / 7000 SF | SECTION 1020.4 | DEAD ENDS | OCCUPANT LOAD <50 20 FEET | N DWELLING ONLY OIL WHERE | | |
| TABLE 506.2 | | | 92011011 102011 | | *LENGTH IS NOT LIMITED WHE | RE LENGTH < 2.5x WIDTH | | |
| MODIFICATIONS | | | CHAPTER 11: ACCESSIE | RII ITV | | | | |
| SECTION 506.2.3 SINGLE-OCCUPANCY MULTIS | STORY BUILDINGS = [700 | [At + (NS x If)] x Sa 00 SF + (7000 SF x 0.75)] x 3 | | | | | | |
| EQUATION 5-2 | | 250 SF x 3 750 SF | SECTION 1106.2 | R-2 OCCUPANCIES WITH ACCESSIBLE, TYPE PROVIDED SHALL BE ACCESSIBLE | PE A OR TYPE B UNITS, AT LEAST 2 | % OF EACH TYPE OF PARKING | | |
| SECTION 506.3 | | [F/P - 0.25] x W/30 | | TOTAL SPACES PROVIDED: ACCESSIBLE SPACES REQUIRED | 163 : 163 x 2% = 4 | | | |
| | $ \Pi = 0. $ | [414/414 - 0.25] x 30/30 .75 | | ACCESSIBLE SPACES PROVIDED: VAN ACCESSIBLE SPACES REQU | 6 RED: 1 PER 6 ACCESSIBLE SPACES DED: 1 | | | |
| | ACTUAL HEIGHT / STORIES 37' - | - 2" / 3 Story | | VAN ACCESSIBLE SPACES PROVI WHEELCHAIR ONLY SPACES REG | | | | |
| | FLOOR LEVEL | G AREA AREA (SF) | SECTION 1107.6.2.2.1 | WHEELCHAIR ONLY SPACES PRO | | | | |
| | FIRST FLOOR THIRD FLOOR | FIRST FLOOR 7405 SF | | R-2 OCCUPANCIES WITH GREATER THAN 20 DWELLING UNITS SHALL PROVIDE MINIMUM 2% TYPE A UNITS. AL R-2 UNITS ON A SITE SHALL BE CONSIDERED TO DETERMINE TOTAL NUMBER OF UNITS AND REQUIRED NUMBER OF TYPE A UNITS | | | | |
| | SECOND FLOOR | 7667 SF 22738 SF | | TYPE A UNITS REQUIRED (TOTAL | • | | | |
| | | | | TYPE A UNITS PROVIDED (TOTAL TYPE A UNITS PROVIDED (THIS B | • | | | |
| SECTION 508.2 | ACCESSORY OCCUPANCY N/A | | SECTION 1107.6.2.2.2 | WHERE THERE ARE FOUR OR MORE DWE | LLING UNITS, ALL UNITS SHALL BE | TYPE B UNITS AT A MINIMUM | | |
| SECTION 508.3 / 508.4 | MIXED OCCUPANCY N/A | | EXCEPTION: | THE NUMBER OF TYPE A AND TYPE B UNIT SECTION 1107.7 | TS IS PERMITTED TO BE REDUCED | IN ACCORDANCE WITH | | |
| TABLE 509 | | RINKLERED, NO SEPARATION REQUIRED RINKLERED, NO SEPARATION REQUIRED | | | | | | |
| | | | ADDITIONAL ACCESSION | U ITV DEGUIDEMENTO | | | | |
| CHAPTER 6: TYPES OF | CONSTRUCTION / CONSTRUCTION | ON CLASSIFICATION | ADDITIONAL ACCESSIBI | ILITY REQUIREMENTS | | | | |
| TABLE 601 | FIRE RESISTANCE RATING REQUIRME | | | CC A117.1 - 2009 | | | | |
| | BUILDING E PRIMARY STRUCTURAL FRAME | FIRE RATING * 0 HOUR | SECTIO | | LE II | | | |
| | BEARING WALLS EXTERIOR 0 HOUR | | FI | FAIR HOUSING ACCESSIBILITY GUIDELINES FHA SAFE HARBOR DESIGN DOCUMENT: IBC 2018 | | | | |
| | INTERIOR 0 HOUR NON BEARING WALLS AND PARTITIONS - EXTERIOR PER TABLE 602 NON BEARING WALLS AND PARTITIONS - INTERIOR 0 HOUR | | ACCESSIBLE UNITS | CORE DEVELOPMENT MANUAL | | | | |
| | FLOOR CONSTRUCTION AND SECONE ROOF CONSTRUCTION AND SECONE | NDARY MEMBERS 0 HOUR | 5% OF U | | 184 x 5% = 0 UNITS 184 x 2% = 0 UNITS | | | |
| | * UNLESS OTHERWISE REQUIRED BY | Y THIS CODE | CHAPTER 13: ENERGY I | EFFICIENCY 2021 OREGON ENERG | GY EFFICIENCY SPECIALTY | Y CODE (OFESC) | | |
| TABLE 602 | FIRE RESISTANCE RATING REQUIRME | NTS FOR EXTERIOR WALLS BASED ON FIRE SEPARATION DISTANCE | 0 | ETTIGIETO 2021 OREGOTI ETTER | | | | |
| | FIRE SEPARATION | | OPAQUE ELEMENTS | REQUIR | RED MIN. R-VALUE | PROVIDED | | |
| | X < 5' 5' <= X < 10' | 1 HOUR | | | | | | |
| | | 1 HOUR | ROOFS INSULATION ENTIRELY AR | ASSEMBLY MAX. | | | | |
| | 10' <= X < 30' X >= 30' | 1 HOUR 0 HOUR 0 HOUR | ROOFS INSULATION ENTIRELY ABOUT DECK METAL BUILDINGS | | N/A N/A | | | |
| | 10' <= X < 30' X >= 30' | 0 HOUR 0 HOUR | INSULATION ENTIRELY ABOUT TO THE PROPERTY OF T | BOVE N/A | N/A | R-49 | | |
| CHAPTER 7: FIRE AND | 10' <= X < 30' | 0 HOUR 0 HOUR | INSULATION ENTIRELY ABOUT TO THE PROPERTY OF T | N/A N/A U-0.021 U-0.090 N/A | N/A N/A R-49 R-11.4 CI N/A | R-49 | | |
| CHAPTER 7: FIRE AND | 10' <= X < 30' X >= 30' | 0 HOUR 0 HOUR | INSULATION ENTIRELY ABOUT DECK METAL BUILDINGS ATTIC AND OTHER WALLS (ABOVE GRADE) MASS METAL BUILDINGS STEEL-FRAMED WOOD-FRAMED / OTHER | N/A N/A U-0.021 U-0.090 N/A N/A N/A U-0.064 | N/A N/A R-49 R-11.4 CI N/A N/A N/A R-13 + 3.8 CI OR R-20 | R-49 | | |
| | 10' <= X < 30' X >= 30' SMOKE PROTECTION FEATURES MINIMUM DISTANCE OF PROJECTION MAXIMUM AREA OF WALL OPENINGS E | 0 HOUR 0 HOUR 40 INCHES BASED ON FSD AND OPENING PROTECTION UNPROTECTED, NON-SPRINKLERED PROTECTED | INSULATION ENTIRELY ABOUT DECK METAL BUILDINGS ATTIC AND OTHER WALLS (ABOVE GRADE) MASS METAL BUILDINGS STEEL-FRAMED WOOD-FRAMED / OTHER WALLS (BELOW GRADE) FLOORS | N/A N/A U-0.021 U-0.090 N/A N/A N/A U-0.064 C-0.092 | N/A N/A R-49 R-11.4 CI N/A N/A N/A R-13 + 3.8 CI OR R-20 R-10 CI | | | |
| TABLE 705.2 | 10' <= X < 30' X >= 30' SMOKE PROTECTION FEATURES MINIMUM DISTANCE OF PROJECTION MAXIMUM AREA OF WALL OPENINGS E 0 TO LESS THAN 3' 3 TO LESS THAN 5' | 0 HOUR 0 HOUR 40 INCHES BASED ON FSD AND OPENING PROTECTION UNPROTECTED, NON-SPRINKLERED PROTECTED NOT PERMITTED NOT PERMITT NOT PERMITTED 15% | INSULATION ENTIRELY ABOUT DECK METAL BUILDINGS ATTIC AND OTHER WALLS (ABOVE GRADE) MASS METAL BUILDINGS STEEL-FRAMED WOOD-FRAMED / OTHER WALLS (BELOW GRADE) FLOORS MASS STEEL JOIST | N/A N/A U-0.021 U-0.090 N/A N/A U-0.064 C-0.092 N/A N/A N/A | N/A N/A R-49 R-11.4 CI N/A N/A N/A R-13 + 3.8 CI OR R-20 R-10 CI N/A N/A | R-23 | | |
| TABLE 705.2 | 10' <= X < 30' X >= 30' SMOKE PROTECTION FEATURES MINIMUM DISTANCE OF PROJECTION MAXIMUM AREA OF WALL OPENINGS E 0 TO LESS THAN 3' 3 TO LESS THAN 5' 5 TO LESS THAN 10' 10 TO LESS THAN 15' | 40 INCHES BASED ON FSD AND OPENING PROTECTION UNPROTECTED, NON-SPRINKLERED NOT PERMITTED NOT PERMITTED 15% 10% 25% 15% | INSULATION ENTIRELY ABOUT DECK METAL BUILDINGS ATTIC AND OTHER WALLS (ABOVE GRADE) MASS METAL BUILDINGS STEEL-FRAMED WOOD-FRAMED / OTHER WALLS (BELOW GRADE) FLOORS MASS | N/A N/A U-0.021 U-0.090 N/A N/A U-0.064 C-0.092 | N/A N/A R-49 R-11.4 CI N/A N/A N/A R-13 + 3.8 CI OR R-20 R-10 CI N/A | | | |
| TABLE 705.2 | 10' <= X < 30' X >= 30' SMOKE PROTECTION FEATURES MINIMUM DISTANCE OF PROJECTION MAXIMUM AREA OF WALL OPENINGS E 0 TO LESS THAN 3' 3 TO LESS THAN 5' 5 TO LESS THAN 10' 10 TO LESS THAN 15' 15 TO LESS THAN 20' 20 TO LESS THAN 25' | 40 INCHES BASED ON FSD AND OPENING PROTECTION UNPROTECTED, NON-SPRINKLERED NOT PERMITTED NOT PERMITTED 15% 10% 25% 15% 45% 45% NO LIMIT | INSULATION ENTIRELY ABOUT DECK METAL BUILDINGS ATTIC AND OTHER WALLS (ABOVE GRADE) MASS METAL BUILDINGS STEEL-FRAMED WOOD-FRAMED / OTHER WALLS (BELOW GRADE) FLOORS MASS STEEL JOIST WOOD FRAMED / OTHER SLAB-ON-GRADE FLOORS | N/A N/A U-0.021 U-0.090 N/A N/A U-0.064 C-0.092 N/A N/A N/A U-0.033 | N/A N/A R-49 R-11.4 CI N/A N/A R-13 + 3.8 CI OR R-20 R-10 CI N/A N/A N/A R-30 | R-23 | | |
| TABLE 705.2 | 10' <= X < 30' X >= 30' SMOKE PROTECTION FEATURES MINIMUM DISTANCE OF PROJECTION MAXIMUM AREA OF WALL OPENINGS E 0 TO LESS THAN 3' 3 TO LESS THAN 5' 5 TO LESS THAN 10' 10 TO LESS THAN 15' 15 TO LESS THAN 20' | 40 INCHES BASED ON FSD AND OPENING PROTECTION UNPROTECTED, NON-SPRINKLERED NOT PERMITTED NOT PERMITTED 15% 10% 25% 15% 45% 25% | INSULATION ENTIRELY ABOUT DECK METAL BUILDINGS ATTIC AND OTHER WALLS (ABOVE GRADE) MASS METAL BUILDINGS STEEL-FRAMED WOOD-FRAMED / OTHER WALLS (BELOW GRADE) FLOORS MASS STEEL JOIST WOOD FRAMED / OTHER SLAB-ON-GRADE FLOORS HEATED UNHEATED | N/A N/A U-0.021 U-0.090 N/A N/A U-0.064 C-0.092 N/A N/A N/A U-0.033 | N/A N/A R-49 R-11.4 CI N/A N/A N/A R-13 + 3.8 CI OR R-20 R-10 CI N/A N/A N/A R-30 | R-23 | | |
| TABLE 705.2 | 10' <= X < 30' X >= 30' SMOKE PROTECTION FEATURES MINIMUM DISTANCE OF PROJECTION MAXIMUM AREA OF WALL OPENINGS E 0 TO LESS THAN 3' 3 TO LESS THAN 5' 5 TO LESS THAN 10' 10 TO LESS THAN 15' 15 TO LESS THAN 20' 20 TO LESS THAN 25' 25 TO LESS THAN 30' | 0 HOUR 0 HOUR 0 HOUR 40 INCHES BASED ON FSD AND OPENING PROTECTION UNPROTECTED, NON-SPRINKLERED PROTECTED NOT PERMITTED NOT PERMITT NOT PERMITTED 15% 10% 25% 15% 45% 25% 75% 45% 25% NO LIMIT 70% NO LIMIT NO LIMIT NO LIMIT NO LIMIT NO LIMIT EXCEPTION 2: BUILDINGS WHOSE EXTERIOR BEARING WALLS, EXTERIOR NONBEARING WALLS AND EXTERIOR PRIMARY | INSULATION ENTIRELY AB DECK METAL BUILDINGS ATTIC AND OTHER WALLS (ABOVE GRADE) MASS METAL BUILDINGS STEEL-FRAMED WOOD-FRAMED / OTHER WALLS (BELOW GRADE) FLOORS MASS STEEL JOIST WOOD FRAMED / OTHER SLAB-ON-GRADE FLOORS HEATED UNHEATED OPAQUE DOORS SWINGING NON-SWINGING | N/A N/A U-0.021 U-0.090 N/A N/A U-0.064 C-0.092 N/A N/A U-0.033 N/A F-0.520 U-0.370 N/A REQUIRED | N/A N/A R-49 R-11.4 CI N/A N/A R-13 + 3.8 CI OR R-20 R-10 CI N/A N/A N/A R-30 N/A R-15 FOR 24" | R-23 R-30 R-15 FOR 24" U-0.370 PROVIDED | | |
| TABLE 705.2 TABLE 705.8 | 10' <= X < 30' X >= 30' SMOKE PROTECTION FEATURES MINIMUM DISTANCE OF PROJECTION MAXIMUM AREA OF WALL OPENINGS E 0 TO LESS THAN 3' 3 TO LESS THAN 5' 5 TO LESS THAN 10' 10 TO LESS THAN 15' 15 TO LESS THAN 20' 20 TO LESS THAN 25' 25 TO LESS THAN 30' 30' OR GREATER | 0 HOUR 0 HOUR 40 INCHES BASED ON FSD AND OPENING PROTECTION UNPROTECTED, NON-SPRINKLERED PROTECTED NOT PERMITTED NOT PERMITT NOT PERMITTED 15% 10% 25% 15% 45% 25% 75% 45% 25% 75% 45% NO LIMIT 70% NO LIMIT NO LIMIT NO LIMIT NO LIMIT EXCEPTION 2: BUILDINGS WHOSE EXTERIOR BEARING WALLS, | INSULATION ENTIRELY ABODECK METAL BUILDINGS ATTIC AND OTHER WALLS (ABOVE GRADE) MASS METAL BUILDINGS STEEL-FRAMED WOOD-FRAMED / OTHER WALLS (BELOW GRADE) FLOORS MASS STEEL JOIST WOOD FRAMED / OTHER SLAB-ON-GRADE FLOORS HEATED UNHEATED OPAQUE DOORS SWINGING NON-SWINGING FENESTRATION NCE ED VERTICAL (0% - 40% OF WALLE) | N/A N/A U-0.021 U-0.090 N/A N/A U-0.064 C-0.092 N/A N/A U-0.033 N/A F-0.520 U-0.370 N/A N/A REQUIRED MAX U MAX SHGC | N/A N/A R-49 R-11.4 CI N/A N/A R-13 + 3.8 CI OR R-20 R-10 CI N/A N/A N/A R-30 N/A R-15 FOR 24" | R-23 R-30 R-15 FOR 24" U-0.370 PROVIDED | | |
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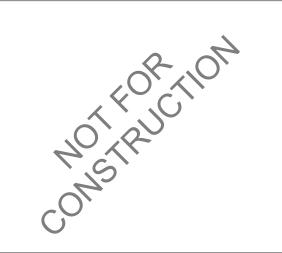
SITE PLAN - ZONING DIAGRAM



702.020 MULTIPLE FAMILY DESIGN REVIEW STANDARDS

| SECTION | REQUIRMENT MET OR ADJUSTMENT REQUESTED | SHEET NUMBER | | | |
|--------------------------|---|--------------------|--|--|--|
| SITE SAFETY & SECURITY | | | | | |
| 702.020.c.1 | REQUIREMENT MET | A2.11-A2.12 | | | |
| 702.020.c.2 | REQUIREMENT MET | A3.01-A3.02 | | | |
| FACADE & BUILDING DESIGN | | | | | |
| 702.020.e.1 | REQUIREMENT MET | A2.11-A2.12 | | | |
| 702.020.e.8 | ADJUSTMENT REQUESTED | A3.01-A3.02 | | | |
| 702.020.e.9 | REQUIREMENT MET | A2.11-A2.12, A3.01 | | | |
| 702.020.e.10 | REQUIREMENT MET | A3.01-A3.02 | | | |



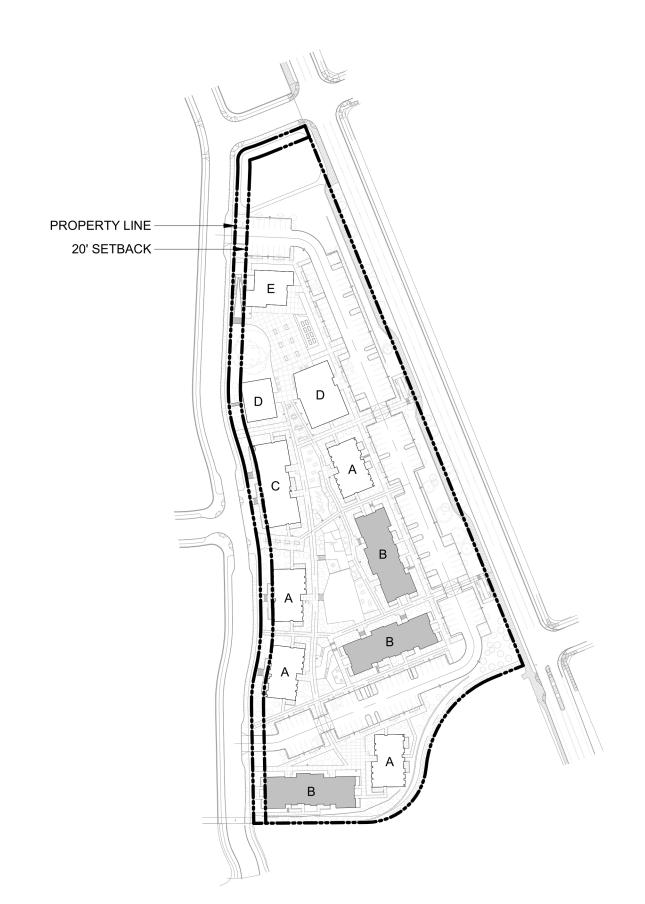

CDP SALEM -**BUILDING B** Job Number:

5205 BATTLE CREEK RD SE SALEM, OR 97306



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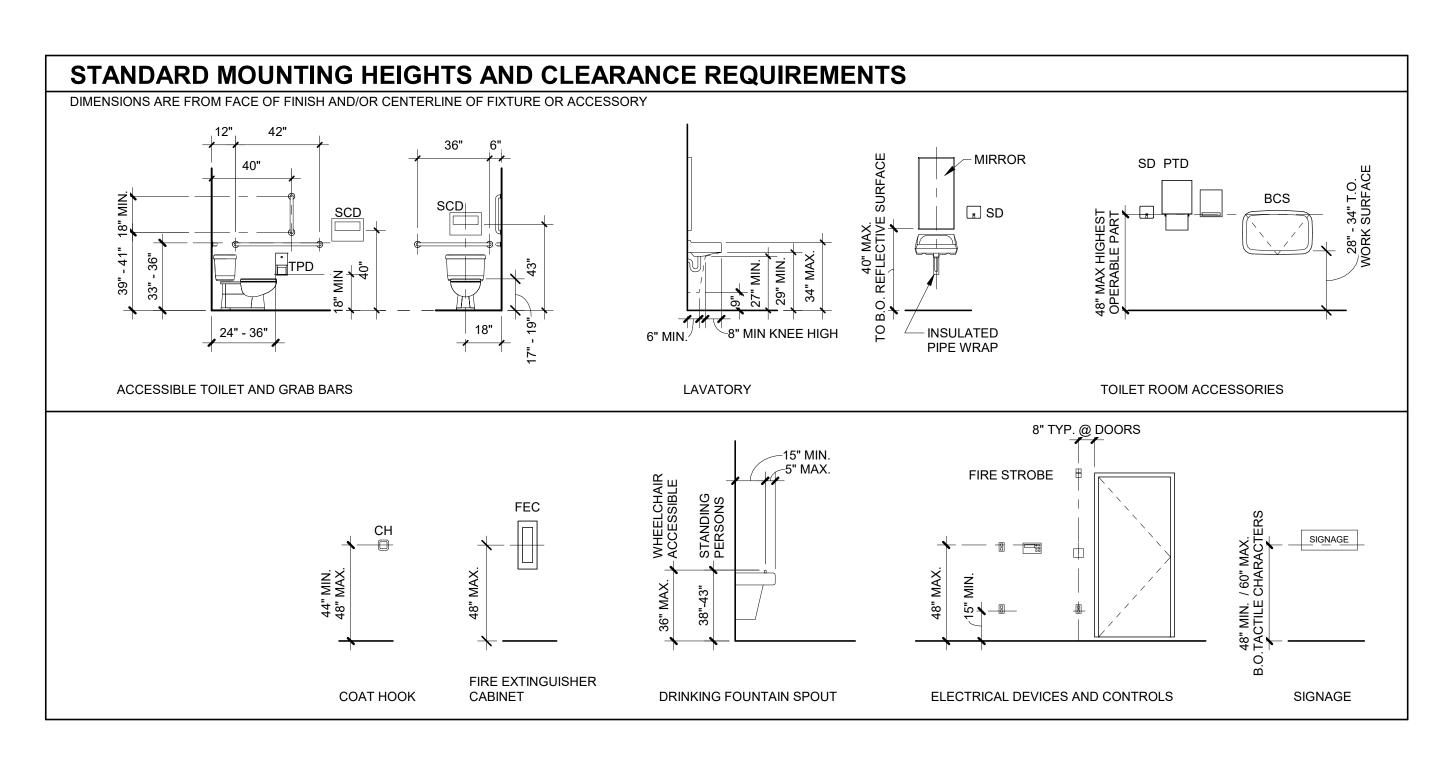
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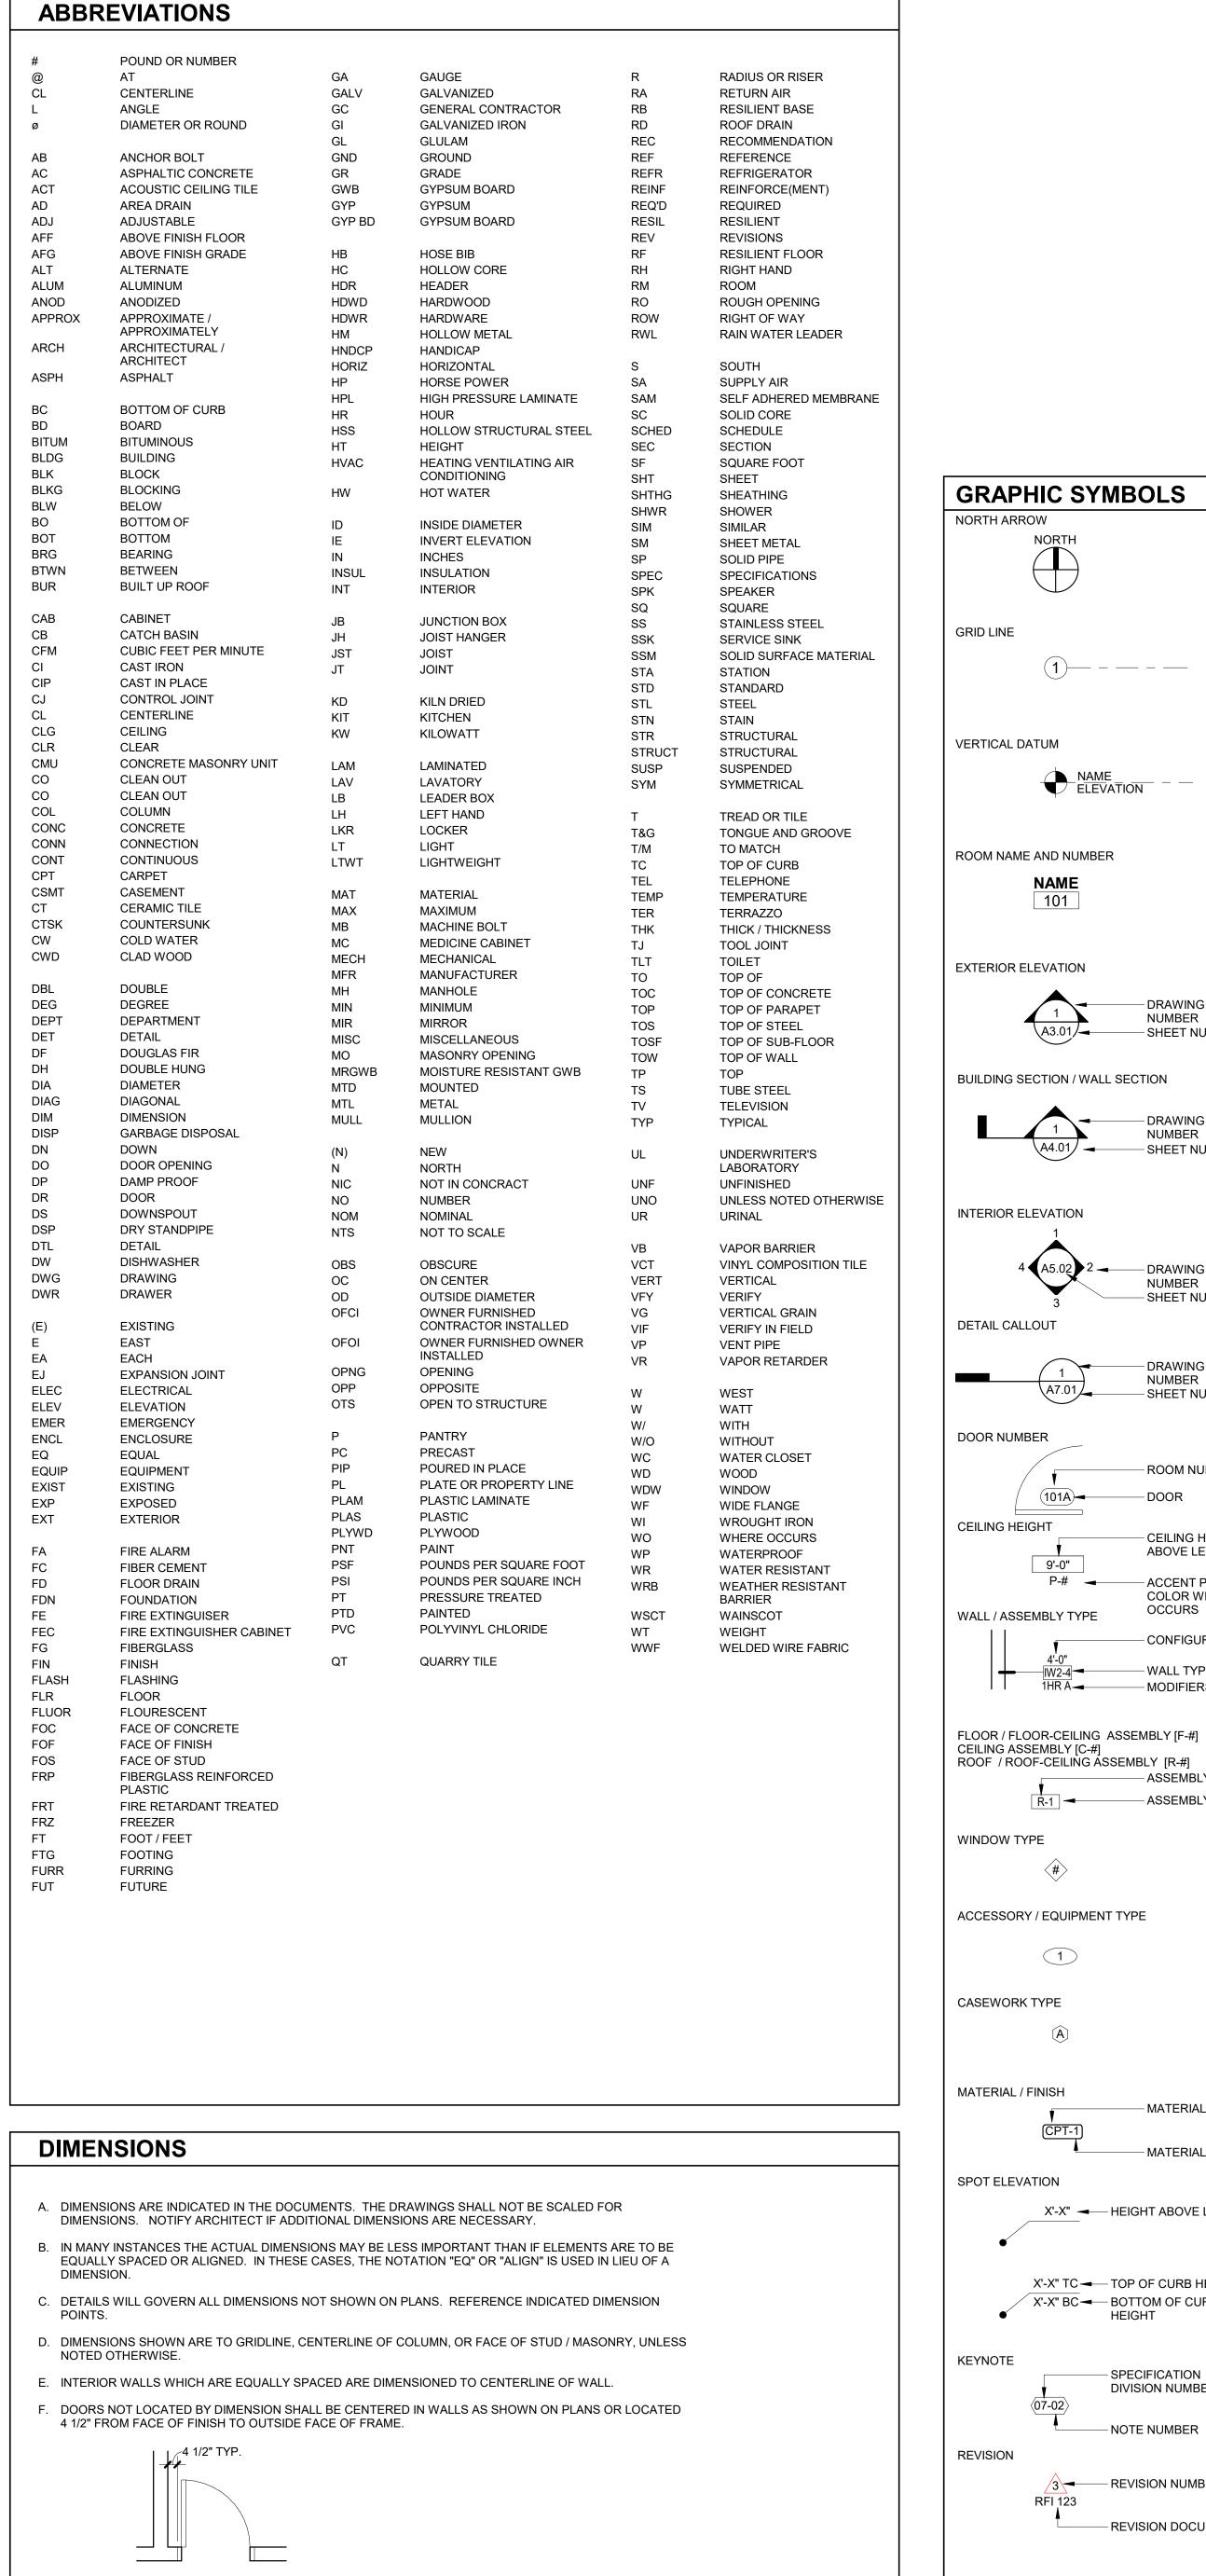
CODE SUMMARY

01.11.2021

DATE

Sheet No:
Building B -







CDP SALEM -**BUILDING B**

Job Number: **5205 BATTLE CREEK RD SE**

SALEM, OR 97306

NORTH

NAME

101

(1)— - — - —

NAME_ ELEVATION - -

- DRAWING

NUMBER

- DRAWING

NUMBER

→ DRAWING

NUMBER

- DRAWING

NUMBER

- SHEET NUMBER

- ROOM NUMBER

- CEILING HEIGHT

ABOVE LEVEL

- ACCENT PAINT

OCCURS

— WALL TYPE

- MODIFIERS

COLOR WHERE

- CONFIGURATION

- ASSEMBLY CATEGORY

— ASSEMBLY NUMBER

— DOOR

(101A)--

— SHEET NUMBER

— SHEET NUMBER

- SHEET NUMBER

Development **Partners**

1 CASEWORK TYPE MATERIAL / FINISH - MATERIAL TYPE - MATERIAL NUMBER X'-X" ── HEIGHT ABOVE LEVEL X'-X" TC ─ TOP OF CURB HEIGHT X'-X" BC
 BOTTOM OF CURB - SPECIFICATION DIVISION NUMBER NOTE NUMBER REVISION NUMBER - REVISION DOCUMENT

Sheet No: Building B -

ARCHITECTURAL

GENERAL NOTES

AND DIAGRAMS

01.11.2021

DATE


LAND USE


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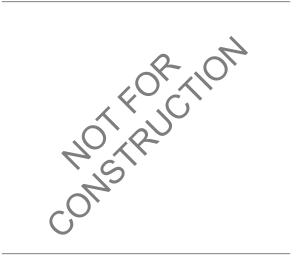
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ESE DRAWINGS ARE THE ORIGINAL THE ARCHITECT AND MAY NOT BE THOUT THE WRITTEN CONSENT OF





SCOTT EDWARDS ARCHITECTURE LLP. 2525 E Burnside Street, Portland, OR 97214 phone: (503) 226-3617 www.seallp.com

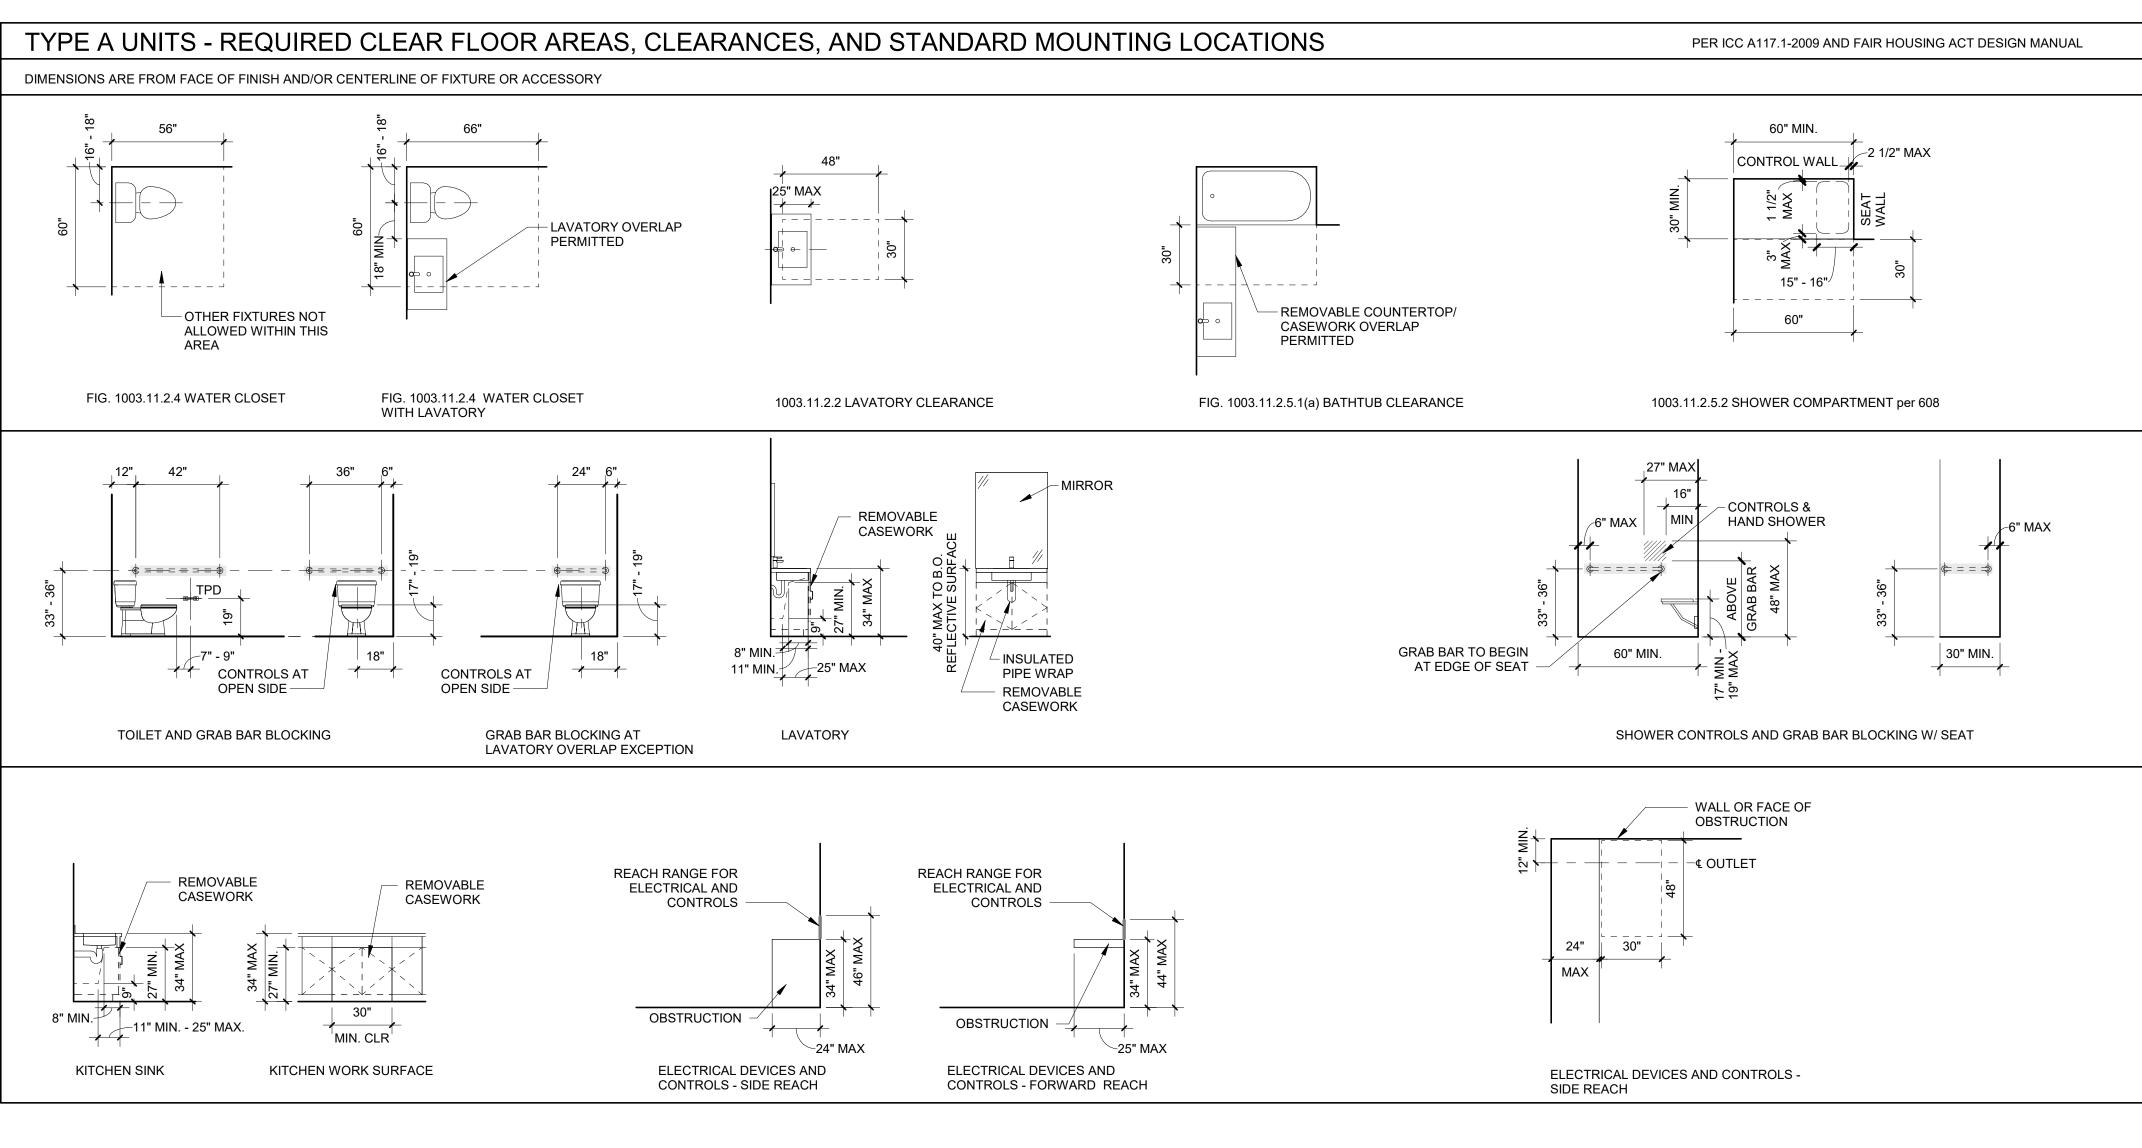


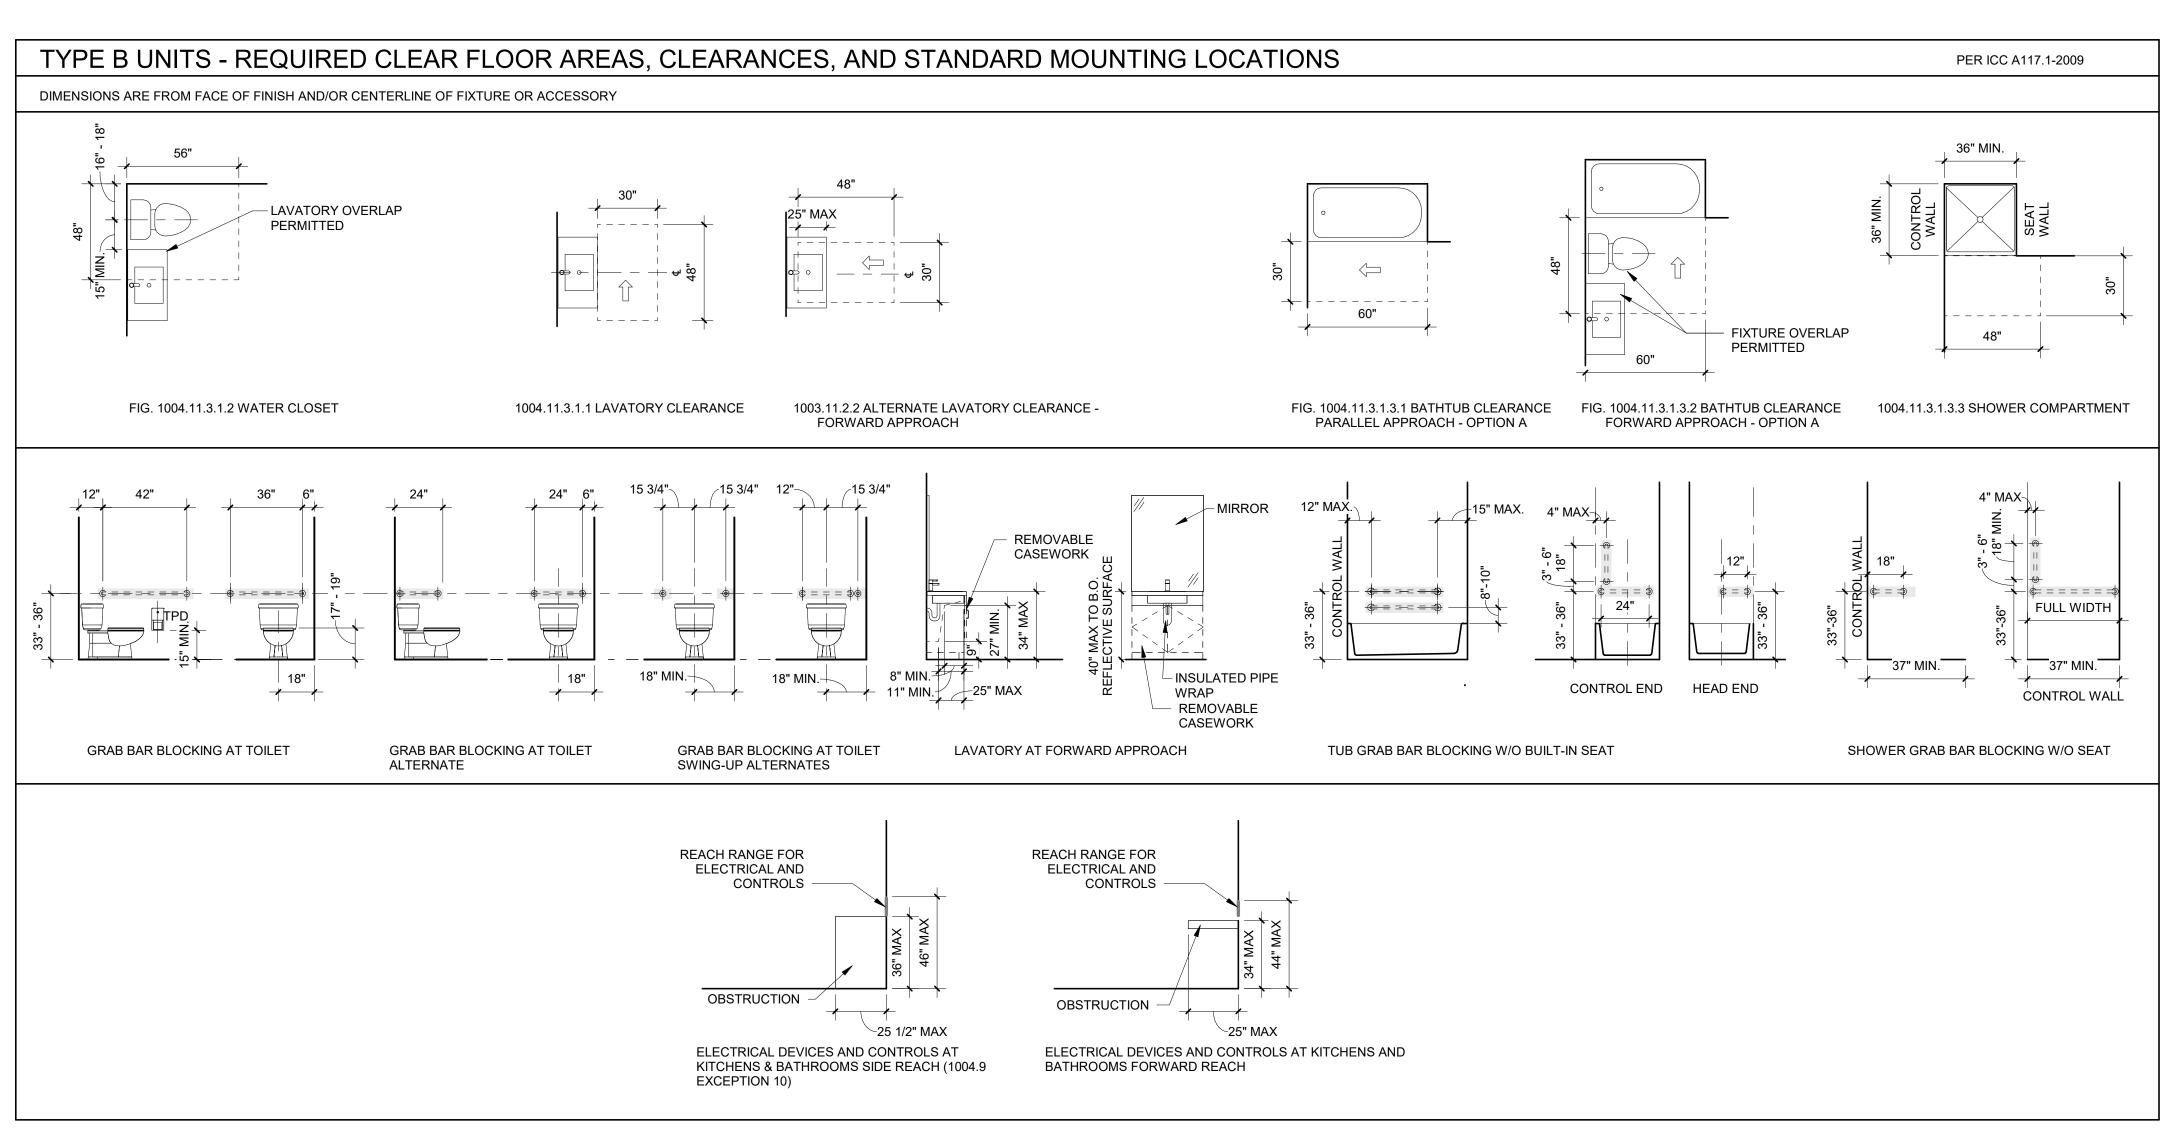CDP SALEM -BUILDING B 21031 Job Number: **5205 BATTLE CREEK RD SE SALEM, OR 97306**



LAND USE SUBMISSION 01.11.2021 ISSUE DATE Drawing: **ACCESSIBILITY DIAGRAMS** -**RESIDENTIAL**

Sheet No: Building B -

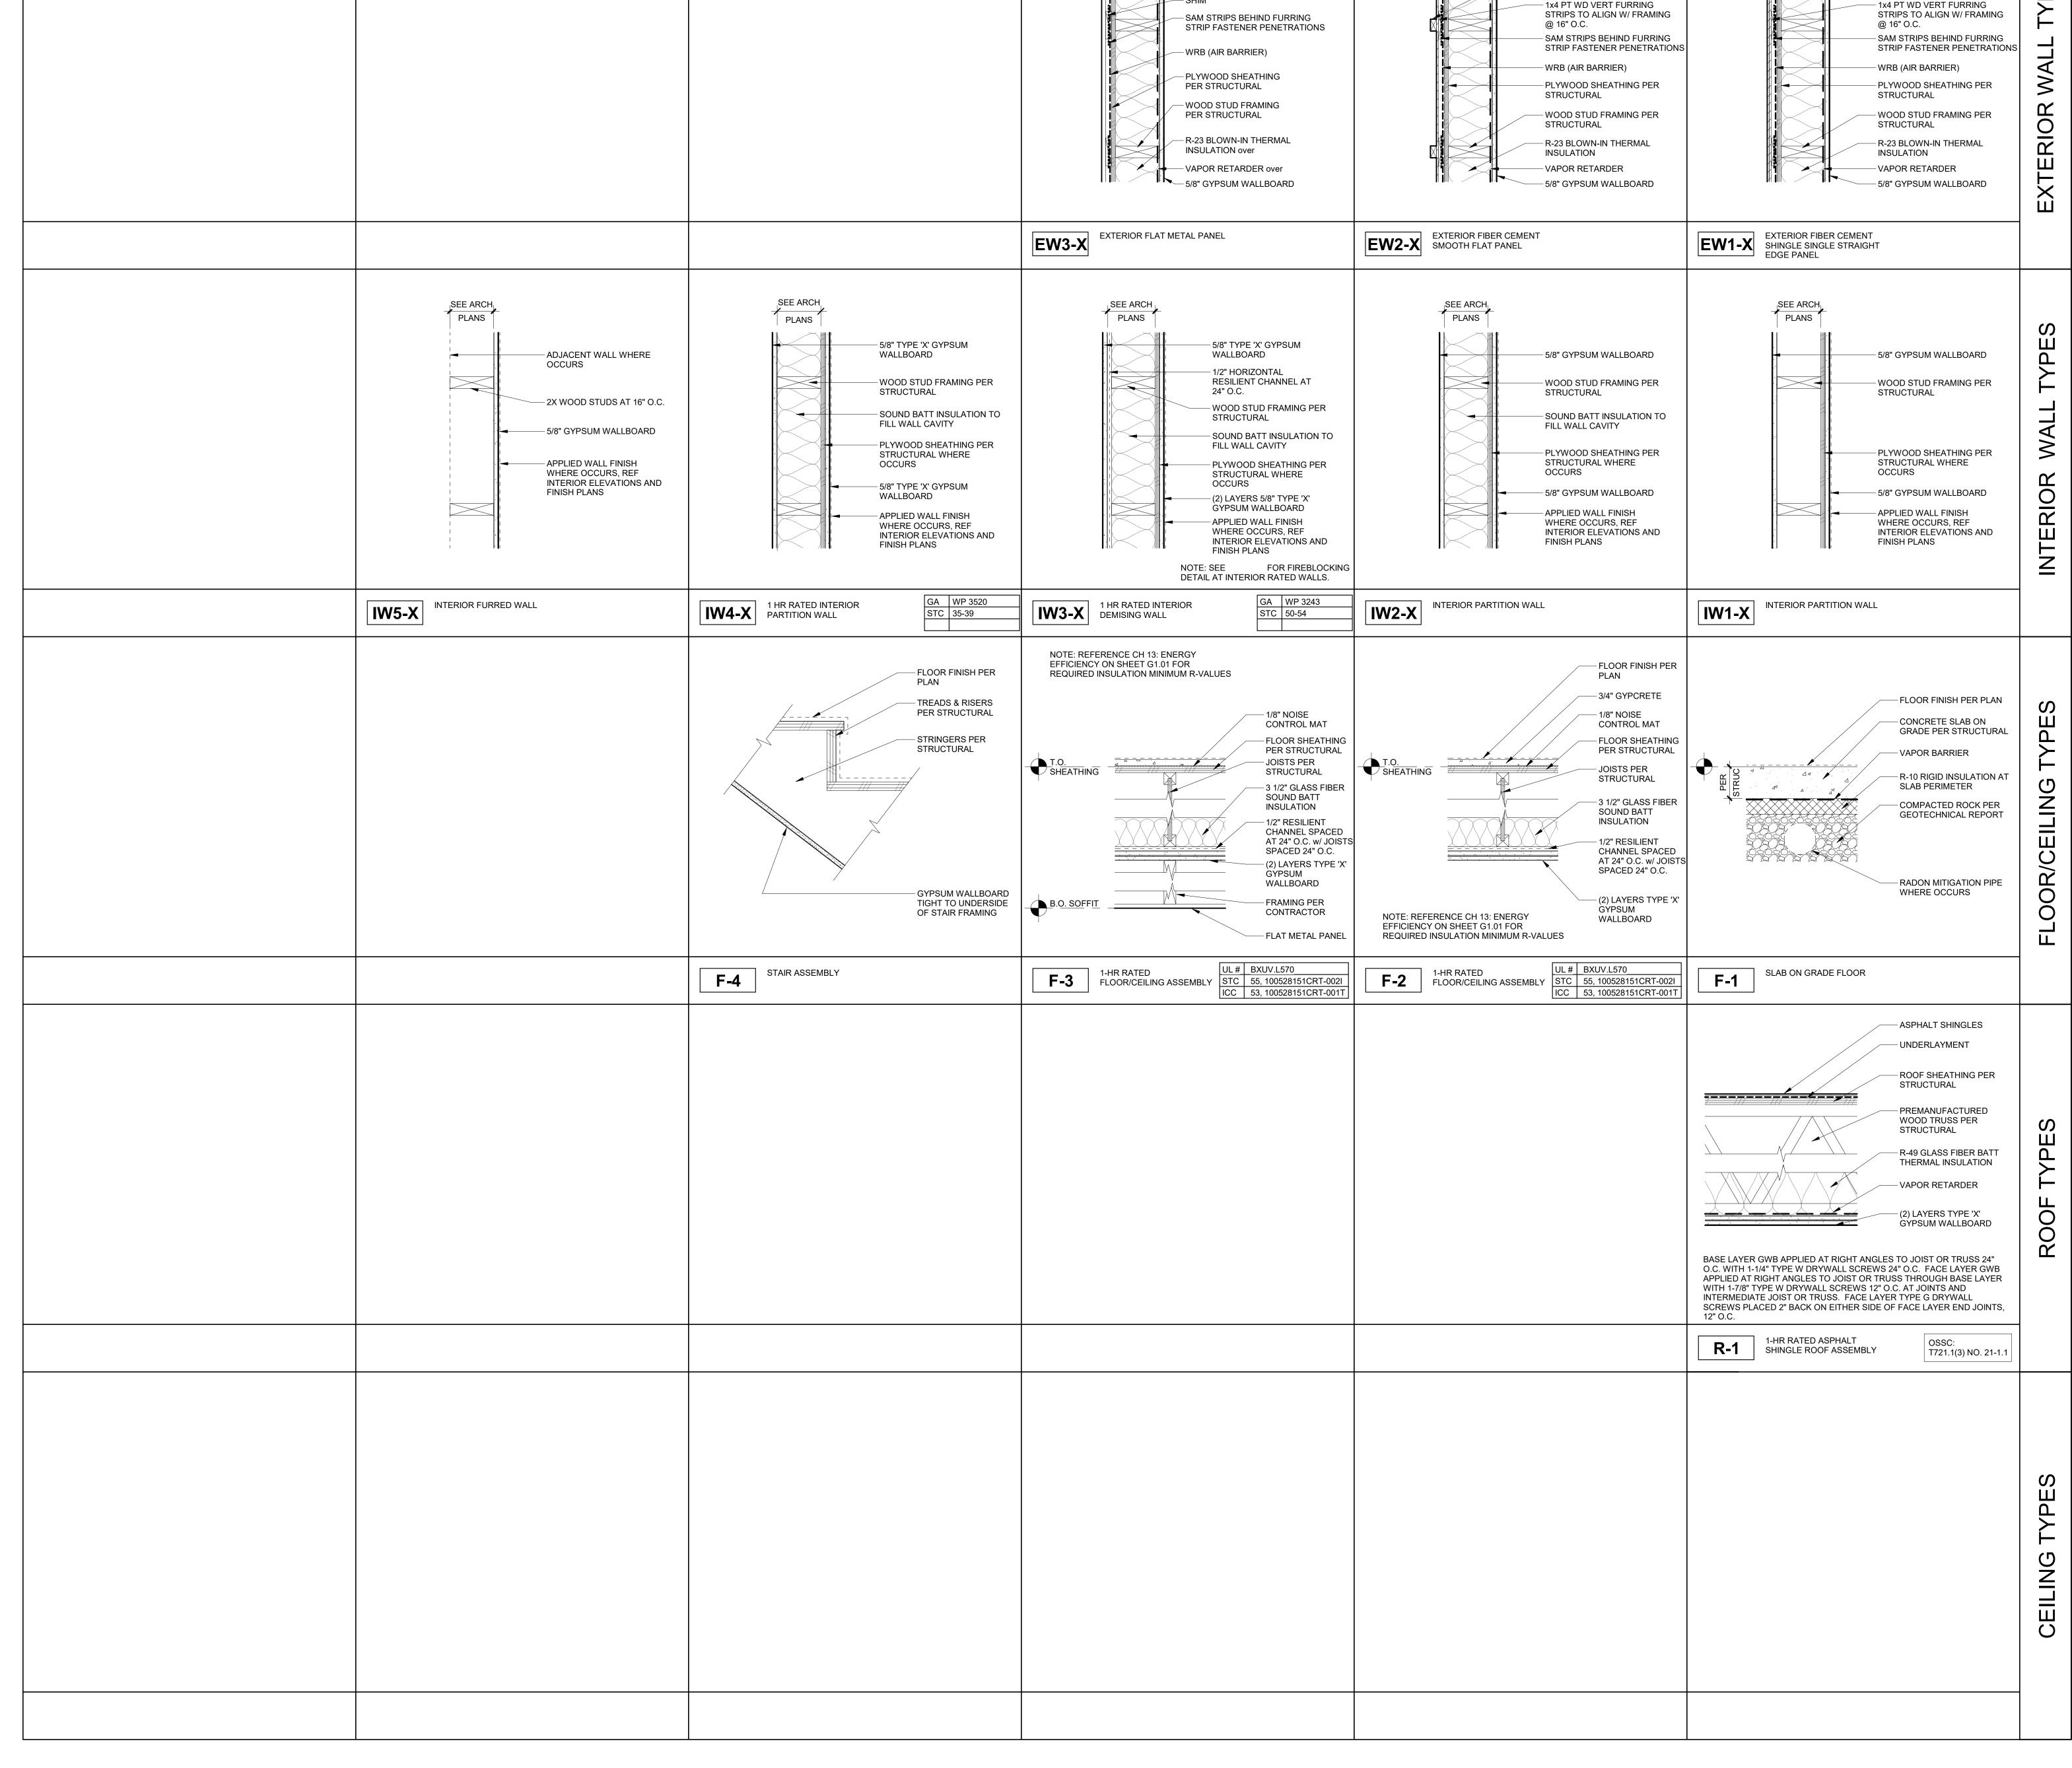

PER ARCH

PLANS

— FLAT METAL PANEL

– 1/2" METAL Z-FURRING

PLANS

- FIBER CEMENT SMOOTH FLAT

FRAMING

PANEL & BATTEN CENTERED ON

GENERAL SHEET NOTES

PER ARCH

PLANS

FIBER CEMENT SHINGLE

STRAIGHT EDGE PANEL

- A. REFERENCE DETAILS FOR ASSEMBLIES NOT SHOWN HERE.
 B. SEE FINISH SCHEDULE, INTERIOR ELEVATIONS,
- SEE FINISH SCHEDULE, INTERIOR ELEVATIONS,
 AND DETAILS FOR SPECIAL CONDITIONS AND
 APPLIED WALL FINISHES.
 MAINTAIN FIRE RATING OF WALLS AROUND FIRE
- C. MAINTAIN FIRE RATING OF WALLS AROUND FIRE EXTINGUISHERS, CABINETS, AND OTHER RECESSED ITEMS.

 D. PROVIDE ACOUSTICAL SEALANT AT FLOOR / CEILING/ WALL TRANSITIONS, RECESSED BOXES,
- AND PENETRATIONS OF SOUND RATED
 ASSEMBLIES AND OTHER CONSTRUCTION AS
 REQUIRED TO ACHIEVE NOTED STC RATINGS.
 PROVIDE MOISTURE RESISTANT GYPSUM BOARD
 TYPICAL AT ALL RESTROOMS, BATHROOMS, AND
- KITCHEN WALLS.

 ALL FRAMING AND FINISHES OF INTERIOR WALLS TO EXTEND TO THE UNDERSIDE OF STRUCTURE ABOVE UNLESS NOTED OTHERWISE.

 WHERE PARTITIONS ARE SOUND RATED OR FIRE

RATED AND INCLUDE PROPRIETARY


DETAILS SEE X/XX.


MANUFACTURERS, NO SUBSTITUTIONS ARE ALLOWED.

H. ALL WOOD IN CONTACT WITH CONCRETE OR MASONRY TO BE PRESSURE TREATED.

I. PROVIDE DEFLECTION HEADS OR CLIPS AT ALL NON-LOAD BEARING CONDITIONS.


J. FOR TYPICAL LIGHT GAUGE METAL FRAMING

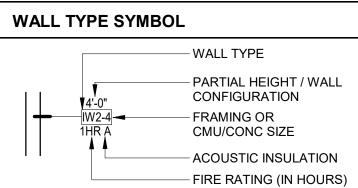

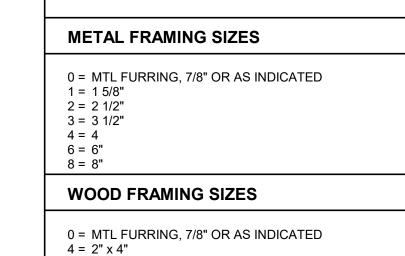

6 = 2" x 6"

8 = 2" x 8"

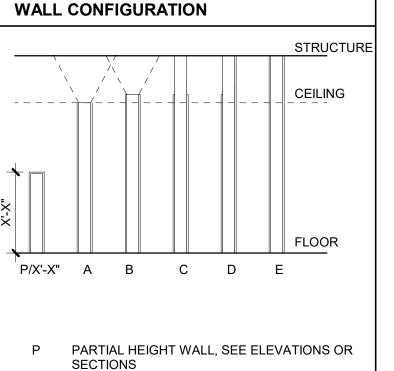

X'-X" HEIGHT AS INDICATED TO TOP OF FINISH

A FRAMING AND FINISHES TERMINATE AT

REQUIRED.

UNDERSIDE OF CEILING. BRACE AS

FRAMING AND FINISHES TERMINATE 4" ABOVE

FINISHED CEILING. BRACE AS REQUIRED.

STRUCTURE. FINISHES TERMINATE AT 4"

FRAMING AND FINISH ONE SIDE OF WALL EXTEND TO BOTTOM OF STRUCTURE. FINISH OTHER SIDE TERMINATES AT 4" ABOVE

FRAMING AND FINISHES BOTH SIDE EXTEND TO UNDERSIDE OF STRUCTURE ABOVE.

FRAMING EXTENDS TO BOTTOM OF

ABOVE FINISHED CEILING.

FINISHED CEILING.

SEA


SCOTT EDWARDS ARCHITECTURE LLP.

2525 E Burnside Street, Portland, OR 97214
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CDP SALEM -BUILDING B

Job Number: 210
5205 BATTLE CREEK RD SE
SALEM, OR 97306



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Drawing:

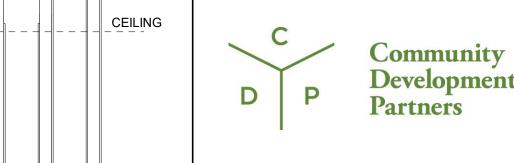ASSEMBLIES


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DATE


ASSEMBLIES

Sheet No: Building B -

A0-20

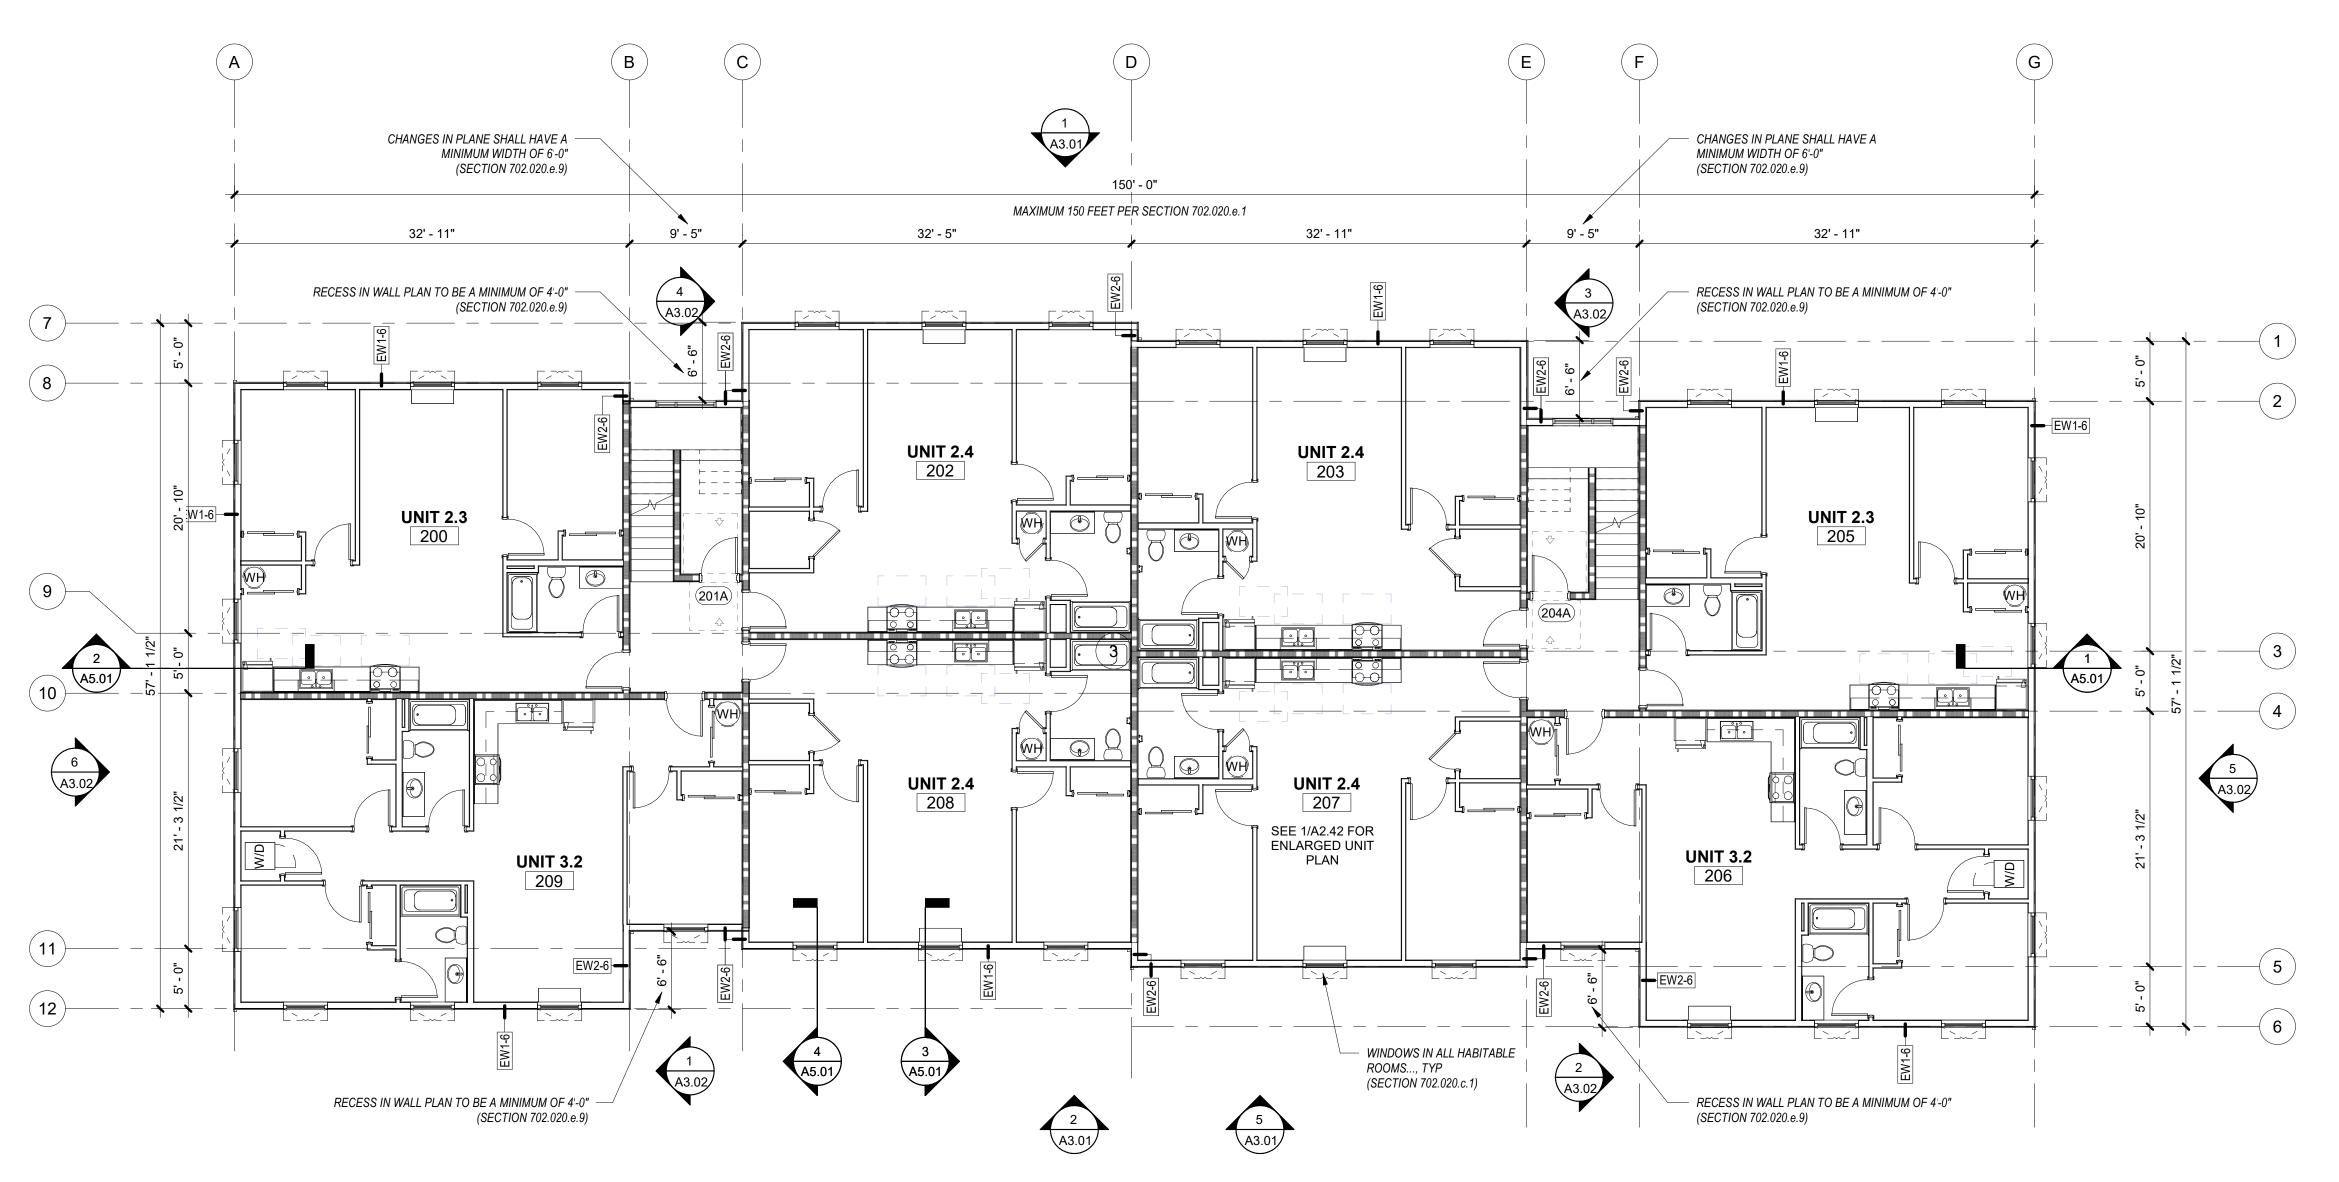

2 SECOND FLOOR PLAN
1/8" = 1'-0"

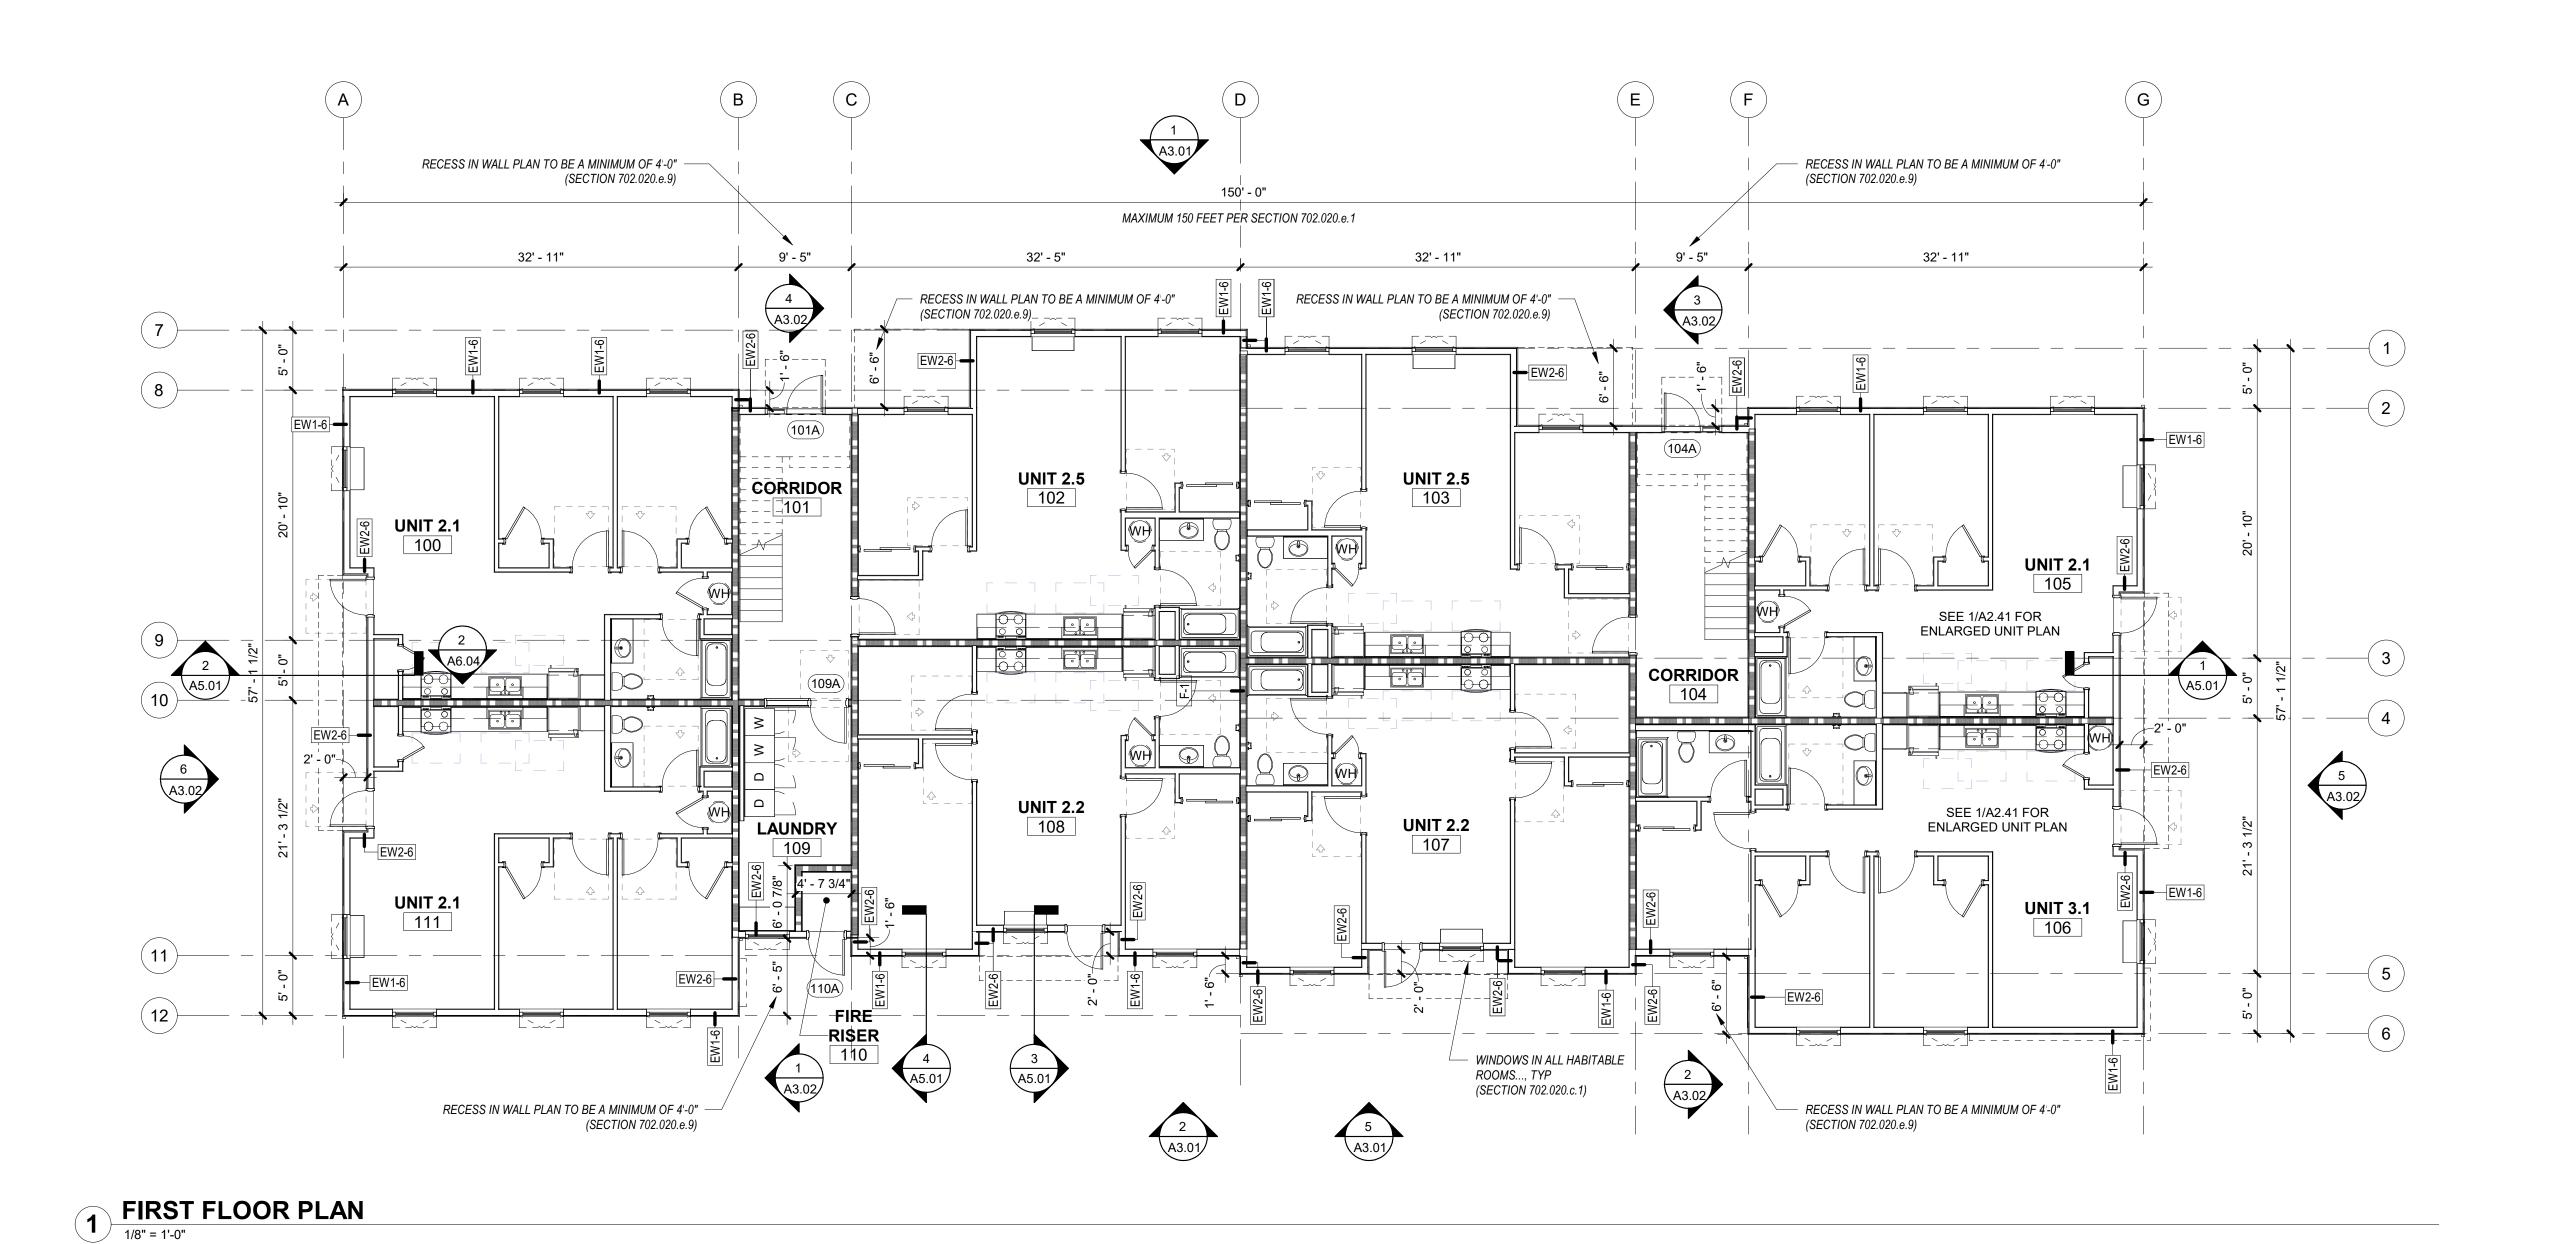

GENERAL SHEET NOTES

- CL OF COLUMN U.N.O. B. ALL EXTERIOR GRID LINES SHOWN ARE TO FACE OF SHEATHING U.N.O. ALL INTERIOR GRID LINES ARE TO FACE OF STUD U.N.O. C. ALL DOOR AND WINDOW DIMENSIONS ARE TO CL OR OVERALL UNIT. REFERENCE SCHEDULES AND DOOR AND WINDOW TYPES D. REFERENCE STRUCTURAL DRAWINGS FOR
- GENERAL CONTROL JOINTS @ SLAB. COORDINATE FINAL LOCATIONS WITH ARCHITECT COMPATIBILITY WITH FLOOR FINISHES

 E. SEE DOOR SCHEDULE FOR DOOR TYPES AND

INSTALLATION DETAILS CORRESPONDING TO

A. WALL DIMENSIONS ARE FROM FACE OF STUD OR

F. SEE WINDOW SCHEDULE FOR WINDOW TYPES G. FOR FLOOR FINISHES, SEE FLOOR FINISH PLAN H. WIRE SHELVING IN ALL BEDROOM CLOSETS I. M.E.P. INFORMATION PROVIDED FOR REFERENCE ONLY. CONTRACTOR TO COORDINATE ALL LOCATIONS OF EQUIPMENT AND REQUIRED

DOOR NUMBERS

- PENETRATIONS PROVIDE BLOCKING FOR FUTURE GRAB BARS AT ALL UNIT RESTROOMS WHERE GRAB BARS ARE NOT SHOWN IN PLAN, REF ACCESSIBILITY
- DIAGRAMS FOR LOCATIONS K. FIRE EXTINGUISHER TO BE PLACED IN PANTRY IN ALL UNITS
- .. CURTAIN RODS AT ALL BEDROOM CLOSETS ARE CFCI, IN LIEU OF DOORS. CURTAINS ARE OFOI. M. DOWNSPOUTS PAINTED IN FIELD, RECTANGLE SHAPE AND SIZE PER PLUMBING AND CIVIL

LEGEND 1 HOUR RATED ASSEMBLY ---- ELEMENT ABOVE FD FLOOR DRAIN R-1 ASPHALT SHINGLE ROOF R-2 STANDING SEAM METAL ROOF

PROVIDE FIRE-RETARDANT

WATER HEATER W FLOOR DRAIN BELOW - REF PLUMBING

TREATED ROOF SHEATHING IN AREA INDICATED DOWNSPOUT

OPERABLE WINDOW

KEYNOTES (07-02)

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CDP SALEM -BUILDING B

Job Number: 5205 BATTLE CREEK RD SE **SALEM, OR 97306**

Development D P Partners

LAND USE SUBMISSION ISSUE

> Drawing: **OVERALL FIRST &** SECOND FLOOR


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DATE

PLANS

THIRD FLOOR PLAN

1/8" = 1'-0"

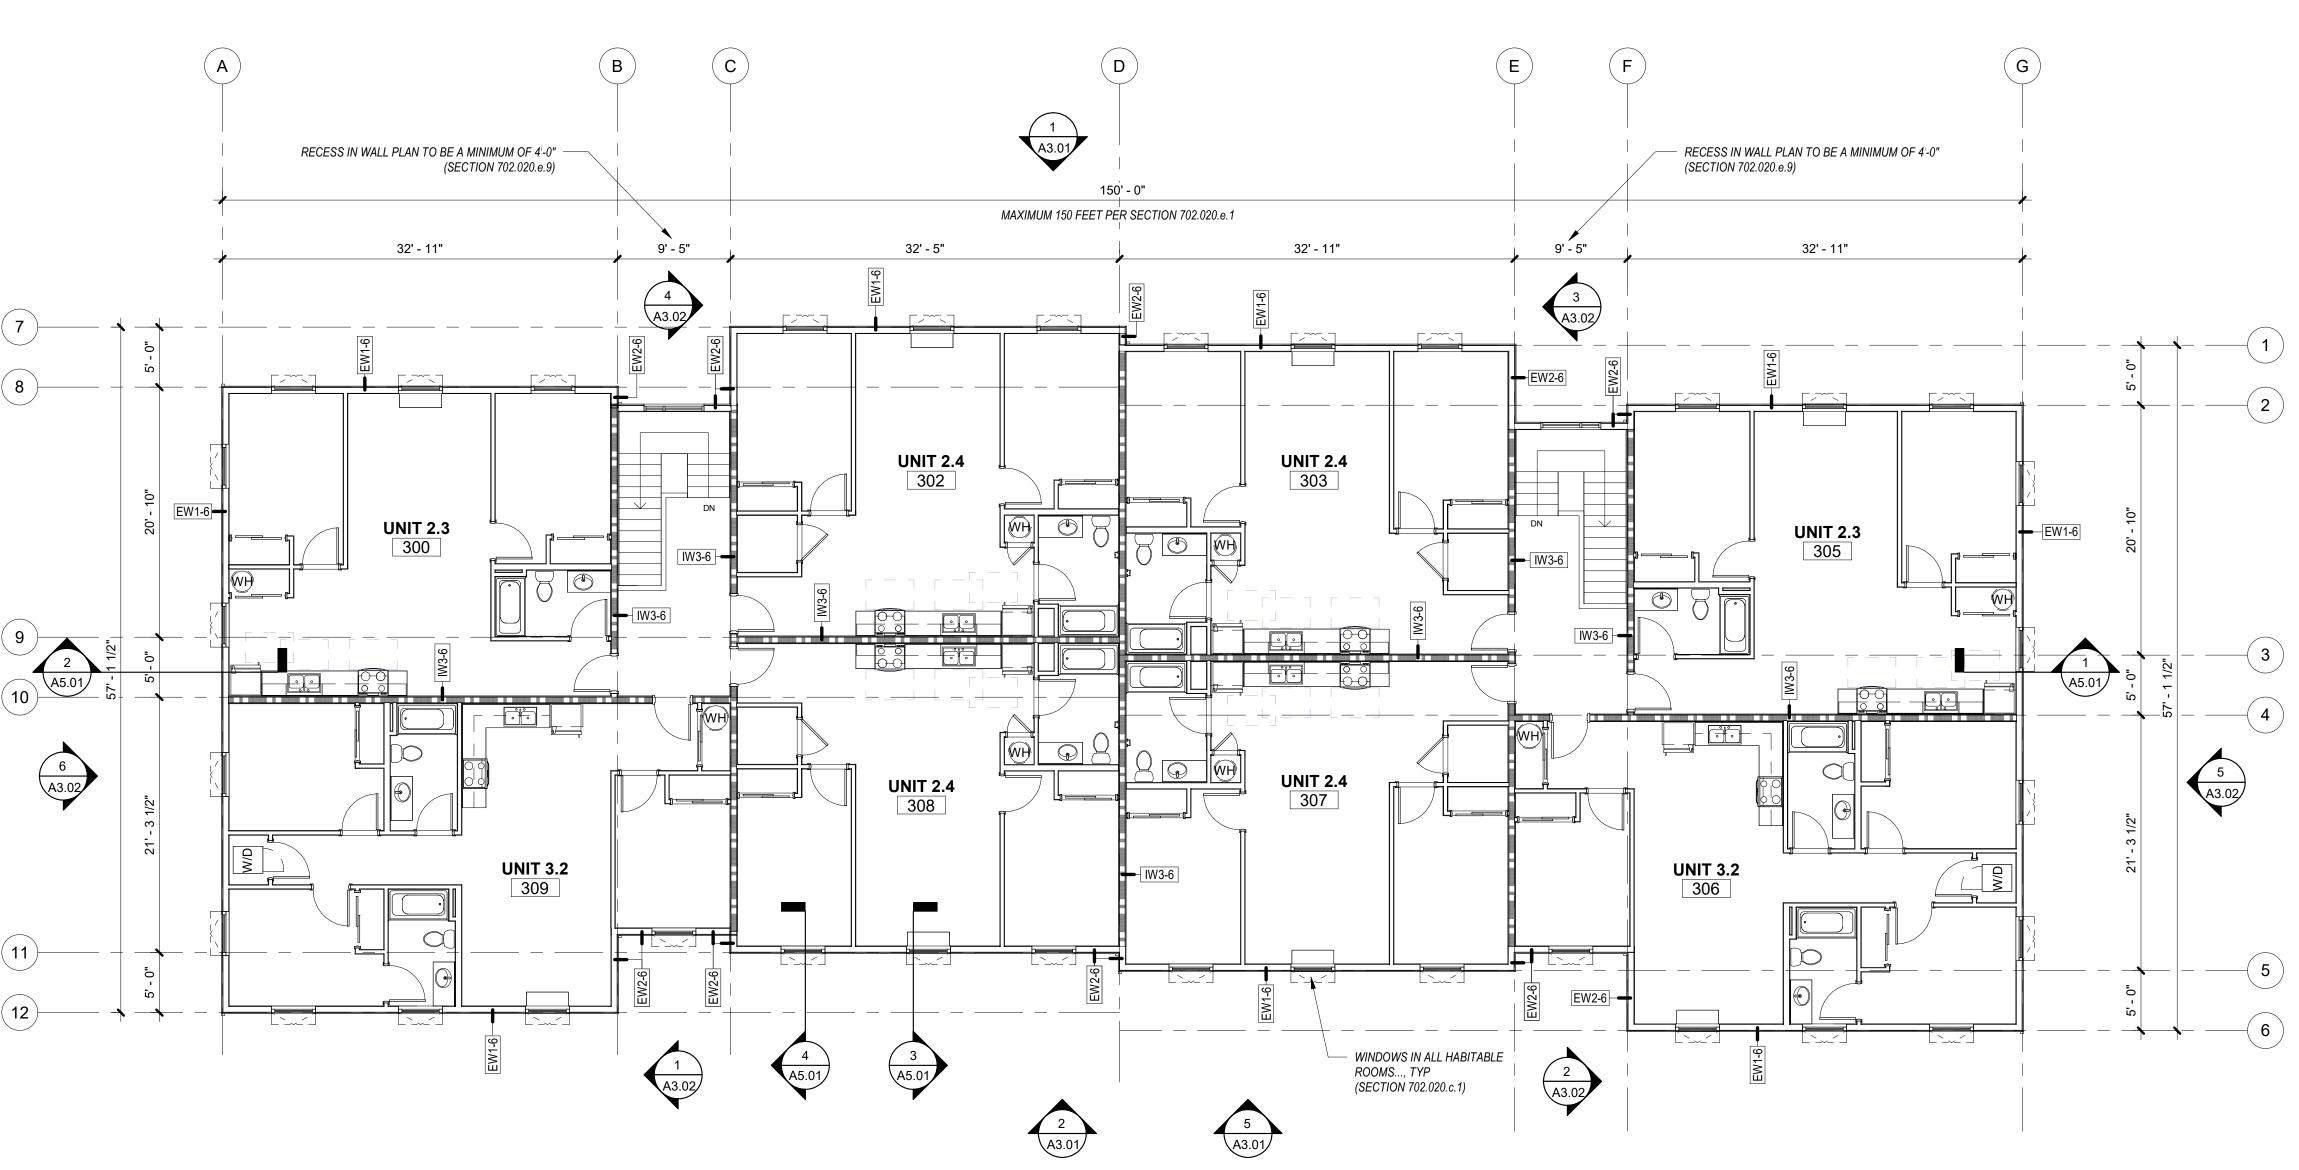

GENERAL SHEET NOTES


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- WITH FLOOR FINISHES

 E. SEE DOOR SCHEDULE FOR DOOR TYPES AND INSTALLATION DETAILS CORRESPONDING TO DOOR NUMBERS F. SEE WINDOW SCHEDULE FOR WINDOW TYPES

32' - 11"

RIDGELINE

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Job Number: 5205 BATTLE CREEK RD SE **SALEM, OR 97306**

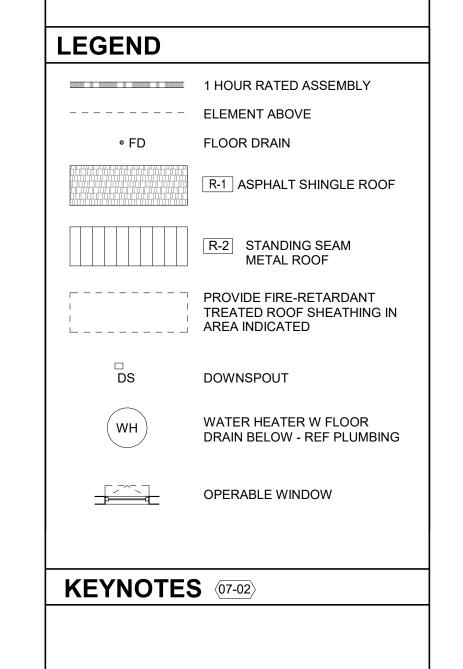


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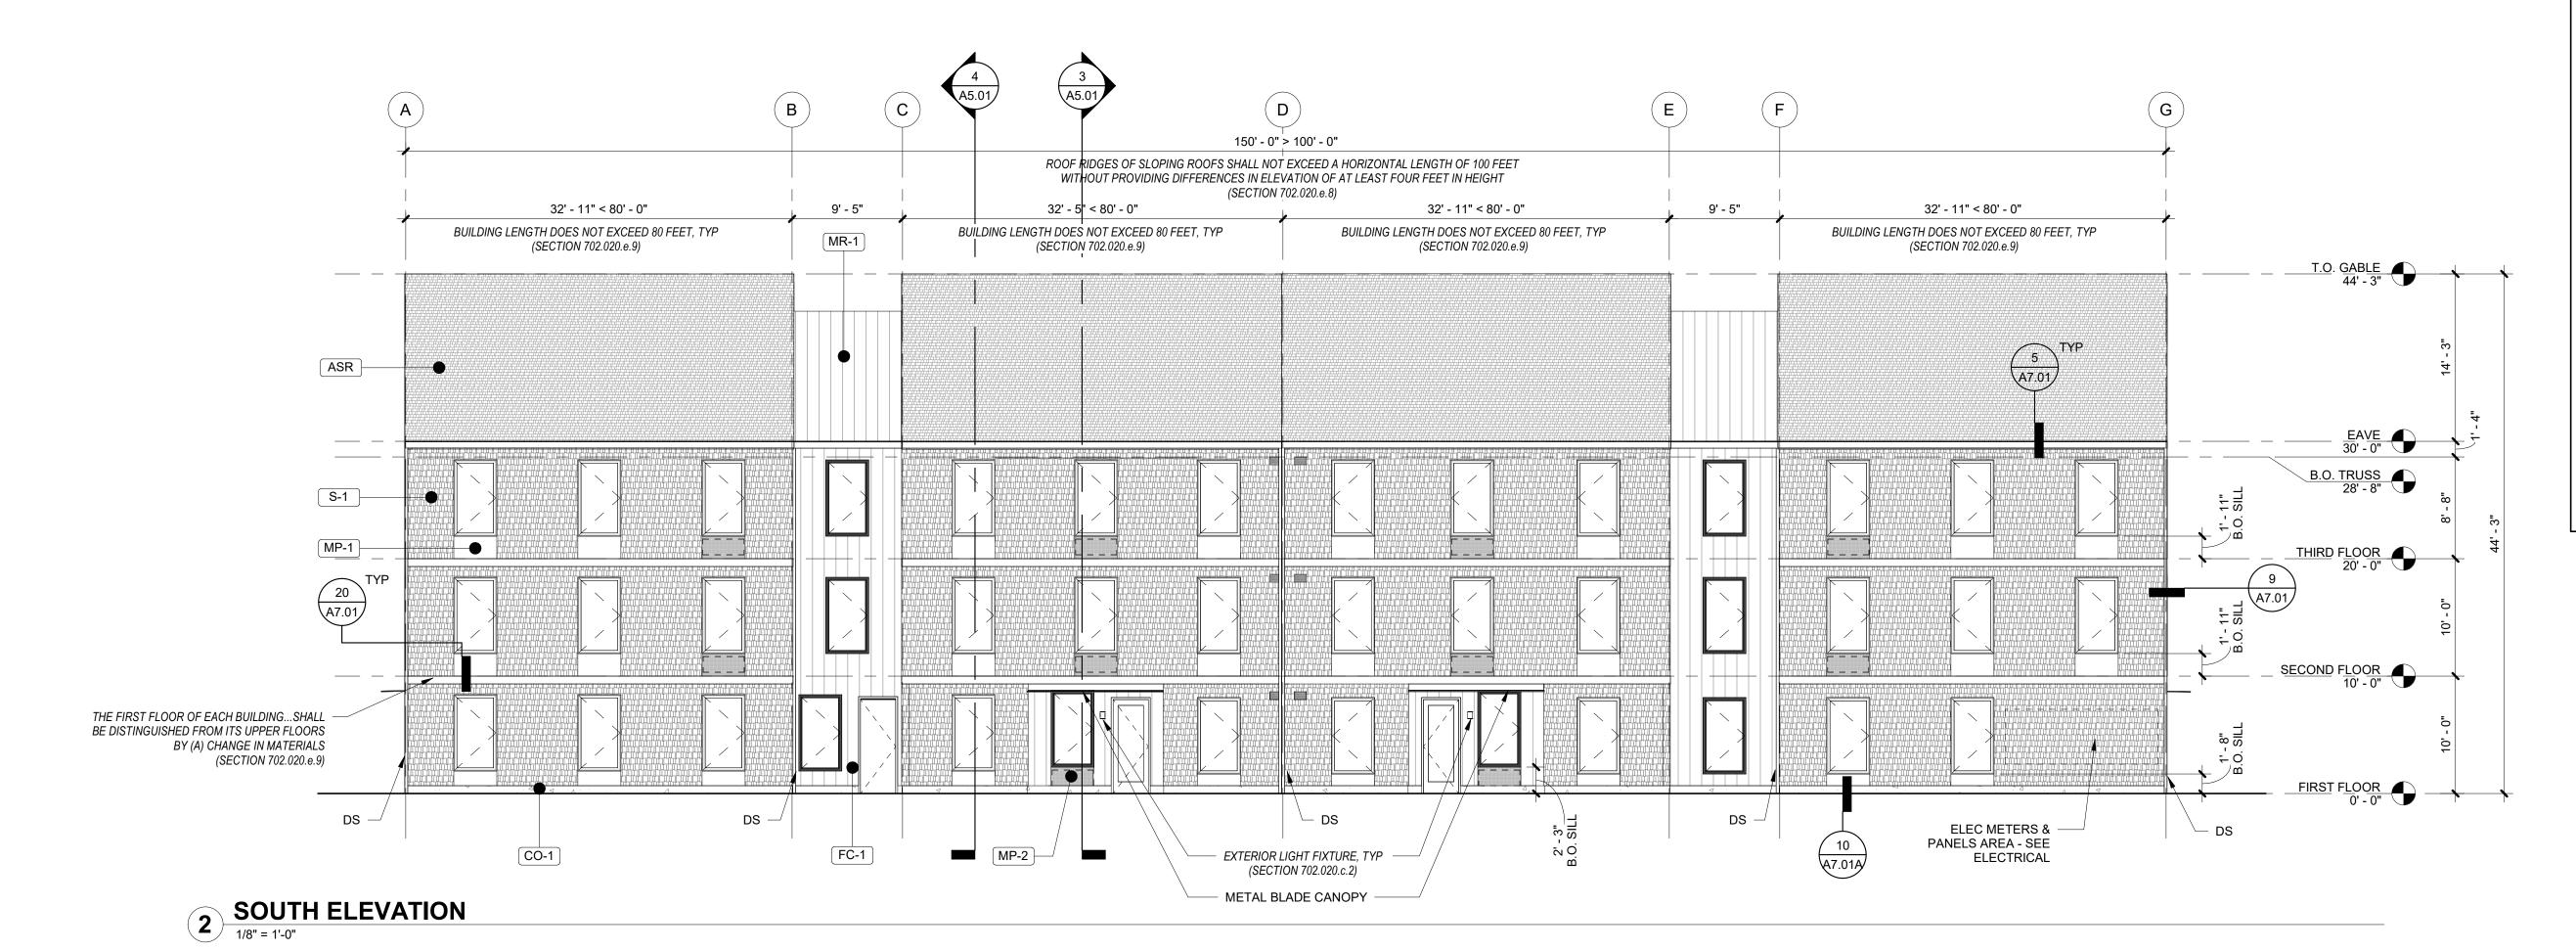
> Drawing: **OVERALL THIRD & ROOF PLANS**


01.11.2021

DATE

A2.12



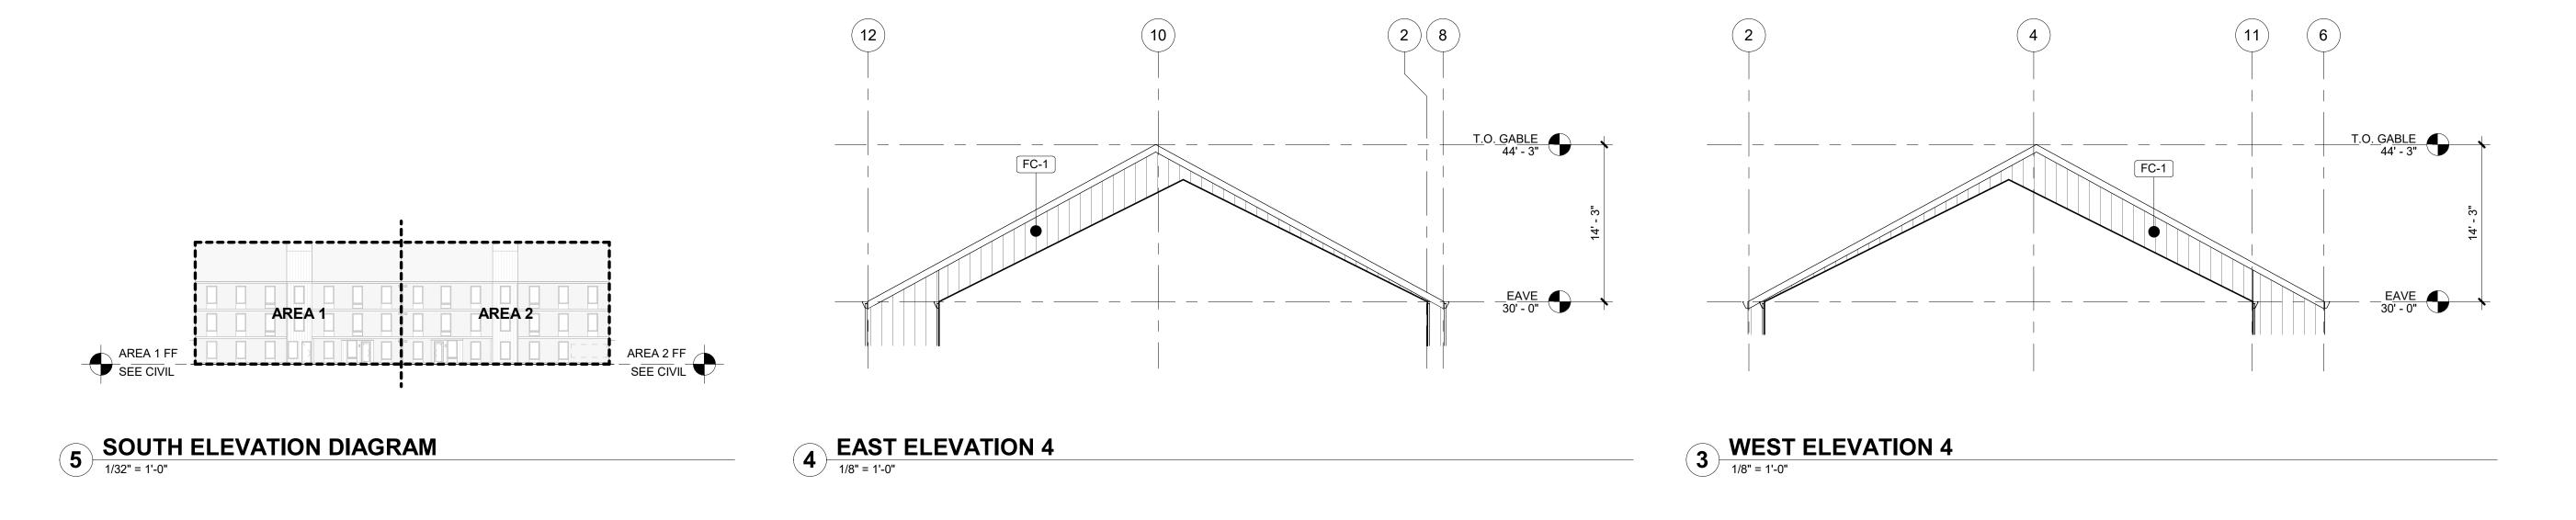

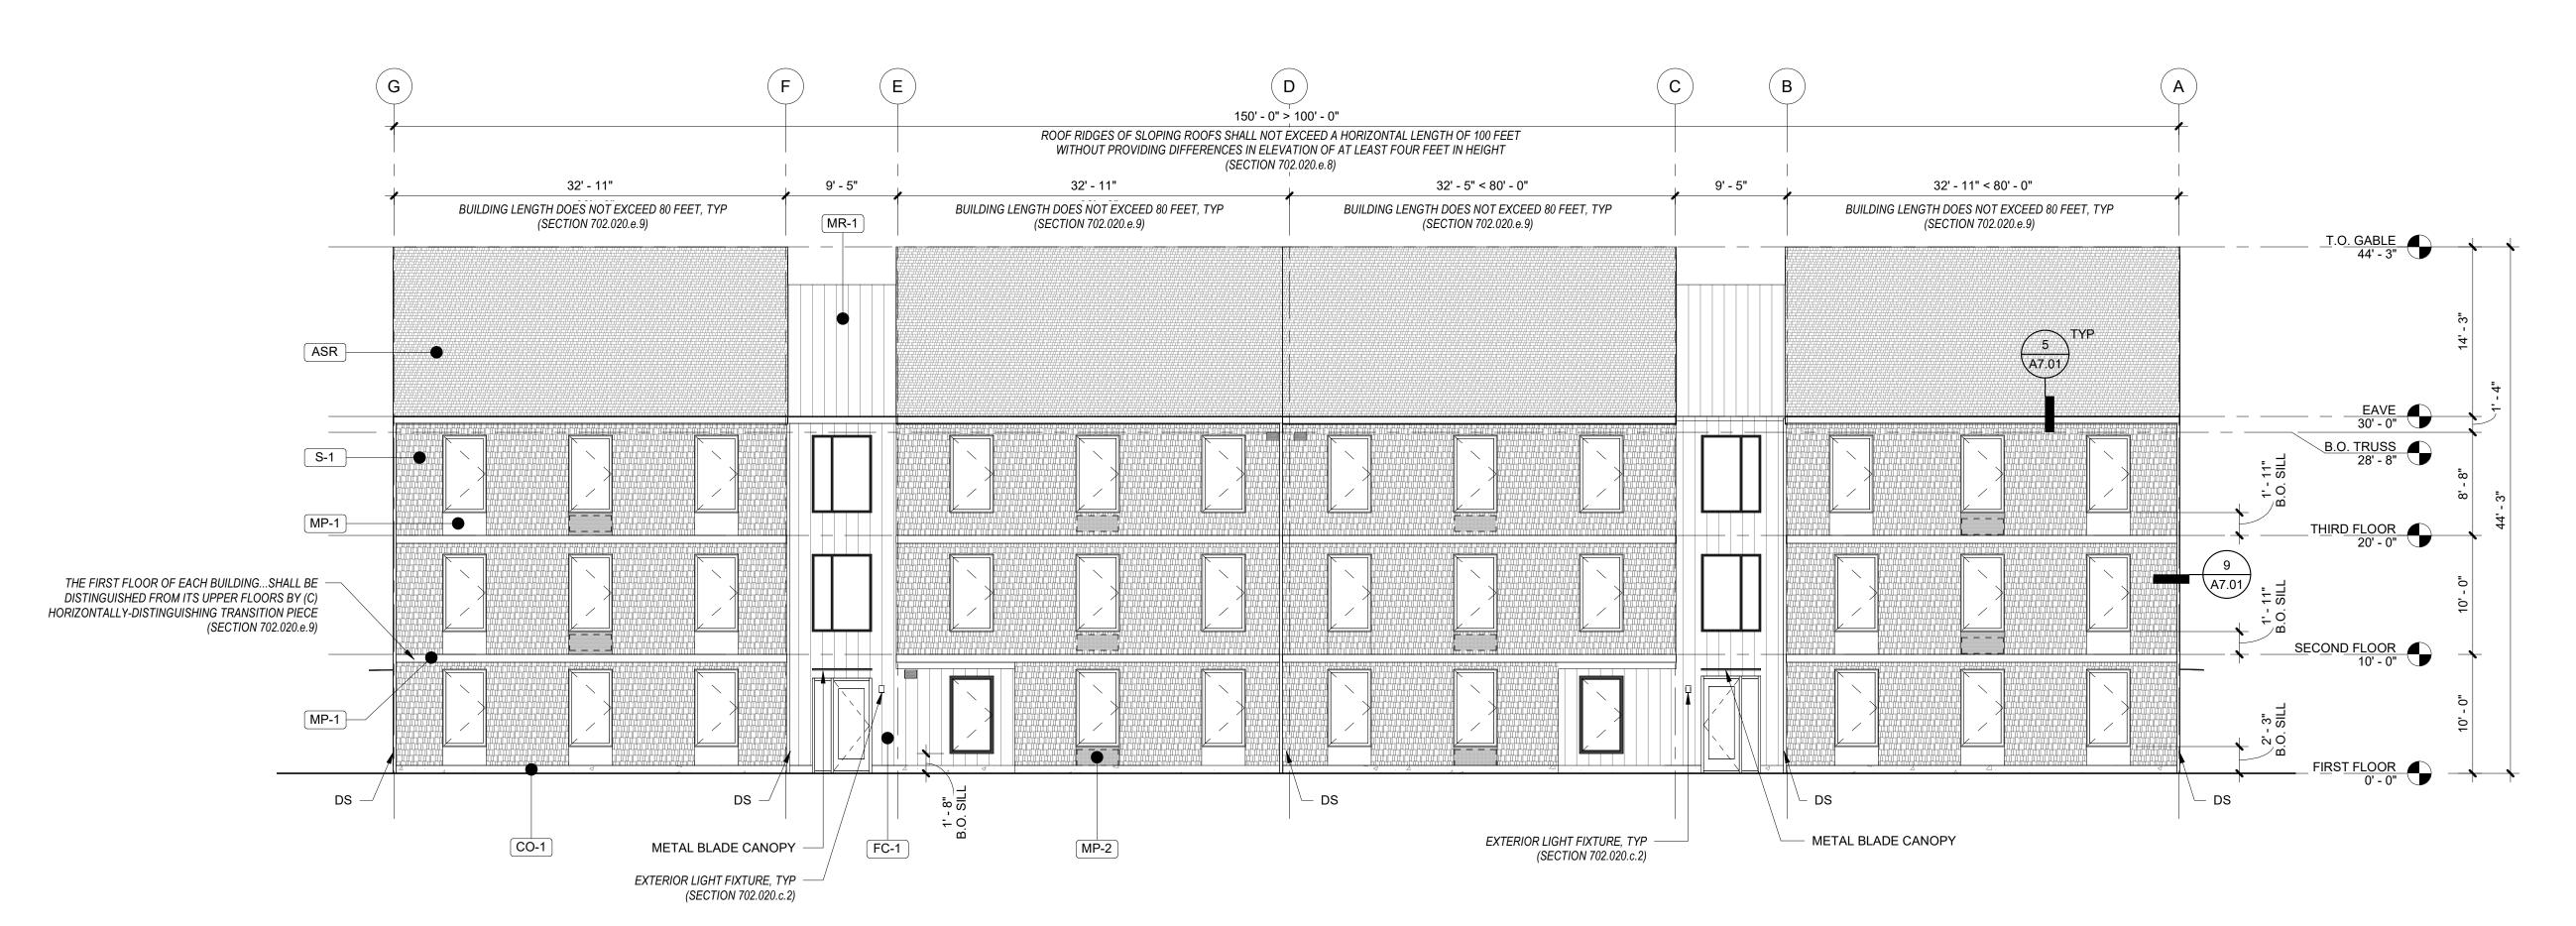

NORTH ELEVATION

1/8" = 1'-0"

GENERAL SHEET NOTES

A. REFERENCE FLOOR PLANS FOR DOOR AND WINDOW LOCATIONS. B. REFERENCE ELECTRICAL FOR EXTERIOR LIGHT

APPLICATIONS. C. CONFIRM ALL EXHAUST OPENINGS ARE MINIMUM 3'-0" FROM OPERABLE OPENINGS. D. ALL EXTERIOR LOUVERS TO BE PAINTED TO

MATCH THE EXTERIOR FINISH IT PENETRATES. E. PREFINISHED 22 GAUGE FORMED SHEET METAL WINDOW TRIM, JAMB, AND SILL AT WINDOWS. F. PREFINISHED 22 GAUGE METAL THROUGH WALL

FLASHING AT WINDOW HEADS.
G. TRANSITION BETWEEN FIBER CEMENT SIDING PROFILES TO FOLLOW MANUFACTURER DETAILING AND REQUIREMENTS.

LEGEND

SHINGLE SIDING PRODUCT: FIBER CEMENT SHINGLE SIDING, STRAIGHT EDGE PANEL COLOR: TBD, DARK

(ASR) PRODUCT: TBD COLOR: TBD **FLAT METAL PANEL**

PRODUCT: TBD FINISH: BLACK FLAT METAL PANEL, PERFORATED

ASPHALT SHINGLE ROOF

PRODUCT: TBD FINISH: BLACK **BOARD & BATTEN SIDING** PRODUCT: FIBER CEMENT SMOOTH FLAT PANEL COLOR: WHITE

STANDING SEAM METAL ROOF

CONCRETE STEM WALL

PRODUCT: COLOR: WHITE

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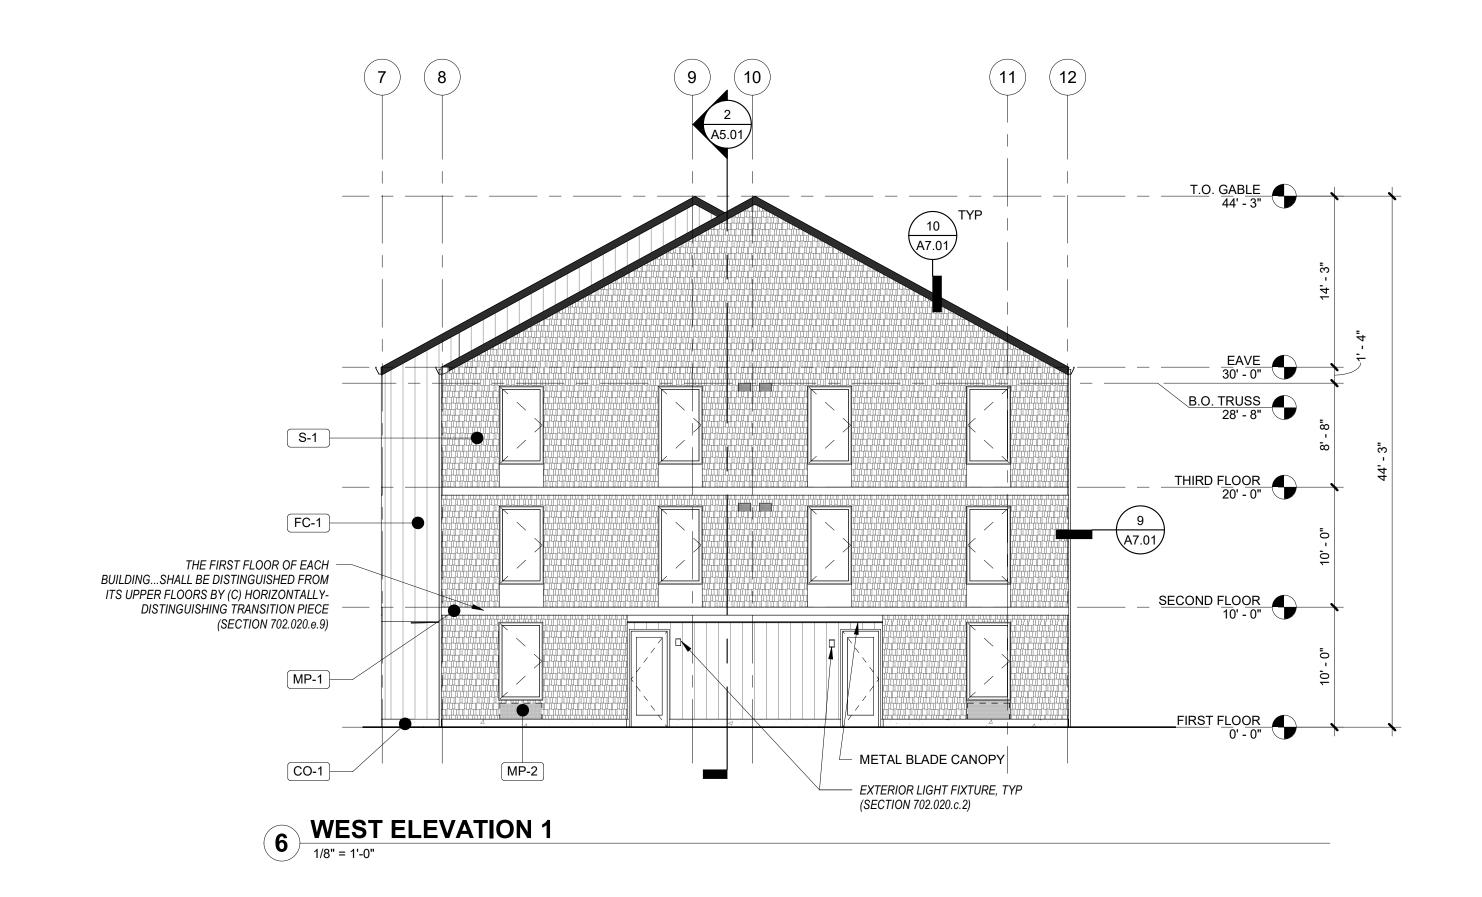
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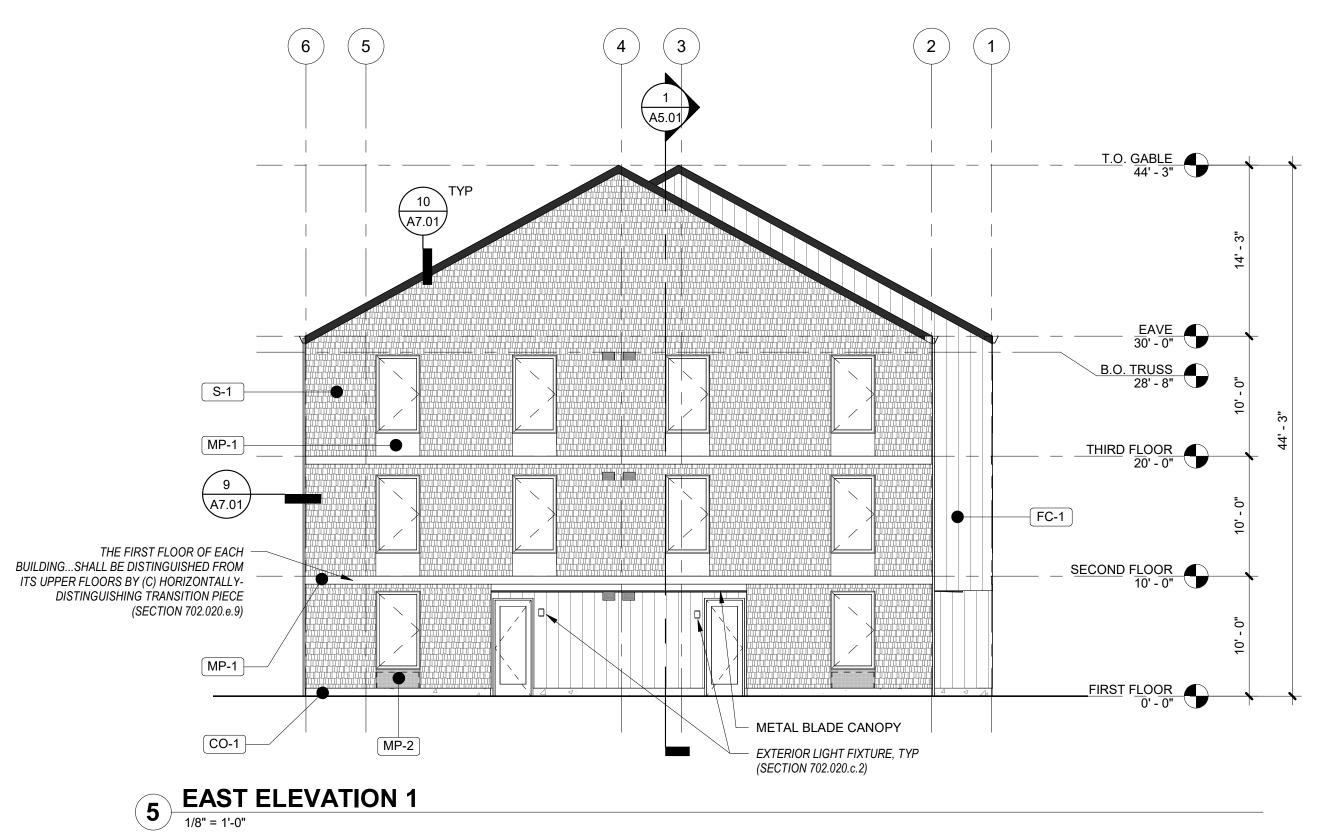
EXTERIOR ELEVATIONS


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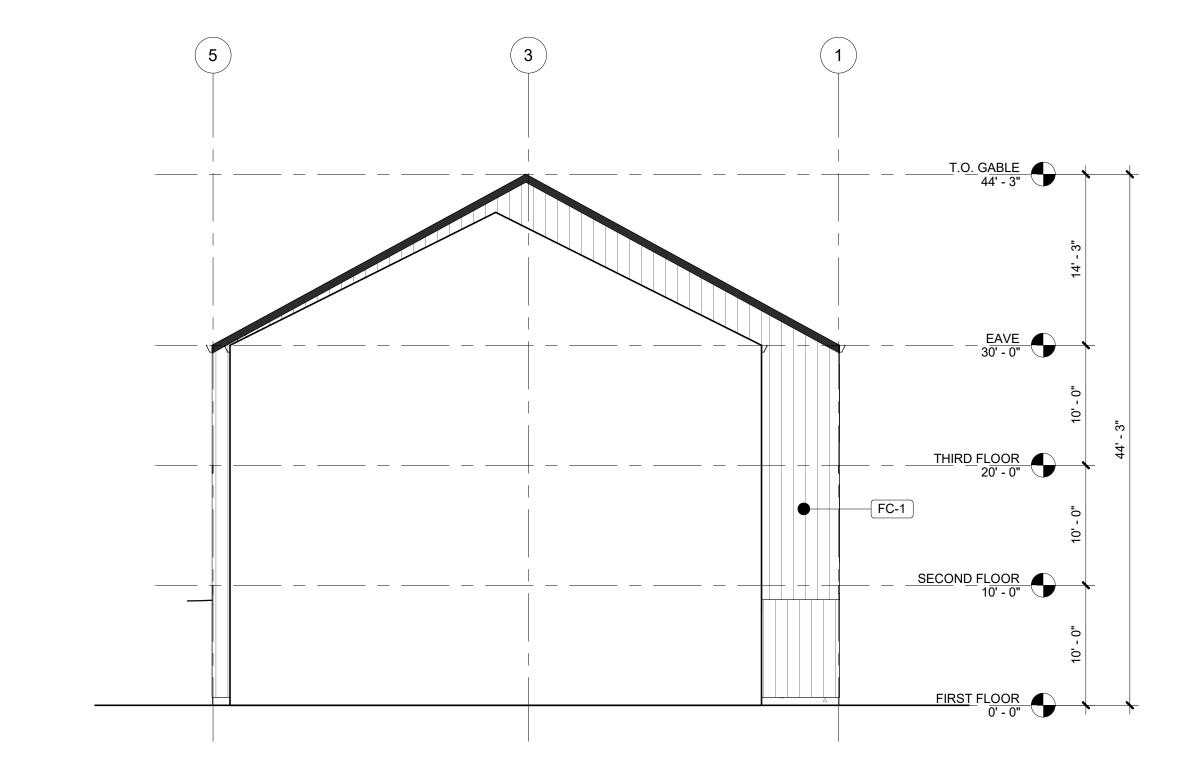
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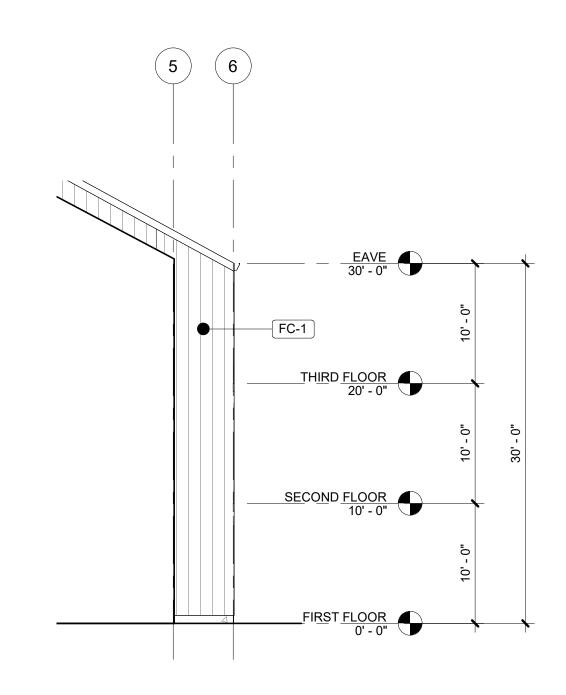








WEST ELEVATION 21/8" = 1'-0"

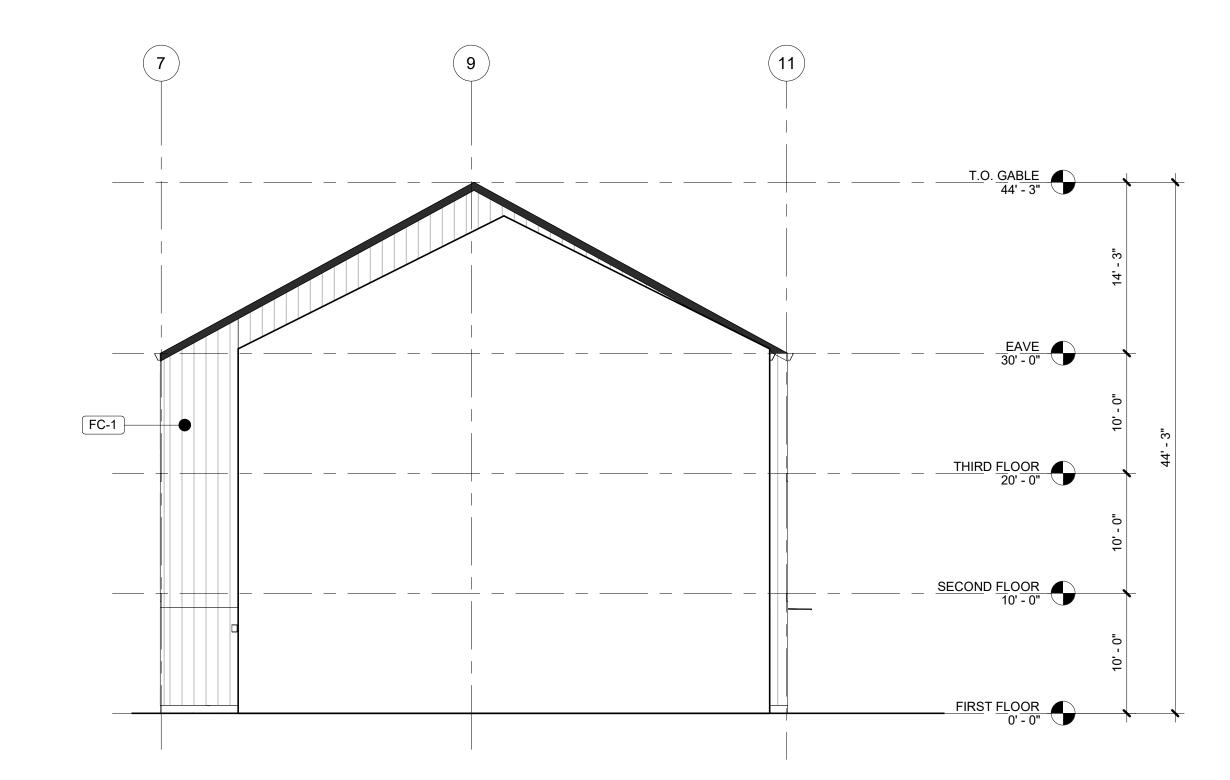


WEST ELEVATION 3

1/8" = 1'-0"

3 EAST ELEVATION 2

1/8" = 1'-0"

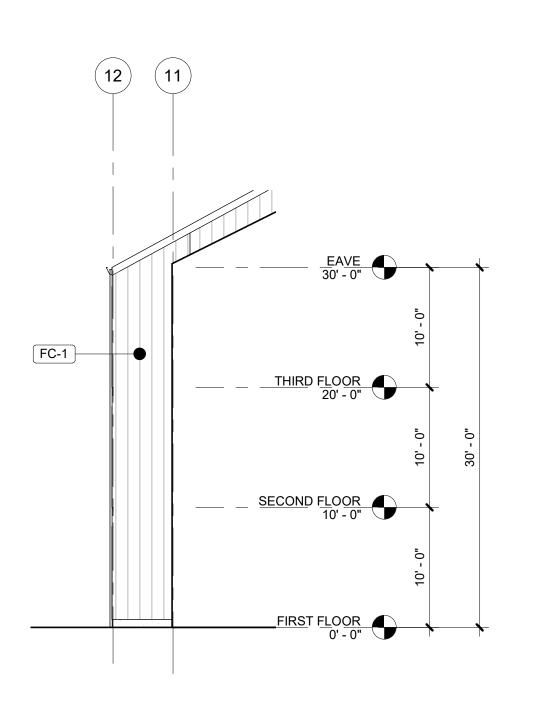

1 EAST ELEVATION 3
1/8" = 1'-0"

GENERAL SHEET NOTES

- A. REFERENCE FLOOR PLANS FOR DOOR AND WINDOW LOCATIONS.

 B. REFERENCE ELECTRICAL FOR EXTERIOR LIGHT APPLICATIONS.

 C. CONFIRM ALL EXHAUST OPENINGS ARE MINIMUM 3'-0" FROM OPERABLE OPENINGS.

 D. ALL EXTERIOR LOUVERS TO BE PAINTED TO MATCH THE EXTERIOR FINISH IT PENETRATES.

 E. PREFINISHED 22 CALIGE FORMED SHEET METAL
- E. PREFINISHED 22 GAUGE FORMED SHEET METAL WINDOW TRIM, JAMB, AND SILL AT WINDOWS.
- F. PREFINISHED 22 GAUGE METAL THROUGH WALL FLASHING AT WINDOW HEADS.
 G. TRANSITION BETWEEN FIBER CEMENT SIDING PROFILES TO FOLLOW MANUFACTURER DETAILING AND REQUIREMENTS.


LEGEND

SHINGLE SIDING
PRODUCT: FIBER CEMENT SHINGLE
SIDING, STRAIGHT EDGE PANEL
COLOR: TBD, DARK

(ASR) PRODUCT: TBD COLOR: TBD


FLAT METAL PANEL PRODUCT: TBD

ASPHALT SHINGLE ROOF

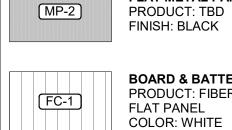


PRODUCT: TBD FINISH: BLACK BOARD & BATTEN SIDING
PRODUCT: FIBER CEMENT SMOOTH
FLAT PANEL

FLAT METAL PANEL, PERFORATED

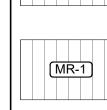

STANDING SEAM METAL ROOF PRODUCT: COLOR: WHITE

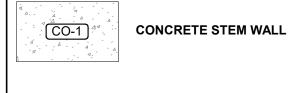

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Drawing: **EXTERIOR**

ELEVATIONS

Sheet No: Building B -


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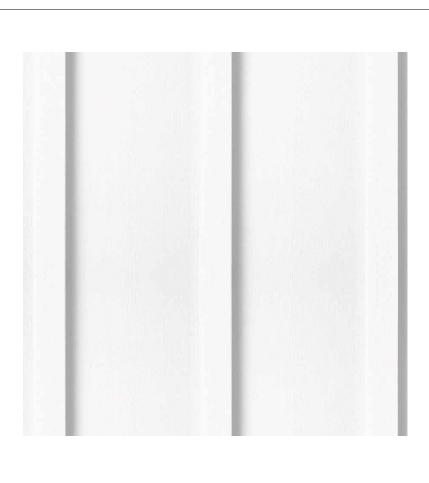
BUILDING FACING COURTYARD 1

MATERIALS



SHINGLE SIDING
PRODUCT: FIBER CEMENT
SHINGLE SIDING, STRAIGHT
EDGE PANEL
COLOR: TBD, DARK

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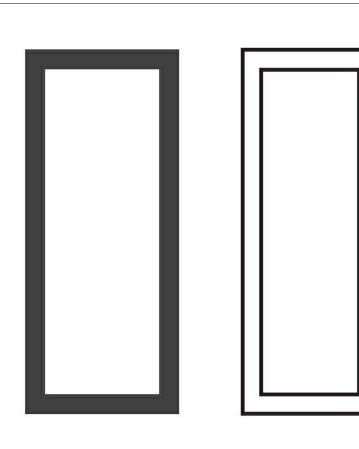
BOARD AND BATTEN SIDING PRODUCT: FIBER CEMENT SMOOTH FLAT PANEL COLOR: WHITE

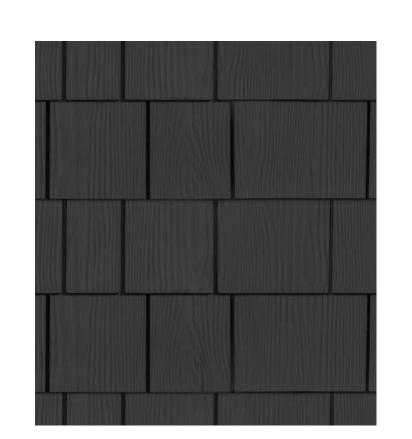

ASPHALT SHINGLE ROOF PRODUCT: TBD FINISH: TBD, DARK



FLAT METAL PANEL PRODUCT: TBD FINISH: TBD, DARK



VINYL WINDOWS
PRODUCT: PRODUCT: VPI
ENDURANCE AND KAWNEER
TRIFAB 451
FINISH: TBD, LIGHT & DARK



BUILDING FACING COURTYARD 2



BUILDING FACING PARKING



PATH FROM PARKING TO COURTYARD

* SITE AND LANDSCAPING SHOWN FOR REFERENCE ONLY. SEE CIVIL AND LANDSCAPE DRAWINGS FOR FULL DESIGN.

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CDP SALEM BUILDING B
Job Number: 21

5205 BATTLE CREEK RD SE SALEM, OR 97306




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Drawing:

RENDERINGS

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LAND USE SUBMISSION ISSUE 01.11.2021

Drawing:


WALL SECTIONS

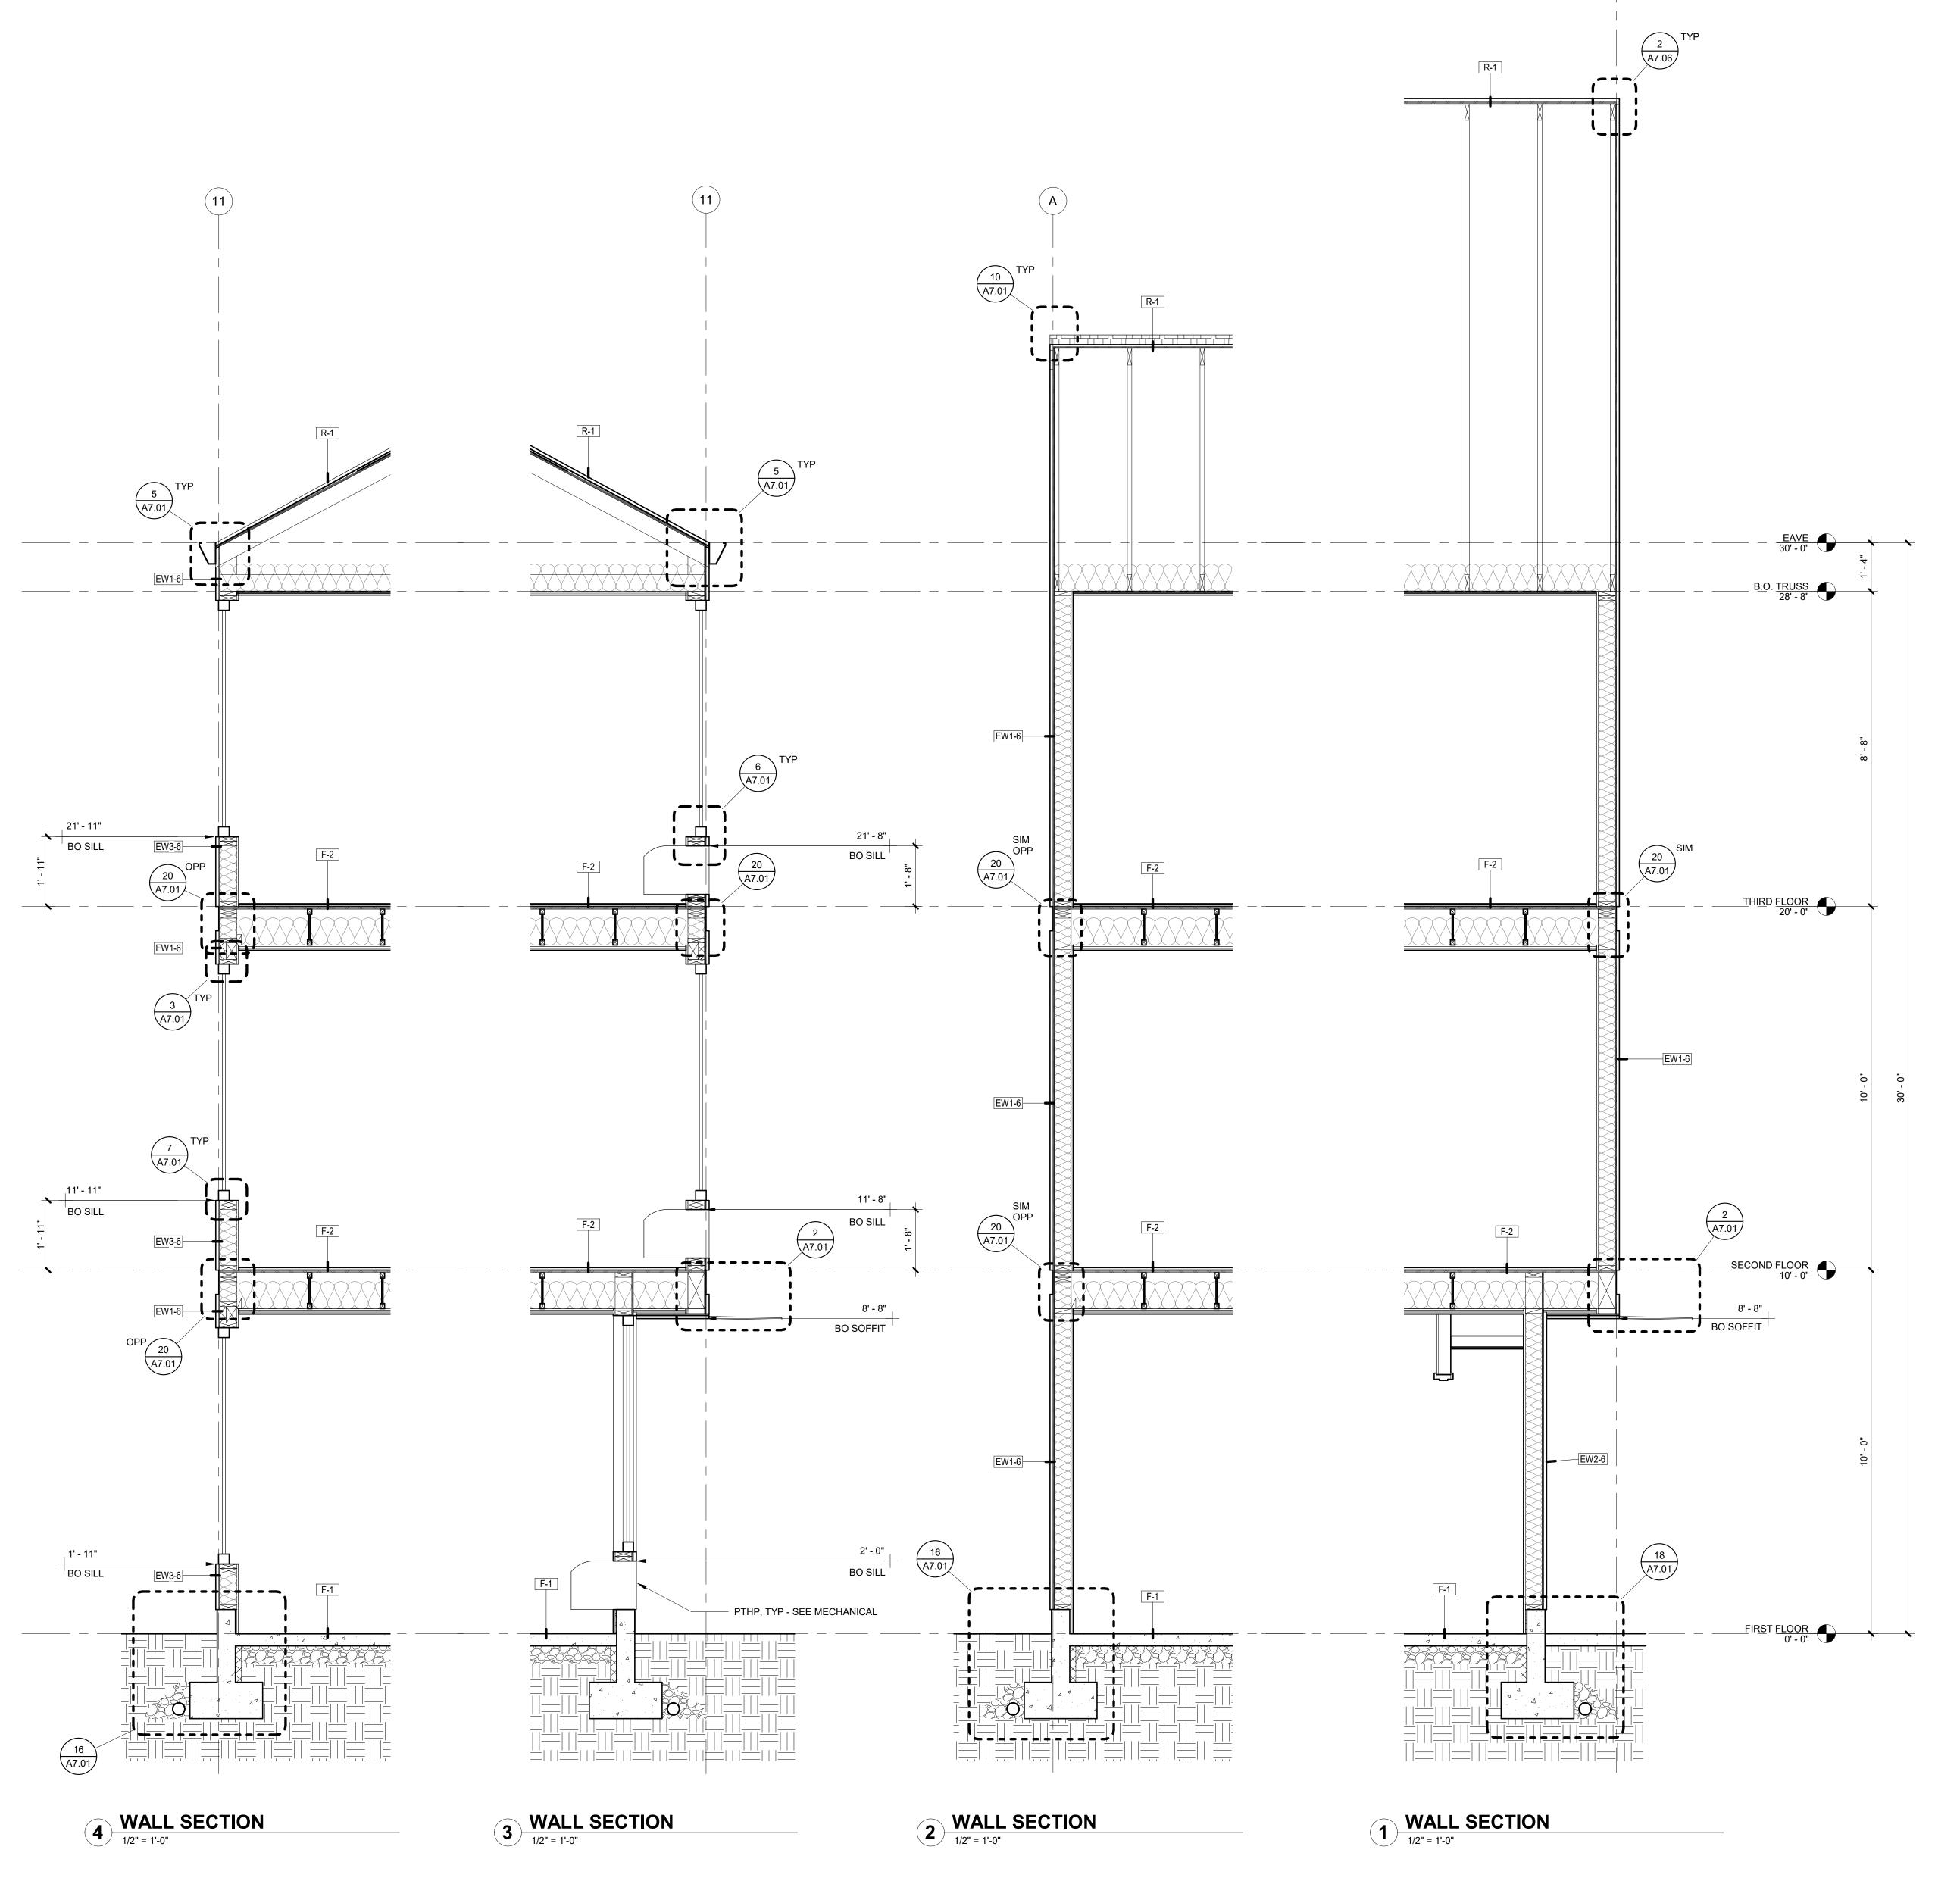
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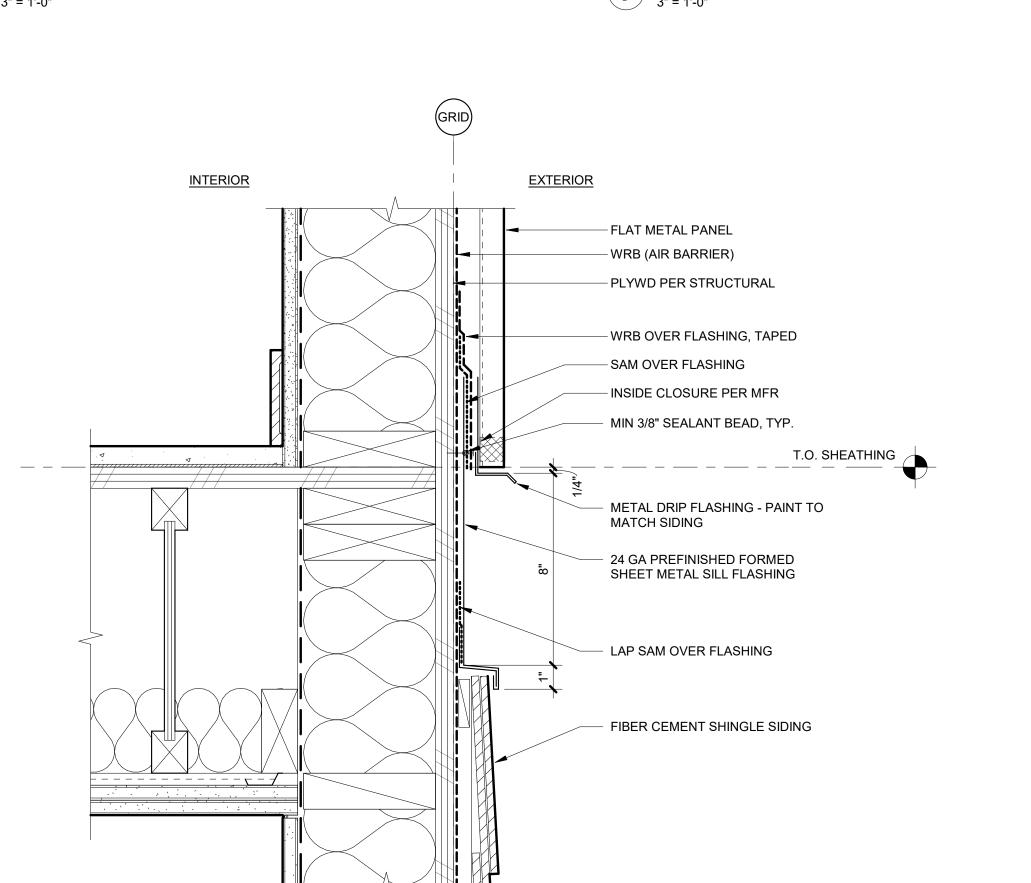
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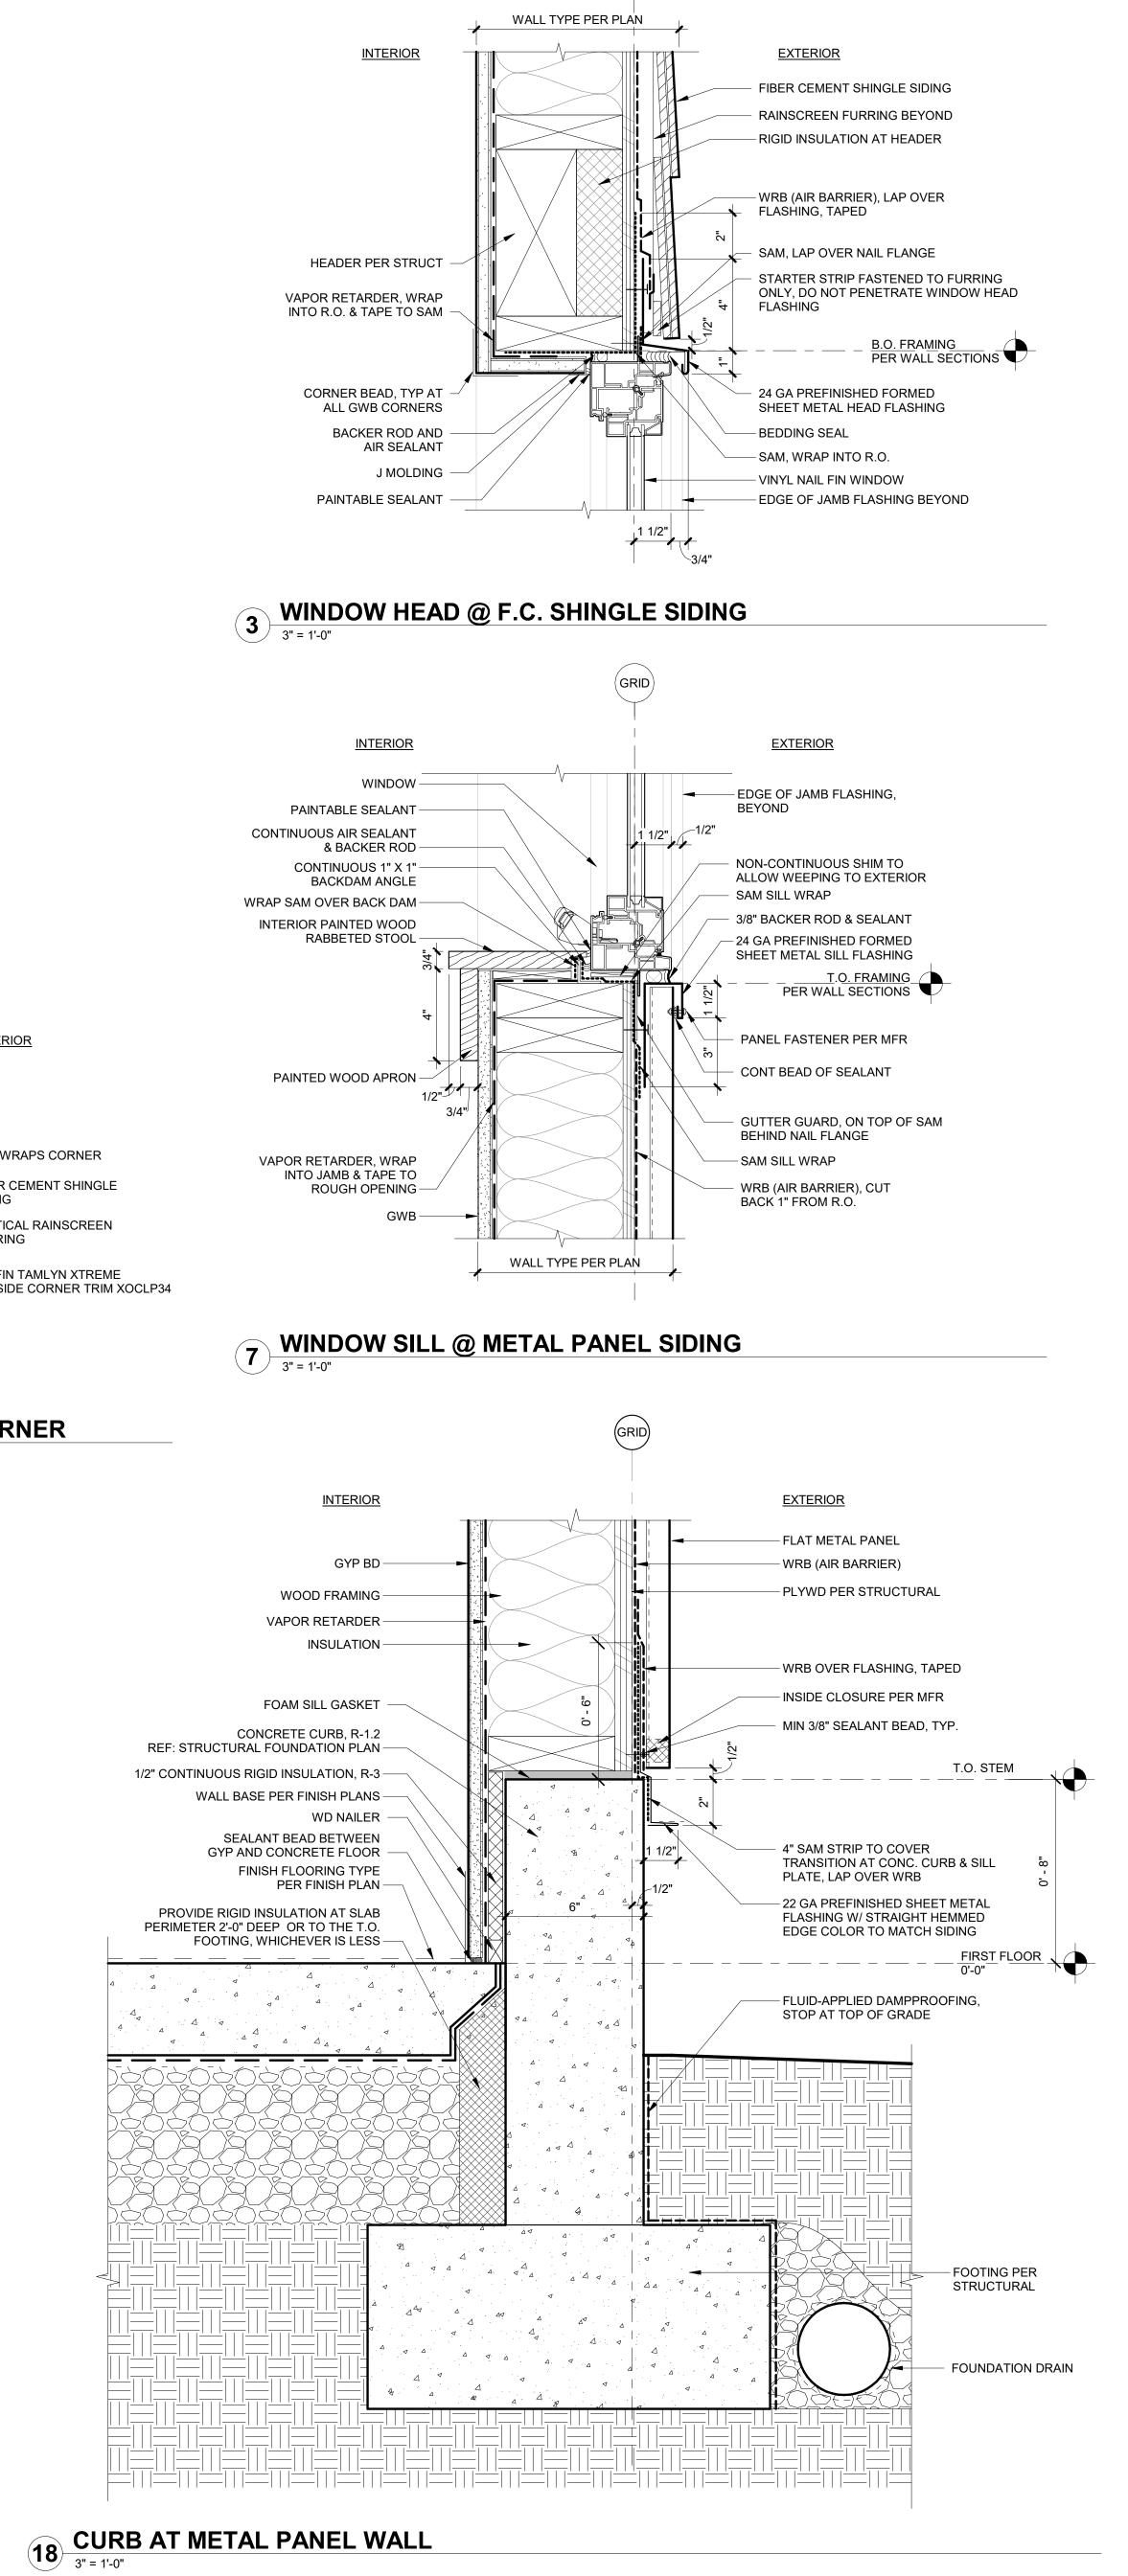
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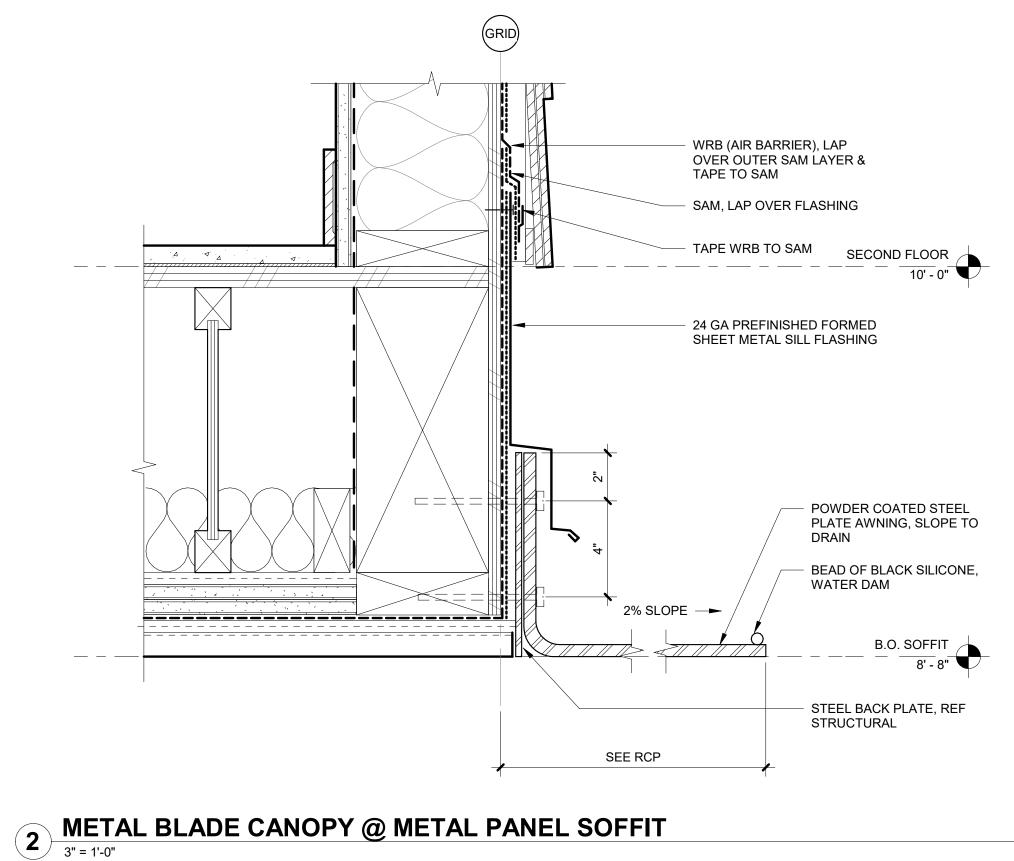









20 REVEAL @ METAL PANEL & SHINGLE SIDING

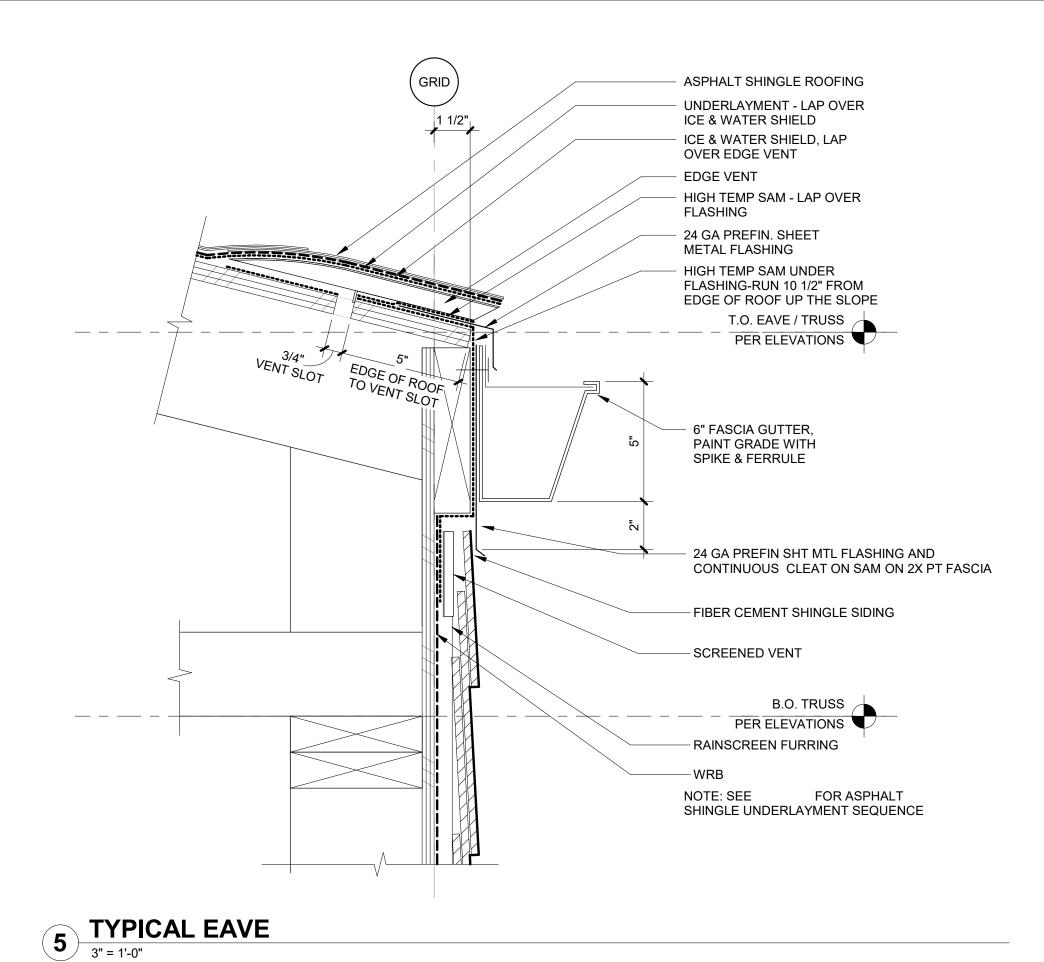

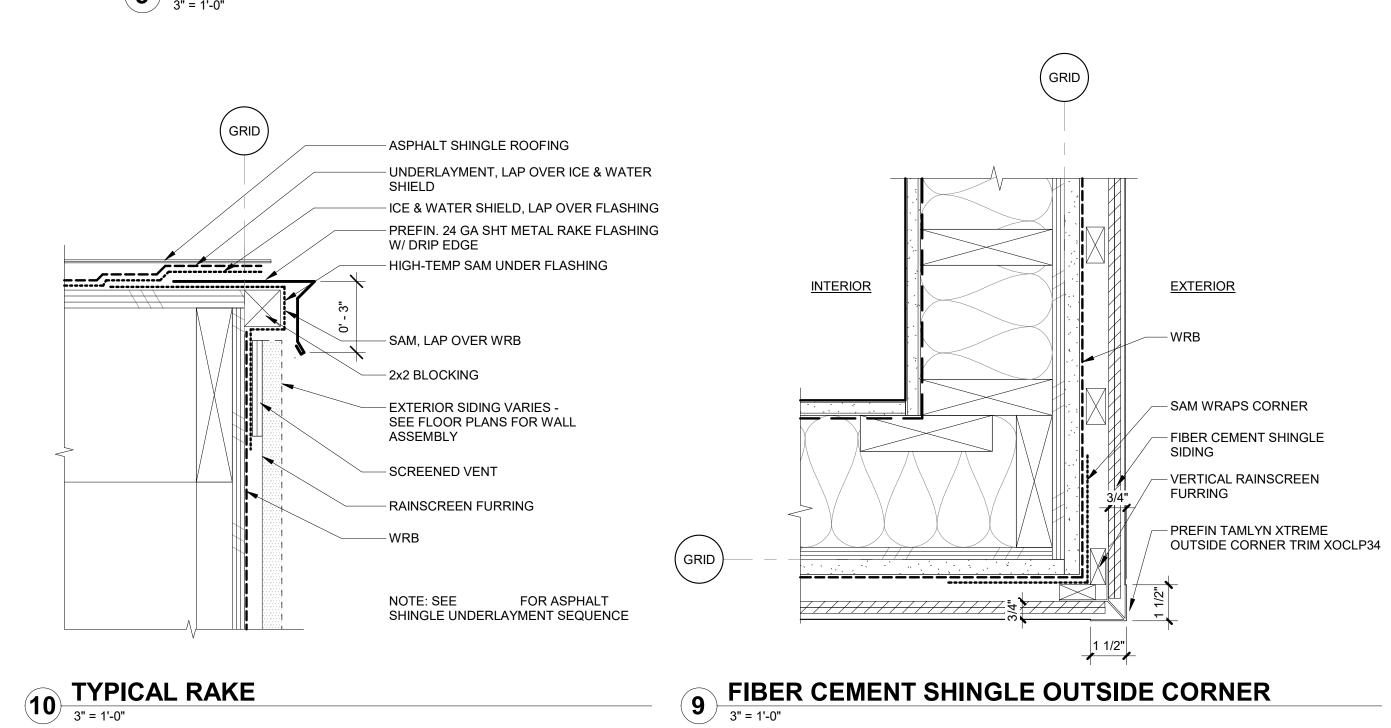

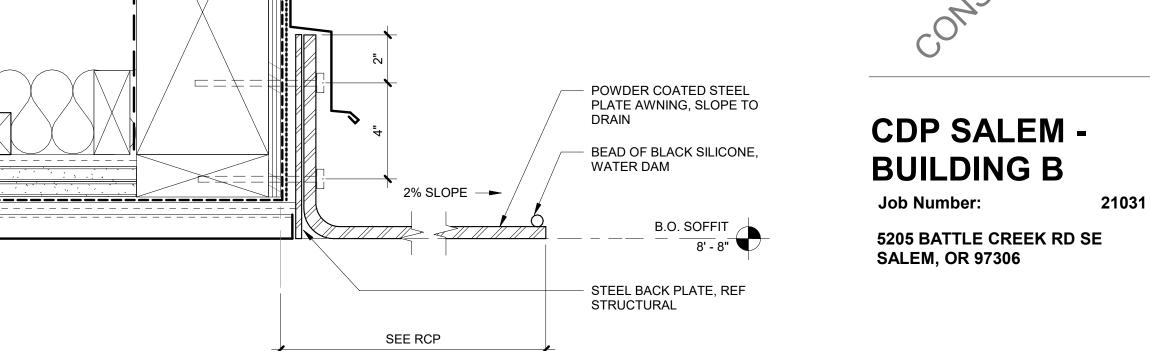

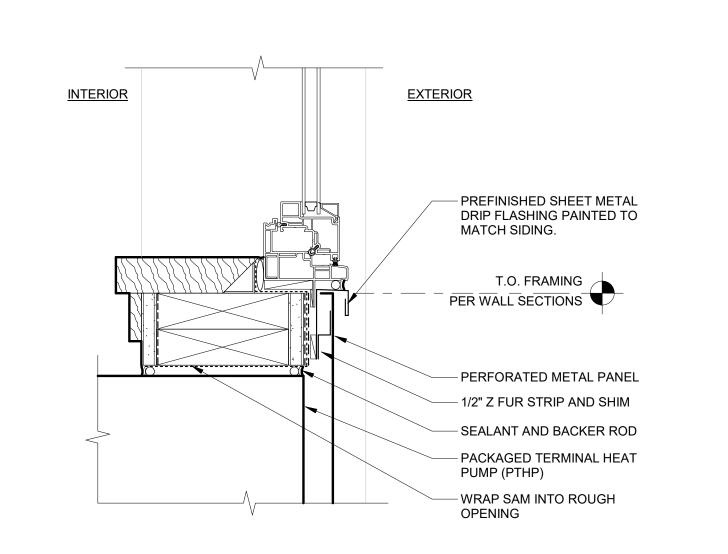

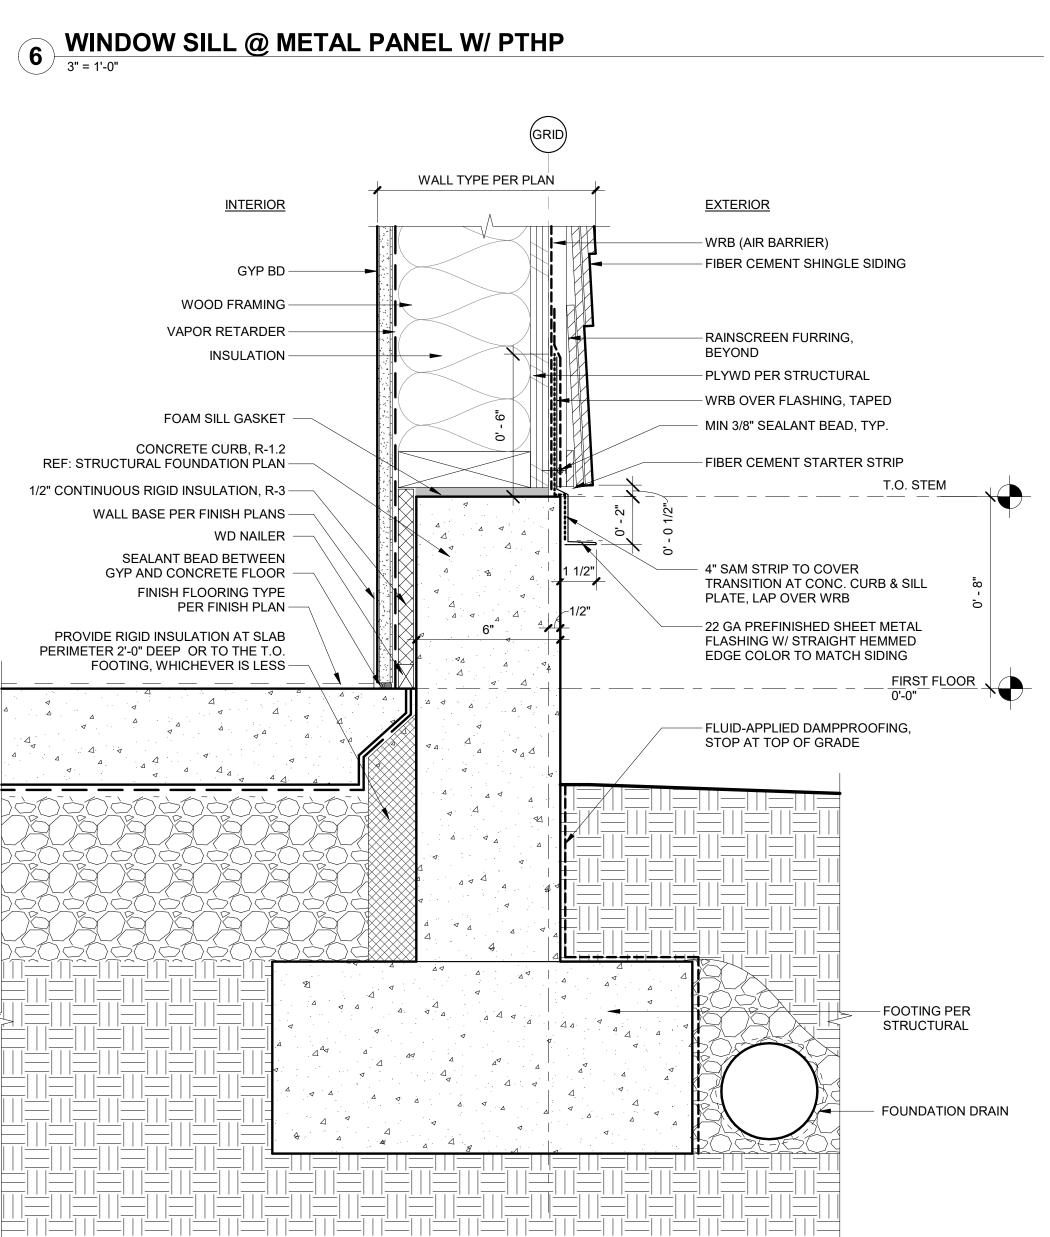

CURB AT EXT FIBER CEMENT SHINGLE CLAD WALL
3" = 1'-0"



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