LAND USE SUBMISSION

01.11.2021




CDP SALEM - BUILDING A

5205 BATTLE CREEK RD SE SALEM, OR 97306





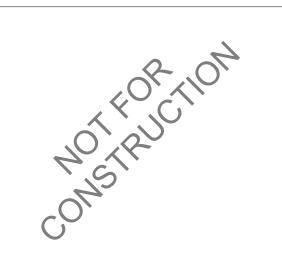

CDP SALEM -BUILDING A

Job Number: 2°
5205 BATTLE CREEK RD SE

SALEM, OR 97306



LAND USE SUBMISSIO ISSUE

Drawing:

GENERAL PROJECT INFORMATION

01.11.2021

DATE

Sheet No:

G0.01

OCCUPANCY	SUMMARY 2				CHAPTER 1
CONSTRUCTION TYPE	V-B, SPRINKLERED PER NFF 13-R	PA			SECTION 10
	DETAILED REQUIREMENTS	S BASED ON OCC	UPANCY AND USE		SECTION 100 SECTION 100
OSSC REFERENCE					TABLE 1006.
SECTION 420.2	SEPARATION WALLS		DWELLING OR SLEEPING UNIT NCIES SHALL BE CONSTRUCTE TH SECTION 708.		
SECTION 420.3	HORIZONTAL SEPARATION	FLOOR ASSEMBLIES	SEPARATING DWELLING OR S HER OCCUPANCIES SHALL BE		TABLE 1006.
SECTION 420.4	SPRINKLER SYSTEM	HORIZONTAL ASSEM	IBLIES IN ACCORDANCE WITH		TABLE 1006.
SECTION 420.4 SECTION 420.5	SPRINKLER SYSTEM FIRE & SMOKE ALARMS	GROUP R-2, FIRE ALA	CIES, REQUIRED PER 903.2.8 ARM SYSTEMS REQUIRED PER QUIRED PER 907.2.10.2	SECTION 907.2.9	
		SMOKE ALARMS REC	QUIRED PER 907.2.10.2		TABLE 1017.
CHAPTER 5: GENERAL	BUILDING HEIGHTS AND	AREAS			TABLE 1020.
TABLE 504.3 TABLE 504.4 TABLE 506.2	HEIGHT / STORIES / AREA F	ACTOR R-2: 60 FT	/ 3 STORY / 7000 SF		SECTION 102
MODIFICATIONS					
SECTION 506.2.3	BUILDING AREA	Aa = [At + (NS x lf)	l x Sa		CHAPTER 1
SINGLE-OCCUPANCY MULTIS EQUATION 5-2		= [7000 SF + (7000 = 12250 SF x 3	-		SECTION 110
		= 36750 SF	W/o		
SECTION 506.3	FRONTAGE INCREASE	If = [F/P - 0.25] x \text{ If = [283/283 - 0.2]} = 0.75			
	ACTUAL HEIGHT / STORIES	34' - 9" / 3 Story			
		BUILDING AREA			
	FLOOR LEVEL FIRST FLOOR		REA (SF) 4392 SF		SECTION 110
	SECOND FLOOR THIRD FLOOR		4601 SF 4601 SF 13593 SF		
	1		. 5555 61		
SECTION 508.2	ACCESSORY OCCUPANCY	N/A			SECTION 110
SECTION 508.3 / 508.4 TABLE 509	MIXED OCCUPANCY INCIDENTAL USES	N/A			EXCEPTION:
-		· · · · · · · · · · · · · · · · · · ·	NO SEPARATION REQUIRED NO SEPARATION REQUIRED		
CHAPTER 6: TYPES OF	CONSTRUCTION / CONS	TRUCTION CLASS	SIFICATION		ADDITIONA
TABLE 601	FIRE RESISTANCE RATING F				APPLICABLE
	E	BUILDING ELEMENT	FIRE RA	-	
	PRIMARY STRUCTURAL FF BEARING WALLS	RAME	0 HC		
	EXTERIOR INTERIOR NON BEARING WALLS AND	DARTITIONS EVTERI	0 HC 0 HC OR PER TAI	DUR	
	NON BEARING WALLS AND NON BEARING WALLS AND FLOOR CONSTRUCTION A	PARTITIONS - INTERIO	OR 0 HC	DUR	ACCESSIBLE
	ROOF CONSTRUCTION AN * UNLESS OTHERWISE RE			DUR	
TARI E 602	FIDE DEGISTANCE DATING	SEUTIDMENTO FOR TH	TERIOR WALLS BASES ON SIZ	E SEDADATION DISTANCE	CHAPTER 1 CLIMATE ZO
TABLE 602		REQUIRMENTS FOR EX SEPARATION DISTANCI	TERIOR WALLS BASED ON FIRI FIRE R		OPAQUE ELEMEN
	X < 5' 5' <= X < 10'		1 HC 1 HC	OUR OUR	ROOFS
	10' <= X < 30' X >= 30'		0 HC 0 HC		INSULATI DECK METAL BI
					ATTIC AN WALLS (ABO
	SMOKE PROTECTION FE				MASS METAL BI
TABLE 705.2	MINIMUM DISTANCE OF PRO				STEEL-FF WOOD-FI WALLS (BEL
TABLE 705.8	MAXIMUM AREA OF WALL O 0 TO LESS THAN 3'	UNPROT	SD AND OPENING PROTECTION FECTED, NON-SPRINKLERED RMITTED	N PROTECTED NOT PERMITTED	FLOORS MASS
	3 TO LESS THAN 5' 5 TO LESS THAN 10'		RMITTED	NOT PERMITTED 15% 25%	STEEL JO WOOD FF
	10 TO LESS THAN 10 10 TO LESS THAN 15' 15 TO LESS THAN 20'	15% 25%		45% 75%	SLAB-ON-GR HEATED
	20 TO LESS THAN 25' 25 TO LESS THAN 30'	45% 70%	_	NO LIMIT NO LIMIT	UNHEATE OPAQUE DO SWINGIN
	30' OR GREATER		Í	NO LIMIT	NON-SWI
705.8.1		NO LIMIT	ION 2. BLIII DINGS WHOSE EVE	FRIOR REARING WALLS	
705.8.1	ALLOWABLE AREA OF OPEN	NINGS EXCEPT EXTERIO STRUCT	TION 2: BUILDINGS WHOSE EXT OR NONBEARING WALLS AND E TURAL FRAME ARE NOT REQUI SHALL BE PERMITTED TO HAVE	EXTERIOR PRIMARY RED TO BE FIRE-RESISTANCE	FENESTRATION
	ALLOWABLE AREA OF OPEN	NINGS EXCEPT EXTERIO STRUCT RATED S OPENING	OR NONBEARING WALLS AND E TURAL FRAME ARE NOT REQUI SHALL BE PERMITTED TO HAVE GS.	EXTERIOR PRIMARY RED TO BE FIRE-RESISTANCE	FENESTRATION VERTICAL (0 FIXED OPERABL
705.8.1 705.11		NINGS EXCEPT EXTERIO STRUCT RATED S OPENING EXCEPT WALL NO ACCORE	OR NONBEARING WALLS AND E TURAL FRAME ARE NOT REQUI SHALL BE PERMITTED TO HAVE GS. TION 1: OT REQUIRED TO BE FIRE-RES DANCE WITH TABLE 602 BECAL	EXTERIOR PRIMARY RED TO BE FIRE-RESISTANCE E UNLIMITED UNPROTECTED ISTANCE RATED IN	VERTICAL (0 FIXED OPERABL ENTRANC
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705.11	ALLOWABLE AREA OF OPEN PARAPETS FIRE WALL FIRE RESISTANCE FIRE BARRIER ASSEMBLIES	NINGS EXCEPT EXTERIO STRUCT RATED S OPENING EXCEPT WALL NO ACCORE DISTANO EXCEPT WALL NO ACCORE DISTANO THOUR,	OR NONBEARING WALLS AND E TURAL FRAME ARE NOT REQUI SHALL BE PERMITTED TO HAVE GS. TION 1: OT REQUIRED TO BE FIRE-RES DANCE WITH TABLE 602 BECAL	EXTERIOR PRIMARY RED TO BE FIRE-RESISTANCE E UNLIMITED UNPROTECTED ISTANCE RATED IN ISE OF FIRE SEPARATION	VERTICAL (0 FIXED OPERABL ENTRANC SKYLIGHT (0 CI = CONTINI FC = FILLED NR = NO REC
705.11 TABLE 706.4 TABLE 707.3.10	PARAPETS FIRE WALL FIRE RESISTANCE FIRE BARRIER ASSEMBLIES HORIZONTAL ASSEMBLIES IFIRE AREAS	NINGS EXCEPT EXTERIO STRUCT RATED S OPENING EXCEPT WALL NO ACCORD DISTANO CE N/A 1 HOUR, BTWN	OR NONBEARING WALLS AND ETURAL FRAME ARE NOT REQUISHALL BE PERMITTED TO HAVE GS. TION 1: OT REQUIRED TO BE FIRE-REST DANCE WITH TABLE 602 BECAUTE.	EXTERIOR PRIMARY RED TO BE FIRE-RESISTANCE E UNLIMITED UNPROTECTED ISTANCE RATED IN ISE OF FIRE SEPARATION	VERTICAL (0 FIXED OPERABL ENTRANC SKYLIGHT (0 CI = CONTINI FC = FILLED NR = NO REC
705.11 TABLE 706.4	PARAPETS FIRE WALL FIRE RESISTANCE FIRE BARRIER ASSEMBLIES HORIZONTAL ASSEMBLIES	NINGS EXCEPT EXTERIO STRUCT RATED S OPENING EXCEPT WALL NO ACCORE DISTANO S AND 1 HOUR, BTWN 1 HOUR	OR NONBEARING WALLS AND ETURAL FRAME ARE NOT REQUISHALL BE PERMITTED TO HAVE GS. TION 1: OT REQUIRED TO BE FIRE-REST DANCE WITH TABLE 602 BECAUTE.	EXTERIOR PRIMARY RED TO BE FIRE-RESISTANCE E UNLIMITED UNPROTECTED ISTANCE RATED IN ISE OF FIRE SEPARATION HAN 4 STORIES	VERTICAL (0 FIXED OPERABL ENTRANC SKYLIGHT (0 CI = CONTINI FC = FILLED NR = NO REC NA = NOT AF
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705.11 TABLE 706.4 TABLE 707.3.10 SECTION 708	PARAPETS FIRE WALL FIRE RESISTANCE FIRE BARRIER ASSEMBLIES HORIZONTAL ASSEMBLIES IF FIRE AREAS FIRE PARTITIONS	NINGS EXCEPT EXTERIO STRUCT RATED S OPENING EXCEPT WALL NO ACCORD DISTANO OF NIA 1 HOUR, 1/2 HOU NOT REG	OR NONBEARING WALLS AND E TURAL FRAME ARE NOT REQUI SHALL BE PERMITTED TO HAVE GS. TION 1: OT REQUIRED TO BE FIRE-RES DANCE WITH TABLE 602 BECAL CE. INTERIOR EXIT STAIR LESS TH	EXTERIOR PRIMARY RED TO BE FIRE-RESISTANCE E UNLIMITED UNPROTECTED ISTANCE RATED IN ISE OF FIRE SEPARATION HAN 4 STORIES	VERTICAL (0 FIXED OPERABL ENTRANC SKYLIGHT (0 CI = CONTINI FC = FILLED NR = NO REC NA = NOT AF
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CHAPTER 10: MEANS OF EGRESS

APPLICABLE STANDARDS

INSULATION ENTIRELY ABOVE

METAL BUILDINGS

ATTIC AND OTHER

WALLS (ABOVE GRADE)

METAL BUILDINGS

WOOD-FRAMED / OTHER

WOOD FRAMED / OTHER

VERTICAL (0% - 40% OF WALL ALLOWED)

SKYLIGHT (0% - 3% OF ROOF ALLOWED)

CHAPTER 29: PLUMBING FIXTURES

CI = CONTINUOUS INSULATION FC = FILLED CAVITY

SLAB-ON-GRADE FLOORS

ENTRANCE DOOR

NR = NO REQUIREMENT NA = NOT APPLICABLE

WALLS (BELOW GRADE)

CHAPTER 11: ACCESSIBILITY

OCCUPANT LOAD (OL)

STAIRWAY EGRESS CAPACITY FACTOR

OTHER EGRESS CAPACITY FACTOR

MAX OCCUPANT LOAD FOR ONE EXIT

MAX OCCUPANT LOAD PER STORY

MIN NUMBER OF EXITS FOR STORY

STORIES WITH ONE EXIT FOR R-2

EXIT ACCESS TRAVEL DISTANCE

MINIMUM CORRIDOR WIDTH

NUMBER OF TYPE A UNITS

2010 ADA STANDARDS FOR ACCESSIBLE DESIGN - TITLE II

FHA SAFE HARBOR DESIGN DOCUMENT: IBC 2018

ASSEMBLY MAX.

N/A

U-0.021

U-0.090

N/A

N/A

U-0.064

C-0.092

N/A

U-0.033

F-0.520

U-0.370

N/A

U-0.45

U-0.63

TOTAL UNITS

REQUIRED

0.36

0.33

0.33

MAX U MAX SHGC MIN VTI/SHGC

2% OF UNITS WITH COMMUNICATION FEATURES 184 x 2% = 0 UNITS

CHAPTER 13: ENERGY EFFICIENCY 2021 OREGON ENERGY EFFICIENCY SPECIALTY CODE (OEESC)

REQUIRED

FAIR HOUSING ACCESSIBILITY GUIDELINES

OHCS CORE DEVELOPMENT MANUAL

5% OF UNITS WITH MOBILITY FEATURES

SECTION 1107.7

ADDITIONAL ACCESSIBILITY REQUIREMENTS

SECTION 504

ANSI ICC A117.1 - 2009

DEAD ENDS

CORRIDOR FIRE-RESISTANCE RATING

TOTAL SPACES PROVIDED:

ACCESSIBLE SPACES REQUIRED:

ACCESSIBLE SPACES PROVIDED: VAN ACCESSIBLE SPACES REQUIRED :

VAN ACCESSIBLE SPACES PROVIDED:

WHEELCHAIR ONLY SPACES PROVIDED:

MAX COMMON PATH OF EGRESS TRAVEL 125 FT

SEE OCCUPANT LOAD TABLE

4 UNITS / 125 FT TRAVEL DISTANCE / UP TO 3 STORIES EMERGENCY ESCAPE AND RESCUE OPENINGS PER 1030

44 INCHES * 36 INCHES WITHIN DWELLING UNIT OR WHERE

*LENGTH IS NOT LIMITED WHERE LENGTH < 2.5x WIDTH

REQUIRED FOR STORIES WITH ONE EXIT

0.2

500

250 FT

OCCUPANT LOAD <50

R-2 OCCUPANCIES WITH ACCESSIBLE, TYPE A OR TYPE B UNITS, AT LEAST 2% OF EACH TYPE OF PARKING PROVIDED SHALL BE ACCESSIBLE

WHEELCHAIR ONLY SPACES REQUIRED: 1 PER 101-200 SPACES

TYPE A UNITS REQUIRED (TOTAL FOR SITE): 184 x 2% = 4 UNITS

TYPE A UNITS PROVIDED (TOTAL FOR SITE): 0 UNITS TYPE A UNITS PROVIDED (THIS BUILDING): 2 UNITS

163

R-2 OCCUPANCIES WITH GREATER THAN 20 DWELLING UNITS SHALL PROVIDE MINIMUM 2% TYPE A UNITS. ALL R-2 UNITS ON A SITE SHALL BE CONSIDERED TO DETERMINE TOTAL NUMBER OF UNITS AND REQUIRED

WHERE THERE ARE FOUR OR MORE DWELLING UNITS, ALL UNITS SHALL BE TYPE B UNITS AT A MINIMUM

THE NUMBER OF TYPE A AND TYPE B UNITS IS PERMITTED TO BE REDUCED IN ACCORDANCE WITH

184 x 5% = 0 UNITS

MIN. R-VALUE

N/A

R-49

R-11.4 CI

N/A

N/A

R-13 + 3.8 CI OR R-20

R-10 CI

N/A

R-30

R-15 FOR 24"

1 WC / LAV / Tub or Shower per unit required and provided

1.10

1.10

1.10

MAX U

163 x 2% = 4

1 PER 6 ACCESSIBLE SPACES

PROVIDED

R-49

R-23

R-30


R-15 FOR 24"

U-0.370

MAX SHGC MIN VTI/SHGC

PROVIDED

20 OCCUPANTS

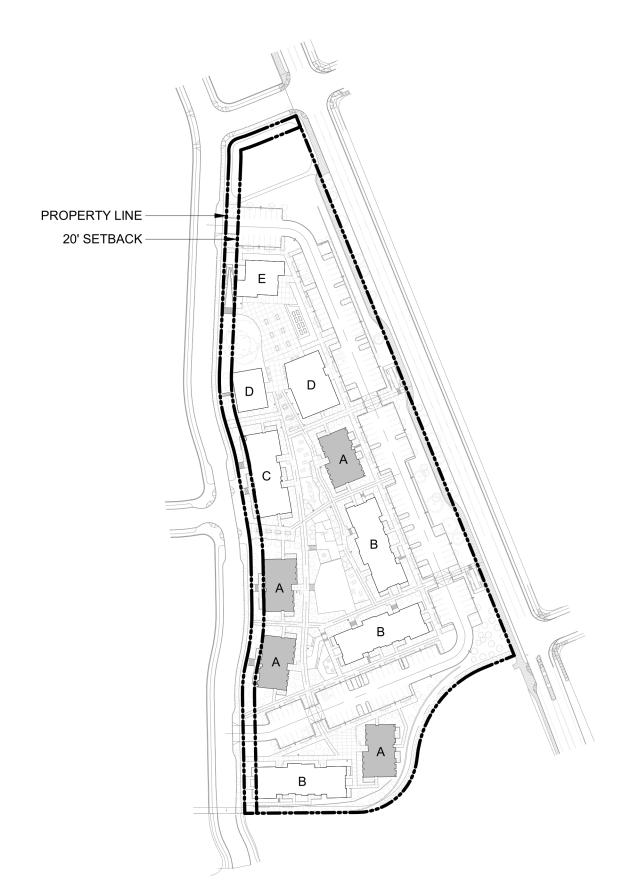

SITE PLAN - ZONING DIAGRAM



702.020 MULTIPLE FAMILY DESIGN REVIEW STANDARDS

SECTION	REQUIRMENT MET OR ADJUSTMENT REQUESTED	SHEET NUMBER		
SITE SAFETY & SECURITY				
702.020.c.1	REQUIREMENT MET	A2.11-A2.13		
702.020.c.2	REQUIREMENT MET	A3.01-A3.02		
FACADE & BUILDING DESIGN				
702.020.e.1	REQUIREMENT MET	A2.11-A2.14		
702.020.e.8	REQUIREMENT MET	A3.02		
702.020.e.9	ADJUSTMENT REQUESTED	A3.01		
702.020.e.10	REQUIREMENT MET	A3.01-A3.02		





CDP SALEM -BUILDING A Job Number: **5205 BATTLE CREEK RD SE**

SALEM, OR 97306



LAND USE SUBMISSION

Drawing:

CODE SUMMARY

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ESE DRAWINGS ARE THE ORIGINAL THE ARCHITECT AND MAY NOT BE THOUT THE WRITTEN CONSENT OF

REQUIRED CLEAR FLOOR AREAS

AREA

30" x 48" CENTERED

ON URINAL

FIG. 604.3 SIZE OF CLEARANCE FOR WATER CLOSET

OTHER FIXTURES NOT

ALLOWED WITHIN THIS

(c) HINGE APPROACH PULL SIDE

(e) HINGE APPROACH PUSH SIDE

¦ □>

* IF BOTH CLOSER AND

LATCH ARE PROVIDED

** 48" MIN IF BOTH CLOSER AND LATCH ARE PROVIDED

ALCOVE: PARALLEL APPROACH

TURNING SPACE: CIRCULAR

TURNING SPACE: T-SHAPED

48" MIN

+-----i

REQUIRED FLOOR AREA

12" 36" MIN

MIN

60" MIN

A. VERIFY ALL ACCESSIBILITY REQUIREMENTS WITH CURRENT CODE AND LOCAL JURISDICATION. B. DIAGRAMS ARE INCLUDED AS A CONVENIENCE ONLY AND ARE NOT ALL INCLUSIVE. REFERENCE CURRENT CODE AND PROJECT DOCUMENTS FOR ADDITIONAL REQUIREMENTS.

NOTIFY ARCHITECT OF ANY DISCREPANCIES BETWEEN DIMENSIONS SHOWN HERE AND PROPOSED WORK.

ABBREVIATIONS

(b) FRONT APPROACH PUSH SIDE 42" MIN.

(d) HINGE APPROACH PULL SIDE

(f) LATCH APPROACH PULL SIDE


* 54" MIN IF CLOSER IS PROVIDED

- UNIVERSAL HC SYMBOL PAINTED HIGHWAY WHITE (TWO COATS) - BACKGROUND PAINTED BLUE TO MATCH COLOR #15090 IN FED. STD. 595A


REFERENCE ONLY

GRID SHOWN FOR * 48" MIN IF CLOSER IS (g) LATCH APPROACH PUSH SIDE

STANDARD MOUNTING HEIGHTS AND CLEARANCE REQUIREMENTS DIMENSIONS ARE FROM FACE OF FINISH AND/OR CENTERLINE OF FIXTURE OR ACCESSORY 18" 8" MIN KNEE HIGH - INSULATED + + PIPE WRAP ACCESSIBLE TOILET AND GRAB BARS LAVATORY TOILET ROOM ACCESSORIES 8" TYP. @ DOORS FIRE STROBE SIGNAGE FIRE EXTINGUISHER COAT HOOK DRINKING FOUNTAIN SPOUT ELECTRICAL DEVICES AND CONTROLS SIGNAGE

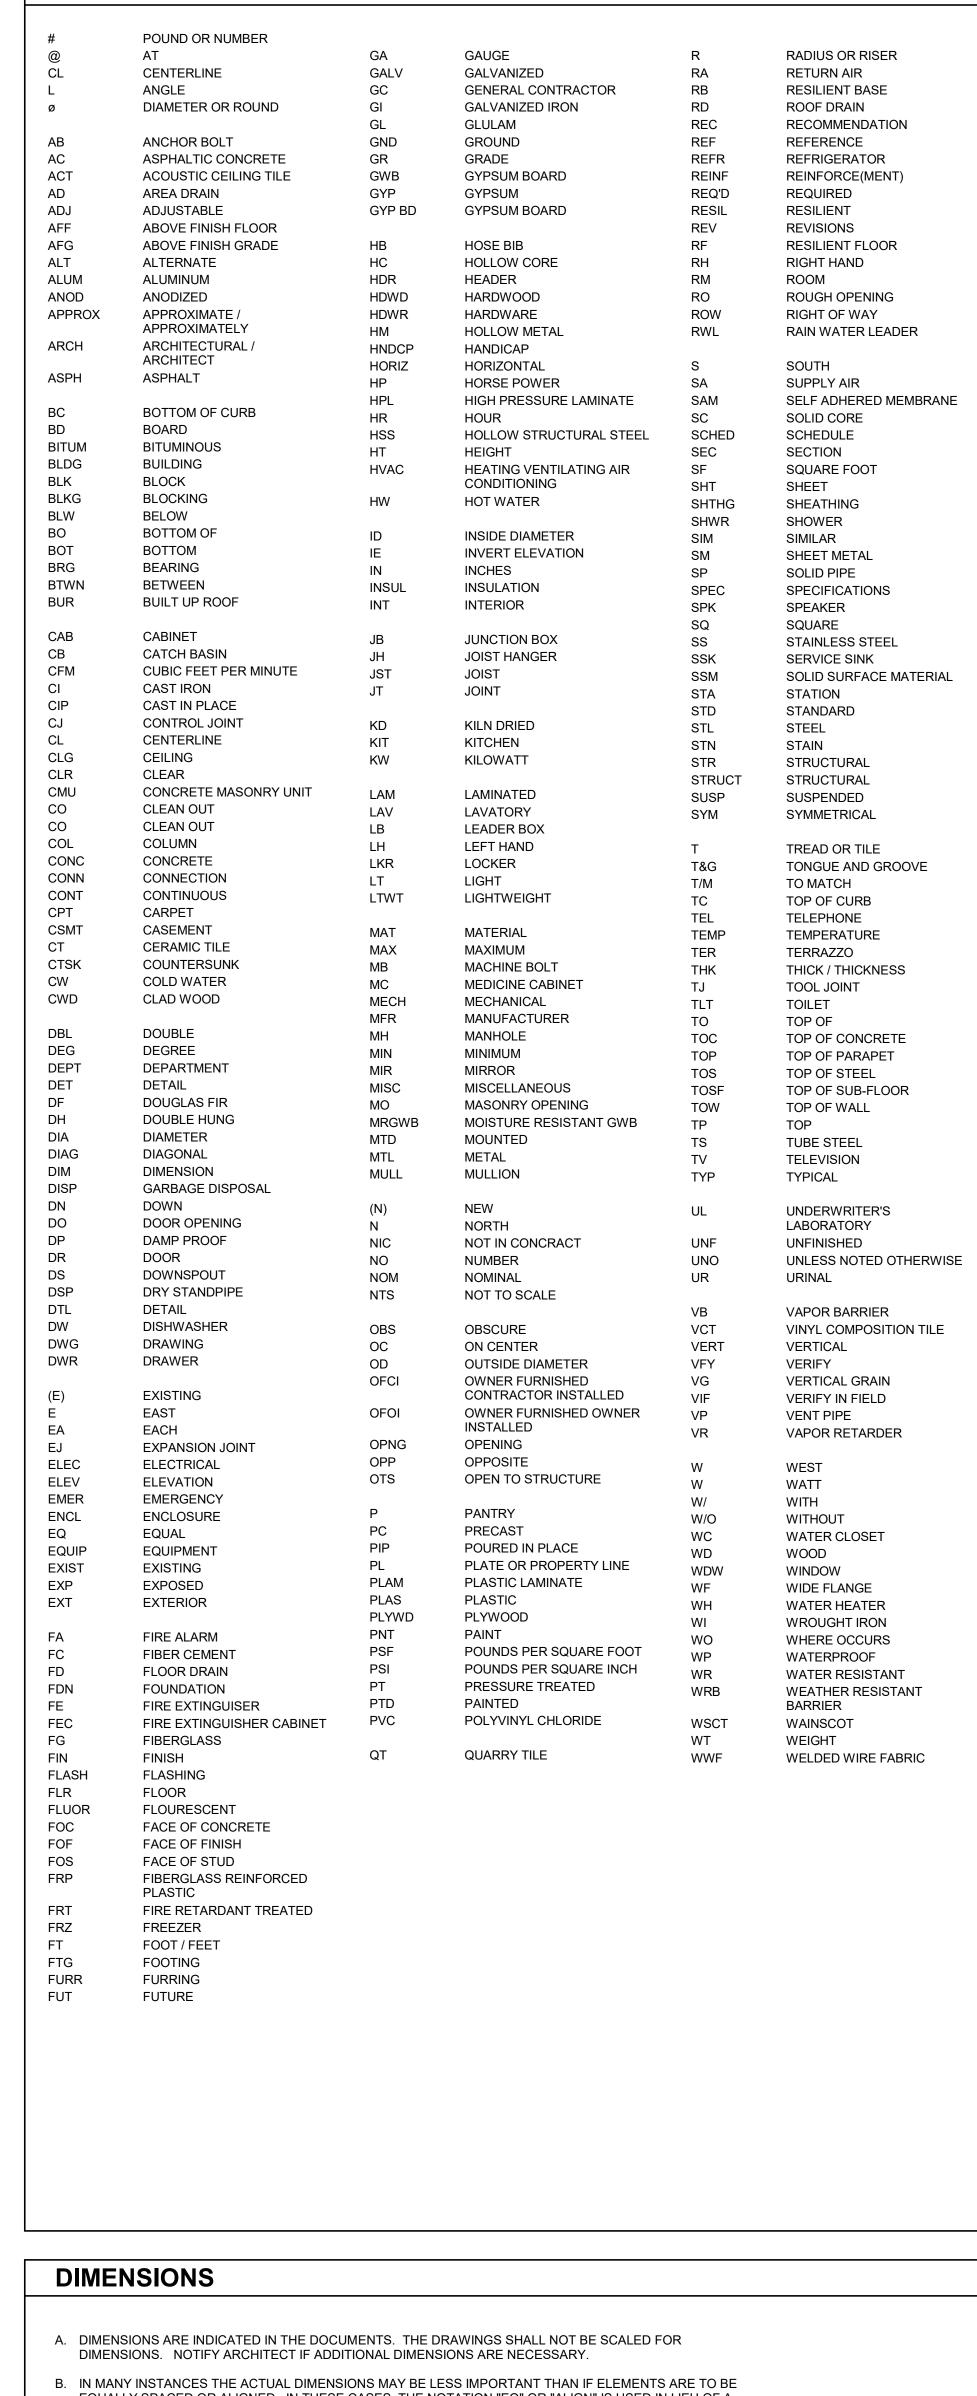

- EQUALLY SPACED OR ALIGNED. IN THESE CASES, THE NOTATION "EQ" OR "ALIGN" IS USED IN LIEU OF A
- C. DETAILS WILL GOVERN ALL DIMENSIONS NOT SHOWN ON PLANS. REFERENCE INDICATED DIMENSION
- D. DIMENSIONS SHOWN ARE TO GRIDLINE, CENTERLINE OF COLUMN, OR FACE OF STUD / MASONRY, UNLESS NOTED OTHERWISE.
- E. INTERIOR WALLS WHICH ARE EQUALLY SPACED ARE DIMENSIONED TO CENTERLINE OF WALL. F. DOORS NOT LOCATED BY DIMENSION SHALL BE CENTERED IN WALLS AS SHOWN ON PLANS OR LOCATED

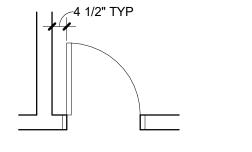

4 1/2" FROM FACE OF FINISH TO ROUGH OPENING.



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CDP SALEM -**BUILDING A**

Partners

Job Number: **5205 BATTLE CREEK RD SE SALEM, OR 97306**

VERTICAL DATUM

GRID LINE

NORTH ARROW

NAME_ ELEVATION - -

ROOM NAME AND NUMBER

NAME

101

GRAPHIC SYMBOLS

(1)— - — - —

NORTH

EXTERIOR ELEVATION

- DRAWING NUMBER \A3.01/-- SHEET NUMBER

BUILDING SECTION / WALL SECTION

- DRAWING NUMBER \A4.01/ — — SHEET NUMBER

INTERIOR ELEVATION

⊸ DRAWING NUMBER — SHEET NUMBER DETAIL CALLOUT

- DRAWING NUMBER - SHEET NUMBER DOOR NUMBER - ROOM NUMBER — DOOR (101A)--

CEILING HEIGHT - CEILING HEIGHT ABOVE LEVEL - ACCENT PAINT **COLOR WHERE** OCCURS WALL / ASSEMBLY TYPE - CONFIGURATION

FLOOR / FLOOR-CEILING ASSEMBLY [F-#] CEILING ASSEMBLY [C-#] ROOF / ROOF-CEILING ASSEMBLY [R-#] - ASSEMBLY CATEGORY — ASSEMBLY NUMBER

— WALL TYPE

- MODIFIERS

WINDOW TYPE ACCESSORY / EQUIPMENT TYPE

1 CASEWORK TYPE MATERIAL / FINISH

- MATERIAL TYPE - MATERIAL NUMBER SPOT ELEVATION X'-X" ── HEIGHT ABOVE LEVEL

X'-X" TC ─ TOP OF CURB HEIGHT X'-X" BC
 BOTTOM OF CURB


KEYNOTE - SPECIFICATION DIVISION NUMBER REVISION


NOTE NUMBER REVISION NUMBER

- REVISION DOCUMENT


LAND USE 01.11.2021 SUBMISSION ISSUE DATE Drawing: ARCHITECTURAL

GENERAL NOTES AND DIAGRAMS

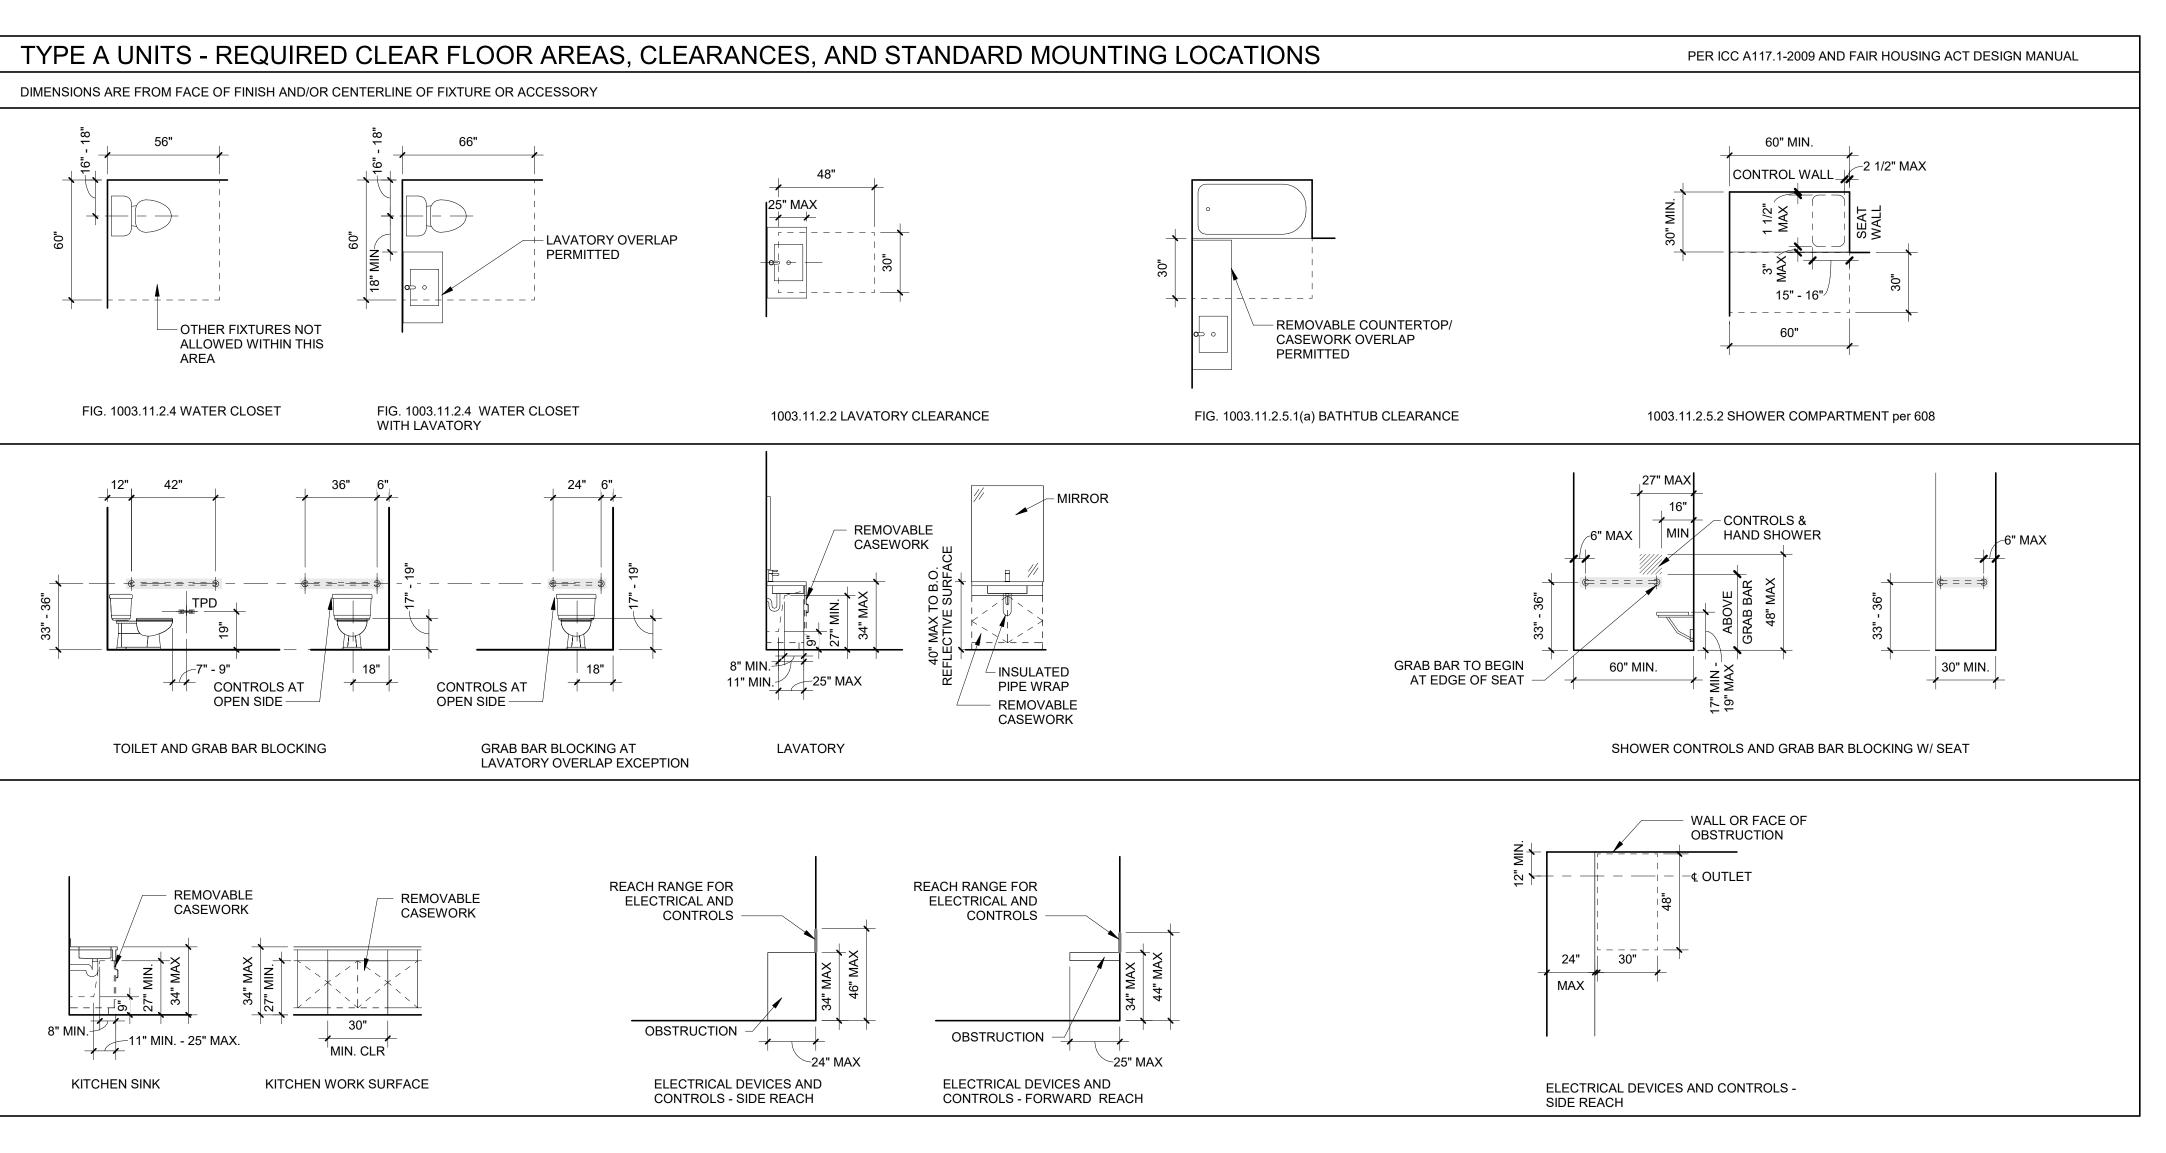

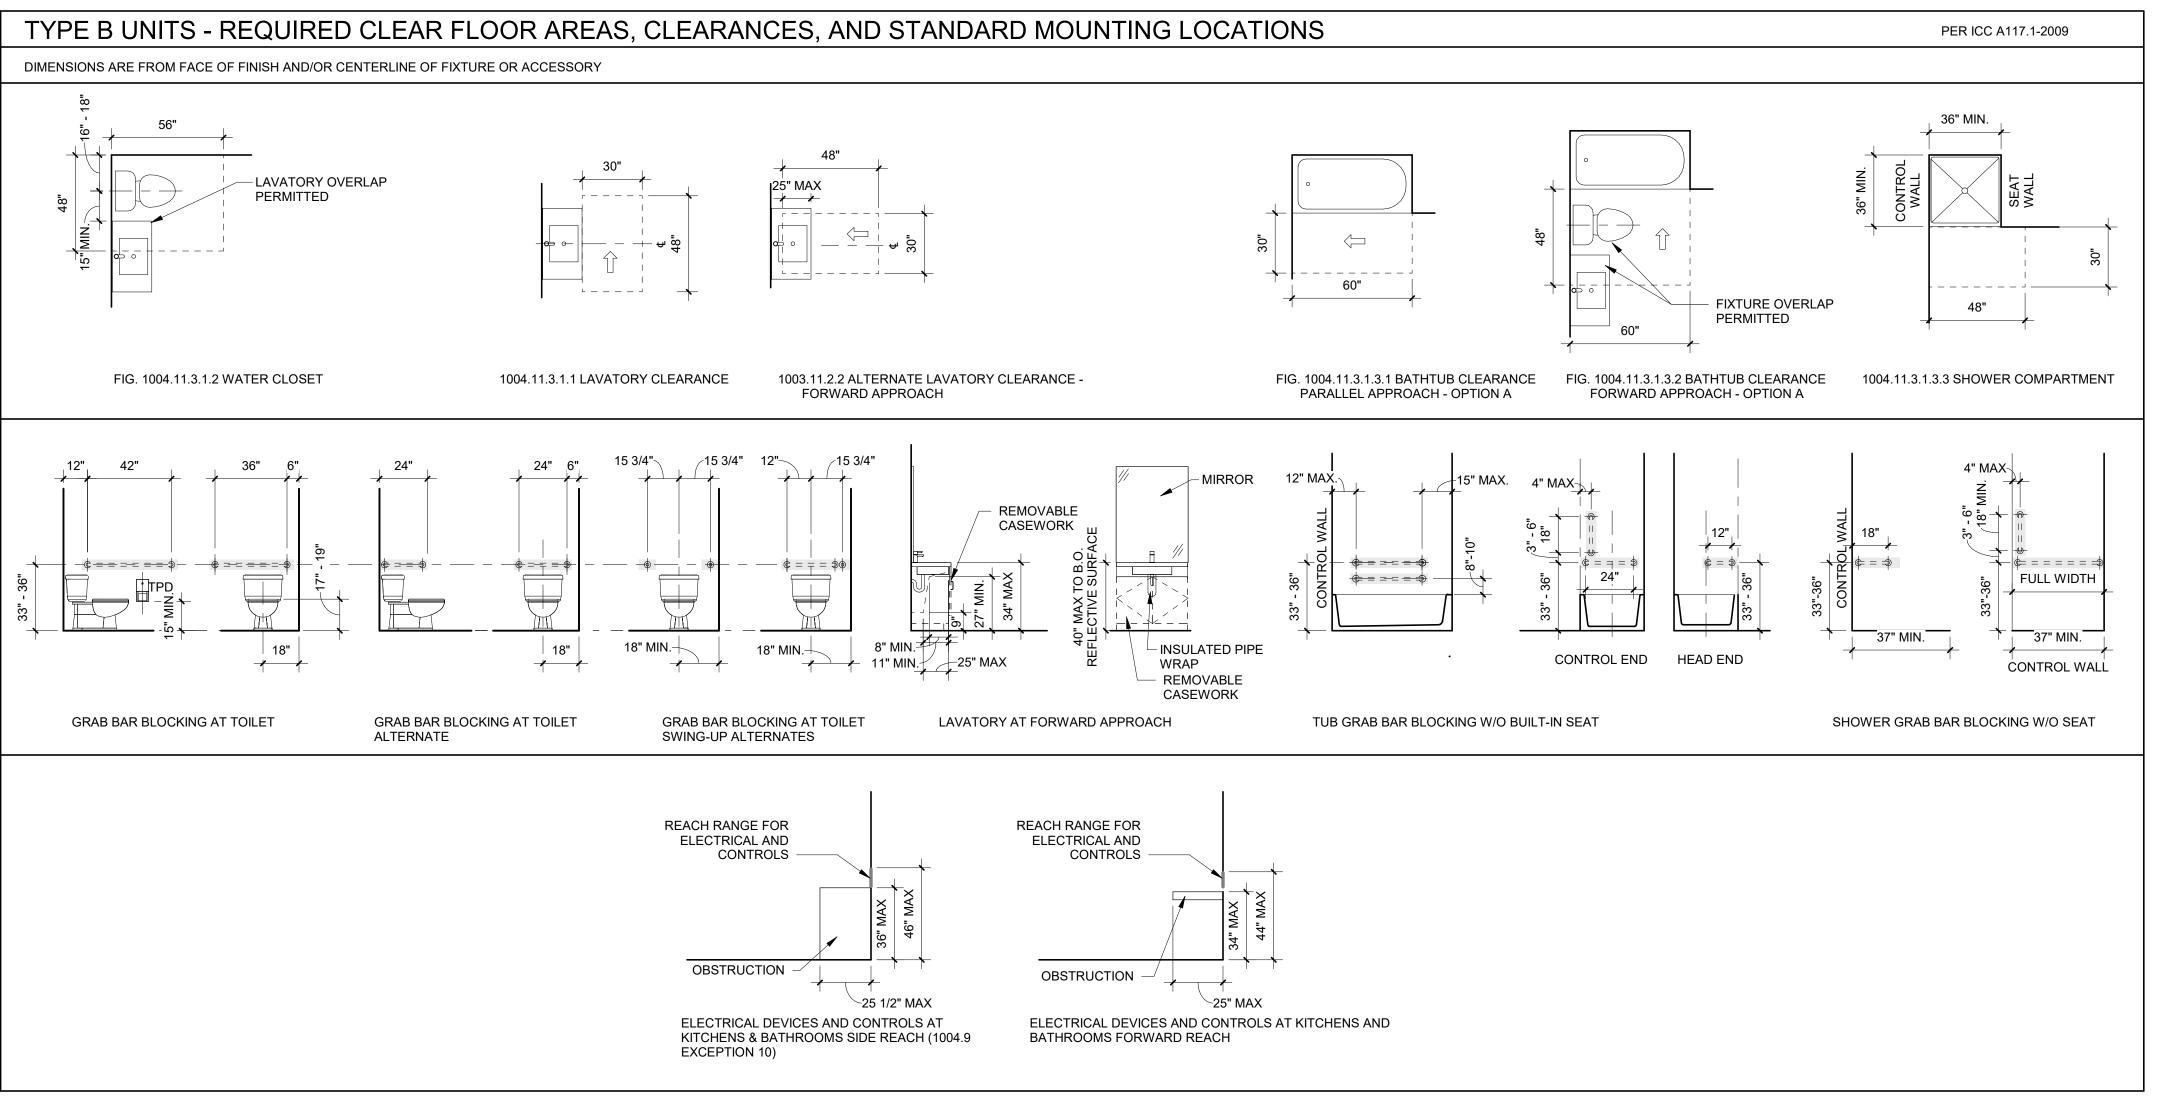



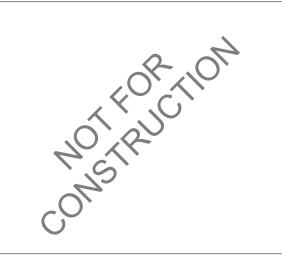

CDP SALEM -BUILDING A Job Number:

5205 BATTLE CREEK RD SE

SALEM, OR 97306



LAND USE SUBMISSION ISSUE

Drawing:

ACCESSIBILITY DIAGRAMS -**RESIDENTIAL**

01.11.2021

PER ARCH

GENERAL SHEET NOTES

A. REFERENCE DETAILS FOR ASSEMBLIES NOT SHOWN HERE. B. SEE FINISH SCHEDULE, INTERIOR ELEVATIONS, AND DETAILS FOR SPECIAL CONDITIONS AND


APPLIED WALL FINISHES. MAINTAIN FIRE RATING OF WALLS AROUND FIRE EXTINGUISHERS, CABINETS, AND OTHER RECESSED ITEMS.

PER ARCH

- PROVIDE ACOUSTICAL SEALANT AT FLOOR / CEILING/ WALL TRANSITIONS, RECESSED BOXES, AND PENETRATIONS OF SOUND RATED ASSEMBLIES AND OTHER CONSTRUCTION AS REQUIRED TO ACHIEVE NOTED STC RATINGS.
- PROVIDE MOISTURE RESISTANT GYPSUM BOARD TYPICAL AT ALL RESTROOMS, BATHROOMS, AND KITCHEN WALLS. ALL FRAMING AND FINISHES OF INTERIOR WALLS TO EXTEND TO THE UNDERSIDE OF STRUCTURE ABOVE UNLESS NOTED OTHERWISE. WHERE PARTITIONS ARE SOUND RATED OR FIRE
- RATED AND INCLUDE PROPRIETARY MANUFACTURERS, NO SUBSTITUTIONS ARE H. ALL WOOD IN CONTACT WITH CONCRETE OR

ABBREVIATIONS

MASONRY TO BE PRESSURE TREATED. AT WALLS WITH RESILIENT CHANNELS SEE DETAIL FOR ASSEMBLY DETAILS.

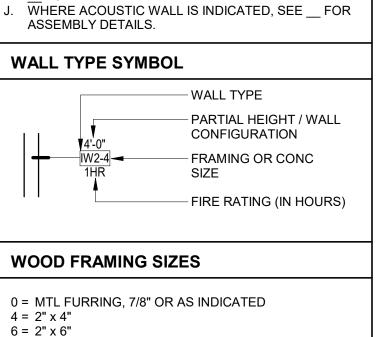

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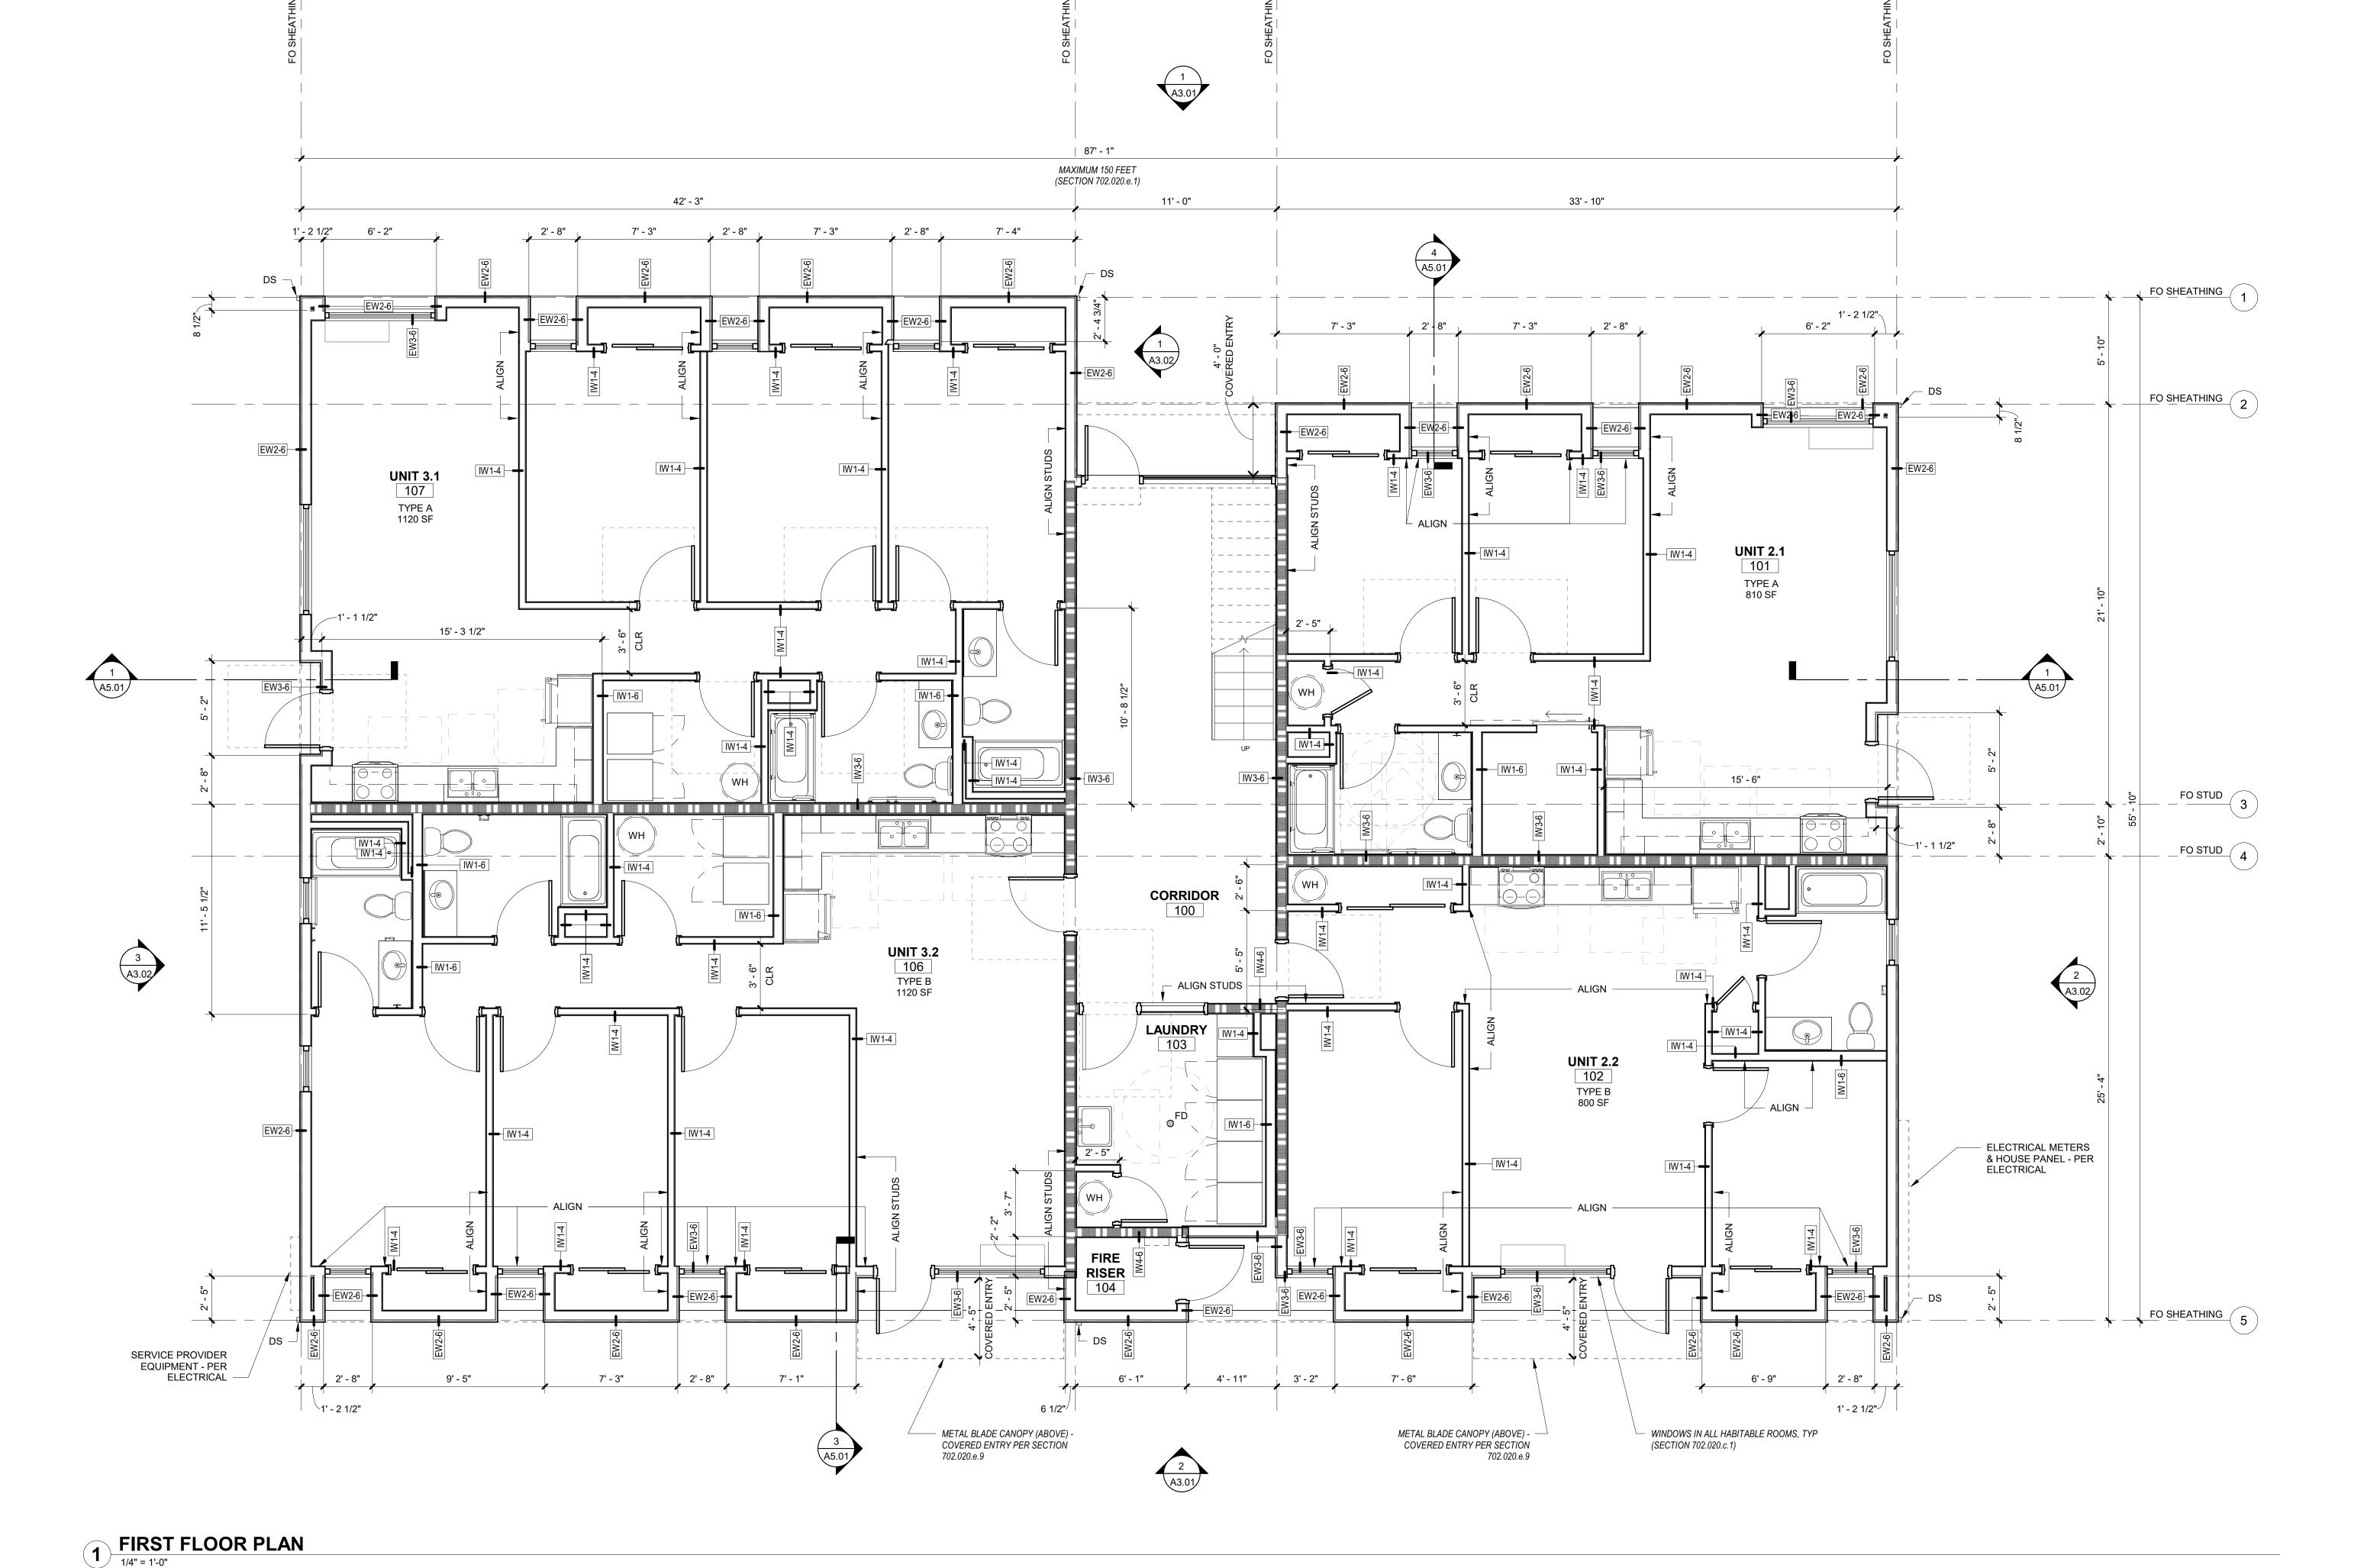
Development Partners

LAND USE **SUBMISSION** ISSUE

DATE Drawing:


01.11.2021

ASSEMBLIES



GENERAL SHEET NOTES

- A. WALL DIMENSIONS ARE FROM FACE OF STUD OR CL OF COLUMN U.N.O. B. ALL EXTERIOR GRID LINES SHOWN ARE TO FACE
- OF SHEATHING U.N.O. ALL INTERIOR GRID LINES
 ARE TO FACE OF STUD U.N.O.
 C. ALL INTERIOR UNIT WALLS TO BE IW2-X. D. ALL DOOR AND WINDOW DIMENSIONS ARE TO CL OR OVERALL UNIT. REFERENCE SCHEDULES AND
- DOOR AND WINDOW TYPES E. REFERENCE STRUCTURAL DRAWINGS FOR GENERAL CONTROL JOINTS @ SLAB. COORDINATE
- FINAL LOCATIONS WITH ARCHITECT COMPATIBILITY WITH FLOOR FINISHES SEE DOOR SCHEDULE FOR DOOR TYPES AND INSTALLATION DETAILS CORRESPONDING TO
- DOOR NUMBERS G. SEE WINDOW SCHEDULE FOR WINDOW TYPES
 H. FOR FLOOR FINISHES, SEE A10.21 SCHEDULES &
- FINISH LEGENDS. I. WIRE SHELVING IN ALL BEDROOM CLOSETSJ. M.E.P. INFORMATION PROVIDED FOR REFERENCE
- K. PROVIDE BLOCKING FOR FUTURE GRAB BARS AT ALL UNIT RESTROOMS WHERE GRAB BARS ARE NOT SHOWN IN PLAN, REF ACCESSIBILITY DIAGRAMS FOR LOCATIONS
- FIRE EXTINGUISHER TO BE PLACED IN PANTRY IN ALL UNITS
- M. DOWNSPOUTS PAINTED IN FIELD, RECTANGLE SHAPE AND SIZE PER PLUMBING AND CIVIL

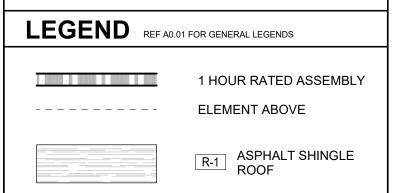


2x3 FLAT STYPE

DOWNSPOUT FLOOR DRAIN WATER HEATER WITH FLOOR DRAIN BELOW -SEE PLUMBING DWGS

KEYNOTES (07-02)

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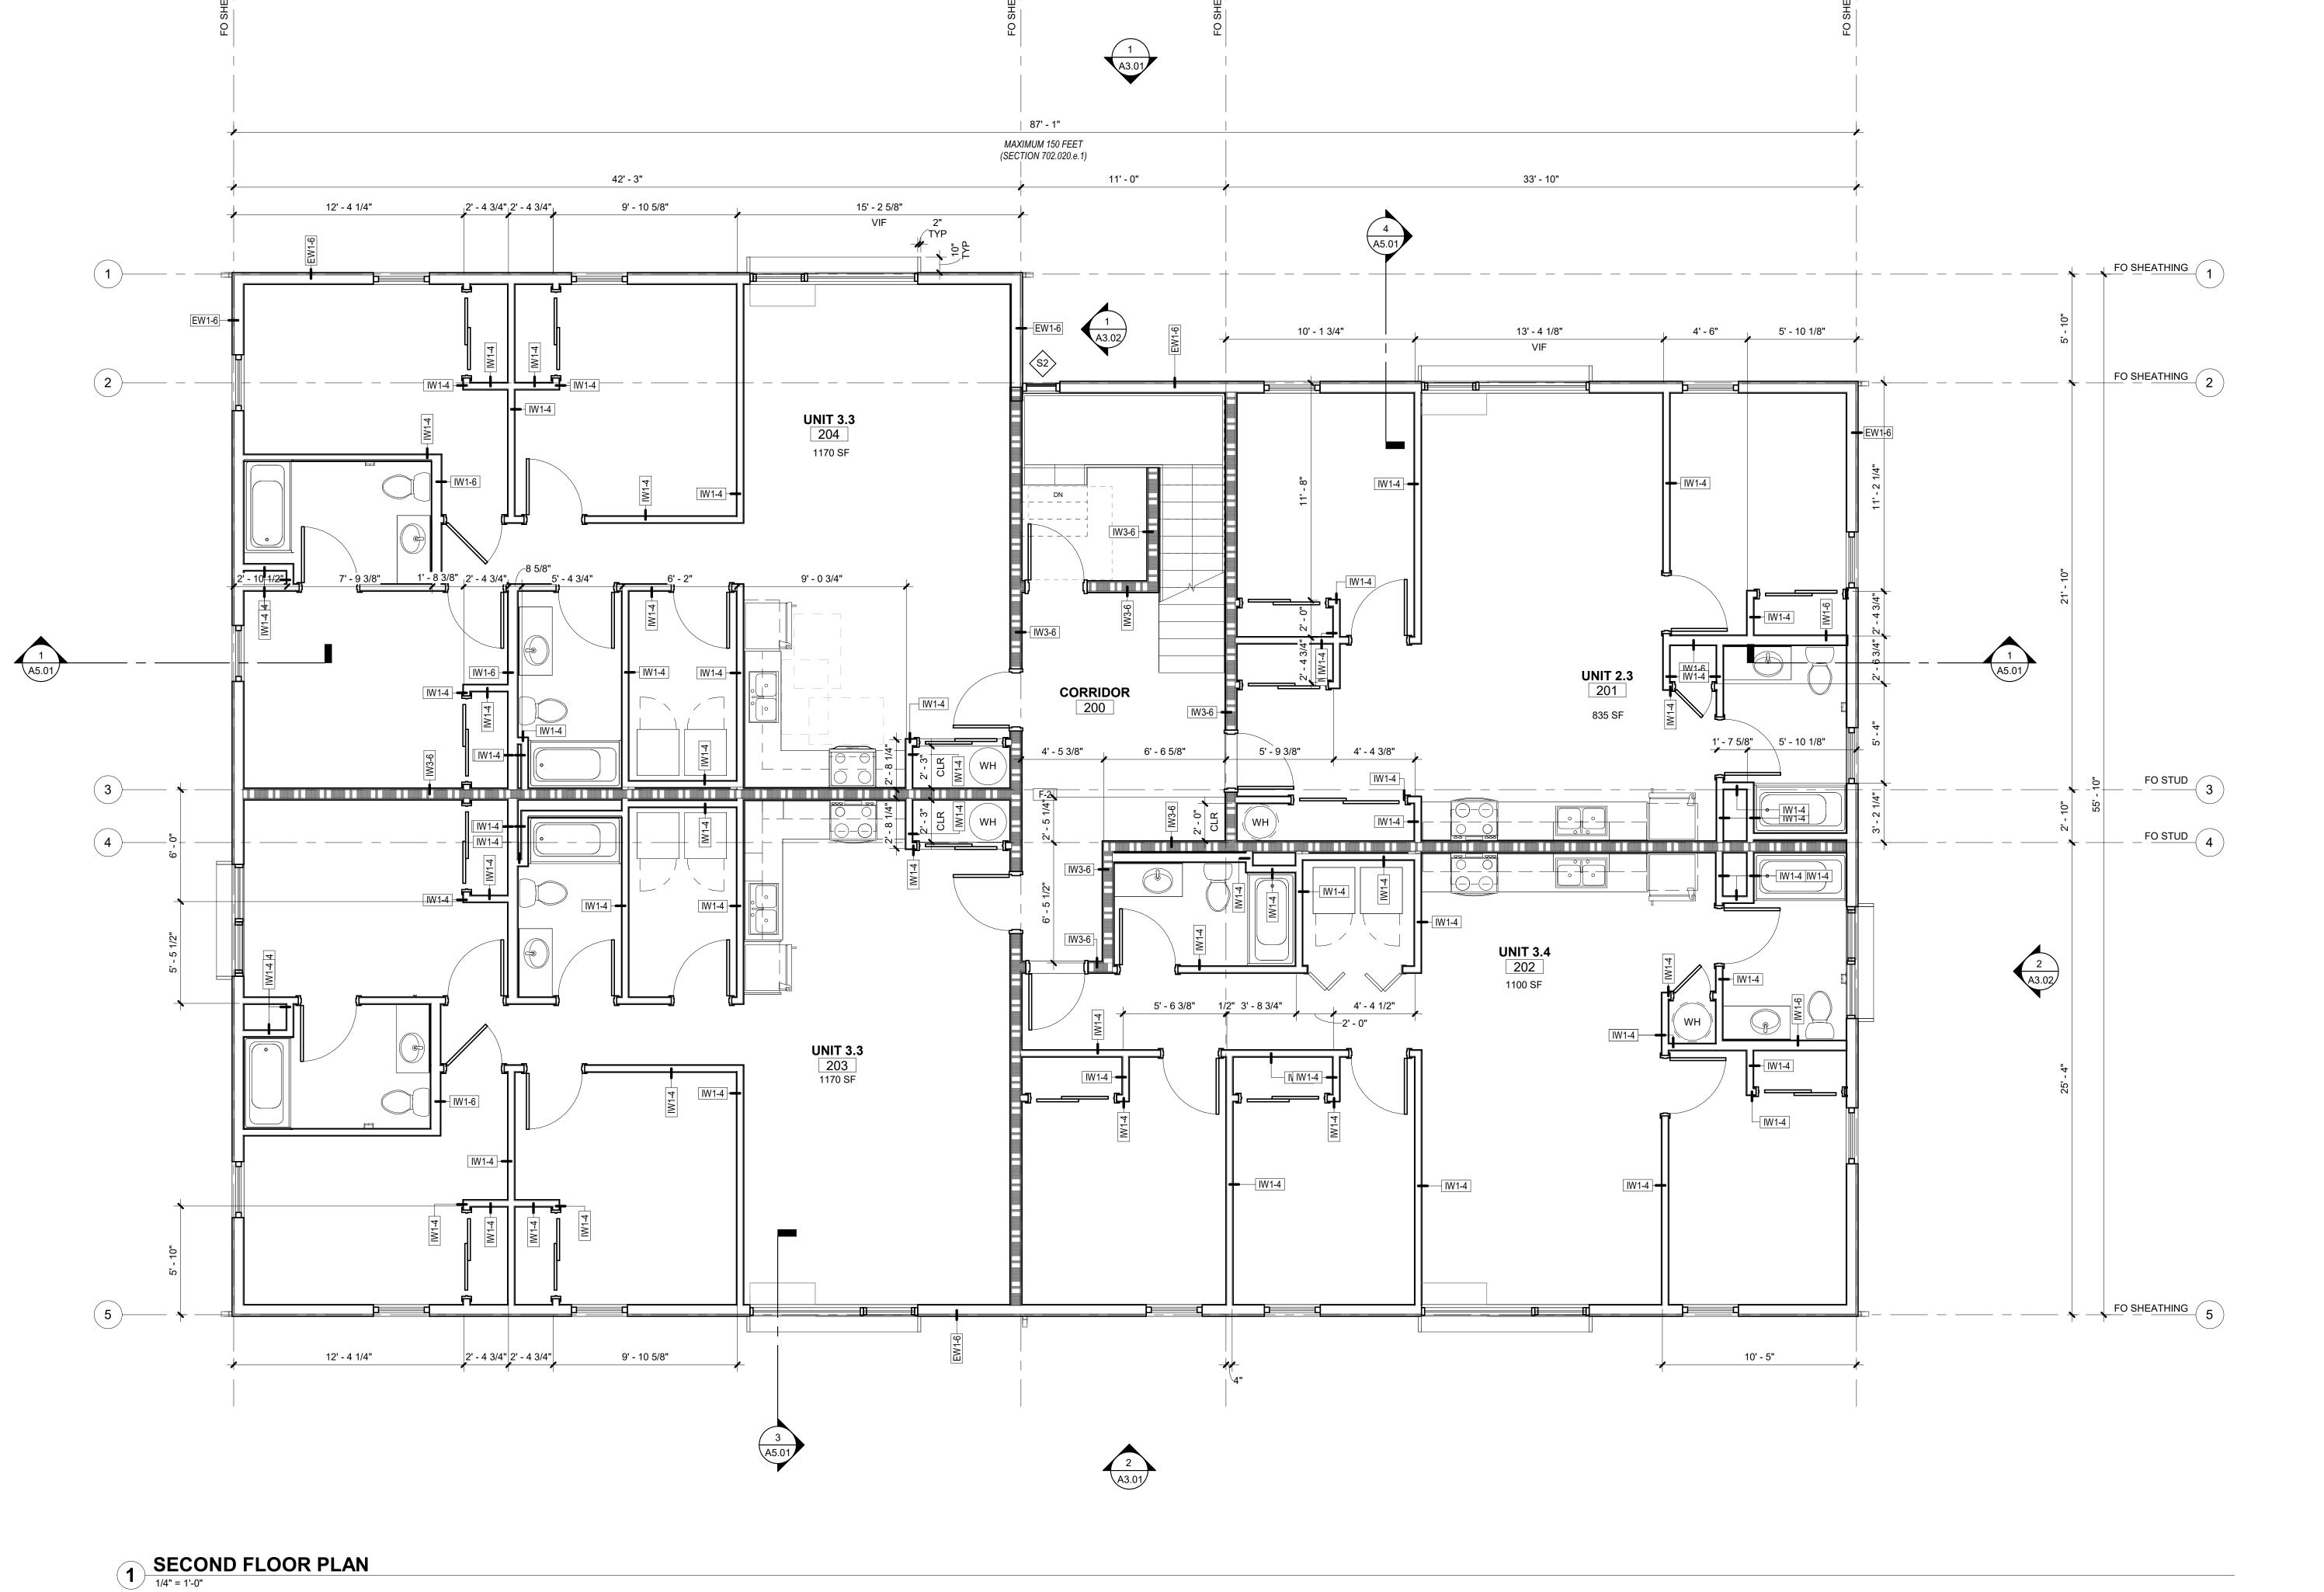


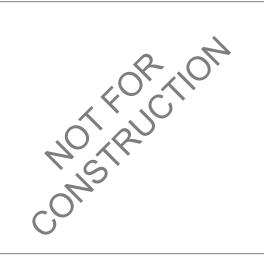LAND USE SUBMISSION ISSUE

Drawing:

FIRST FLOOR PLAN

01.11.2021



GENERAL SHEET NOTES

- A. WALL DIMENSIONS ARE FROM FACE OF STUD OR CL OF COLUMN U.N.O.
- B. ALL EXTERIOR GRID LINES SHOWN ARE TO FACE
 OF SHEATHING U.N.O. ALL INTERIOR GRID LINES
 ARE TO FACE OF STUD U.N.O.
 C. ALL INTERIOR UNIT WALLS TO BE IW2-X.
 D. ALL DOOR AND WINDOW DIMENSIONS ARE TO CL
- OR OVERALL UNIT. REFERENCE SCHEDULES AND DOOR AND WINDOW TYPES

 E. REFERENCE STRUCTURAL DRAWINGS FOR
 GENERAL CONTROL JOINTS @ SLAB. COORDINATE
- FINAL LOCATIONS WITH ARCHITECT COMPATIBILITY WITH FLOOR FINISHES
- F. SEE DOOR SCHEDULE FOR DOOR TYPES AND INSTALLATION DETAILS CORRESPONDING TO DOOR NUMBERS
- G. SEE WINDOW SCHEDULE FOR WINDOW TYPES
 H. FOR FLOOR FINISHES, SEE A10.21 SCHEDULES & FINISH LEGENDS.
- I. WIRE SHELVING IN ALL BEDROOM CLOSETSJ. M.E.P. INFORMATION PROVIDED FOR REFERENCE
- K. PROVIDE BLOCKING FOR FUTURE GRAB BARS AT ALL UNIT RESTROOMS WHERE GRAB BARS ARE NOT SHOWN IN PLAN, REF ACCESSIBILITY DIAGRAMS FOR LOCATIONS

 L. FIRE EXTINGUISHER TO BE PLACED IN PANTRY IN
- ALL UNITS M. DOWNSPOUTS PAINTED IN FIELD, RECTANGLE

SHAPE AND SIZE PER PLUMBING AND CIVIL

LEGEND REF A0.01 FOR GENERAL LEGENDS 1 HOUR RATED ASSEMBLY **ELEMENT ABOVE** ----R-1 ASPHALT SHINGLE ROOF 2x3 FLAT STYPE DOWNSPOUT FLOOR DRAIN WATER HEATER WITH FLOOR DRAIN BELOW -SEE PLUMBING DWGS KEYNOTES (07-02)

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Drawing:


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DATE

SECOND FLOOR

PLAN



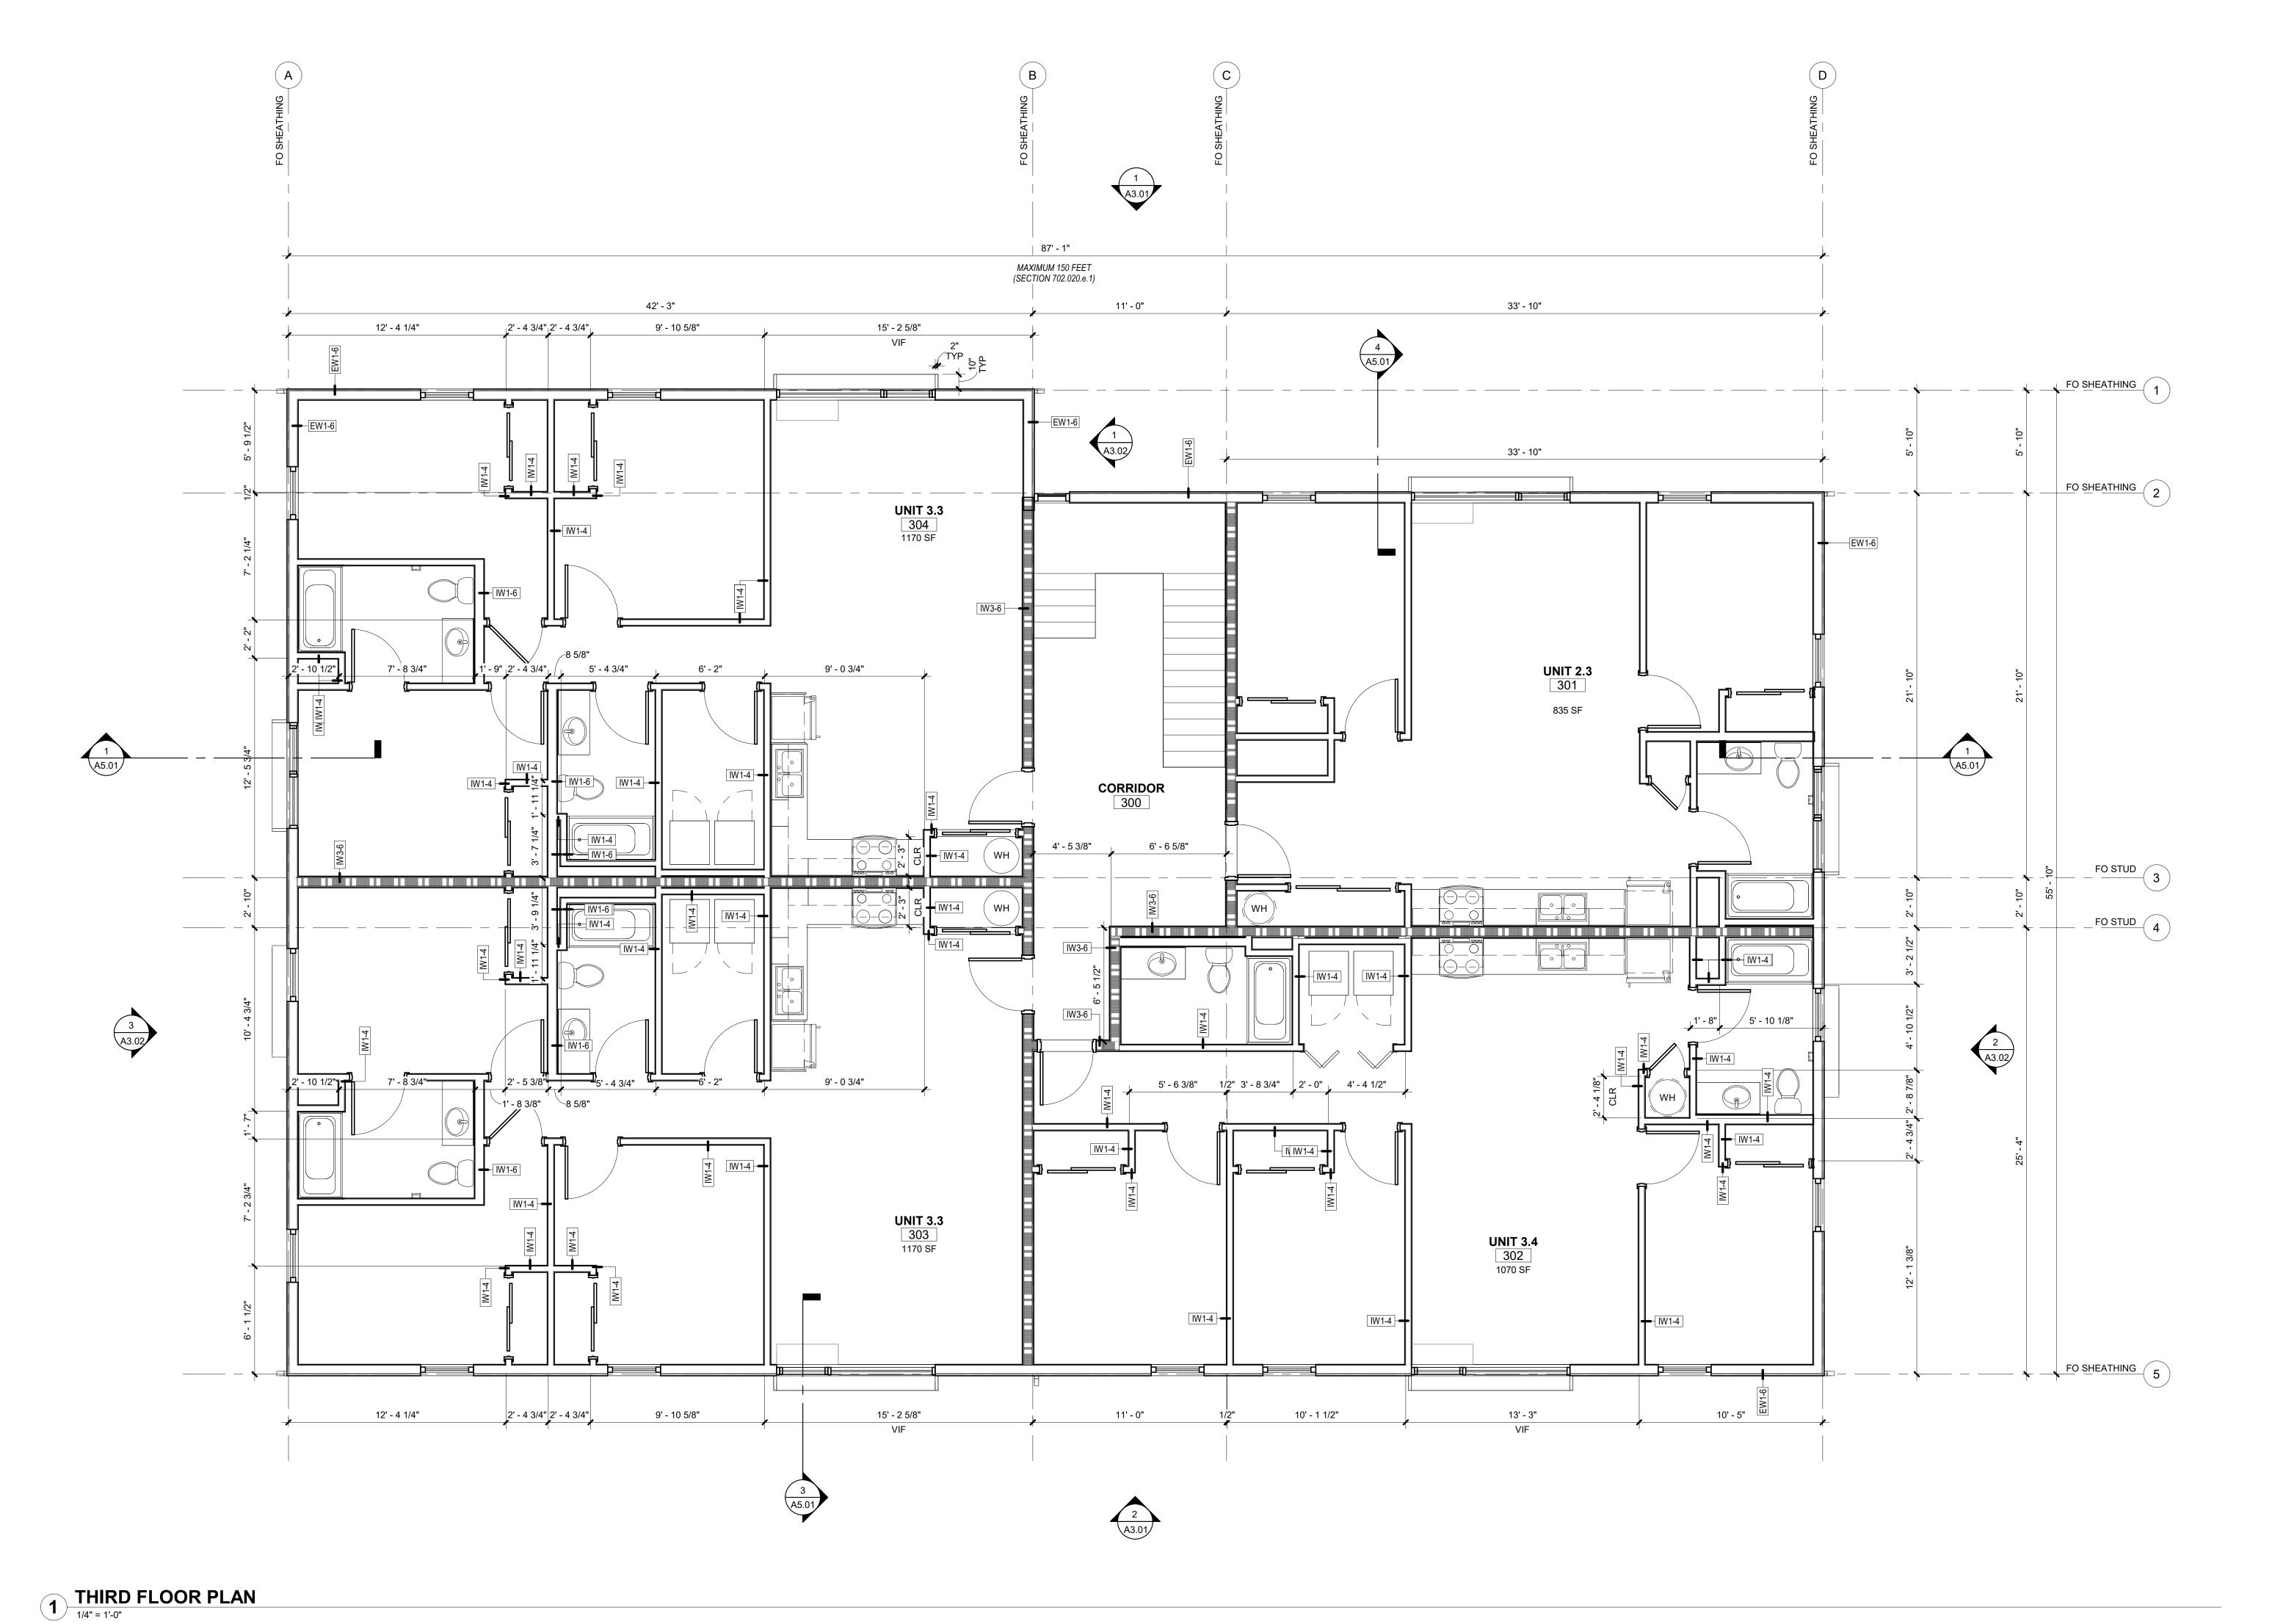

GENERAL SHEET NOTES

- A. WALL DIMENSIONS ARE FROM FACE OF STUD OR CL OF COLUMN U.N.O. B. ALL EXTERIOR GRID LINES SHOWN ARE TO FACE
 OF SHEATHING U.N.O. ALL INTERIOR GRID LINES
 ARE TO FACE OF STUD U.N.O.
 C. ALL INTERIOR UNIT WALLS TO BE IW2-X.
 D. ALL DOOR AND WINDOW DIMENSIONS ARE TO CL
- OR OVERALL UNIT. REFERENCE SCHEDULES AND
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- FINAL LOCATIONS WITH ARCHITECT COMPATIBILITY WITH FLOOR FINISHES F. SEE DOOR SCHEDULE FOR DOOR TYPES AND INSTALLATION DETAILS CORRESPONDING TO
- DOOR NUMBERS G. SEE WINDOW SCHEDULE FOR WINDOW TYPES
 H. FOR FLOOR FINISHES, SEE A10.21 SCHEDULES &
- I. WIRE SHELVING IN ALL BEDROOM CLOSETSJ. M.E.P. INFORMATION PROVIDED FOR REFERENCE
- K. PROVIDE BLOCKING FOR FUTURE GRAB BARS AT ALL UNIT RESTROOMS WHERE GRAB BARS ARE NOT SHOWN IN PLAN, REF ACCESSIBILITY DIAGRAMS FOR LOCATIONS

 L. FIRE EXTINGUISHER TO BE PLACED IN PANTRY IN
- ALL UNITS M. DOWNSPOUTS PAINTED IN FIELD, RECTANGLE SHAPE AND SIZE PER PLUMBING AND CIVIL

FINISH LEGENDS.

LEGEND REF A0.01 FOR GENERAL LEGENDS

1 HOUR RATED ASSEMBLY **ELEMENT ABOVE** ----R-1 ASPHALT SHINGLE ROOF 2x3 FLAT STYPE DOWNSPOUT FLOOR DRAIN WATER HEATER WITH

FLOOR DRAIN BELOW -SEE PLUMBING DWGS

KEYNOTES (07-02)

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LAND USE SUBMISSION ISSUE

Drawing:

THIRD FLOOR PLAN

01.11.2021

1 4 ROOF 1/4" = 1'-0"



- A. WALL DIMENSIONS ARE FROM FACE OF STUD OR CL OF COLUMN U.N.O.
 B. ALL EXTERIOR GRID LINES SHOWN ARE TO FACE OF SHEATHING U.N.O. ALL INTERIOR GRID LINES ARE TO FACE OF STUD U.N.O.
 C. ALL INTERIOR UNIT WALLS TO BE IW2-X.
 D. ALL DOOR AND WINDOW DIMENSIONS ARE TO CL OR OVERALL UNIT. REFERENCE SCHEDULES AND DOOR AND WINDOW TYPES
 E. REFERENCE STRUCTURAL DRAWINGS FOR GENERAL CONTROL JOINTS @ SLAB. COORDINATE FINAL LOCATIONS WITH ARCHITECT COMPATIBILITY WITH FLOOR FINISHES
 E. SEE DOOR SCHEDULE FOR DOOR TYPES AND
- F. SEE DOOR SCHEDULE FOR DOOR TYPES AND INSTALLATION DETAILS CORRESPONDING TO
- INSTALLATION DETAILS CORRESPONDING TO DOOR NUMBERS

 G. SEE WINDOW SCHEDULE FOR WINDOW TYPES


 H. FOR FLOOR FINISHES, SEE A10.21 SCHEDULES & FINISH LEGENDS.

 I. WIRE SHELVING IN ALL BEDROOM CLOSETS

 J. M.E.P. INFORMATION PROVIDED FOR REFERENCE
- K. PROVIDE BLOCKING FOR FUTURE GRAB BARS AT ALL UNIT RESTROOMS WHERE GRAB BARS ARE NOT SHOWN IN PLAN, REF ACCESSIBILITY DIAGRAMS FOR LOCATIONS

 L. FIRE EXTINGUISHER TO BE PLACED IN PANTRY IN
- ALL UNITS

 M. DOWNSPOUTS PAINTED IN FIELD, RECTANGLE
 SHAPE AND SIZE PER PLUMBING AND CIVIL

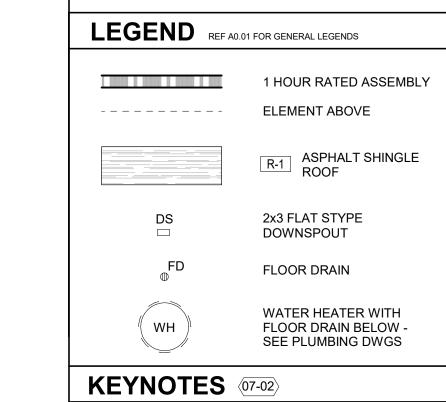

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CDP SALEM -

BUILDING A


Job Number:



LAND USE SUBMISSION ISSUE

> Drawing: ROOF

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ASPHALT SHINGLE ROOF **CDP SALEM -**(ASR) PRODUCT: TBD COLOR: TBD **BUILDING A** Job Number: **FLAT METAL PANEL** PRODUCT: TBD 5205 BATTLE CREEK RD SE SALEM, OR 97306 FINISH: BLACK FLAT METAL PANEL, PERFORATED PRODUCT: TBD FINISH: BLACK **VERTICAL WOOD SIDING** PRODUCT: TBD FINISH: TBD CONCRETE STEM WALL X-VENT PTHP (BEYOND) L _ _ _ _ J D P Community
Development
Partners EXTERIOR LIGHT FIXTURE -PROVIDED AT SOFFIT (SECTION 702.020.c.2) 1 BUILDING ELEVATION
1/4" = 1'-0"

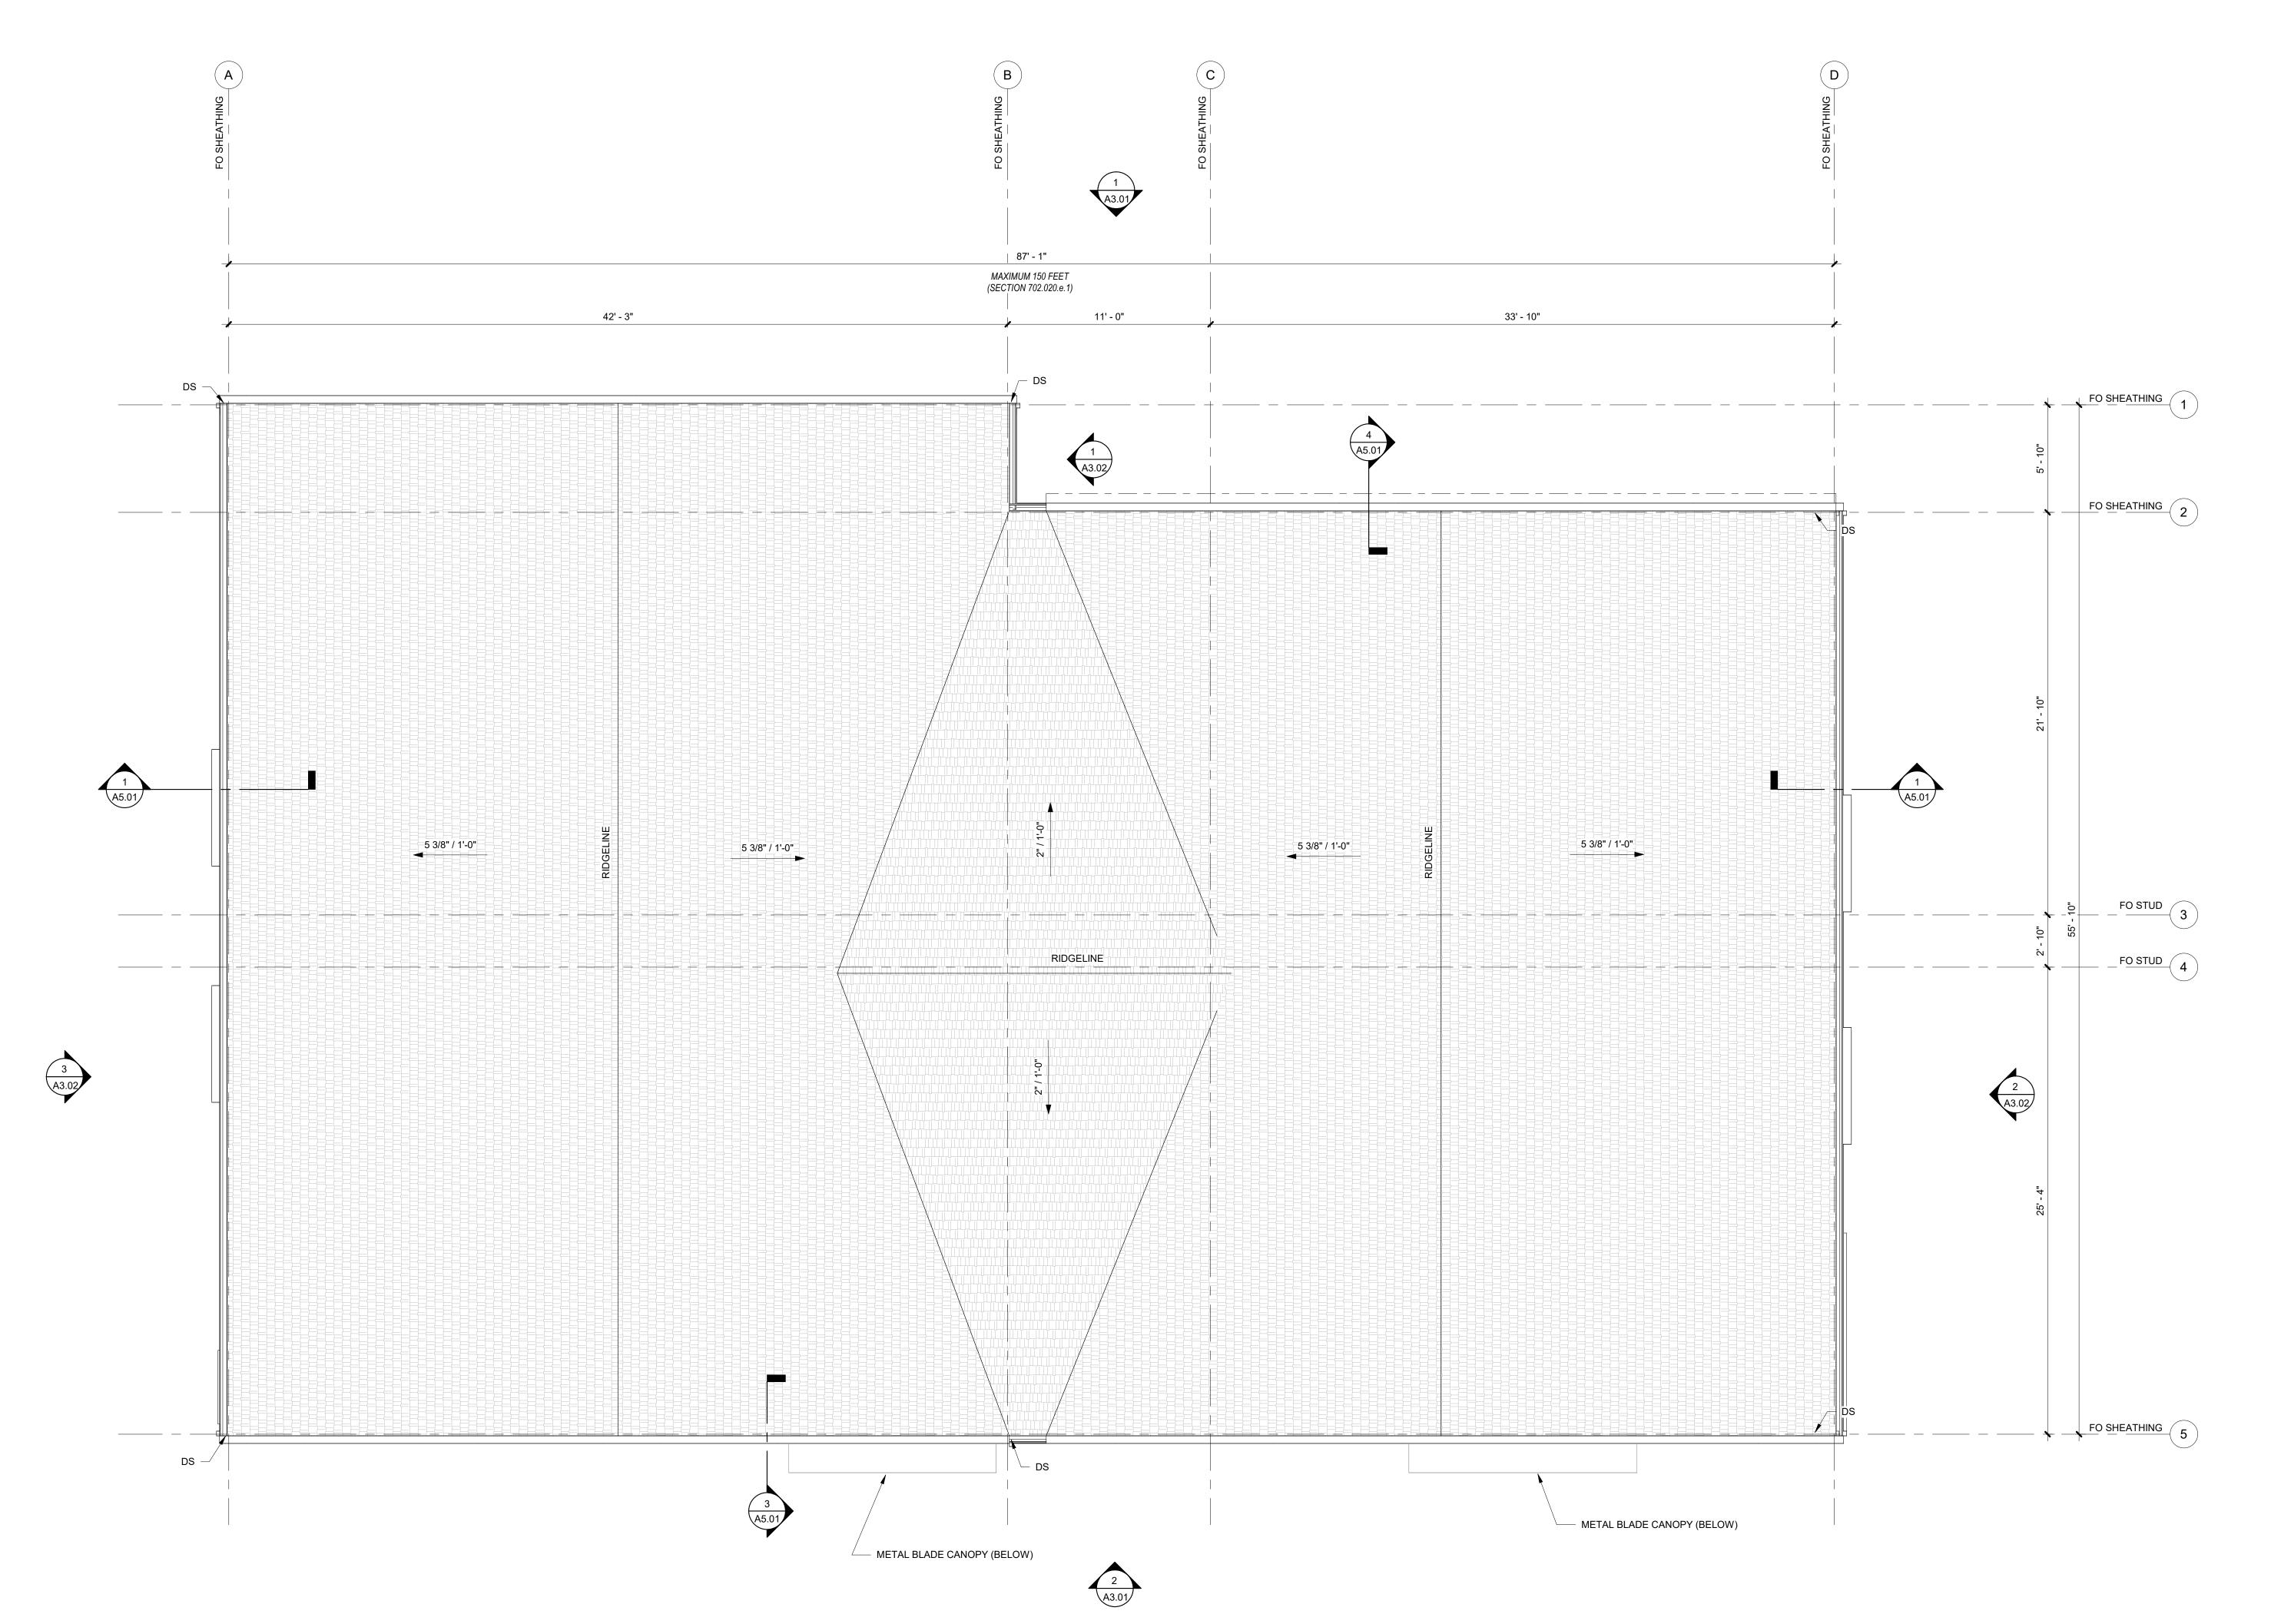

LAND USE SUBMISSION ISSUE

Drawing:

GENERAL SHEET NOTES

A. REFERENCE FLOOR PLANS FOR DOOR AND WINDOW LOCATIONS.B. REFERENCE ELECTRICAL FOR EXTERIOR LIGHT APPLICATIONS.

3'-0" FROM OPERABLE OPENINGS.

D. ALL EXTERIOR LOUVERS TO BE PAINTED TO MATCH THE EXTERIOR FINISH IT PENETRATES.

LEGEND

E. PREFINISHED 22 GAUGE FORMED SHEET METAL WINDOW TRIM, JAMB, AND SILL AT WINDOWS.

PREFINISHED 22 GAUGE METAL THROUGH WALL FLASHING AT WINDOW HEADS.
G. TRANSITION BETWEEN FIBER CEMENT SIDING

PROFILES TO FOLLOW MANUFACTURER DETAILING AND REQUIREMENTS.

SHINGLE SIDINGPRODUCT: SHINGLE SIDING,
STRAIGHT EDGE PANEL

COLOR: TBD, LIGHT


C. CONFIRM ALL EXHAUST OPENINGS ARE MINIMUM


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EXTERIOR ELEVATIONS 01.11.2021

DATE





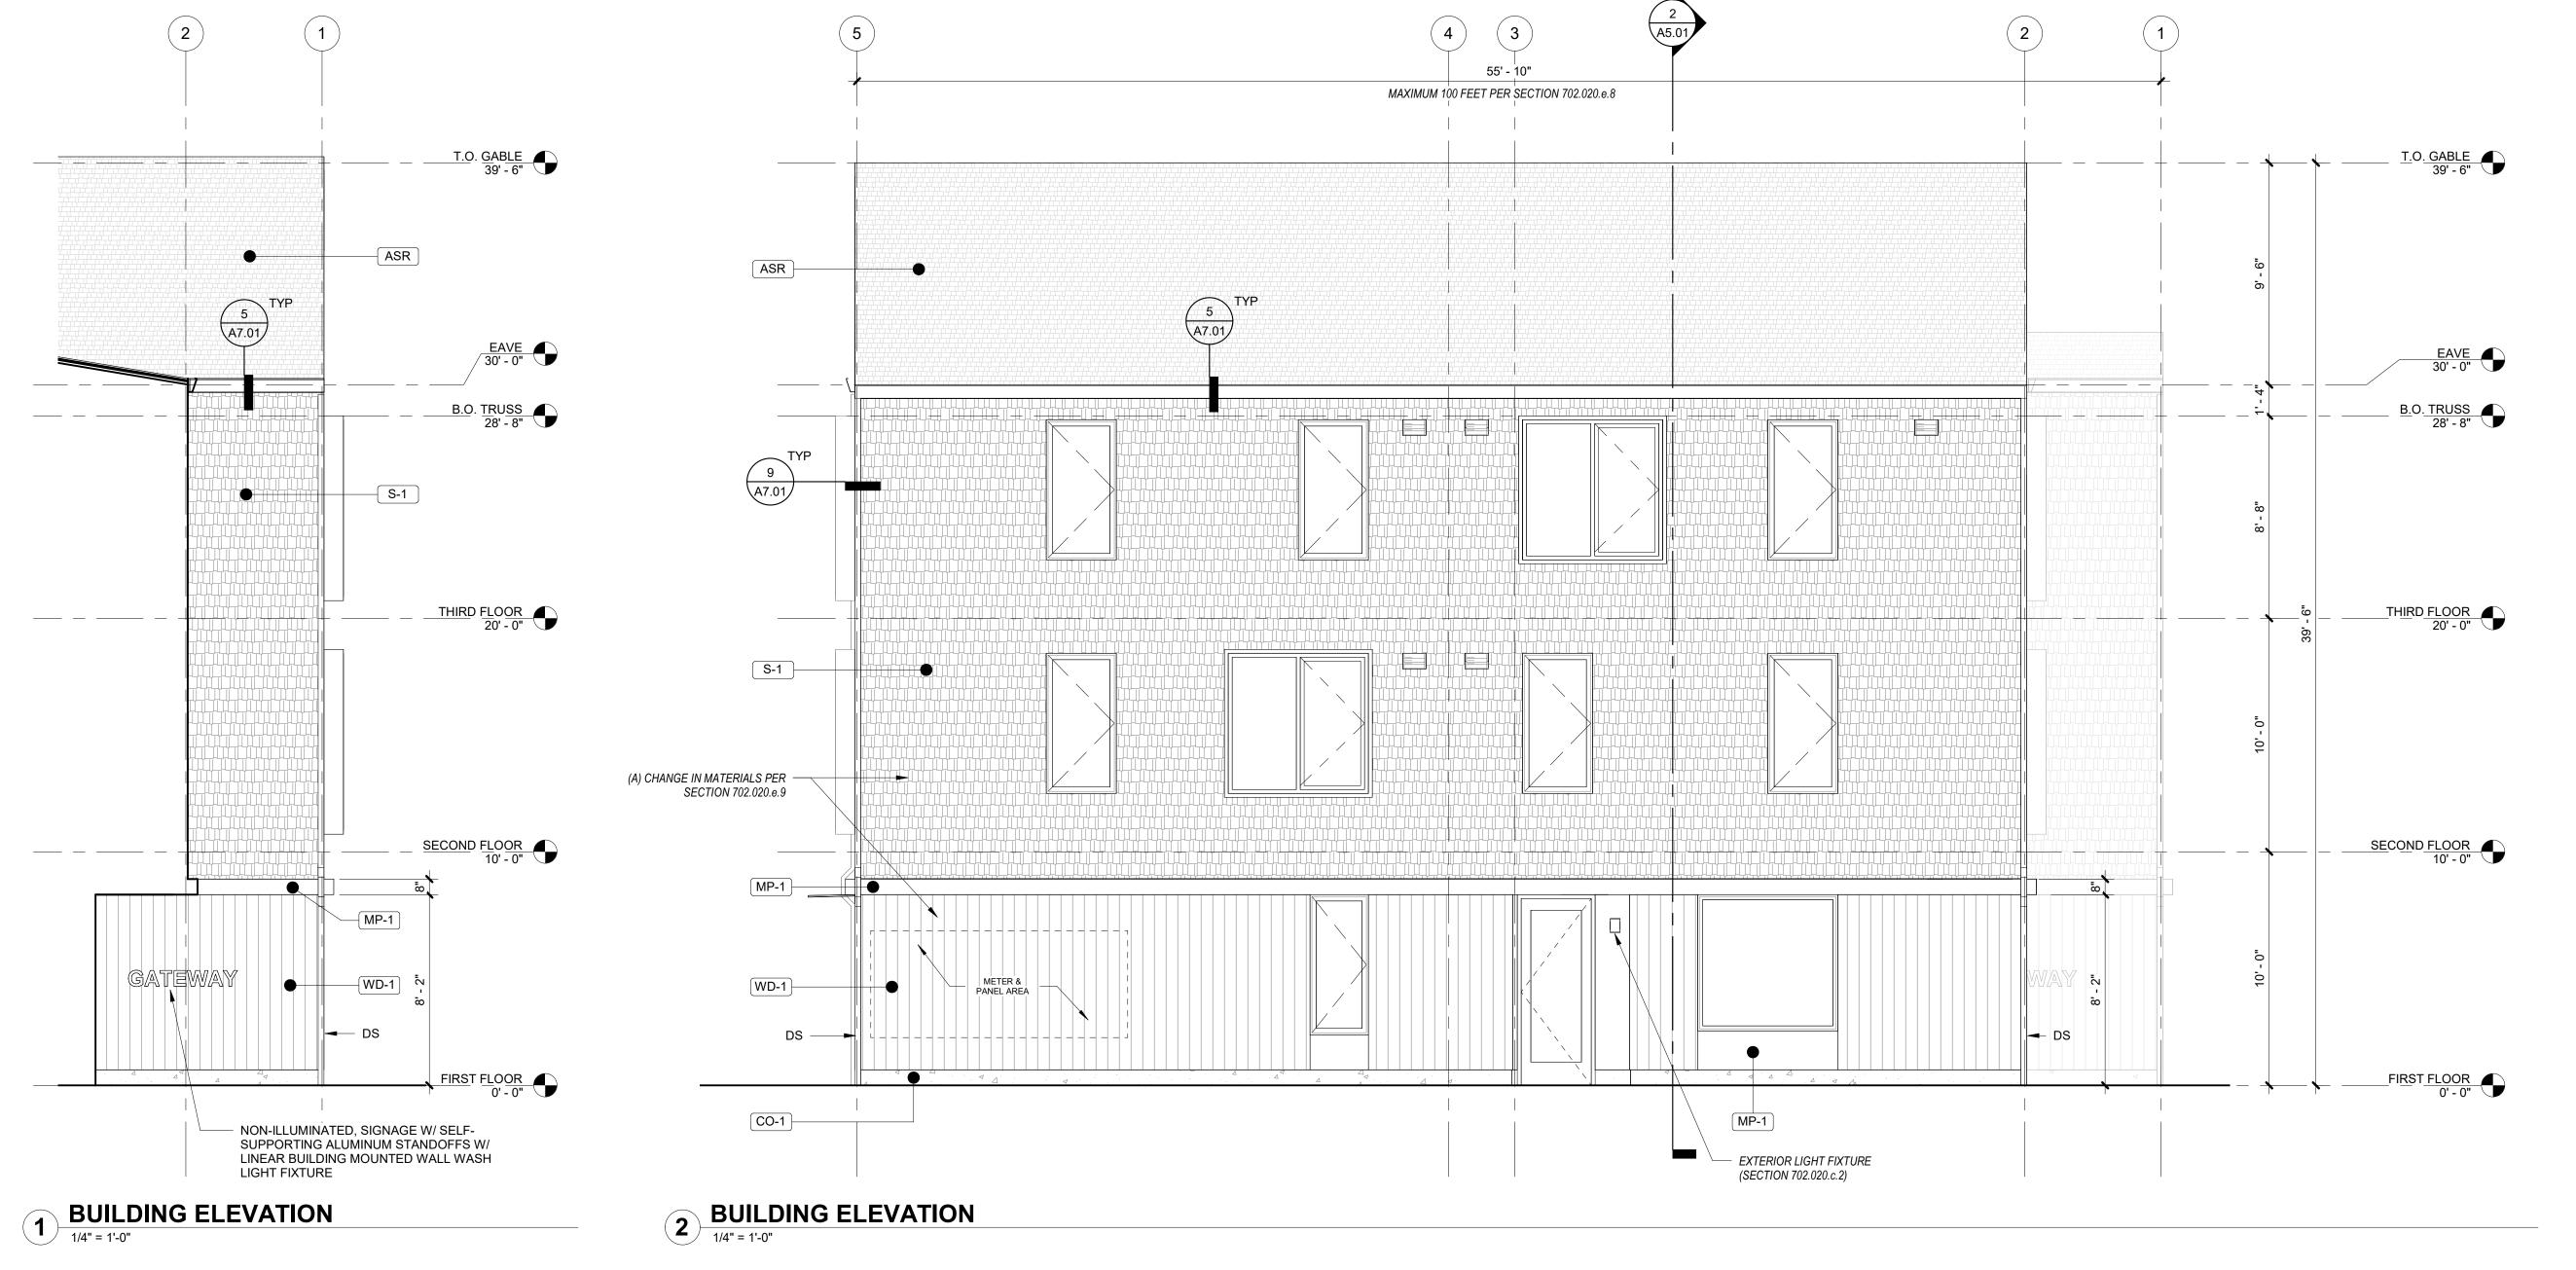
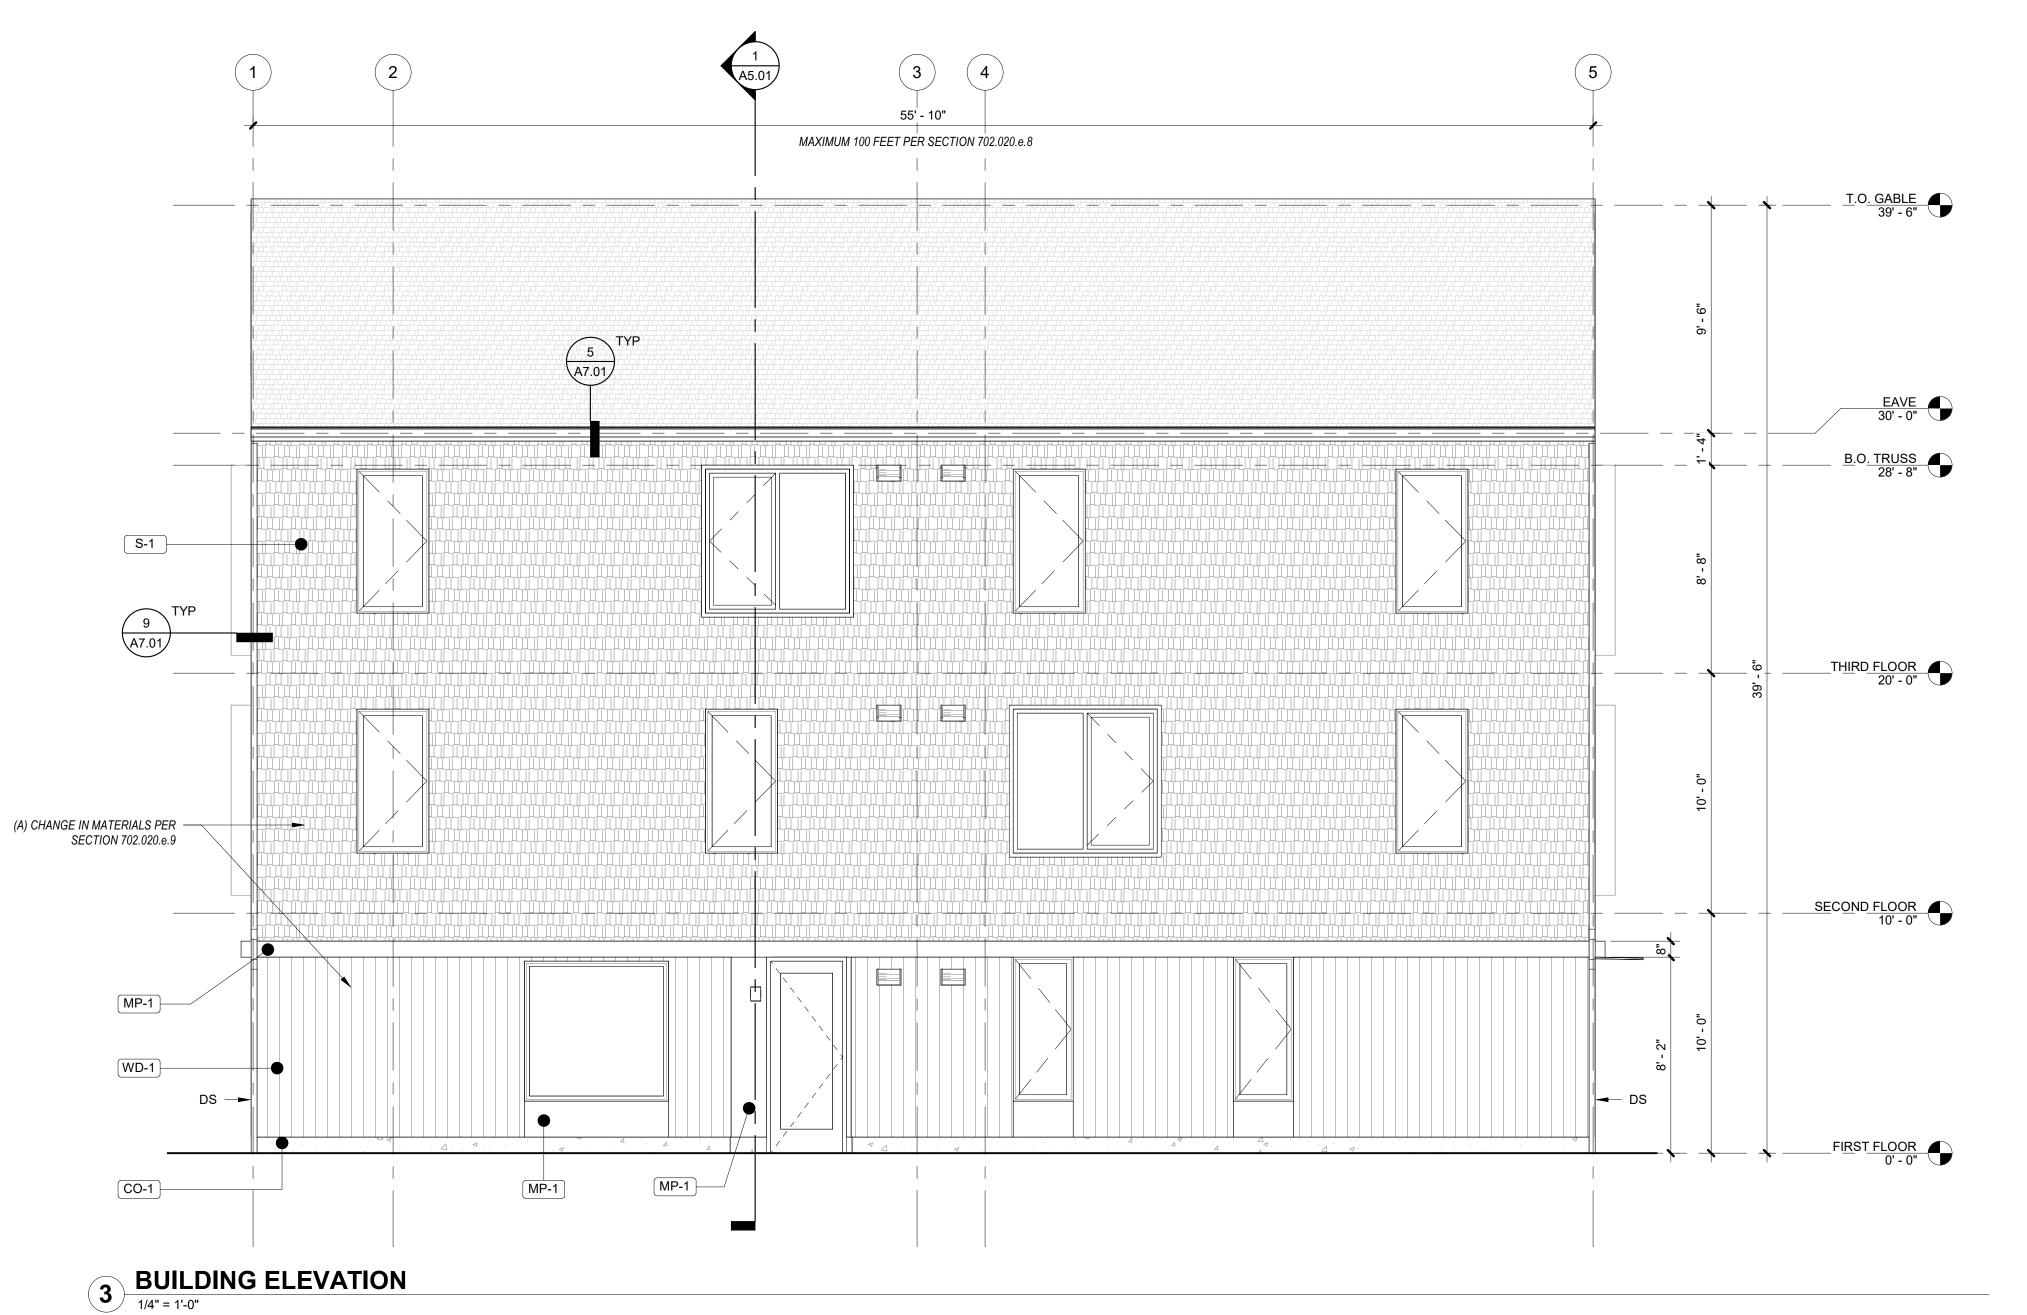
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WOT FORTION CONSTRUCTION

CDP SALEM -BUILDING A

Job Number: 2^c
5205 BATTLE CREEK RD SE
SALEM, OR 97306

FLAT METAL PANEL, PERFORATED
PRODUCT: TBD
FINISH: BLACK

FLAT METAL PANEL PRODUCT: TBD

FINISH: BLACK

WD-1 PRODUCT: TBD FINISH: TBD

CONCRETE STEM WALL

GENERAL SHEET NOTES

A. REFERENCE FLOOR PLANS FOR DOOR AND WINDOW LOCATIONS.B. REFERENCE ELECTRICAL FOR EXTERIOR LIGHT

C. CONFIRM ALL EXHAUST OPENINGS ARE MINIMUM

E. PREFINISHED 22 GAUGE FORMED SHEET METAL WINDOW TRIM, JAMB, AND SILL AT WINDOWS.F. PREFINISHED 22 GAUGE METAL THROUGH WALL

G. TRANSITION BETWEEN FIBER CEMENT SIDING

PROFILES TO FOLLOW MANUFACTURER DETAILING AND REQUIREMENTS.

SHINGLE SIDINGPRODUCT: SHINGLE SIDING,
STRAIGHT EDGE PANEL

ASPHALT SHINGLE ROOF

COLOR: TBD, LIGHT

PRODUCT: TBD COLOR: TBD

3'-0" FROM OPERABLE OPENINGS.

D. ALL EXTERIOR LOUVERS TO BE PAINTED TO MATCH THE EXTERIOR FINISH IT PENETRATES.

FLASHING AT WINDOW HEADS.

APPLICATIONS.

LEGEND

(ASR)

X-VENT

PTHP (BEYOND)

L _ _ _ _ J

D P Community
Development
Partners

LAND USE SUBMISSION ISSUE

Drawing:

EXTERIOR ELEVATIONS

Sheet No: Building A -

01.11.2021



PATH FROM PARKING TO COURTYARD



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CDP SALEM -BUILDING A

Job Number:

5205 BATTLE CREEK RD SE SALEM, OR 97306



Development Partners

BUILDING PATIOS

BUILDING FACING COURTYARD 1

MATERIALS



VERTICAL WOOD SIDING PRODUCT: TBD FINISH: TBD

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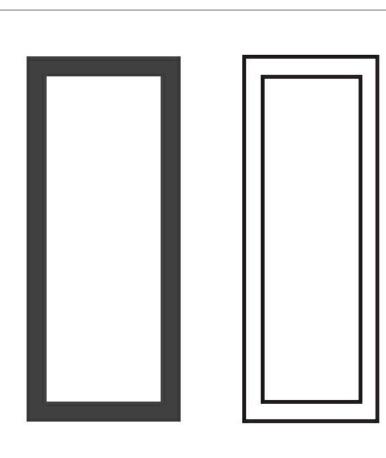
SHINGLE SIDING PRODUCT: SHINGLE SIDING, STRAIGHT EDGE PANEL FINISH: TBD, LIGHT



ASPHALT SHINGLE ROOF PRODUCT: TBD FINISH: TBD, DARK



FLAT METAL PANEL PRODUCT: TBD FINISH: TBD, DARK



VINYL WINDOWS PRODUCT: VPI ENDURANCE FINISH: TBD, LIGHT & DARK

* SITE AND LANDSCAPING SHOWN FOR REFERENCE ONLY. SEE CIVIL AND LANDSCAPE DRAWINGS FOR FULL DESIGN.

LAND USE SUBMISSION ISSUE

DATE

01.11.2021

RENDERINGS

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CDP SALEM -BUILDING A Job Number: 5205 BATTLE CREEK RD SE SALEM, OR 97306

Community Development Partners

LAND USE SUBMISSION ISSUE

Drawing:

WALL SECTIONS

01.11.2021

DATE

