

PROJECT DATA

|                       |  |
|-----------------------|--|
| SITE AREA:            | 38,332 SQ SF   |
| EXISTING PARKING:     | 47 STALLS  |
| PARKING REQUIRED:     | 1 STALL/250 SQ.FT = 17 STALLS (BASED ON 4,233 SQ.FT) |
| PARKING PROVIDED:     | 47 STALLS  |
| ACCESSIBLE REQUIRED:  | 2 STALLS (BASED ON 47 PROVIDED)                      |
| ACCESSIBLE PROVIDED:  | 2 STALLS   |
| ZONING:               | RETAIL COMMERCIAL                                    |
| BUILDING AREA:        | 4,233 EXISTING SQ. FT.                               |
| OCCUPANCY :           | A-2 (EXISTING)                                       |
| TYPE OF CONSTRUCTION: | V-8 (EXISTING)                                       |

SITE PLAN KEYNOTES

- (SP-01) REMOVE EXISTING & INSTALL (2) NEW DIGITAL MENU BOARDS AS SHOWN. SEE DETAIL 2/DT1.0 FOR EXACT LOCATIONS AND 10/DT1.1. LOCATE EXISTING UTILITIES PRIOR TO EXCAVATING FOOTINGS.
- (SP-02) REMOVE EXISTING CUSTOMER ORDER DISPLAY & INSTALL (2) CUSTOMER ORDER CANOPIES AS SHOWN PER DETAIL 6/DT1.2. SEE DETAIL 2/DT1.0 FOR EXACT LOCATIONS. LOCATE EXISTING UTILITIES PRIOR TO EXCAVATING FOOTINGS.
- (SP-03) INSTALL NEW VEHICLE DETECTOR LOOPS AT NEW ORDER POINTS PER 2/DT1.0. (OPTIONAL AT DRIVE THRU BOOTH) PATCH & REPAIR CONCRETE PAD AT DRIVE-THRU AS NECESSARY. SEE 18/DT1.1 & 20 DT1.1.
- (SP-04) REMOVE EXISTING & INSTALL NEW GATEWAY SIGN PACKAGE AS SHOWN. COORDINATE LOCATION WITH McDONALD'S CONSTRUCTION MANAGER TO ENSURE BEST VISIBILITY FROM SITE ENTRANCE. SEE DETAIL 8/DT1.2 FOR MORE INFO. LOCATE UNDERGROUND UTILITIES PRIOR TO EXCAVATION.
- (SP-05) NOT USED.
- (SP-06) INSTALL SPEECH/HEARING IMPAIRED SIGNAGE ON THE DRIVE-THRU C.O.D. & EACH DRIVE-THRU SERVICE WINDOW. SEE DETAILS 4/SD1 & 5/SD1. PICTURE MENU, CLIPBOARD AND PENCILS ARE TO BE PROVIDED AT EACH DRIVE-THRU WINDOW.
- (SP-07) EXISTING LANDSCAPE TO REMAIN. IF DAMAGED BY CONSTRUCTION, PATCH AND REPAIR AS NECESSARY TO ACCOMMODATE DEMOLITION AND NEW CONSTRUCTION. NEW LANDSCAPING TO MATCH EXISTING ADJACENT. ENSURE PLANTINGS DO NOT INHIBIT VIEW TO DRIVE THRU SIGNS.
- (SP-08) STRIPE PARKING STALLS AND SYMBOLS AS SHOWN. PAINTS TO BE TRAFFIC WHITE (2 COATS) AT PARKING AND TRAFFIC YELLOW (2 COATS) AT DRIVE-THRU. SEE DETAIL 1/SD1, 2/SD1, & 3/SD1.
- (SP-09) APPROXIMATE LINE OF NEW CONCRETE WORK TO EXISTING CONCRETE TO REMAIN.
- (SP-10) APPROXIMATE LINE OF CONCRETE PAD TO ASPHALT TRANSITION.
- (SP-11) EXISTING ROAD SIGN TO REMAIN. PROTECT FROM DAMAGE.
- (SP-12) EXISTING DIRECTIONAL SIGN TO REMAIN
- (SP-13) EXISTING FLAG POLE TO REMAIN.
- (SP-14) EXISTING LOT LIGHTING TO REMAIN
- (SP-15) EXISTING BOLLARD, PROTECT FROM DAMAGE
- (SP-16) EXISTING CATCH BASIN TO REMAIN
- (SP-17) RELOCATE TRANSFORMER TO NEW LOCATION SHOWN. VERIFY EXACT LOCATION WITH McDONALD'S CONSTRUCTION MANAGER & UTILITY COMPANY.
- (SP-18) NEW LANDSCAPING TO MATCH ADJACENT & AS REQUIRED BY LOCAL JURISDICTION REQUIREMENTS. ENSURE PLANTINGS WILL NOT INHIBIT VIEW OF DRIVE THRU & DIRECTIONAL SIGNAGE FROM CUSTOMERS.
- (SP-19) PROVIDE MERGE POINT MONITOR MOUNTED ON POLE WITH FOUNDATION; EXACT LOCATION TO BE COORDINATED WITH McDONALD'S CONSTRUCTION MANAGER. PROVIDE 2" CONDUIT TO CASH BOOTH JUNCTION BOX. CONNECT TO ELECTRICAL & DATA SYSTEMS.
- (SP-20) REMOVE EXISTING ASPHALT, LANDSCAPING, CONCRETE CURBS, & CONCRETE DRIVE THRU PAD AS NECESSARY TO ACCOMMODATE NEW WORK. INSTALL NEW CONCRETE PAVING & CURBING THROUGHOUT DRIVE THRU LANES AS SHOWN, PER McDONALD'S SPECIFICATIONS. SLOPE TO DRAIN AS NECESSARY. SEE DETAILS 2/DT1.1, 3/DT1.1, & 4/DT1.1.

SIGN LEGEND

- (A) "WELCOME" GATEWAY SIGN (1 NEW)
- (B) CUSTOMER ORDER CANOPY (2 NEW)
- (C) DIGITAL MENU BOARD (2 NEW)
- (D) PULL FORWARD STALL SIGNS (2 EXISTING)
- (E) NOT USED
- (F) "ANY LANE, ANY TIME" SIGN (1 NEW ATTACHED TO GATEWAY POLE)

LEGEND

- EXISTING CONCRETE CURBING TO REMAIN/ REPAIR
- NEW CONCRETE CURBING
- EXISTING CONSTRUCTION TO BE DEMOLISHED
- NEW STRIPING
- EXISTING LANDSCAPING TO REMAIN
- NEW LANDSCAPING
- EXISTING CONCRETE TO REMAIN
- NEW CONCRETE
- EXISTING LOT LIGHT
- EXISTING STRIPING
- EXISTING CATCH BASIN

GENERAL NOTES

1. PROPOSED UTILITIES ARE SHOWN IN SCHEMATIC ONLY. EXACT LOCATIONS SHALL BE DETERMINED TO ALLOW FOR THE MOST ECONOMICAL INSTALLATION.
2. THE CONTRACTOR SHALL COORDINATE WITH ALL UTILITY COMPANIES TO DETERMINE EXACT POINT OF SERVICE CONNECTION AT EXISTING UTILITY. REFER TO THE BUILDING ELECTRICAL AND PLUMBING DRAWINGS FOR UTILITY SERVICE ENTRANCE LOCATIONS, SIZES, AND CIRCUITING.
3. FINISH WALK AND CURB ELEVATIONS SHALL BE 6" ABOVE FINISH PAVEMENT.

PAVING SPECIFICATION  
(MINIMUM 3" TOTAL COMPACTED ASPHALT THICKNESS)

NOTE: McDONALD'S ENGINEER RESERVES THE RIGHT TO REQUEST A COMPACTION TEST AND/OR A CORE SAMPLE. IF TESTS PROVE CORRECT, PER ABOVE SPECIFICATION, TESTS WILL BE AT THE EXPENSE OF McDONALD'S, OTHERWISE, G.C. WILL BE CHARGED.

LOT LIGHTING RECOMMENDATION

EXISTING LOT LIGHTS TO REMAIN. VERIFY WITH McDONALD'S CONSTRUCTION MANAGER IF CLEAN/RELAMP OR NO WORK DURING THIS PROJECT.

PARKING INFORMATON

|              |    |                                 |
|--------------|----|---------------------------------|
| TOTAL SPACES | 25 | 9'-0" X 20'-0" SPACES @ 65'     |
|              | 20 | 9'-0" X 20'-0" SPACES @ 60'     |
|              | 2  | ADA 9'-0" X 20'-0" SPACES @ 65' |
| 47           |    |                                 |
|              |    |                                 |
|              |    |                                 |
|              |    |                                 |
|              |    |                                 |
|              |    |                                 |
|              |    |                                 |

UTILITY INFORMATION

|                | SIZE | TYPE     | LOCATION |
|----------------|------|----------|----------|
| SANITARY SEWER |      | EXISTING |          |
| WATER          |      | EXISTING |          |
| STORM SEWER    |      | EXISTING |          |
| ELECTRIC       |      | EXISTING |          |
| GAS            |      | EXISTING |          |

SURVEY INFORMATION

|          |                |             |             |
|----------|----------------|-------------|-------------|
| DRAWN BY | STD ISSUE DATE | REVIEWED BY | DATE ISSUED |
|          | JUL 2021       | SEM         | JUL 2021    |

PLAN SCALE: 1" = 20'

STREET ADDRESS  
3995 RICKEY ST. SE

CITY  
SALEM

STATE  
OR

BOROUGH  
SALEM

REGIONAL DWG. NO

36-0189

CORPORATE DWG. NO.

14118

REGISTERED ARCHITECT  
SHERRI E. GRUBBS  
KIRKLAND, WA  
STATE OF OREGON

**Magellan**  
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PREPARED BY:  
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**M. McDonald's USA, LLC**  
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DRAWN BY  
JUL 2021

REVIEWED BY  
SEM  
JUL 2021

DATE ISSUED  
JUL 2021


TITLE  
SIDE-BY-SIDE DRIVE THRU REMODEL

DESCRIPTION  
NEW SBS DRIVE THRU AT EXISTING BUILDING


SITE ADDRESS  
3995 Rickey St. SE Salem, OR 97301

SHEET NO.  
PP21-210  
**SP-2**  
SITE PLAN


MA  
BY

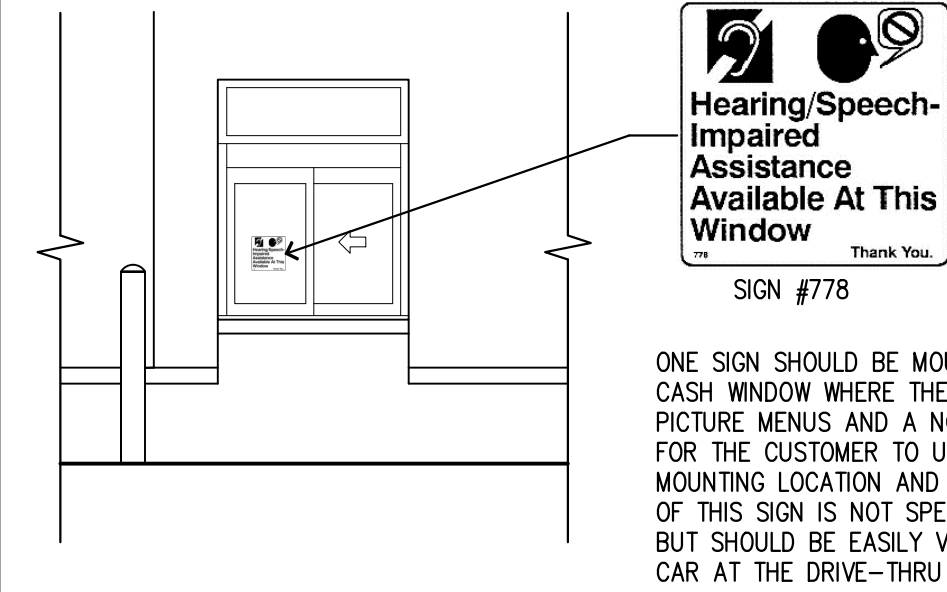

**SPEECH/ HEARING IMPAIRED SIGN @ D.T.**  
SCALE: NOT TO SCALE  
105\_SPEECH\_SIGN\_DT.DWG

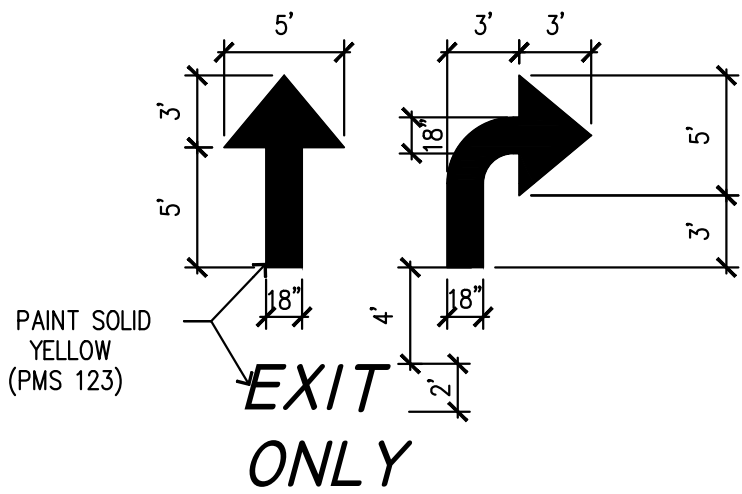


**TYPICAL PAVEMENT MARKINGS**  
SCALE: NOT TO SCALE  
PAVEMENT\_MARKING.DWG

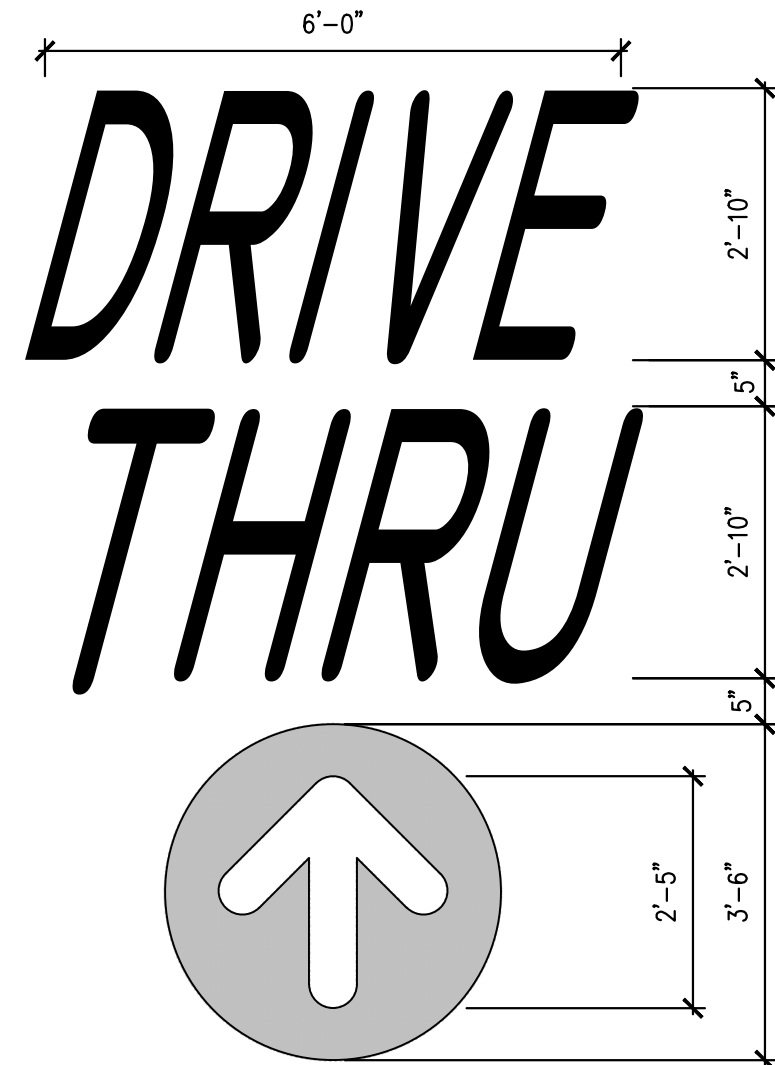

**PAINTED "DRIVE-THRU" WITH ARROW**  
SCALE: NOT TO SCALE  
PAINTED\_DRIVE\_THRU.DWG



**PAINTED "THANK YOU"**  
SCALE: NOT TO SCALE  
PAINTED\_THANK\_YOU.DWG

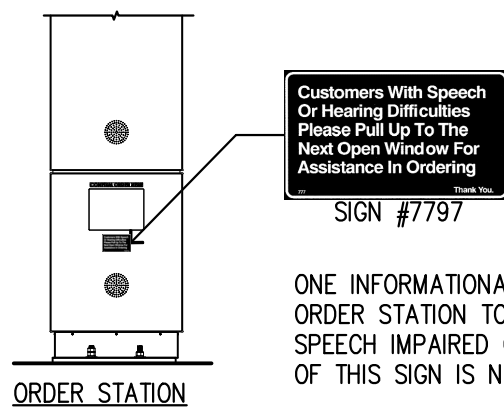

**SPEECH/ HEARING IMPAIRED SIGN @ C.O.D.**  
SCALE: NOT TO SCALE  
SPEECH\_SIGN\_COD.DWG

|                 |   |                |          |
|-----------------|---|----------------|----------|
| TITLE           | SIDE-BY-SIDE DRIVE THRU REMODEL         | DRAWN BY       | PP21-210 |
| DESCRIPTION     | NEW SBS DRIVE THRU AT EXISTING BUILDING | STD ISSUE DATE | JUL 2021 |
| SHEET NO.       | SD1                                     | REVIEWED BY    | SEM      |
| SITE ID         | 36-0189                                 | DATE ISSUED    | JUL 2021 |
| SITE ADDRESS    | 3995 Rickey St. SE Salem, OR 97301      |                |          |
| PERMIT SUBMITAL |   | REV            | DATE     |
| MA              |   | -              |          |
| BY              |   |                |          |

RECEIVED ARCHITECT  
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STATE OF OREGON

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www.magellanarchitects.com



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1. VERIFY CONDUIT SIZES AND LAYOUT WITH DETECTOR LOOP MANUFACTURER.
2. CENTER VEHICLE DETECTOR LOOP IN DRIVE THRU LANE. INSTALL PER MFR. RECOMMENDATIONS.
3. SEE SHEET DT1.0 FOR DIMENSIONS OF DRIVE-THRU LANE CONCRETE PAD FOR DETECTOR LOOP.
4. NO STEEL (REBAR OR ELECTRICAL WIRE) SHALL BE USED WITHIN 2' OF LOOP.
5. DETECTOR LOOP MANUFACTURERS:  
DETECTOR LOOPS MAY BE BY ONE OF THE FOLLOWING COMPANIES OR EQUAL.  
3M: 1-800-328-0033  
HME: 1-800-848-4468

- 
- 1-1/2" PVC CONDUITS TO BUILDING FOR:
- LOOP DETECTOR & AUDIO
  - DATA CABLE
- 1/2" STEEL CONDUIT TO BUILDING FOR COD POWER
- COD POST FOUNDATION
- 1 1/2" PVC SLEEVE FOR DETECTOR LOOP
- 2'-0" TO 2'-6"
- DETECTOR LOOP
- 5'-0"
- TRAFFIC FLOW
- CONCRETE CURB
- PLAN
- WIDTH OF DRIVE-THRU LANE




NOTE: DETECTOR LOOPS AT PRESENTATION AND ORDER  
WINDOWS ARE OPTIONAL.  
GC TO INSTALL PVC SLEEVES TO FACILITATE POSSIBLE FUTURE  
LOOP INSTALLATION.

### B - DT WINDOW DETECTOR LOOP

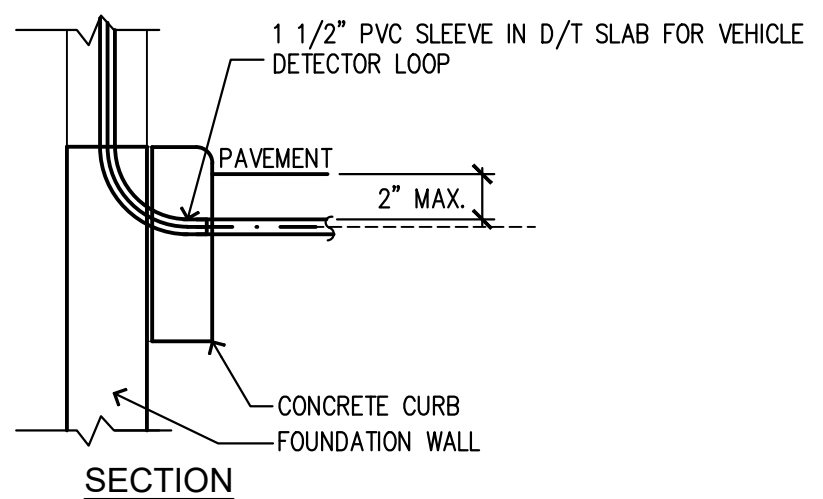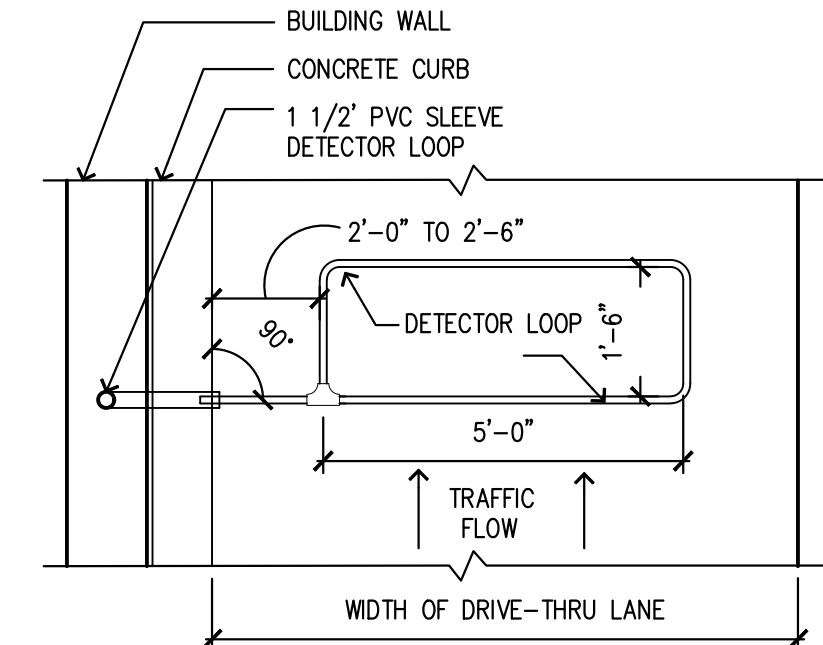SCALE: NOT TO SCALE


- 1 ELECTRICAL EQUIPMENT ITEM 215.0225 IN PRESENTATION BOOTH. PROVIDE 2" HOLE & GROMMET IN JUNCTION BOX COVER PLATE FOR POS DATA CABLES. PROVIDE 2 1/2"C ABOVE CEILING.
- 2 OPTIONAL DRIVE-THRU WINDOW DETECTOR LOOP FOR ORDER & PRESENTATION WINDOWS -- SEE 18/DTI.1. G.C. TO INSTALL PVC SLEEVES TO FACILITATE POSSIBLE FUTURE LOOP INSTALLATION.
- 3 ELECTRICAL EQUIPMENT ITEM #215.024 IN ORDER/CASH BOOTH. PROVIDE 2" HOLE & GROMMET IN JUNCTION BOX COVER PLATE FOR POS DATA CABLES. PROVIDE 2 1/2"C ABOVE CEILING.
- 4 PROVIDE STEEL CONDUIT AND CONDUCTOR PER POS & CORD ISOLATED GROUND/ DEDICATED CIRCUIT DETAIL 1/2"C-2#12 & 1/2" GROUND & 1/2" ISOLATED GROUND. PROVIDE 1 CB PER CORD.

- |   |  |
|---|--|
| 5 | 1 1/2" PVC CONDUIT FOR REMOTE LOOP DETECTOR & COD AUDIO CABLES. EC TO PROVIDE 3 PULL STRINGS INSIDE CONDUIT. |
| 6 | 1 1/2" CO FOR COD DATA CABLES. EC TO PROVIDE 3 PULL STRINGS INSIDE CONDUIT.                                  |
| 7 | CONDUIT FOR COO LOOP DETECTOR, ELECTRICAL EQUIPMENT ITEM 217.11E1* - SEE 18/DTJ.1.                           |
| 8 | 1/2"x2#12, POWER FOR MENU BOARD ILLUMINATION.  |
| 9 | "ORDER HERE" CANOPY LIGHTS.  |

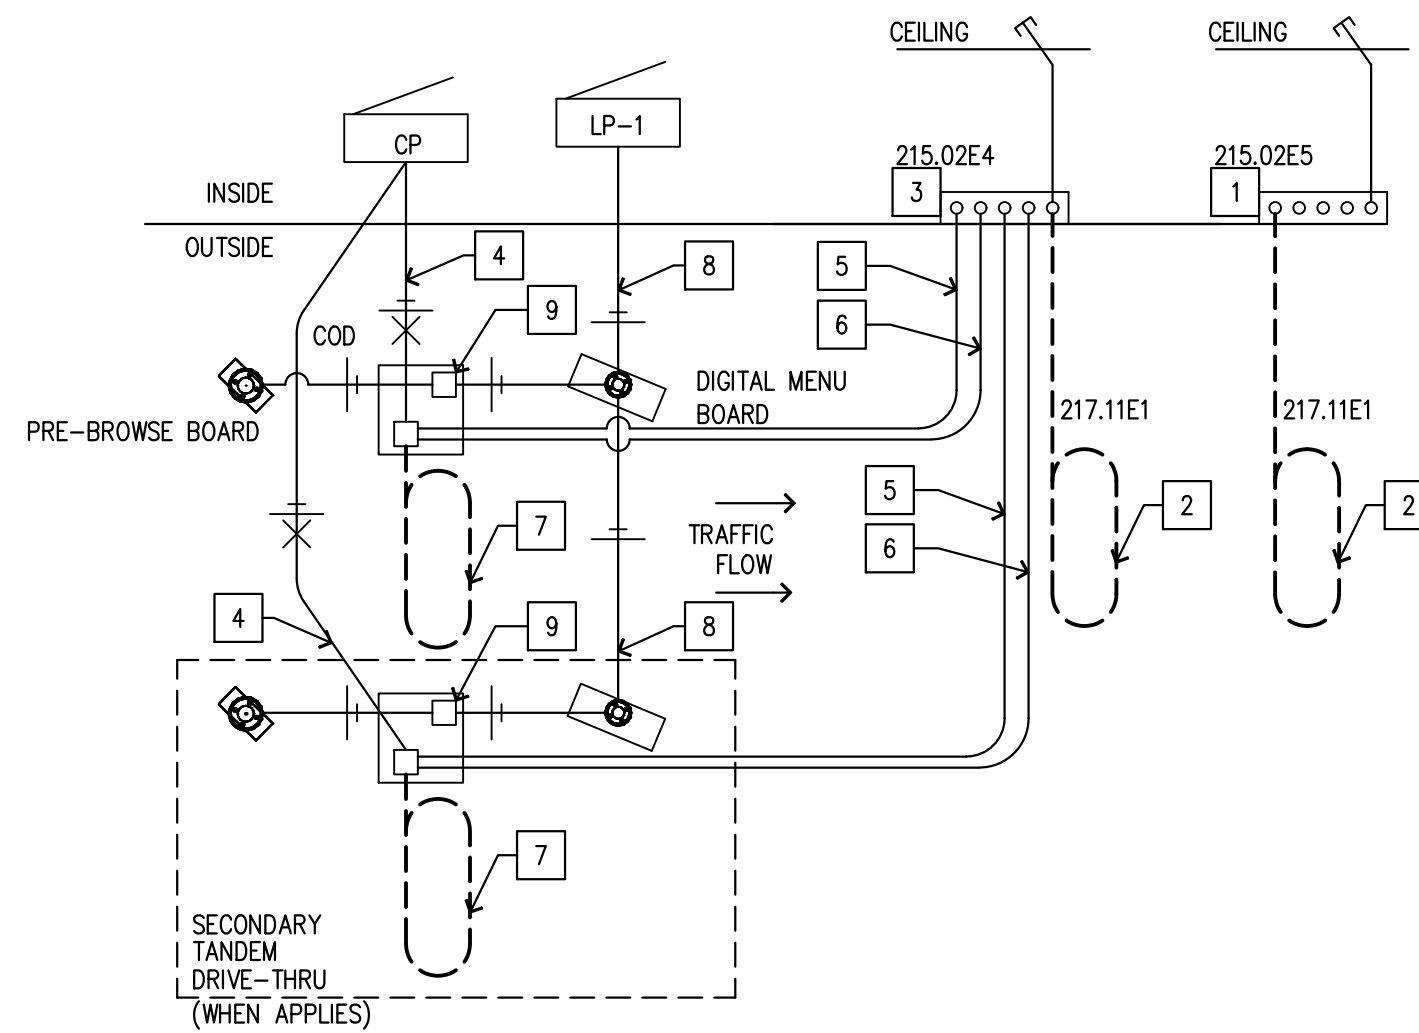


SCALE: NOT TO SCALE

- TOP OF PIERS SHALL BE SLOPED SUCH THAT MOISTURE CANNOT ACCUMULATE.
- USE 3000 PSI CONCRETE COMPRESSIVE STRENGTH (fc)
- PIER DEPTHS REQUIRED ARE MINIMUMS. ALL PIERS TO EXTEND TO FROST DEPTH AS DETERMINED BY LOCAL JURISDICTION.

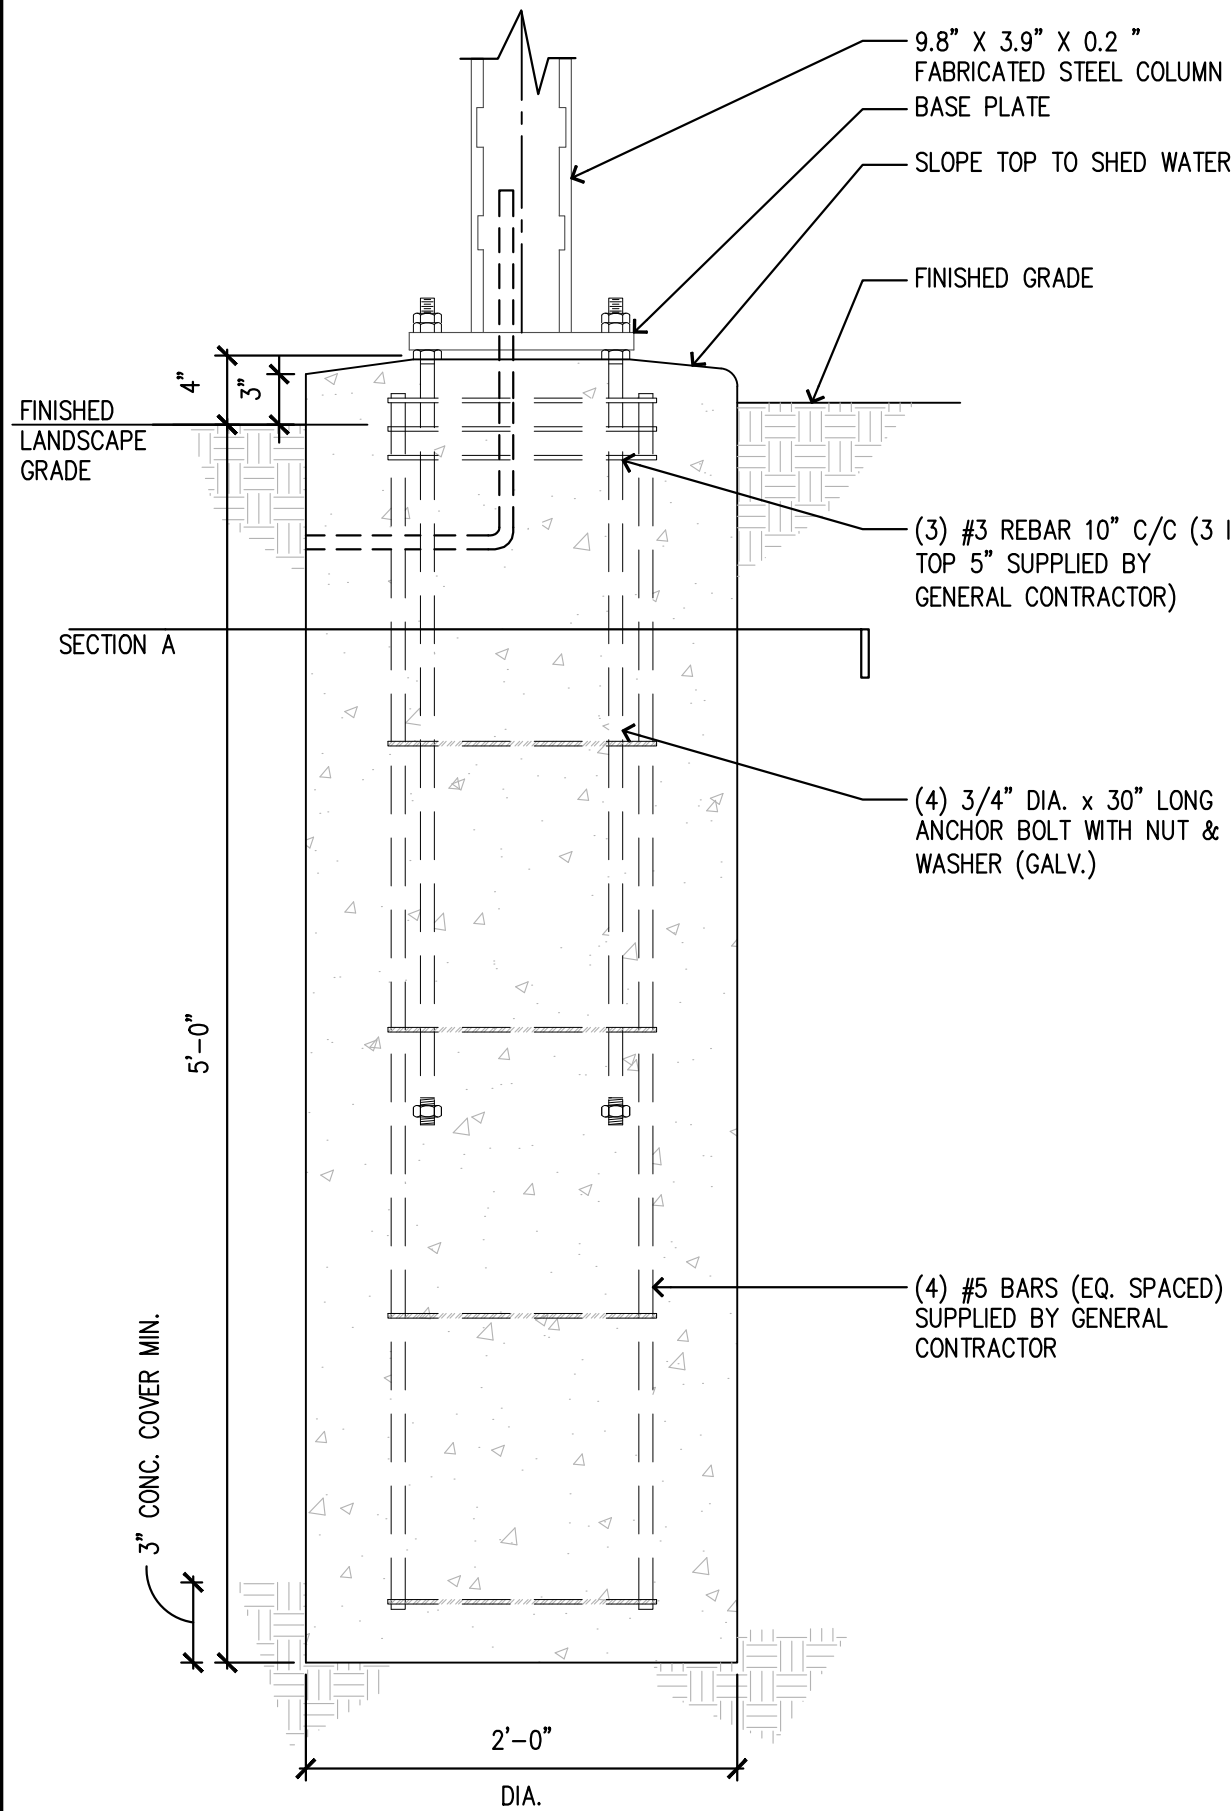


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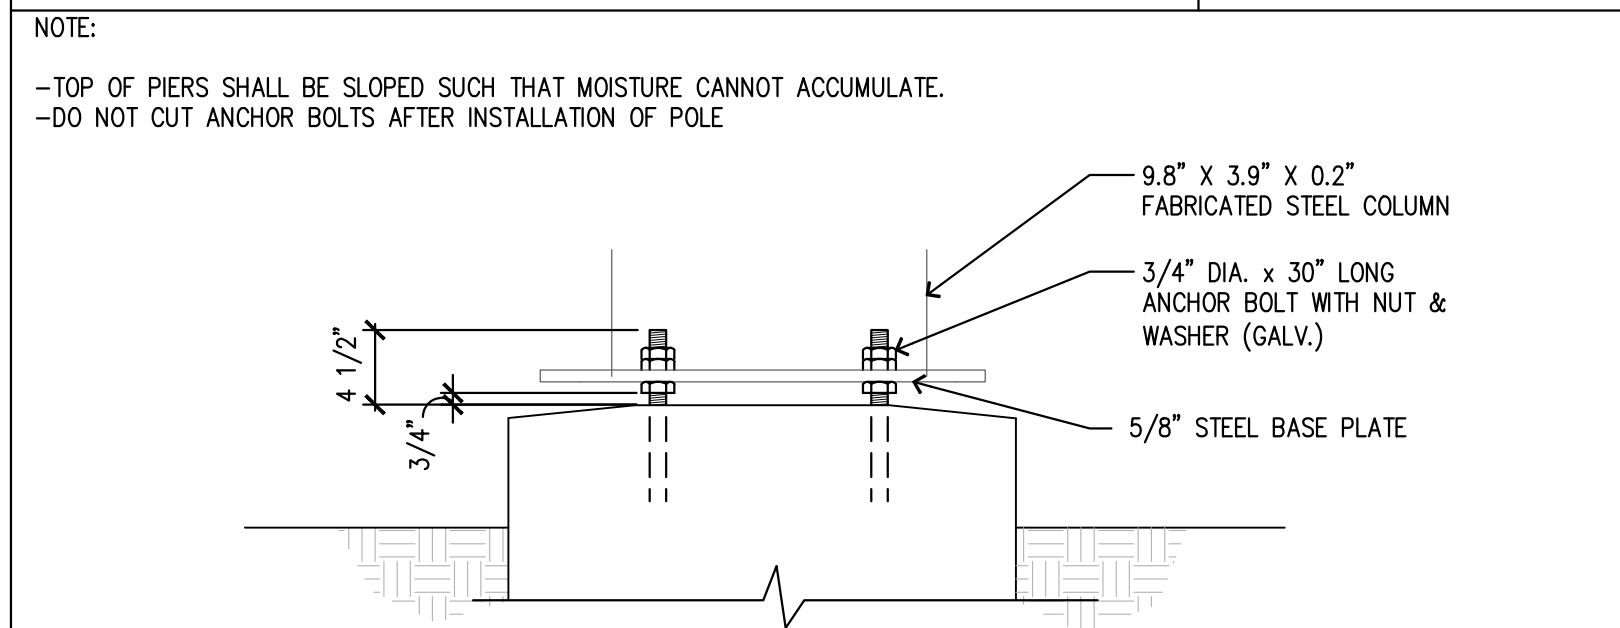
-TOP OF PIERS SHALL BE SLOPED SUCH THAT MOISTURE CANNOT ACCUMULATE.

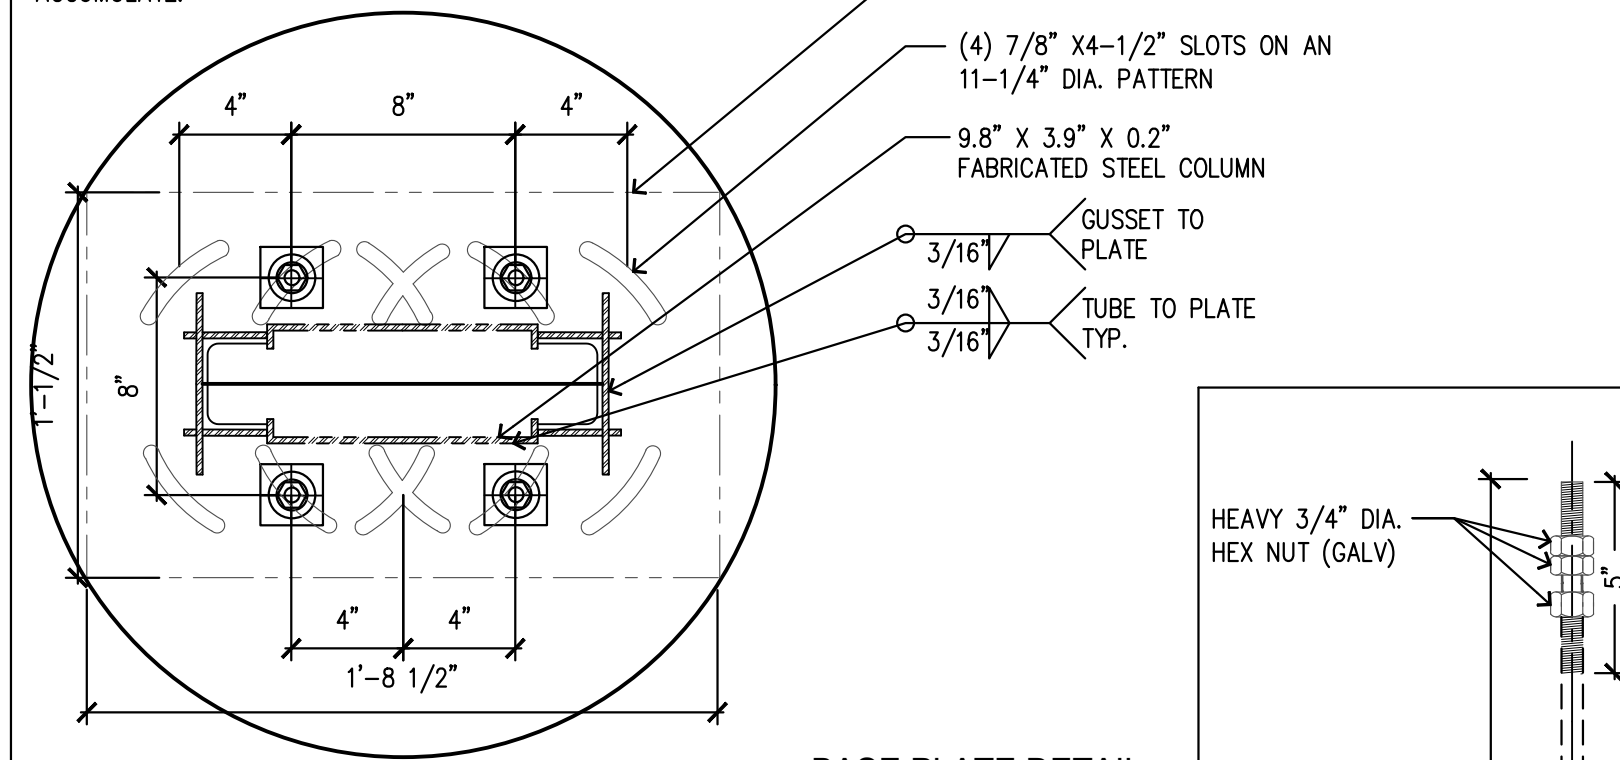

### BASE PLATE DETAIL

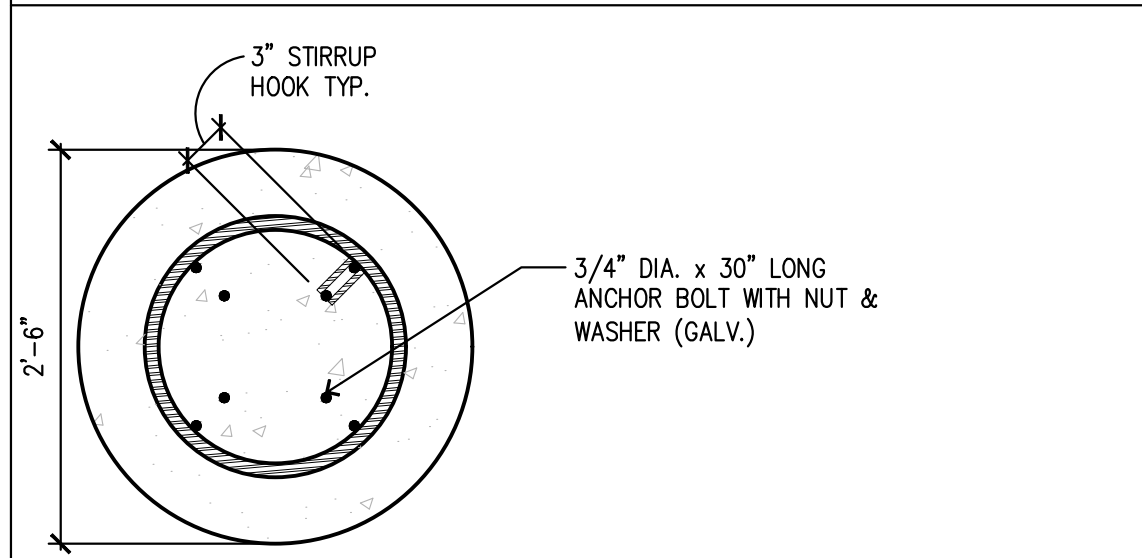


SECTION A




### CONNECTION DETAIL

1. G.C. TO COORDINATE THE RESPONSIBILITIES OF THE ELECTRICAL CONTRACTOR AND THE SIGN SUPPLIER.
2. GENERAL CONTRACTOR TO INSTALL PRE-FORMED, PRE-WIRED VEHICLE DETECTOR LOOP.
3. #12 GREEN GROUNDING CONDUCTOR MUST BE RUN WITH CIRCUIT CONDUCTORS FROM GROUND BUS IN PANEL LP TO ALL MENU BOARDS AND REFERENCE BOARDS.
4. ALL UNDERGROUND CONDUIT FOR AUDIO TO BE P.V.C. NO METAL ALLOWED.
5. ALL GALVANIZED ANCHOR BOLTS TO BE SUPPLIED BY THE CONTRACTOR.

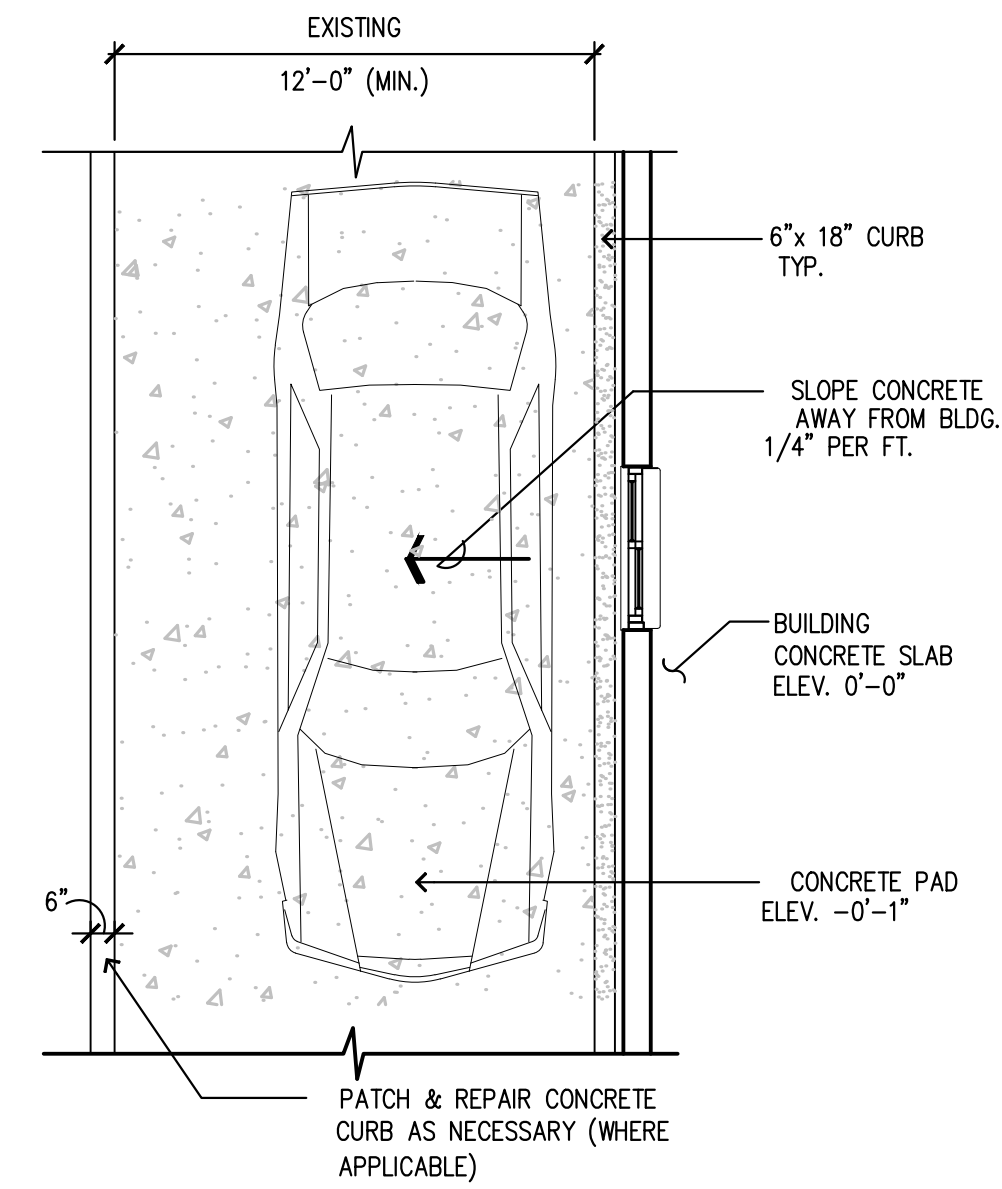


SCALE:  $1/4" = 1'-0"$

NOTE: SLOPE PAVEMENT TO FOLLOW LOT  
FOR DRAINAGE

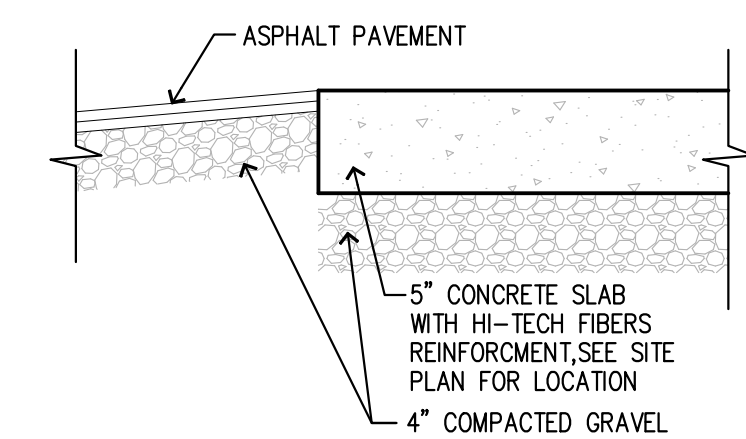


SCALE:  $1/4" = 1'-0"$

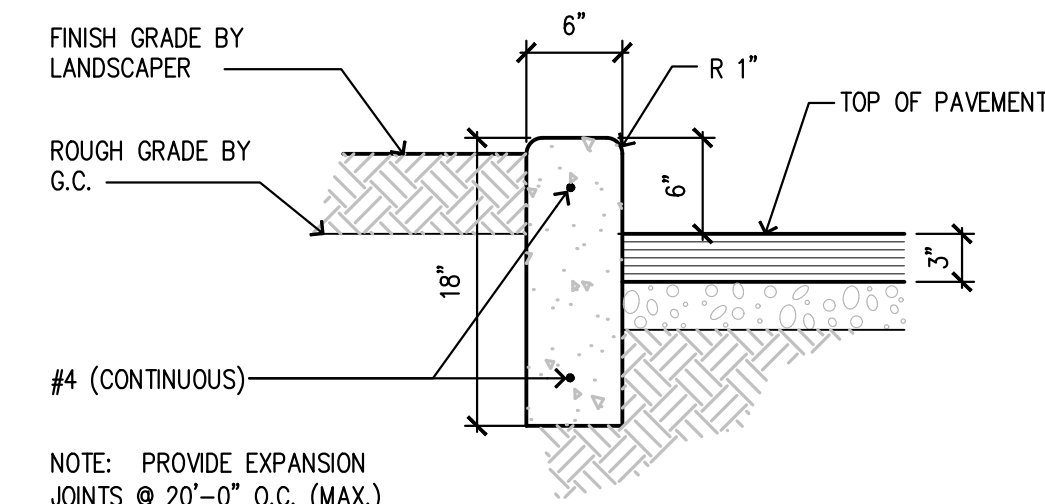


SCALE:  $1/4" = 1'-0"$

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D/T POST DETAIL

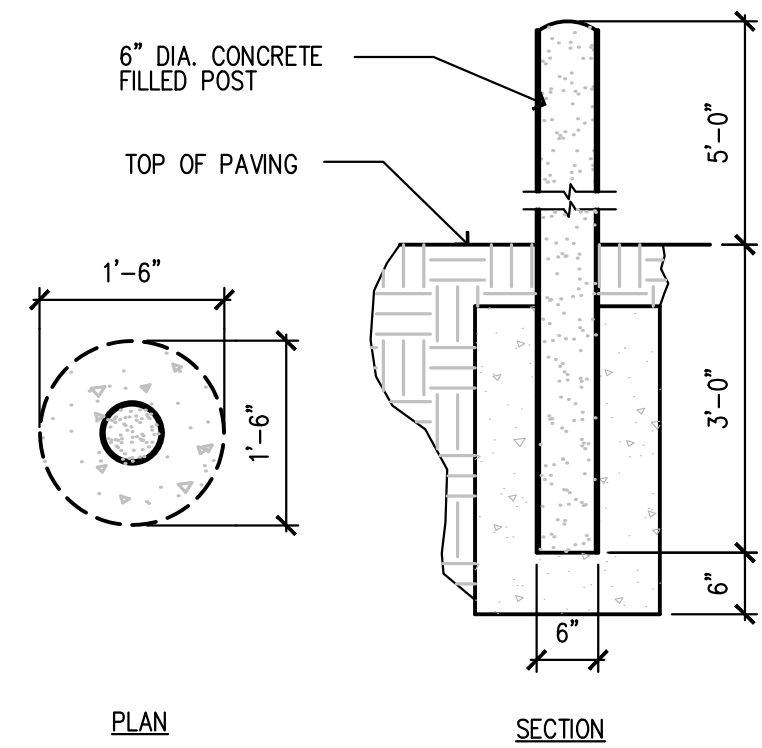SCALE: NOT TO SCALE




## VEHICLE SIGHT LINES

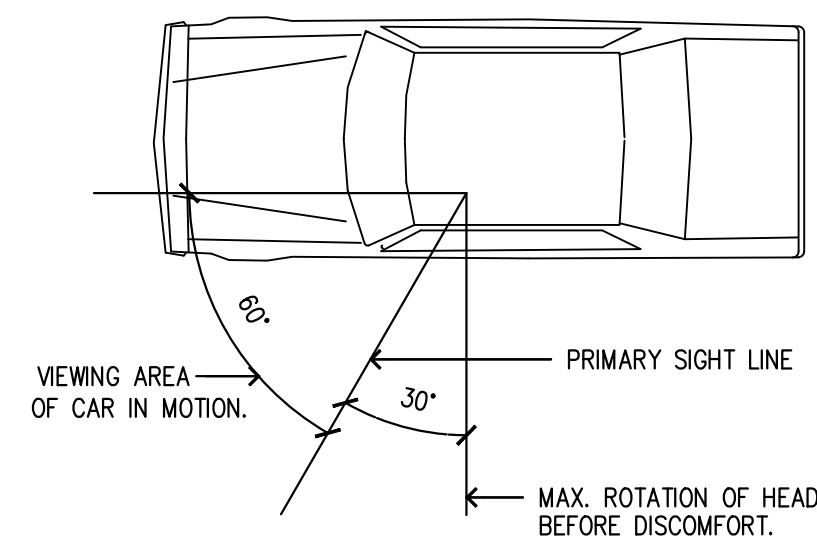SCALE: NOT TO SCALE

NOTE:

- USE 3000 PSI CONCRETE COMPRESSIVE STRENGTH (f'c)
- PIER DEPTHS REQUIRED ARE MINIMUMS. ALL PIERS TO EXTEND TO FROST DEPTH AS DETERMINED BY LOCAL JURISDICTION
- TOP OF PIERS SHALL BE SLOPED SUCH THAT MOISTURE CANNOT ACCUMULATE.
- MINIMUM ALLOWABLE LATERAL SOIL BEARING PRESSURE 100 PSF/FT OF DEPTH (x2)
- PROVIDE A MINIMUM OF 3" CONCRETE COVER FOR ALL EMBEDDED STEEL
- ALL REINFORCING BY GENERAL CONTRACTOR

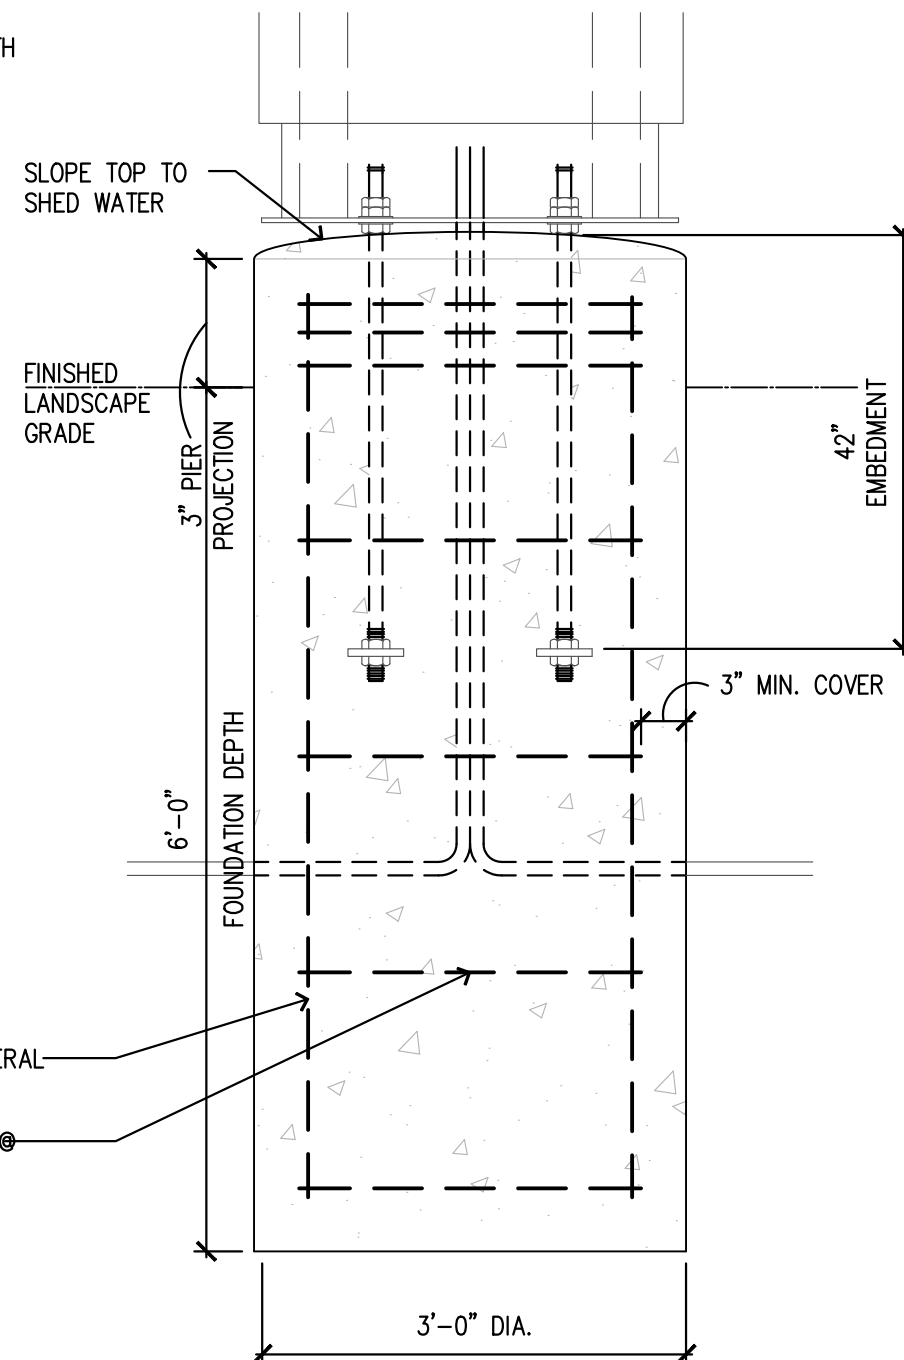

(8) #6 VERTICALS SUPPLIED BY GENERAL-  
CONTRACTOR

#3 TIES @ 12" O.C. W/ (3) #3 TIES @  
TOP 5" SUPPLIED BY GENERAL  
CONTRACTOR

**NOTE:**

- TOP OF PIERS SHALL BE SLOPED SUCH THAT MOISTURE CANNOT ACCUMULATE.
- USE F1554 GRADE 36 BOLTS MINIMUM
- USE HOT DIPPED GALVANIZED BOLTS
- ANCHOR BOLTS TO BE SET IN ACCORDANCE WITH AISC CODE OF STANDARD PRACTICE
- ANCHOR RODS, NUTS & WASHERS SHALL BE SHIPPED AS AN ASSEMBLY FROM THE SIGN/ LIGHTING MANUFACTURER
- DO NOT CUT ANCHOR BOLTS AFTER INSTALLATION OF POLE

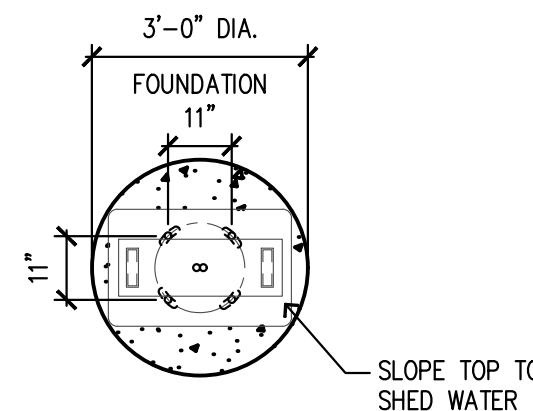



Diagram illustrating the assembly components for the rear axle leveling nut:

- 1/2 HEIGHT LOCK NUT (GALVANIZED)
- HEAVY HEX NUT (GALVANIZED)
- PLATE WASHERS (GALVANIZED)
- PER MFR.
- HEAVY HEX LEVELING NUT (GALVANIZED)

ANCHOR BOLT

**NOTE:**

- TOP OF PIERS SHALL BE SLOPED SUCH THAT MOISTURE CANNOT ACCUMULATE.
- ANCHOR RODS, NUTS & WASHERS SHALL BE SHIPPED AS AN ASSEMBLY FROM THE SIGN/ LIGHTING MANUFACTURER
- DO NOT CUT ANCHOR BOLTS AFTER INSTALLATION OF POLE

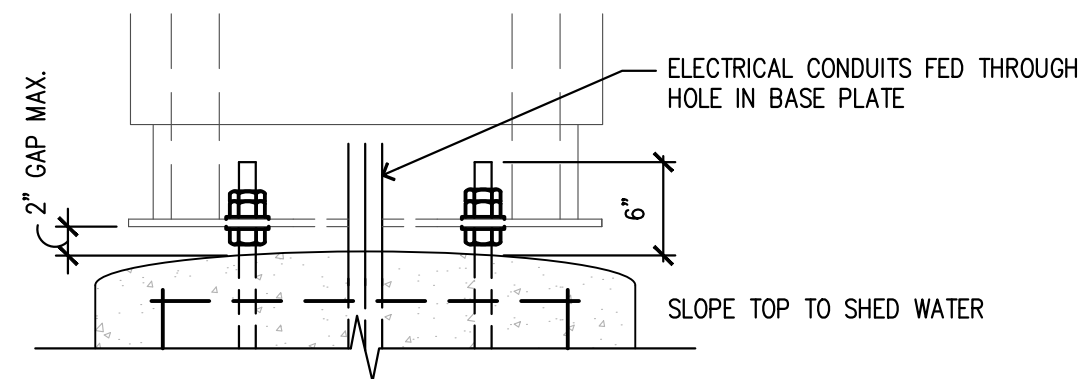


### CONNECTION DETAIL

6

- SCALE: NOT TO SCALE

**NOTE:**

- USE 3000 PSI CONCRETE COMPRESSIVE STRENGTH (f<sub>c</sub>)
- PIER DEPTHS REQUIRED ARE MINIMUMS. ALL PIERS TO EXTEND TO FROST DEPTH AS DETERMINED BY LOCAL JURISDICTION.
- TOP OF PIERS SHALL BE SLOPED SUCH THAT MOISTURE CANNOT ACCUMULATE.
- ELECTRICAL CONTRACTOR TO PROVIDE INFORMATION ON CONDUIT AND ELECTRICAL REQUIREMENTS
- MINIMUM ALLOWABLE LATERAL SOIL BEARING PRESSURE 100 PSF/FT OF DEPTH (x2).
- 3" MIN. CONCRETE COVER FOR REINFORCEMENT
- ALL REINFORCING BY GENERAL CONTRACTOR

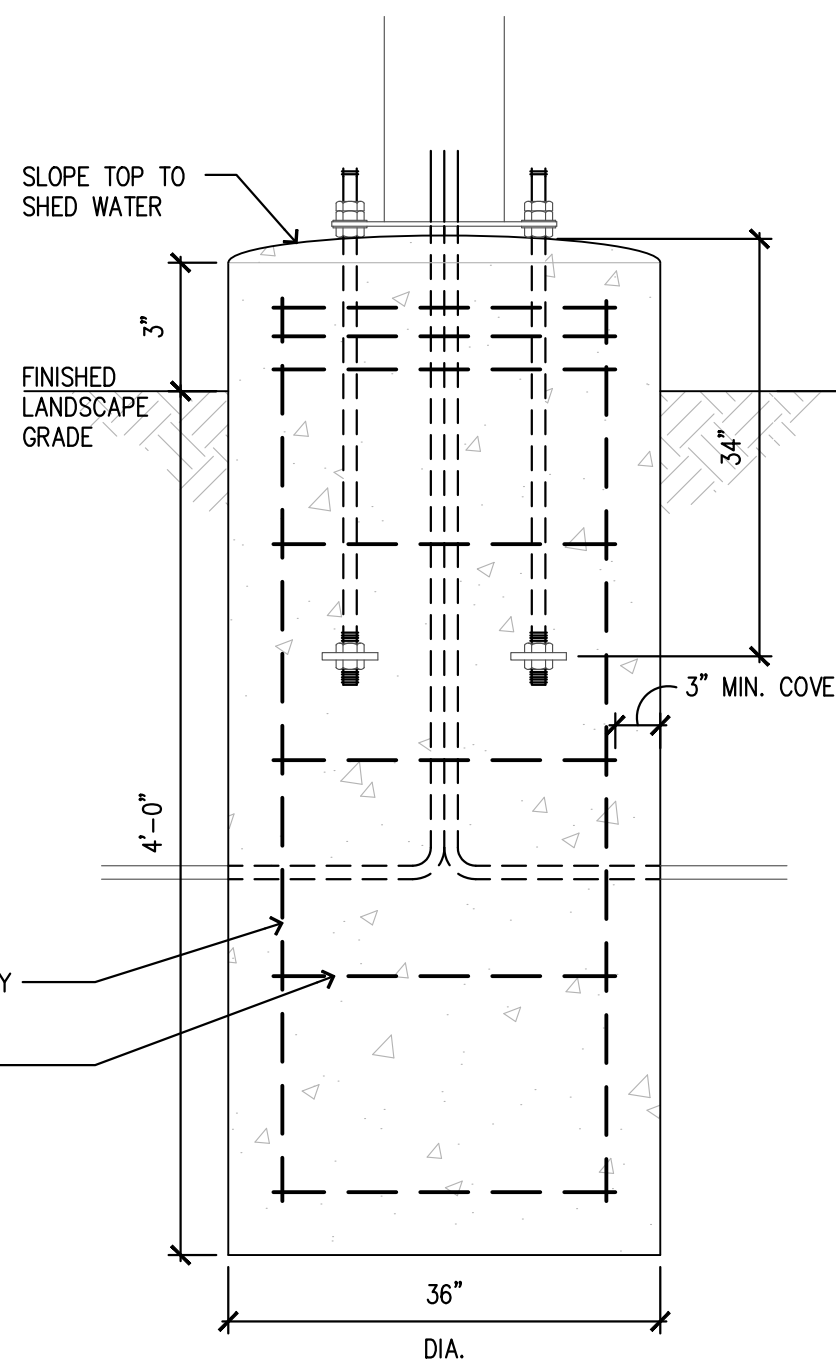

(12) 6'-10" #6 VERTICALS SUPPLIED BY  
GENERAL CONTRACTOR

#3 TIES @ 12" O.C. W/ (3) #3 TIES @  
TOP 5" SUPPLIED BY GENERAL  
CONTRACTOR

**NOTE:**

- TOP OF PIERS SHALL BE SLOPED SUCH THAT MOISTURE CANNOT ACCUMULATE.
- HOT DIPPED GALVANIZED BOLTS
- F1554 GRADE 36 ANCHOR BOLTS
- ANCHOR BOLTS TO BE SET IN ACCORDANCE WITH AISC CODE OF STANDARD PRACTICE
- ANCHOR RODS, NUTS & WASHERS SHALL BE SHIPPED AS AN ASSEMBLY FROM THE SIGN/ LIGHTING MANUFACTURER
- DO NOT CUT ANCHOR BOLTS AFTER INSTALLATION OF POLE

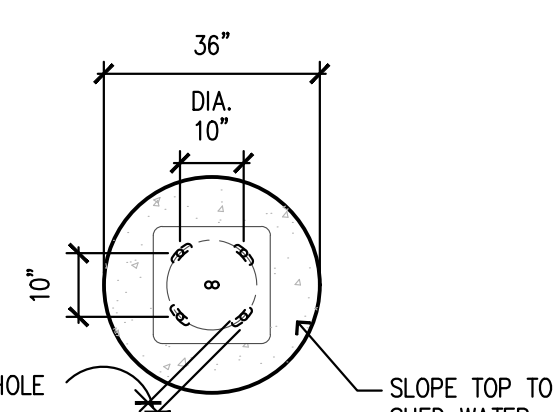


Diagram illustrating the components of the leveling nut assembly:

- 1/2" HEIGHT LOCK NUT (GALVANIZED)
- HEAVY HEX NUT (GALVANIZED)
- GALVANIZED WASHERS (SUPPLIED BY MFR.)
- HEAVY HEX LEVELING NUT (GALVANIZED)


3/4" DIA. GRAD  
DIPPED GALVANI  
ANCHOR BOLT

2"x2"x1/4" PLATE

ANCHOR BOLT

**NOTE:**

- TOP OF PIERS SHALL BE SLOPED SUCH THAT MOISTURE CANNOT ACCUMULATE.
- ANCHOR RODS, NUTS & WASHERS SHALL BE SHIPPED AS AN ASSEMBLY FROM THE SIGN/ LIGHTING MANUFACTURER
- DO NOT CUT ANCHOR BOLTS AFTER INSTALLATION OF POLE

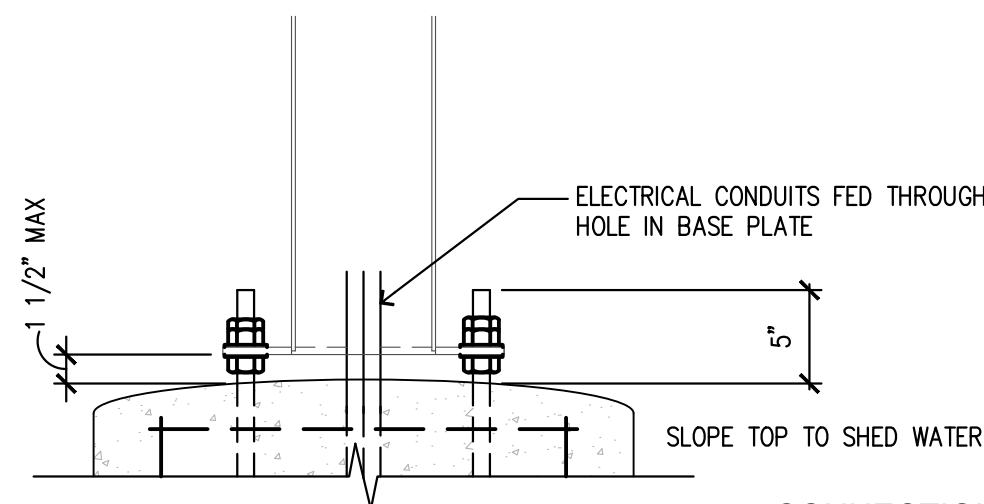

### CONNECTION DETAIL

- DT1.2 SCALE: NOT TO SCALE

[illegible]

REGISTERED ARCHITECT  
SHERRI E. GRUENEIS  
KIRKLAND, WA  
STATE OF OREGON

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|                    |                                    |          |                |             |
|--------------------|------------------------------------|----------|----------------|-------------|
| SHEET NO.          | TITLE                              | DRAWN BY |                |             |
|                    |                                    |          | STD ISSUE DATE | REVIEWED BY |
| DT1.2              | SIDE-BY-SIDE DRIVE THRU REMODEL    | JUL 2021 | SEM            | JUL 2021    |
| PP21-210           |                                    |          |                |             |
| DRIVE-THRU DETAILS |                                    |          |                |             |
| SITE ID            | SITE ADDRESS                       |          |                |             |
| 36-0189            | 3995 Riskey St. SE Salem, OR 97301 |          |                |             |