

NOTICE of FILING

LAND USE REQUEST AFFECTING THIS AREA

There is a development proposal for the property listed in this notice and shown on the attached map. The City is seeking input from neighbors on the proposal. If you have questions or comments about the proposal, contact the case manager.

Esta carta es un aviso sobre una propuesta de desarrollo para la propiedad enumerada y que se muestra en el mapa adjunto. La ciudad está buscando la opinión de los vecinos sobre la propuesta. Si tiene preguntas o comentarios sobre la propuesta, póngase en contacto con nosotros al 503-588-6213.

Subdivision Case No. SUB21-03 CASE NUMBER:

PROPERTY LOCATION: 430 Turtle Bay Court SE, Salem OR 97306

March 29, 2021 **NOTICE MAILING DATE:**

PROPOSAL SUMMARY: A subdivision tentative plan to divide approximately 4.96 acres into 16 lots with

> lots ranging in size from 8,010 square feet to 27,325 square feet. The applicant is requesting an alternative street standard to reduce the street width from 60-feet

to 50-feet.

COMMENT PERIOD: All written comments must be submitted to City Staff no later than 5:00

p.m., Monday, April 12, 2021. Please direct any questions and/or comments

about the case to the Case Manager listed below.

CASE MANAGER: Aaron Panko, Planner III, City of Salem Planning Division, 555 Liberty Street SE,

Room 305, Salem, Oregon 97301. Telephone: 503-540-2356; E-mail:

Neighborhood associations are volunteer organizations of neighbors coming

APanko@cityofsalem.net

NEIGHBORHOOD

together to make neighborhoods the best they can be. They receive notice of land **ASSOCIATION:** use applications within their boundaries, and they often submit comments on the

applications to the City. Neighborhood association meetings are open to everyone.

Contact your neighborhood association to get involved:

South Gateway Neighborhood Association, Glenn Baly, Land Use Co-Chair; Phone: 503-588-6924; Email: glennbaly12345@gmail.com; Mike Hughes, Land

Use Co-Chair; Phone: 503-584-0806; Email: hughes.m@comcast.net.

The Americans with Disabilities Act (ADA) accommodations will be provided on ACCESS:

request.

CRITERIA TO BE

CONSIDERED:

Salem Revised Code (SRC) Chapter 205.010(d) – Subdivision Tentative Plan

Salem Revised Code (SRC) is available to view at this link:

http://bit.ly/salemorcode. Type in the chapter number(s) listed above to view the

applicable criteria.

PROPERTY OWNER(S) / APPLICANT(S):

Robert and Maria Noyes

CONTACT:

Gerald Horner, Willamette Engineering Inc.

PROPOSAL REQUEST:

A subdivision tentative plan to divide approximately 4.96 acres into 16 lots with lots ranging in size from 8,010 square feet to 27,325 square feet. The applicant is requesting an alternative street standard to reduce the street width from 60-feet to 50-feet.

The subject property is approximately 4.96 acres in size, zoned RA (Residential Agriculture), and located at 430 Turtle Bay Court SE - 97306 (Marion County Assessor Map and Tax Lot number: 083W16DD / 00300).

APPLICATION PROCESS:

Following the close of the Public Comment Period, a decision will be issued and mailed to the applicant, property owner, affected neighborhood association, anyone who submitted written comments, and anyone who received notice of the land use request.

Failure to raise an issue in writing prior to the close of the Public Comment Period with sufficient specificity to provide the opportunity to respond to the issue, precludes appeal to the Land Use Board of Appeals (LUBA) on this issue. A similar failure to raise constitutional issues relating to proposed conditions of approval precludes an action for damages in circuit court.

MORE INFORMATION:

Documents and evidence submitted by the applicant are available for review and paper copies can be obtained at a reasonable cost. You can also find out more information about the status of the proposed application on the City's online Permit Application Center at https://permits.cityofsalem.net. Just enter the permit number listed here: 20 119160

PLEASE PROMPTLY FORWARD A COPY OF THIS NOTICE TO ANY OTHER OWNER, TENANT OR LESSEE For more information about Planning in Salem:

http://www.cityofsalem.net/planning

It is the City of Salem's policy to assure that no person shall be discriminated against on the grounds of race, religion, color, sex, marital status, familial status, national origin, age, mental or physical disability, sexual orientation, gender identity and source of income, as provided by Salem Revised Code Chapter 97. The City of Salem also fully complies with Title VI of the Civil Rights Act of 1964, and related statutes and regulations, in all programs and activities. Disability-related modification or accommodation, including auxiliary aids or services, in order to participate in this meeting or event, are available upon request. Sign language and interpreters for languages other than English are also available upon request. To request such an accommodation or interpretation, contact the Community Development Department at 503-588-6173 at least three business days before this meeting or event.

TTD/TTY telephone 503-588-6439 is also available 24/7

REQUEST FOR COMMENTS

Subdivision Case No. SUB21-03

REGARDING:

Si necesita ayuda para comprender esta informacion, por favor llame 503-588-6173

PROJECT ADDRESS: 430 Turtle Bay Court SE, Salem OR 97306 **AMANDA Application No.:** 20-119160-LD COMMENT PERIOD ENDS: Monday, April 12, 2021 at 5:00 PM **REQUEST:** A subdivision tentative plan to divide approximately 4.96 acres into 16 lots with lots ranging in size from 8,010 square feet to 27,325 square feet. The applicant is requesting an alternative street standard to reduce the street width from 60-feet to 50-feet. The subject property is approximately 4.96 acres in size, zoned RA (Residential Agriculture), and located at 430 Turtle Bay Court SE - 97306 (Marion County Assessor Map and Tax Lot number: 083W16DD / 00300). The Planning Division is interested in hearing from you about the attached proposal. Staff will prepare a Decision that includes consideration of comments received during this comment period. We are interested in receiving pertinent, factual information such as neighborhood association recommendations and comments of affected property owners or residents. The complete case file, including all materials submitted by the applicant and any applicable professional studies such as traffic impact analysis, geologic assessments, and stormwater reports, are available upon request. Comments received by 5:00 p.m., Monday, April 12, 2021, will be considered in the decision process. Comments received after this date will be not considered. **PLEASE NOTE: City offices have very limited staffing due to COVID-19. To ensure that your comments are received by the deadline, we recommend that you e-mail your comments to the Case Manager listed below.** CASE MANAGER: Aaron Panko, Planner III, Phone: 503-540-2356; E-Mail: APanko@cityofsalem.net. For information about Planning in Salem, please visit: http://www.cityofsalem.net/planning PLEASE CHECK THE FOLLOWING THAT APPLY: 1. I have reviewed the proposal and have no objections to it. 2. I have reviewed the proposal and have the following comments: Name/Agency: Address:

IMPORTANT: IF YOU MAIL COMMENTS, PLEASE FOLD AND RETURN THIS POSTAGE-PAID FORM




BUSINESS REPLY MAIL FIRST-CLASS MAIL PERMIT NO. 1508 SALEM, OR


POSTAGE WILL BE PAID BY ADDRESSEE

PLANNING DIVISION CITY OF SALEM RM 305 555 LIBERTY ST SE SALEM OR 97301-9907 NO POSTAGE NECESSARY IF MAILED IN THE UNITED STATES

լանալույնին-ակարհրդիկինությունների ակարարակ**ն**

Vicinity Map 430 Turtle Bay Court SE

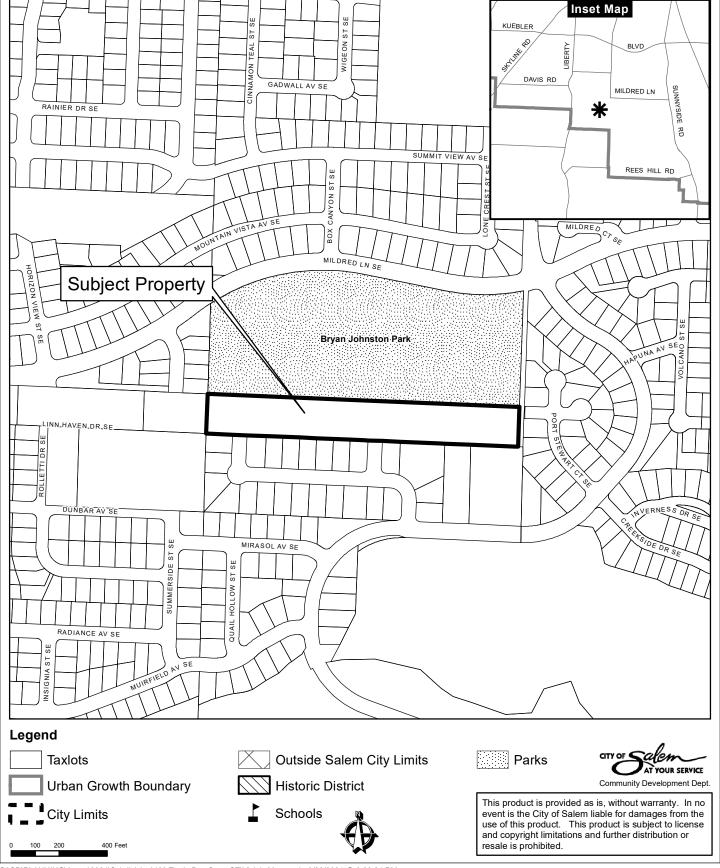

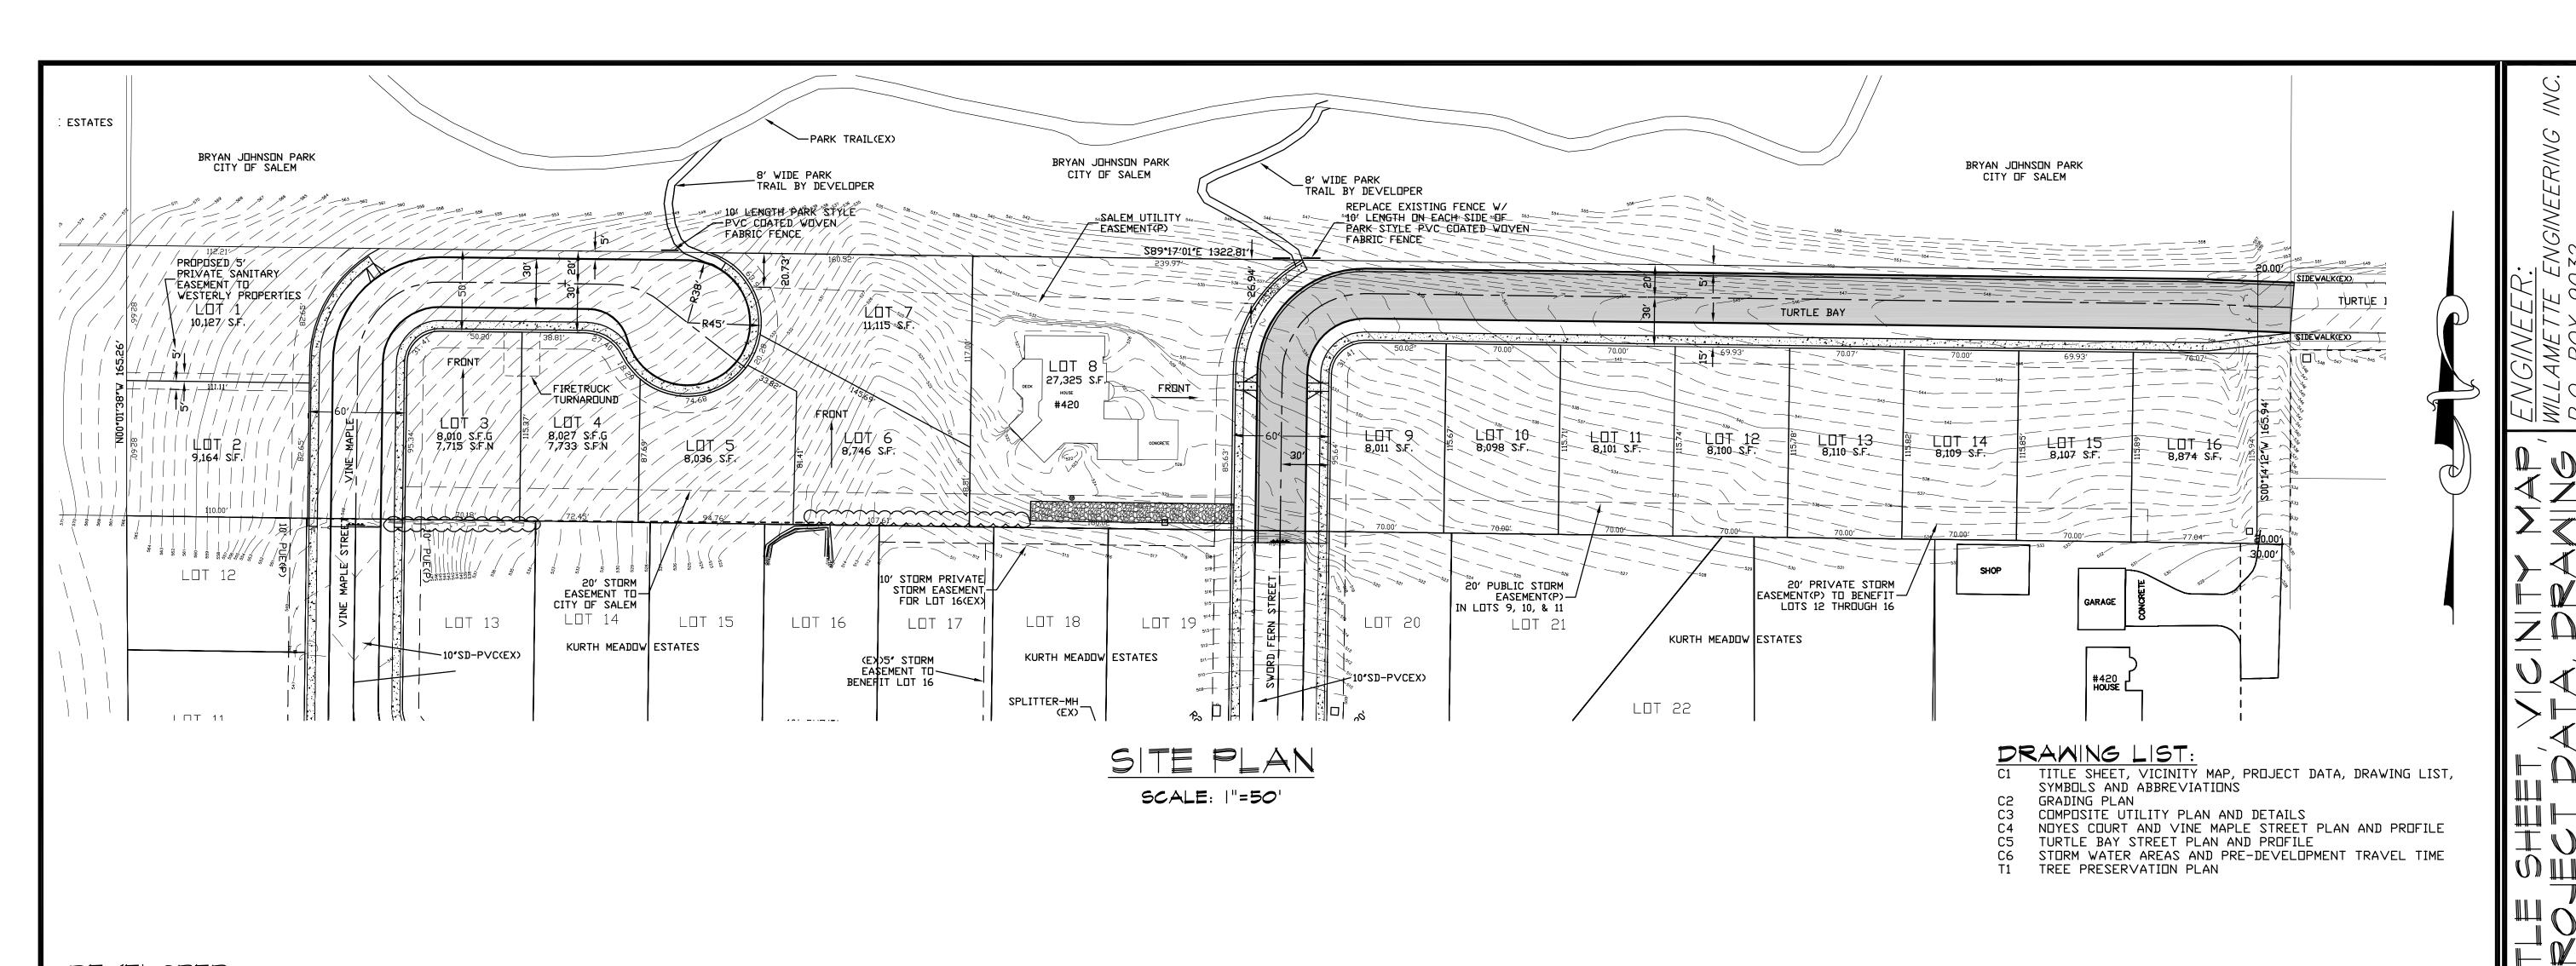

ROBERT NOYES AND MARIA NOYES 430 TURTLE BAY COURT SE SALEM OR 97306

SUBDIVISION DATA:

Z8 QIHZNWUT RANGE 3W SECTION 21 MARION COUNTY

LOTS - 16

AVERAGE S.F. - 9,170 SQUARE FEET LOTS/ACRE - 3.19 TOTAL ACREAGE - 5.02 ACRES

SURVEY DATUM:

CITY OF SALEM 1/4 CORNER 083W15 BRASS DIŚK IN MONUMENT BOX DOWN 14.5" ELEVATION 439.016

ABBREVIATIONS:

AC - ASPHALTIC CONCRETE INV - INVERT AD - ALGEBRAIC DIFFERENCE K - DESIGN CONSTANT ALCSP - ALUMINIZED CORRUGATED L - LENGTH,LINE STEEL PIPE LP - LIGHT POLE ASSY - ASSEMBLY NTS - NOT TO SCALE BVCE - BEGINNING V.C. ELEVATION MC - MARION COUNTY BVCS - BEGIN V.C. STATION MH - MANHOLE BO - BLOW OFF M - METER BFV - BUTTERFLY VALVE MJ - MECHANICAL JOINT C&G - CURB AND GUTTER ML - MEGALUG JOINT CB - CATCH BASIN P - PROPOSED CHDPE - CORRUGATED HIGH PED - PEDESTAL DENSITY POLYPROPELENE PVC - POLYVINYL CHLORIDE CL - CENTERLINE PP - POWER POLE CMP - CORRUGATED METAL PIPE PL - PROPERTY LINE CO - CLEANOUT R - RADIUS CONC - CONCRETE RD - ROOF DRAIN COSSD - CITY OF SALEM STANDARD ROW - RIGHT-OF-WAY COKSD - CITY OF KEIZER STANDARD SS - SANITARY SEWER S — SLOPE SCH — SCHEDULE DRAWING CUL - CULVERT ST - STATION DI - DUCTILE IRON ST - STREET

DS - DOWN SPOUT

EG - EXISTING GROUND/GRADE

EL - ELEVATION
ER - ENTERING RADIUS
EVCE - ENDING V.C. ELEVATION

EVCS - ENDING V.C. STATION

EP - EDGE OF PAVEMENT

DWG - DRAWING

ELEC - ELECTRIC

FF - FINISH FLOOR

FG - FINISH GRADE

FH - FIRE HYDRANT

FM - FORCE MAIN

INT - INTERSECTION

STD - STANDARD

SVC - SERVICE

TYP - TYPICAL

SD - STORM DRAIN

TC - TOP OF CURB

VC - VERTICAL CURVE

PC - POINT OF CURVE

PT — POINT OF TANGENT PERF — PERFORATED

WM - WATER MAIN

TEL - TELEPHONE

SYMBOLS:

EXISTING BLOW OFF ASSY. PROPOSED BLOW OFF ASSY. EXISTING CATCH BASIN PROPOSED TYPE 1 CATCH BASIN PROPOSED TYPE 2 CATCH BASIN PROPOSED TYPE 3 CATCH BASIN PROPOSED TYPE 4 CATCH BASIN PROPOSED CLEANOUT EXISTING CLEANOUT PROPOSED FIRE HYDRANT EXISTING FIRE HYDRANT PROPOSED GATE VALVE EXISTING GATE VALVE EXISTING STORM DRAIN MANHOLE PROPOSED STORM DRAIN MANHOLE EXISTING SEWER MANHOLE PROPOSED SEWERMANHOLE ■ PROPOSED REDUCER/INCREASER ☐ EXISTING REDUCER/INCREASER * PROPOSED STREET LIGHT **☼**→ EXISTING STREET LIGHT PROPOSED WATER METER EXISTING WATER METER PROPOSED UTILITY POLE EXISTING UTILITY POLE — - — CENTER LINE ---- EASEMENT LINE ——

T—— ELECTRICAL LINE ----GAS MAIN --- SANITARY SEWER —⊸— STORM DRAIN TELEPHONE — - - — WATER MAIN

----F----FIBER OPTIC

> THRUST BLOCK

- RIGHT OF WAY

S RAINER 1. FOUNTAINHEAD ST WAS STONE OF THE BAY S SUSSEX AYS AG NAVAH INHAL 6000 THARBOURTOWN! MIRASOL AV CT 100 miles CREKSIDE GOLF COURSE VICINITY MAP

FOR APPLICATION NOT FOR CONSTRUCTION



22×34 SCALE: 1"=40'	
11×17 SCALE: 1"=80'	


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				DESIGNED BY:	GPH	
REV.	DATE	BY	NESCRIPTION	DRAWN BY:	RW	
`	22			DATE:	03-10-	21
0	03-10-21	GPH		JOB NO.	2020-2	21
				CLIENT NO.		
				DRAWING NO.		REV.

ASPHALT LEGEND

EXISTING ASPHALT PROPOSED ASPHALT

SPECIAL INSTRUCTIONS

- ALL CONSTRUCTION SHALL BE IN ACCORDANCE WITH THE CITY OF SALEM STANDARD CONSTRUCTION SPECIFICATIONS AND ANY SPECIAL PROVISIONS INCLUDED AS A PART OF THE
- ATTENTION: OREGON LAW REQUIRES YOU TO FOLLOW RULES ADOPTED BY THE OREGON UTILITY NOTIFICATION CENTER. THOSE RULES ARE SET FORTH IN OAR 952-001-0010 THROUGH 952-001-0090. YOU MAY OBTAIN COPIES OF THE RULES BY CALLING THE CENTER THE TELEPHONE NUMBER FOR THE OREGON UTILITY NOTIFICATION CENTER IS 503-232-1987.

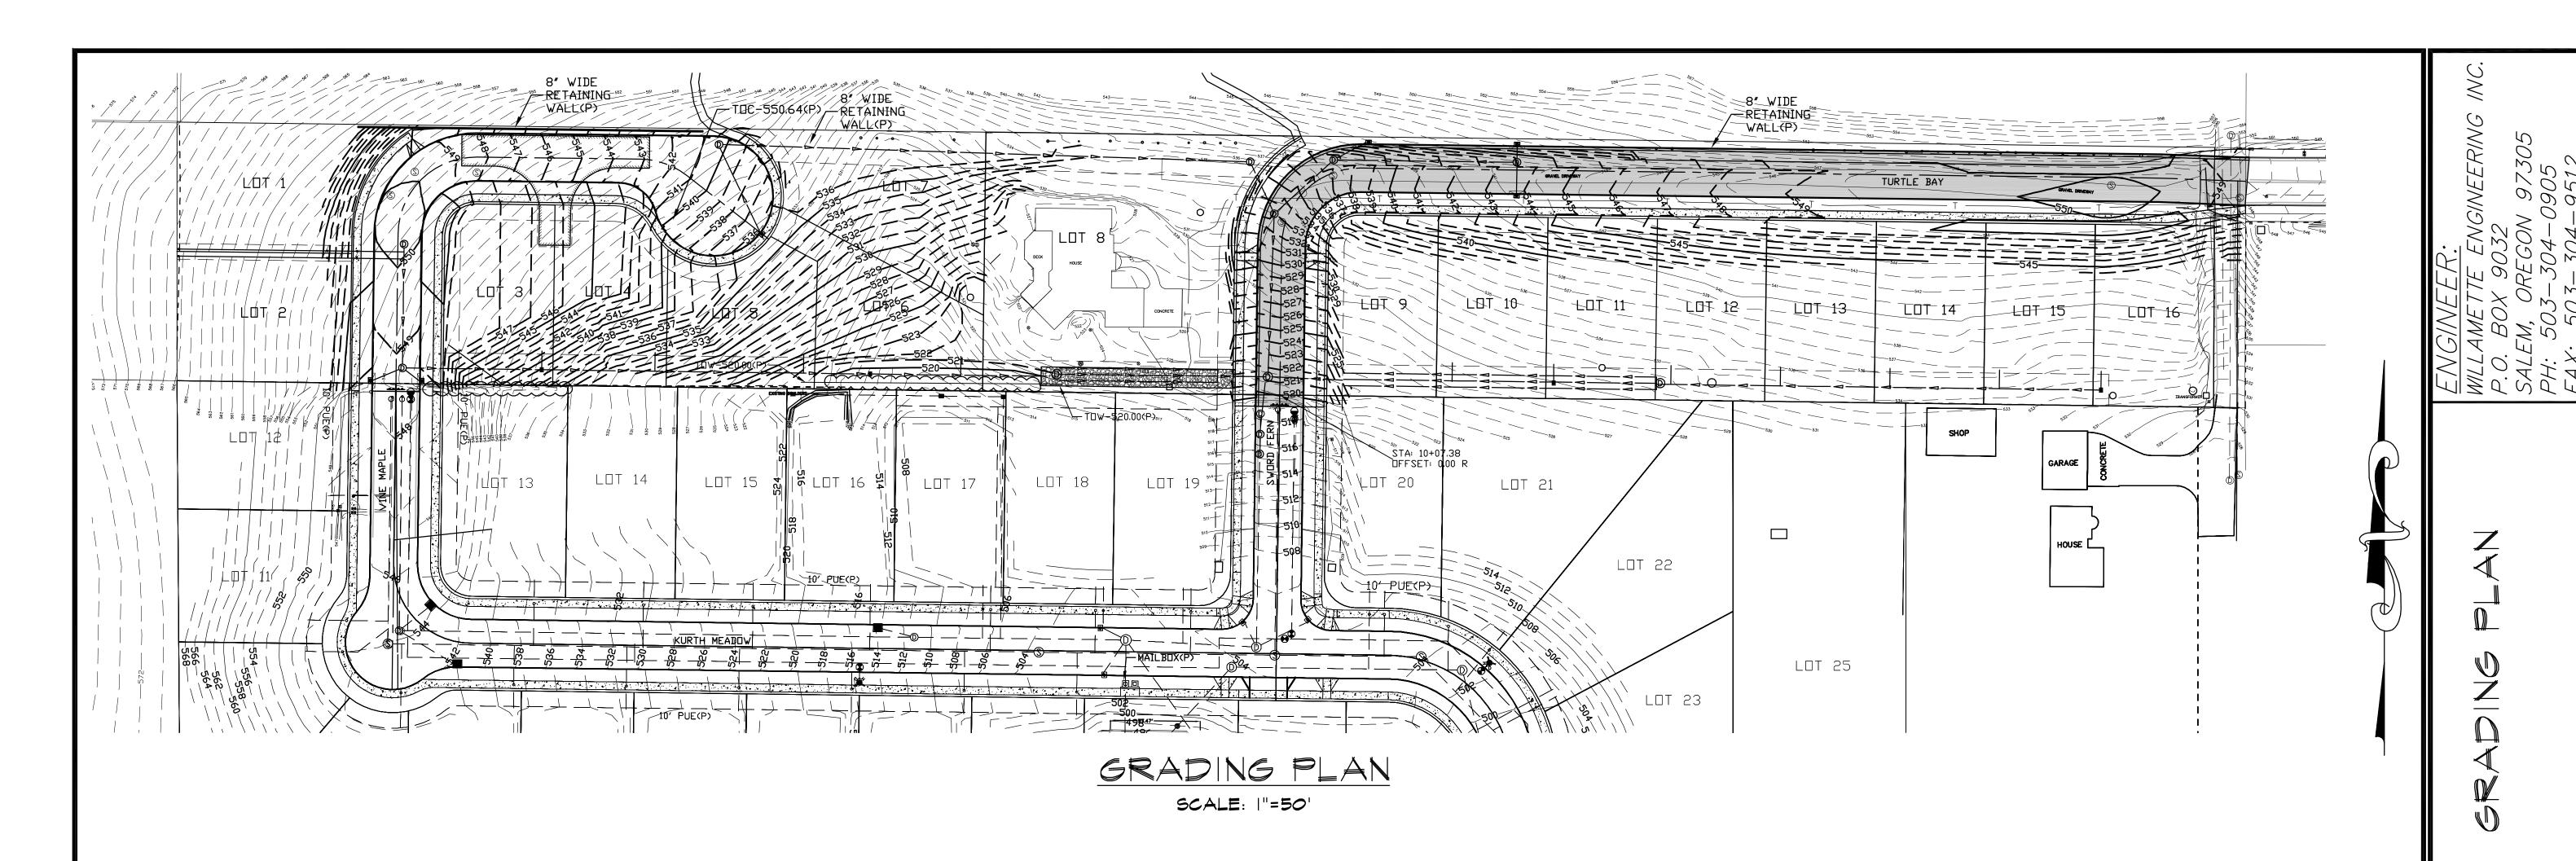

GENERAL EARTHWORK SPECIFICATIONS:

1. ALL AREAS WHERE STRUCTURAL FILLS, FILL SLOPES, STRUCTURES OR ROADWAYS ARE TO BE CONSTRUCTED SHALL BE STRIPPED OF ORGANIC TOPSOIL AND CLEARED OF SURFACE AND SUBSURFACE DELETERIOUS MATERIAL, INCLUDING BUT NOT LIMITED TO VEGETATION, ROOTS, OR OTHER ORGANIC MATERIAL, UNDOCUMENTED FILL, CONSTRUCTION DEBRIS, SOFT OR UNSUITABLE SOILS AS DIRECTED BY THE GEOTECHNICAL ENGINEER OF RECORD. THESE MATERIALS SHALL BE REMOVED FROM THE SITE OR STOCKPILED IN A DESIGNATED LOCATION FOR REUSE IN LANDSCAPE AREAS IF SUITABLE FOR THAT PURPOSE. EXISTING UTILITIES AND STRUCTURES THAT ARE NOT TO BE USED AS PART OF THE PROJECT DESIGN OR BY NEIGHBORING FACILITIES, SHALL BE REMOVED OR PROPERLY ABANDONED, AND THE ASSOCIATED DEBRIS REMOVED FROM THE SITE.

2. UPON COMPLETION OF SITE STRIPPING AND CLEARING, THE EXPOSED SOIL AND/OR ROCK SHALL BE OBSERVED BY THE GEOTECHNICAL ENGINEER OF RECORD OR A DESIGNATED REPRESENTATIVE TO ASSESS THE SUBGRADE CONDITION FOR THE INTENDED OVERLYING USE. PITS, DEPRESSIONS, OR HOLES CREATED BY THE REMOVAL OF ROOT WADS, UTILITIES, STRUCTURES, OR DELETERIOUS MATERIAL SHALL BE PROPERLY CLEARED OF LOOSE MATERIAL, BENCHED AND BACKFILLED WITH FILL MATERIAL APPROVED BY THE GEOTECHNICAL ENGINEER OF RECORD COMPACTED TO THE PROJECT SPECIFICATIONS.

3. IN STRUCTURAL FILL AREAS, THE SUBGRADE SOIL SHALL BE SCARIFIED TO A DEPTH OF 4-INCHES, IF SOIL FILL IS USED, MOISTURE CONDITIONED TO WITHIN 2% OF THE MATERIALS OPTIMUM MOISTURE FOR COMPACTING, AND BLENDED WITH THE FIRST LIFT OF FILL MATERIAL. THE FILL PAVEMENT AND COMPACTION EQUIPMENT SHALL BE APPROPRIATE FOR FILL MATERIAL TYPE, REQUIRED DEGREE OF BLENDING, AND UNCOMPACTED LIFT THICKNESS. ASSUMING PROPER EQUIPMENT SELECTION, THE TOTAL UNCOMPACTED THICKNESS OF THE SCARIFIED SUBGRADE AND FIRST FILL LIFT SHALL NOT EXCEED 8-INCHES, SUBSEQUENT LIFTS OF UNCOMPACTED FILL SHALL NOT EXCEED 8-INCHES UNLESS OTHERWISE APPROVED BY THE GEOTECHNICAL ENGINEER OF RECORD. THE UNCOMPACTED LIFT THICKNESS SHALL BE ASSESSED BASED ON THE TYPE OF COMPACTION EQUIPMENT USED AND RESULTS OF INITIAL COMPACTION TESTING, FINE-GRAINED SOIL FILL IS GENERALLY MOST EFFECTIVELY COMPACTED USING A KNEADING STYLE COMPACTOR, SUCH AS A SHEEPS-FOOT ROLLER, WHERE AS GRANULAR MATERIALS ARE MORE EFFECTIVELY COMPACTOR.

4. ALL STRUCTURAL SOIL FILL SHALL BE WELL BLENDED, MOISTURE CONDITIONED TO WITHIN 2% OF THE MATERIAL'S OPTIMUM MOISTURE CONTENT FOR COMPACTION AND COMPACTED TO AT LEAST 90% OF THE MATERIAL'S MAXIMUM DRY DENSITY AS DETERMINED BY ASTM METHOD D-1557, OR AN EQUIVALENT METHOD, SOIL FILL SHALL NOT CONTAIN MORE THAN 10% ROCK MATERIAL AND NO SOLID MATERIAL OVER 3-INCHES IN DIAMETER UNLESS APPROVED BY THE GEOTECHNICAL ENGINEER OF RECORD, ROCKS SHALL BE EVENLY DISTRIBUTED THROUGHOUT EACH LIFT OF FILL THAT THEY ARE CONTAINED WITHIN AND SHALL NOT BE CLUMPED TOGETHER IN SUCH A WAY THAT VOIDS CAN OCCUR.

5. ALL STRUCTURAL GRANULAR FILL SHALL BE WELL BLENDED, MOISTURE CONDITIONED AT OR UP TO 3% ABOVE OF THE MATERIAL'S OPTIMUM MOISTURE CONTENT FOR COMPACTION AND COMPACTED TO AT LEAST 95% OF THE MATERIAL'S MAXIMUM DRY DENSITY AS DETERMINED BY ASTM METHOD D-1557 OR AN EQUIVALENT METHOD. THE GRANULAR FILL SHALL NOT CONTAIN SOLID PARTICLES OVER 2-INCHES IN DIAMETER UNLESS SPECIAL DENSITY TESTING METHODS OR PROOF-ROLLING IS APPROVED BY THE GEOTECHNICAL ENGINEER OF RECORD. GRANULAR FILL IS GENERALLY CONSIDERED TO BE A CRUSHED AGGREGATE WITH A FRACTURE SURFACE OF AT LEAST 70% AND A MAXIMUM SIZE NOT EXCEEDING 1.5 INCHES IN DIAMETER, WELL-GRADED WITH LESS THAN 10%, BY WEIGHT, PASSING THE NO. 200 SIEVE.

6. STRUCTURAL FILL SHALL BE FIELD TESTED FOR COMPLIANCE WITH PROJECT SPECIFICATIONS FOR EVERY 2-FEET IN VERTICAL RISE OR 500 CUBIC YARD PLACED, WHICHEVER IS LESS. IN-PLACE FILL DENSITY TESTING SHALL BE PERFORMED BY A COMPETENT INDIVIDUAL TRAINED IN THE TESTING AND PLACEMENT OF SOIL AND AGGREGATE FILL PLACEMENT, USING EITHER ASTM METHOD D-1556/4959/4944 (SAND CONE), D-6938 (NUCLEAR DENSOMETER), OR D-2937/4959/4944 (DRIVE CYLINDER). SHOULD THE FILL MATERIALS NOT BE SUITABLE FOR TESTING BY THE ABOVE METHODS, THEN OBSERVATION OF PLACEMENT, COMPACTION AND PROOF-ROLLING WITH A LOADED 10 CUBIC YARDS DUMP TRUCK, OR EQUIVALENT GROUND PRESSURE EQUIPMENT, BY A TRAINED INDIVIDUAL MAY BE USED TO ASSESS AND DOCUMENT THE COMPLIANCE WITH STRUCTURAL FILL SPECIFICATIONS.

ROOF DRAIN LEGEND:

- INDICATES 3" PVC SLEEVE THROUGH CURB FOR HOUSE ROOF DRAIN. ONE PER HOUSE LOTS 1, 10-19, & 20-23. ALL SLEEVES.

22×34 SCALE: 1"=40' 11×17 SCALE: 1"=80'

REV.

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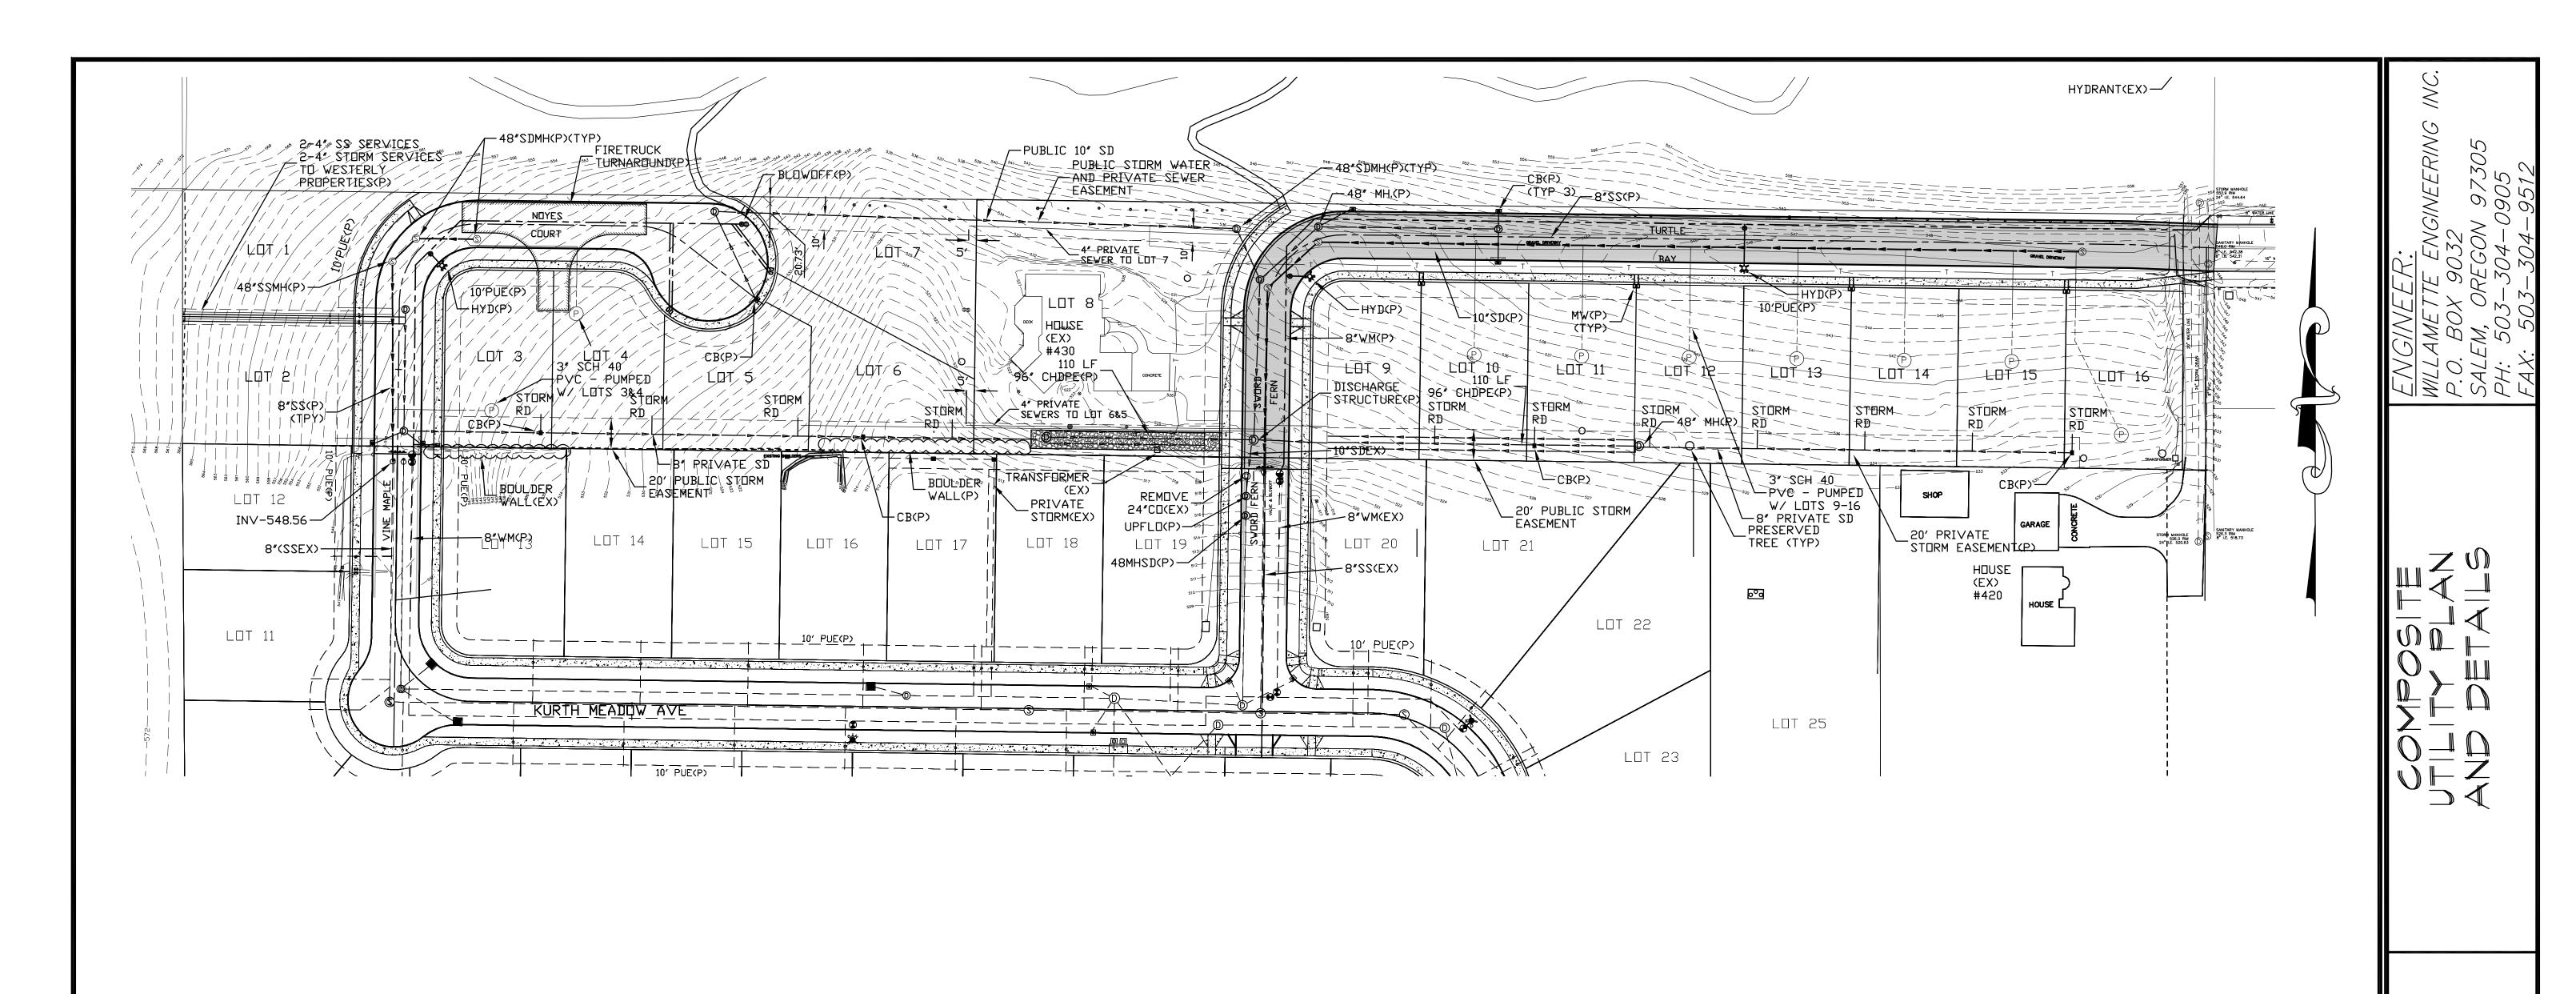


SCALE: 1"=80'

				DESIGNED BY: GPH
, .	DATE	BY	DESCRIPTION	DRAWN BY: RW
Ů				DATE: 03-10-21
	03-10-21	GPH	ISSUED FOR SUBDIVISION APPLICATION	JOB NO. 2020-21
				CLIENT NO.
				DRAWING NO. REV.

FOR APPLICATION


NOT FOR CONSTRUCTION



UTILITY PLAN

SCALE: 22×34 |"=50', ||x|7 |"=100'

SCALE: 1" = 1'-0"

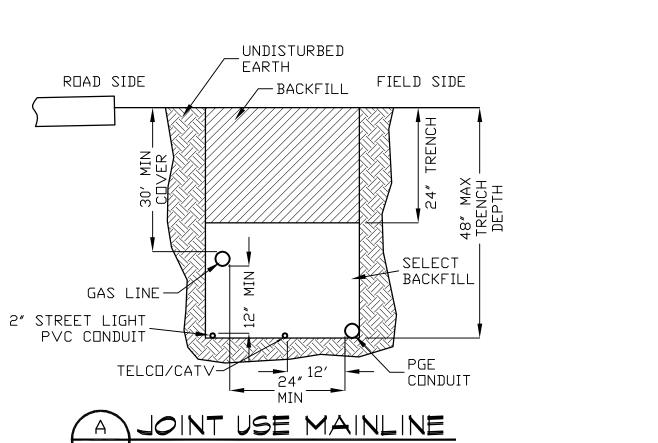

LATCH LID ON LID MUST FACE TOWARD STREET. INSTALL PEDESTAL WITH FINAL GRADE AT "GROUND LEVEL" MARK ON CASE. PEDESTAL MUST BE INSTALLED LEVEL WITH HORIZON. DUCT TO SERVICE MARK, CAP AND INSTALL 20' OF 500# PULL STRING SECTION SCALE: 1' = 1'-0' SECONDARY SPLICE PEDESTAL

> ALL SECONDARY PEDESTALS (PF-300) TO BE INSTALLED ON PROPERTY LINES WITHIN THE UTILITY EASEMENT AND AT FINAL GRADE. ALTERNATE LOCATIONS MUST BE APPROVED BY PGE AND WILL BE NOTED ON THE SKETCH, COST FOR RELOCATIONS OR ADJUSTMENTS OF PEDESTALS WILL BE THE RESPONSIBILITY OF THE REQUESTING PARTY (BUILDER/DEVELOPER), PGE APPROVALS OF INSTALLATION WILL BE BASED ON FINAL GRADE AND LOCATION CRITERIA SET BY THE DEVELOPER OR HIS AGENT.

FOR APPLICATION NOT FOR CONSTRUCTION

NG NORTHWEST NATURAL GAS CL CENTURY LINK COM COMCAST PGE PORTLAND GENERAL ELECTRIC L STREET LIGHT (CITY OF SALEM)


CONTRACTOR SHALL INSTALL STREET CROSSINGS. 2. ALL CROSSINGS MUST BE INSPECTED BEFORE

COVERING. CONTRACTOR SHALL CONTACT CITY OF SALEM FOR STREETLIGHT CROSSING AND ALL PRIVATE UTILITY COMPANIES FOR THEIR CONDUITS.



EXPIRES: JUNE 30, 2021

				DESIGNED BY: GPH
_V.	DATE	BY	I NESCRIPTION	DRAWN BY: RW DATE: 03-11-21
)	03-11-21	GPH		JOB NO. 2020-21 CLIENT NO.
				DRAWING NO. REV.
				630

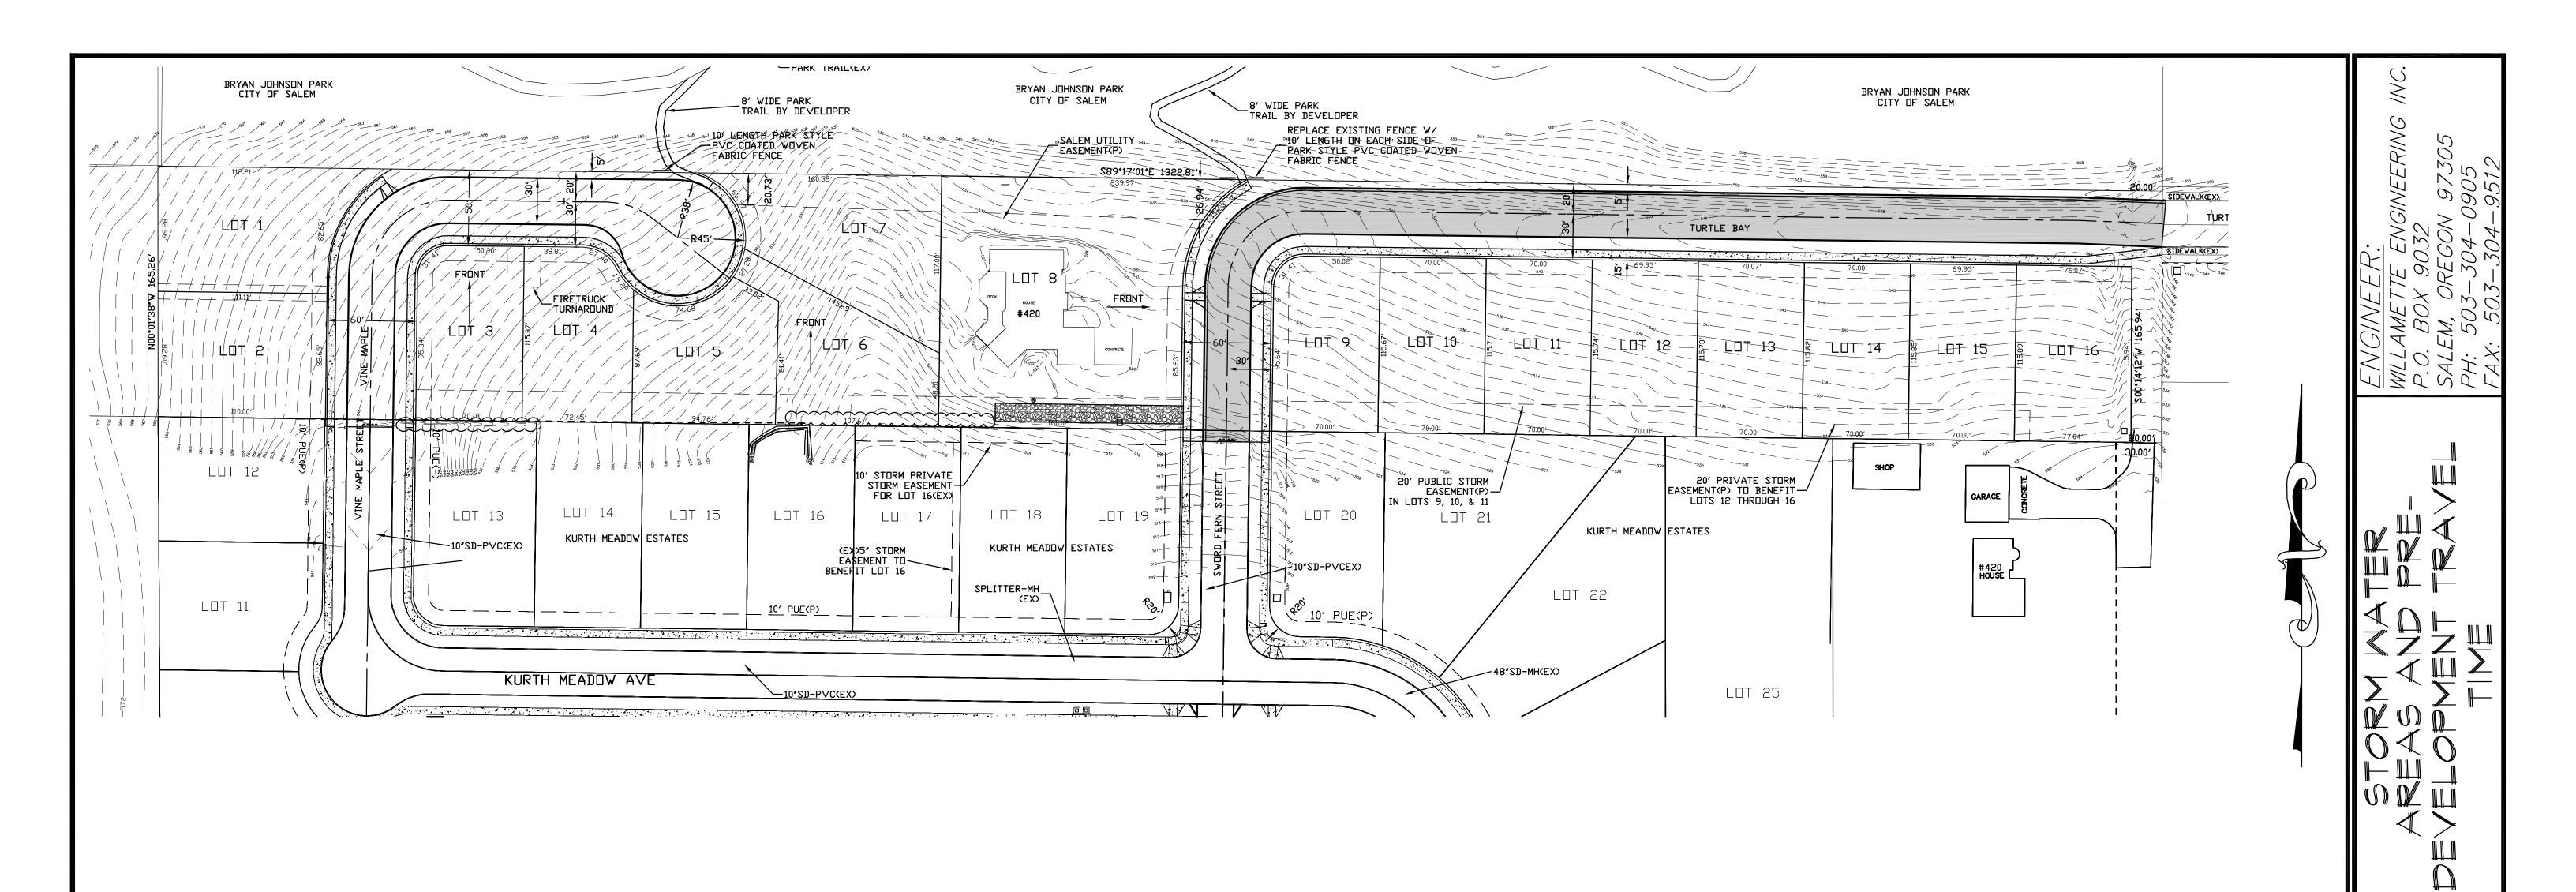

STORM MATER AREAS AND PRE-DEVELOPMENT TRAVEL TIME

SCALE: |"=50'

SPRING QUAIL VILLAGE PERVIOUS AND IMPERVIOUS AREAS

EXISTING HOUSE AND APRONS: NEW STREETS: 14 NEW HOUSES: 14 x 2,500 SQ. FEET 35,000 SQUARE FEET

5.02 ACRES(218,881 SQUARE FEET) 4,700 SQUARE FEET 27,750 SQUARE FEET

14 NEW DRIVEWAYS: 14 x 30' x 25' 10,500 SQUARE FEET 14 NEW PATIOS: 14 x 20' x 20' 5,600 SQUARE FEET 7,250 SQUARE FEET SIDEWALKS

TRAVEL TIME ON WEST SIDE 564' - 520' = 10%

I = 0.82" FOR 30 MINUTES

 $T = 0.93(300^6)(.30^6)$ = 30 MINUTES (0.82^{,4}) (0.10)

NORTH OFFSITE

PERVIOUS AND IMPERVIOUS AREAS 11.90 ACRES(518,170 SQUARE FEET) 3,500 SQUARE FEET

EXISTING HOUSE AND APRONS: 261 SUMMERSIDE BRUSH AND GRASS:

514,670 SQUARE FEET TRAVEL TIME ON NORTH OFFSITE

 $\frac{596' - 540'}{525'} = 10.7\%$

I = 0.82" FOR 30 MINUTES

 $T = 0.93(300^{\circ})(.30^{\circ}) = 30 \text{ MINUTES}$ (0.82[°]) (0.107)

SPRING QUAIL VILLAGE

TREES THERE ARE 21 EXISTING TREES TO BE SAVED AND

AT LEAST TWO(2) TREES PLANTED PER LOT. THIS AMOUNTS TO A TOTAL POTENTIAL REDUCTION IN IMPERVIOUS AREA OF 1,610 SQUARE FEET OR 0.058 ACRES 14 LOTS - 14 x 2 x 20 SQUARE FEET = 560 SQUARE FEET.


21 TREES x 50 SQUARE FEET PER TREE = 1,050 SQUARE FEET

FOR APPLICATION NOT FOR CONSTRUCTION



				DESIGNED BY:	5PH
REV.	DATE	BY	DESCRIPTION		RW -10-21
0	03-10-21	GPH	ISSUED FOR SUBDIVISION APPLICATION		20-21
				DRAWING NO.	REV.

XPIRES: JUNE 30, 2021	.	
	DESIGNED BY:	GPH
	DRAWN BY:	RW
	DATE:	03-10-2
	JOB NO.	2020-2
	CLIENT NO.	
	DRAWING NO.	

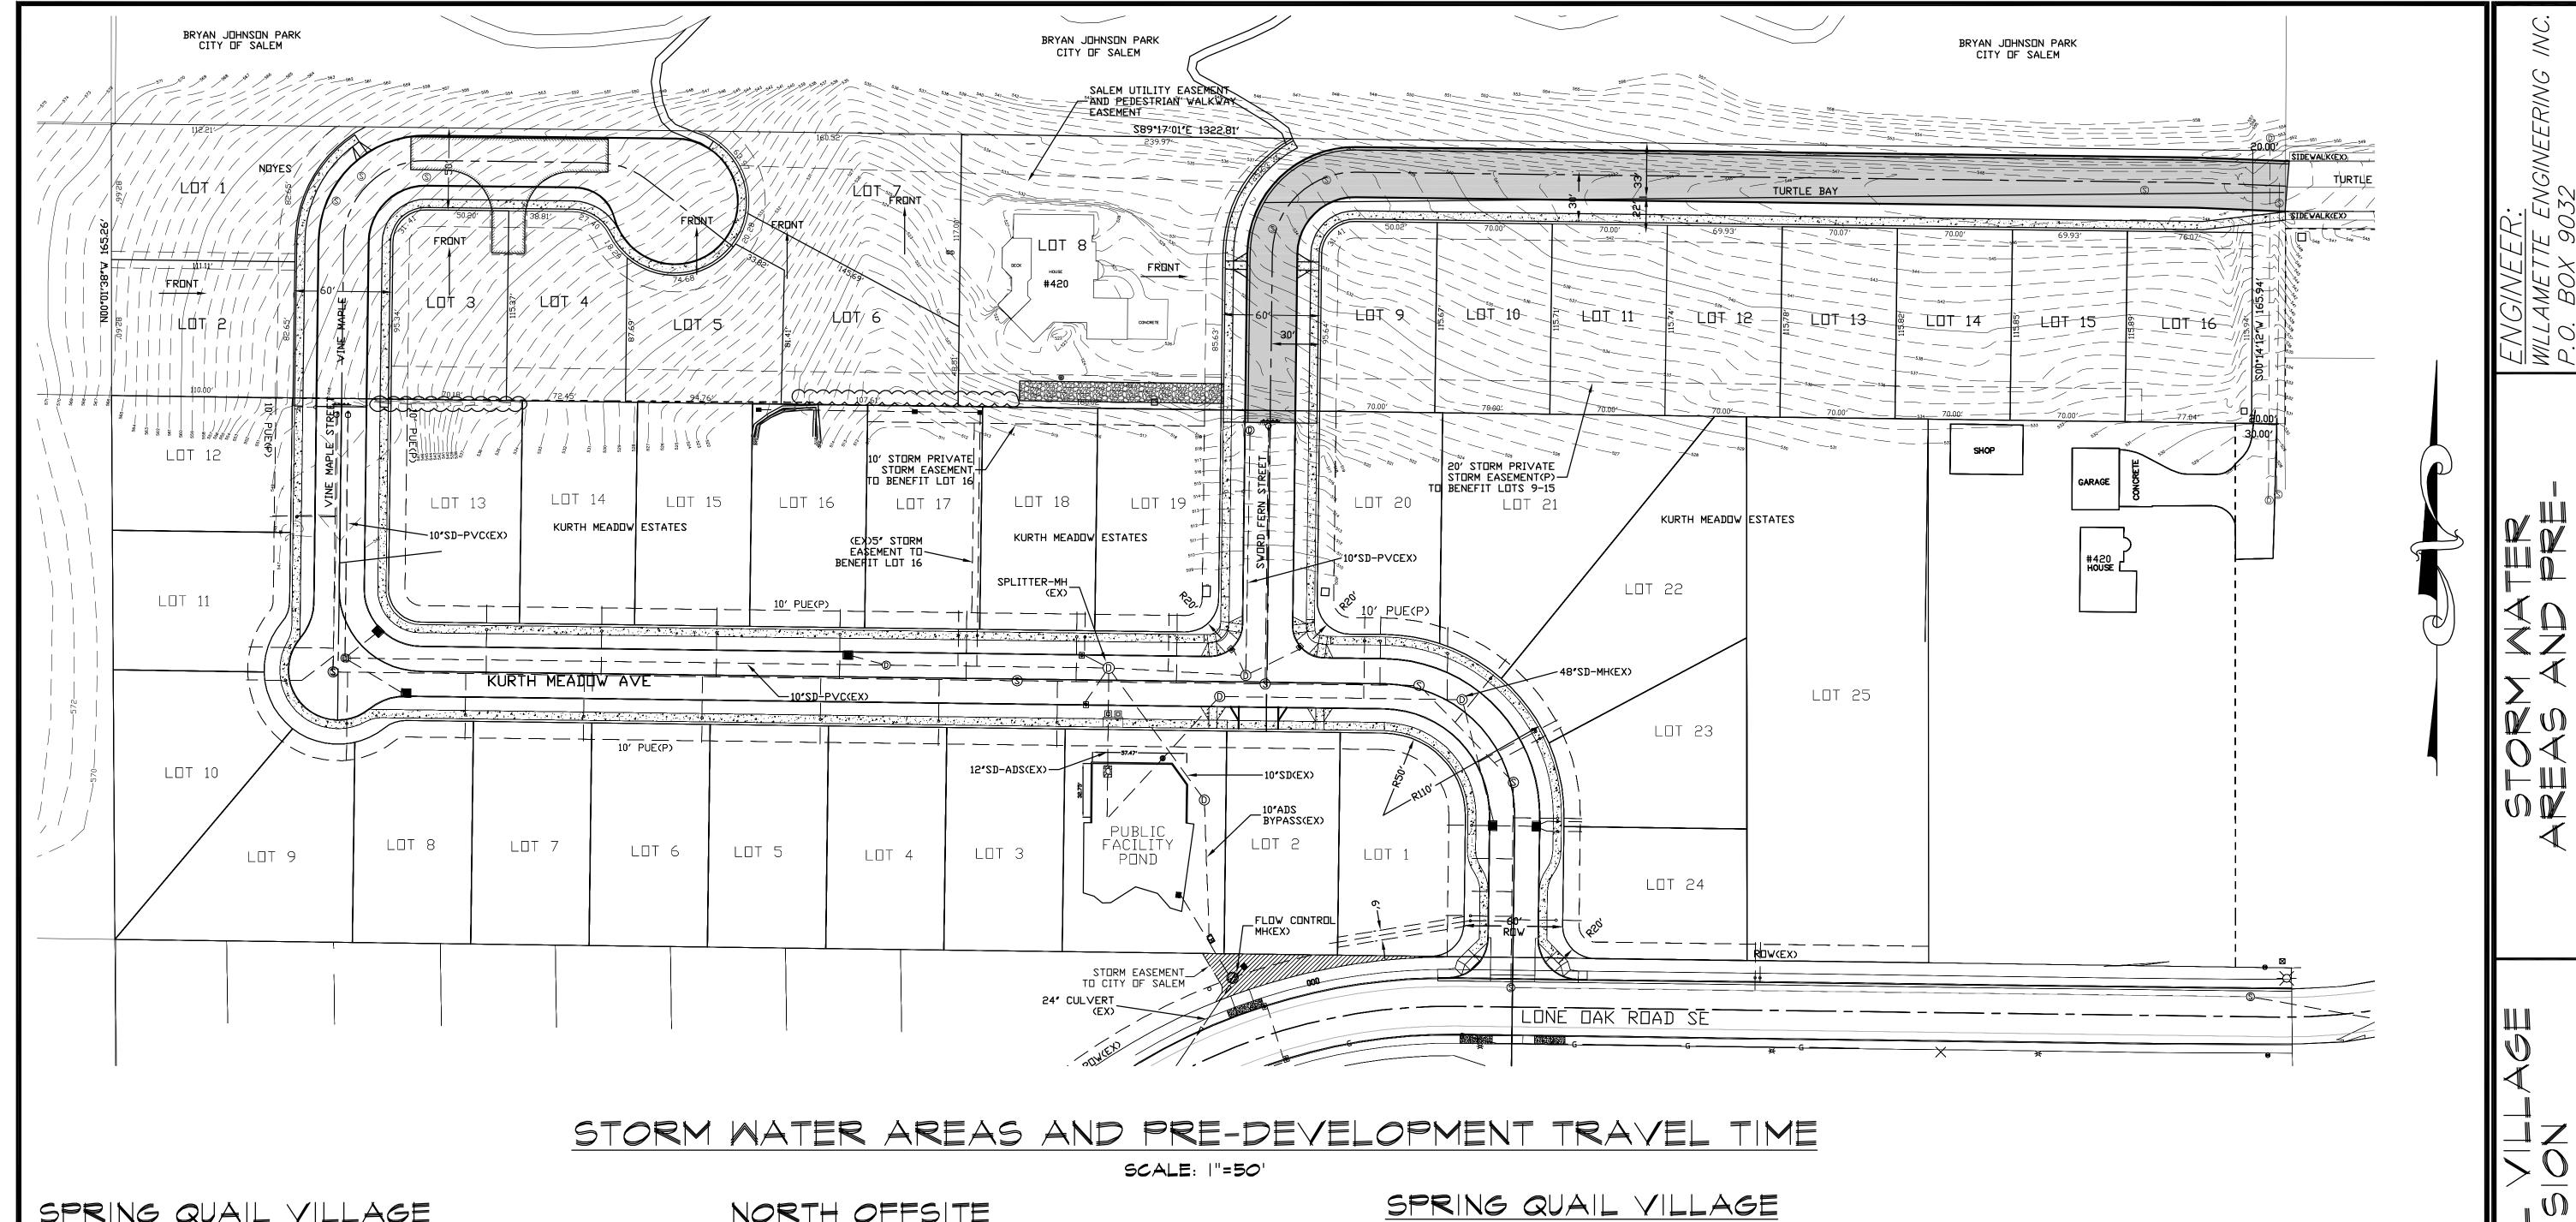

SPRING QUAIL VILLAGE PERVIOUS AND IMPERVIOUS AREAS

EXISTING HOUSE AND APRONS: **NEW STREETS:** 14 NEW HOUSES: 14 x 2,500 SQ. FEET 35,000 SQUARE FEET 14 NEW DRIVEWAYS: 14 x 30' x 25' 10,500 SQUARE FEET 14 NEW PATIOS: 14 x 20' x 20'

5.02 ACRES(218,881 SQUARE FEET) 4,700 SQUARE FEET 32,350 SQUARE FEET

5,600 SQUARE FEET 14,000 SQUARE FEET

TRAVEL TIME ON WEST SIDE 564'-520' = 10%

SIDEWALKS

 $T = 0.93(300^6)(.30^6)$ = 30 MINUTES (0.82^{,4}) (0.10)

I = 0.82" FOR 30 MINUTES

NORTH OFFSITE

PERVIOUS AND IMPERVIOUS AREAS

11.90 ACRES(518,170 SQUARE FEET) 3,500 SQUARE FEET

TOTAL SITE: EXISTING HOUSE AND APRONS: 261 SUMMERSIDE BRUSH AND GRASS:

I = 0.82" FOR 30 MINUTES

514,670 SQUARE FEET TRAVEL TIME ON NORTH OFFSITE

 $\frac{596' - 540'}{525'} = 10.7\%$ $T = 0.93(300^{\circ})(.30^{\circ}) = 30 \text{ MINUTES}$ (0.82^{.4}) (0.107)

TREES

THERE ARE 39 EXISTING TREES TO BE SAVED AND AT LEAST TWO(2) TREES PLANTED PER LOT. THIS AMOUNTS TO A TOTAL POTENTIAL REDUCTION IN IMPERVIOUS AREA OF 2,510 SQUARE FEET OR 0.058 ACRES

14 LOTS - 14 x 2 x 20 SQUARE FEET = 560 SQUARE FEET. 39 TREES x 50 SQUARE FEET PER TREE = 1,950 SQUARE FEET

FOR APPLICATION NOT FOR CONSTRUCTION



				DESIGNED BY: GPH
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	09-15-20	GPH		JOB NO. 2020-21 CLIENT NO.
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