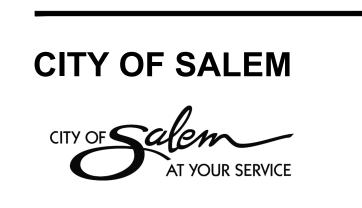




SCALE: NOT TO SCALE



CONTEXT MAP

PROJECT MANAGER: RAYMOND JOSEPH, SENIOR PARKS PLANNER

PRIME CONSULTANT: LANDSCAPE ARCHITECTURE, PERMITTING, ENGINEERING



ENVIRONMENTAL SCIENCE ASSOCIATES 819 SE MORRISON STREET SUITE 310 PORTLAND, OR 97214 (503) 274-2010

PROJECT MANAGER: MATTHEW CRAMPTON, RLA PROJECT ENGINEER: CHAD MCKINNEY, PE, CFM

BAILEY RIDGE PARK RESTORATION AND PATHWAY PROJECT

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PLANTING DETAILS L5.2

<u>SURVEY</u>

ΟΤΑΚ 808 SW THIRD AVE., SUITE 800 PORTLAND, OR 97204

(503) 415 2332

CONTACT: SUE TSOI, PLS CULTURAL RESOURCE STUDY

HISTORICAL RESEARCH ASSOCIATES 59 E. 14TH AVE EUGENE, OR 97401

(206) 898 5781

CONTACT: BRADLEY BOWDEN, PRINCIPAL ARCHAEOLOGIST

30% DRAFT DESIGN JANUARY 2025

GENERAL NOTES

- ALL CONSTRUCTION SHALL BE TO CITY OF SALEM STANDARDS AND SPECIFICATIONS AND THE MATERIAL SPECIFICATIONS DEVELOPED FOR THIS PROJECT.
- 2. REFERENCE STANDARD CONSTRUCTION SPECIFICATIONS (SCS) FOR REQUIREMENTS REGARDING PROTECTION OF EXISTING FACILITIES AND TREES.
- REFERENCE SCS FOR REQUIREMENTS REGARDING OPERATION OF EXISTING WATER VALVES.
- REFERENCE SCS FOR TRAFFIC PROTECTION AND CONTROL REQUIREMENTS. 4
- 5. UTILITY COORDINATION:

THE LOCATION AND DESCRIPTION OF EXISTING UTILITIES SHOWN ARE COMPILED FROM AVAILABLE RECORDS AND/OR FIELD SURVEYS. THE CITY OR UTILITY COMPANIES DO NOT GUARANTEE THE ACCURACY NOR THE COMPLETENESS OF SUCH RECORDS

ATTENTION: OREGON LAW REQUIRES YOU TO FOLLOW RULES ADOPTED BY THE OREGON UTILITY NOTIFICATION CENTER. THOSE RULES ARE SET FORTH IN OAR 952-001-0010THROUGH OAR 952-001-0090. YOU MAY OBTAIN COPIES OF THE RULES BY CALLING THE CENTER. (NOTE: THE TELEPHONE NUMBER FOR THE OREGON UTILITY NOTIFICATION CENTER IS (503)-232-1987).

> (A). PROVISIONS SHALL BE MADE BY THE CONTRACTOR TO KEEP ALL EXISTING UTILITIES IN SERVICE AND PROTECT THEM DURING CONSTRUCTION.

(B). UTILITIES, OR INTERFERING PORTIONS OF UTILITIES, THAT ARE ABANDONED IN PLACE SHALL BE REMOVED BY THE CONTRACTOR TO THE EXTENT NECESSARY TO ACCOMPLISH THE WORK THE CONTRACTOR SHALL PLUG THE REMAINING EXPOSED ENDS OF ABANDONED UTILITIES.

- 6. REFERENCE SCS FOR ANY ADDITIONAL UTILITY COORDINATION REQUIREMENTS.
- 7. THE CONTRACTOR SHALL BE EXPECTED TO VISIT THE SITE AND MAKE THEIR OWN DETERMINATION OF TOPOGRAPHIC FEATURES REQUIRING RESTORATION.
- 8. PROTECT ALL ROOTS TWO INCHES AND LARGER IN DIAMETER. TRIM TREES. SHRUBS AND HEDGES ONLY AS DIRECTED BY THE CITY OF SALEM'S REPRESENTATIVE.
- CONTRACTOR SHALL PROVIDE ENGINEER WITH MINIMUM 48 HOURS NOTICE PRIOR TO NEEDING THE 9. ENGINEER ON SITE. COORDINATE WITH ENGINEER TO REVIEW INSTALLATION OF PROPOSED PROJECT FEATURES AS NEEDED.
- 10. ALL CONSTRUCTION SHALL CONFORM TO CITY OF SALEM'S OREGON DEPARTMENT OF ENVIRONMENTAL QUALITY PERMIT NO. 1200-CA.
- 11. CONTACT THE CITY OF SALEM'S REPRESENTATIVE IMMEDIATELY IF UNANTICIPATED CONTAMINATION IS ENCOUNTERED DURING CONSTRUCTION.
- 12. ALL UTILITIES SHOWN ARE APPROXIMATE AND SHOWN FOR REFERENCE ONLY. CONTRACTOR IS RESPONSIBLE FOR LOCATING AND PROTECTING ALL UTILITIES.
- 13. THE CONTRACTOR SHALL BE RESPONSIBLE FOR PROVIDING ADEQUATE SAFEGUARDS, SAFETY DEVICES, PROTECTIVE EQUIPMENT, FLAGGERS, AND ANY OTHER NEEDED ACTIONS TO PROTECT THE LIFE, HEALTH, AND SAFETY OF THE PUBLIC, AND TO PROTECT PROPERTY IN CONNECTION WITH THE PERFORMANCE OF WORK COVERED BY THE CONTRACTOR.
- 14. THE CONTRACTOR SHALL BE RESPONSIBLE FOR SITE SECURITY INCLUDING PROTECTION OF WORK AND SITE AGAINST VANDALISM. THEFT, AND UNAUTHORIZED ACCESS
- 15. THE CONTRACTOR SHALL BE RESPONSIBLE FOR MAINTAINING THE INTEGRITY OF ADJACENT UTILITIES WHICH MAY INCLUDE, BUT ARE NOT LIMITED TO, WATER, POWER, SEWER, STORM, AND COMMUNICATIONS.
- 16. THE CONTRACTOR SHALL NOTIFY RESIDENTS AND BUSINESSES 48 HOURS IN ADVANCE OF ANY WORK AFFECTING ACCESS OR SERVICE AND SHALL MINIMIZE INTERRUPTIONS TO DRIVEWAYS FOR RESIDENTS ADJACENT TO THE PROJECT SITES.
- 17. ALL LAWN AND VEGETATED AREAS DISTURBED WILL BE RESTORED TO ORIGINAL CONDITION.
- 18. DISTURBANCE OR DAMAGE TO OTHER PROPERTY ON ADJACENT PARCELS OR IN THE PUBLIC RIGHT OF WAY SHALL ALSO BE REPAIRED OR RESTORED TO ORIGINAL CONDITION.
- 19. A COPY OF THE APPROVED PLANS SHALL BE ONSITE DURING CONSTRUCTION AT ALL TIMES.
- 20. THE CONTRACTOR SHALL NOT COMMENCE WORK UNTIL WRITTEN AUTHORIZATION TO PROCEED HAS BEEN PROVIDED BY THE CITY OF SALEM.
- 21. THE CONTRACTOR SHALL COORDINATE WITH THE CITY OF SALEM ON OBTAINING ALL PROJECT PERMITS PRIOR TO STARTING CONSTRUCTION.

- 1. ENVIRONMENTAL SCIENCE ASSOCIATES IS NOT RESPONSIBLE FOR DESIGN AND CONSTRUCTION REVIEW SERVICES RELATING TO THE CONTRACTORS SAFETY PRECAUTIONS OR MEANS. METHODS. TECHNIQUES. SEQUENCES. OR PROCEDURES USED FOR THE CONTRACTOR TO PERFORM THEIR WORK.
- 2. THE CONTRACTOR SHALL MAINTAIN COMPLIANCE WITH PROJECT PERMITS AND THE PUBLISHED ODFW IN-WATER WORK WINDOW FOR THE WILLAMETTE RIVER AND ITS TRIBUTARIES:

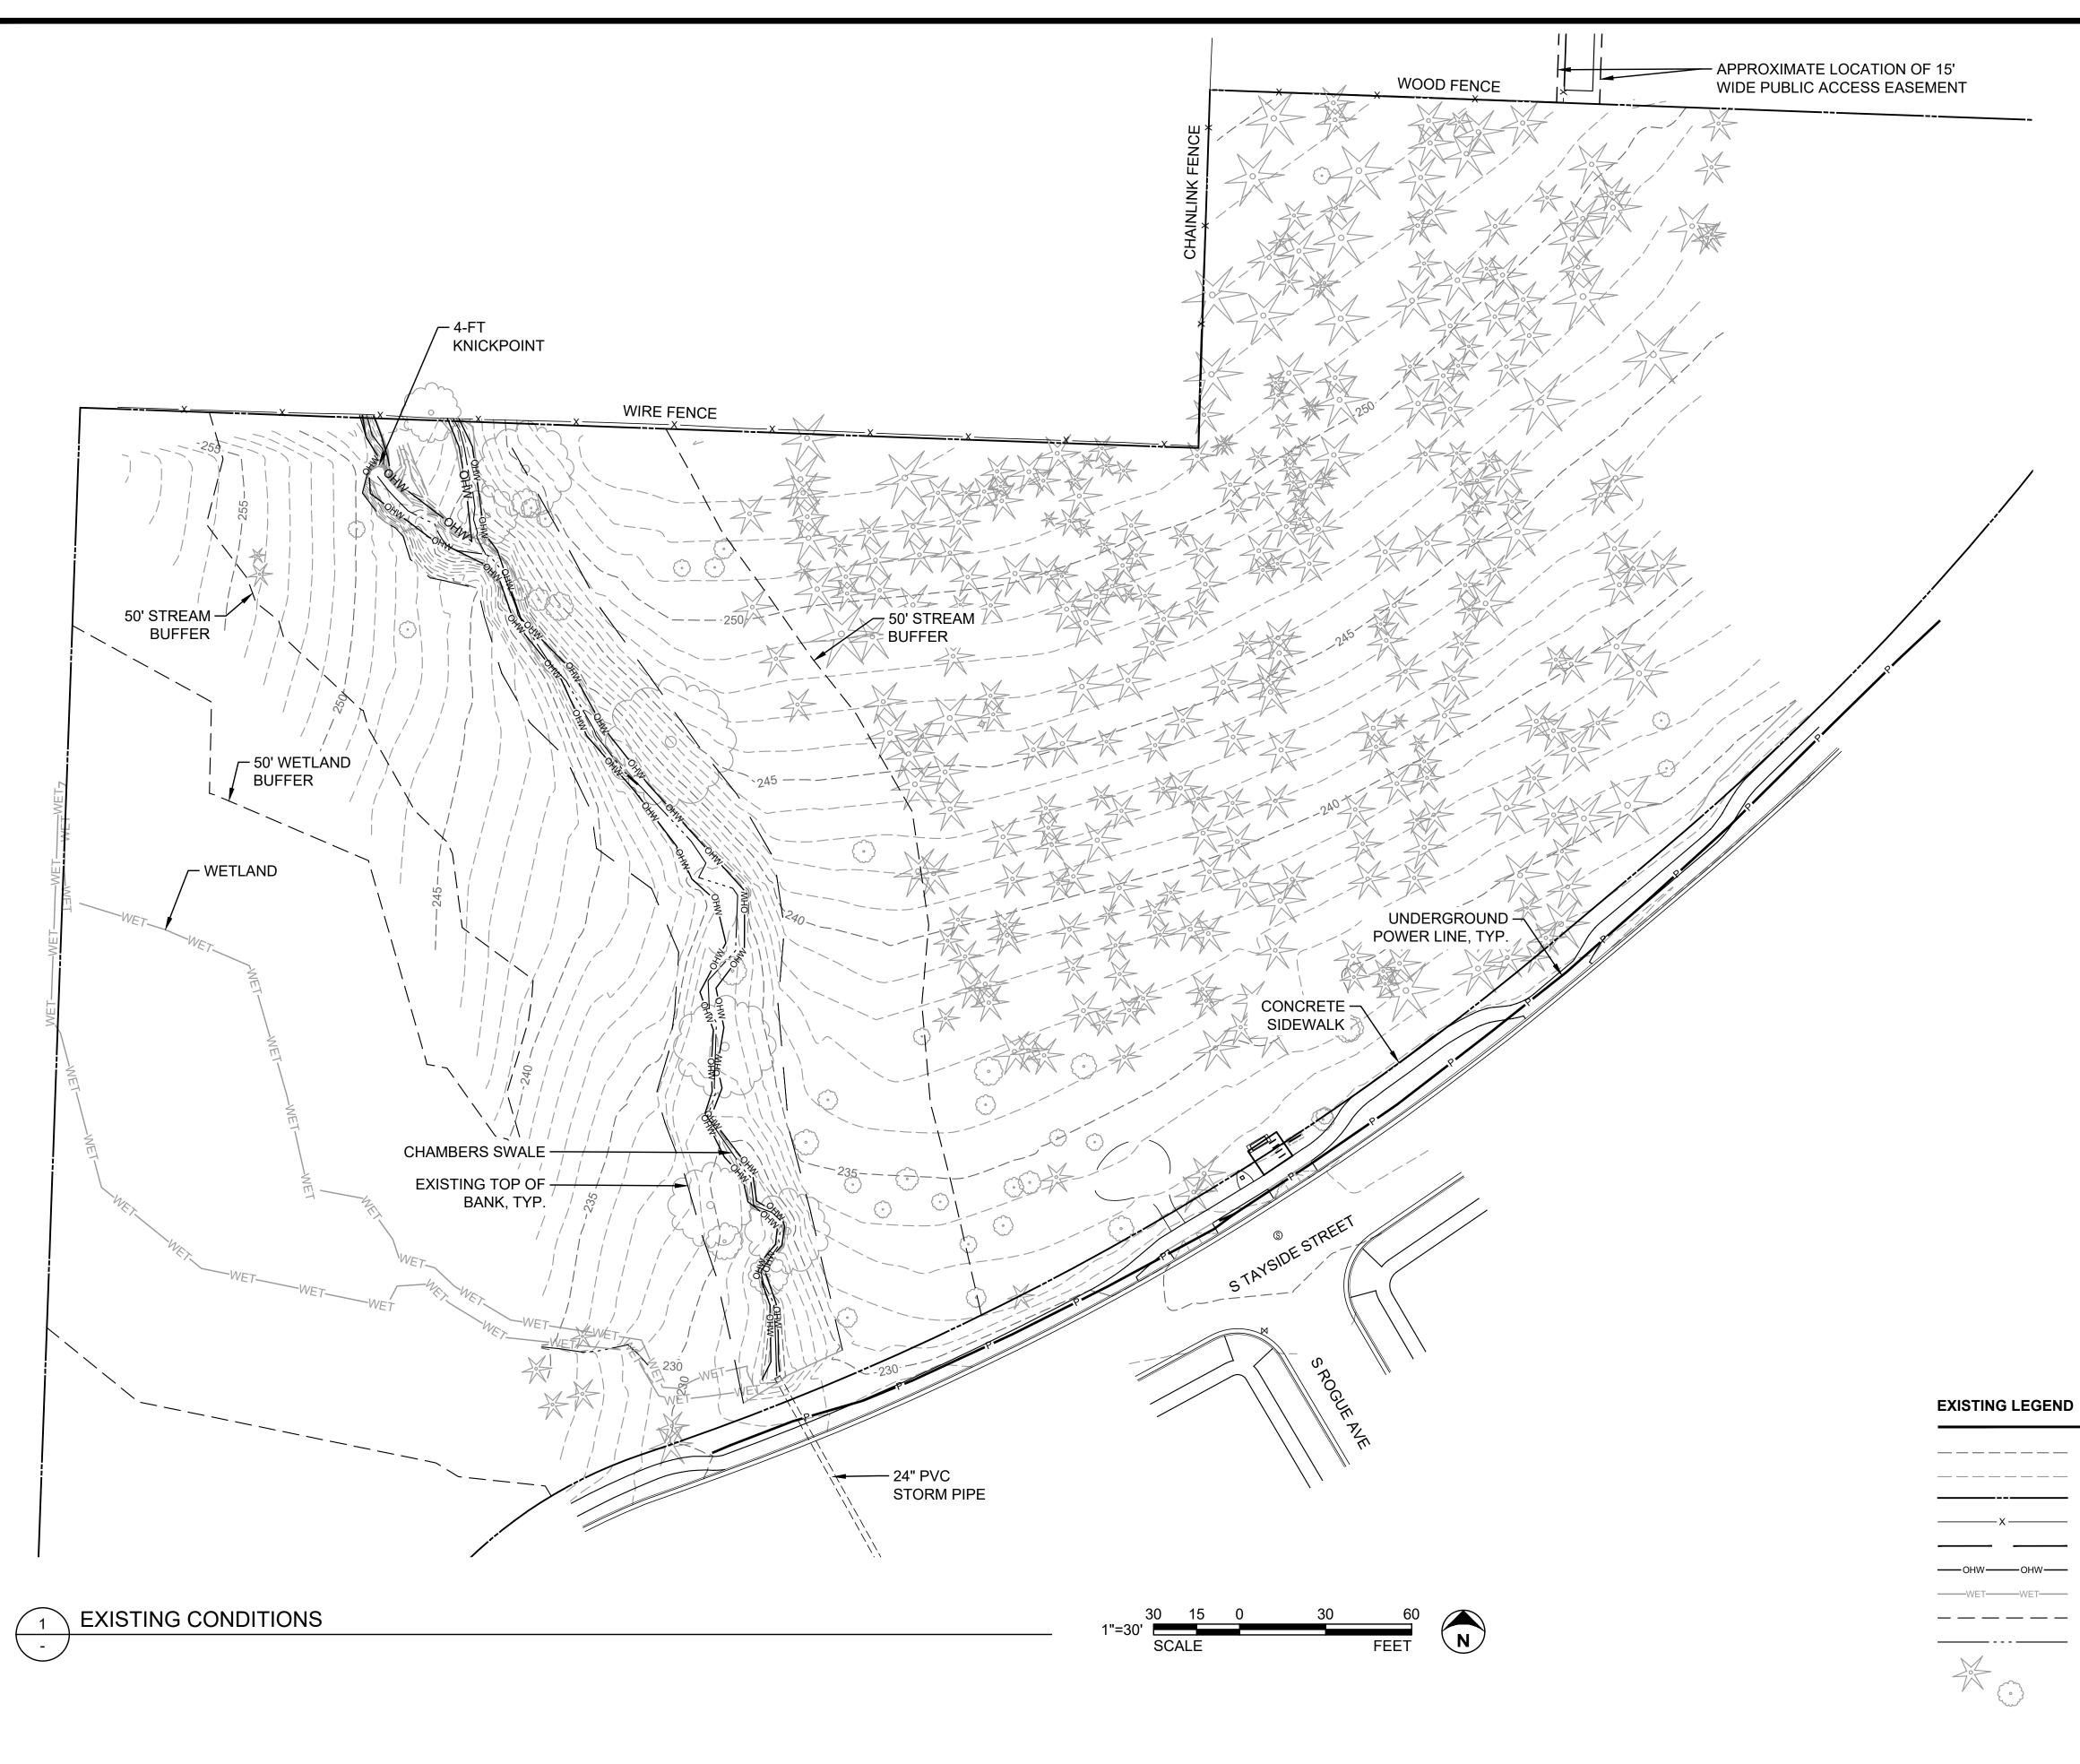
JULY 1ST - OCTOBER 31ST

- 3. DUE TO THE DEGRADABLE NATURE OF SOME OF THE PROPOSED PROJECT MATERIALS, ENVIRONMENTAL SCIENCE ASSOCIATES DOES NOT GUARANTEE THE LIFESPAN OF INSTALLED SITE FEATURES AND THE STABILIZATION SUCCESS OF THE PROJECT. SUPPLEMENTAL PROJECT MONITORING FOLLOWING THE COMPLETION OF CONSTRUCTION WILL NEED TO BE CONDUCTED TO DETERMINE PROJECT SUCCESS IN STABILIZING THE ON-GOING EROSION OF THE SWALE'S BANKS AND BED.
- THIS PROJECT IS INTENDED TO BE FIELD FIT. THE ENGINEER RESERVES THE AUTHORITY TO ALTER PROPOSED FEATURES DURING CONSTRUCTION TO BETTER STABILIZE THE ERODED AND UNSTABLE SWALE BANKS AND BED.
- 5. CONTRACTOR SHALL VERIFY EXISTING SITE FEATURES AND DISCUSS POSSIBLE CONSTRUCTION CONFLICTS WITH PROJECT REPRESENTATIVE PRIOR TO START OF WORK.
- 6. CONTRACTOR SHALL LIMIT MACHINERY MOVEMENT AND DISTURBANCE TO STAGING AREAS OR TEMPORARY ACCESS CORRIDORS, AS SHOWN ON THE DRAWINGS OR AS APPROVED BY THE CITY OF SALEM AND THE LANDOWNER.
- 7. FIELD VERIFY WITH THE ENGINEER ALL DROP STRUCTURE LOCATIONS, LENGTHS, WIDTHS, AND ELEVATIONS PRIOR TO EXCAVATION, ASSEMBLY, AND INSTALLATION OF EACH FEATURE.
- 8. EQUIPMENT AND MATERIAL STAGING AREAS TO BE LOCATED AS SHOWN ON THE PLANS. EQUIPMENT AND MATERIAL SHALL NOT BE STORED OUTSIDE THE IDENTIFIED STAGING AREA EXTENTS, UNLESS APPROVED BY PROJECT REPRESENTATIVE.
- THE MIGRATORY BIRD NESTING PERIOD FOR THE CITY OF SALEM IS MARCH 1ST TO AUGUST 31ST. IF CONSTRUCTION ACTIVITIES ARE TO a COMMENCE WITHIN THIS TIME FRAME. THE CONTRACTOR MUST CONTACT THE CITY OF SALEM TO PERFORM A BIRD NEST SURVEY PRIOR TO CONSTRUCTION ACTIVITIES COMMENCING.

ABBREVIATIONS

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NOT FOR CONSTRUCTION
OWNER
CITY OF Salem AT YOUR SERVICE
BAILEY RIDGE PARK
TAXLOT NUMBER: 083W06CC13900
PROJECT NAME
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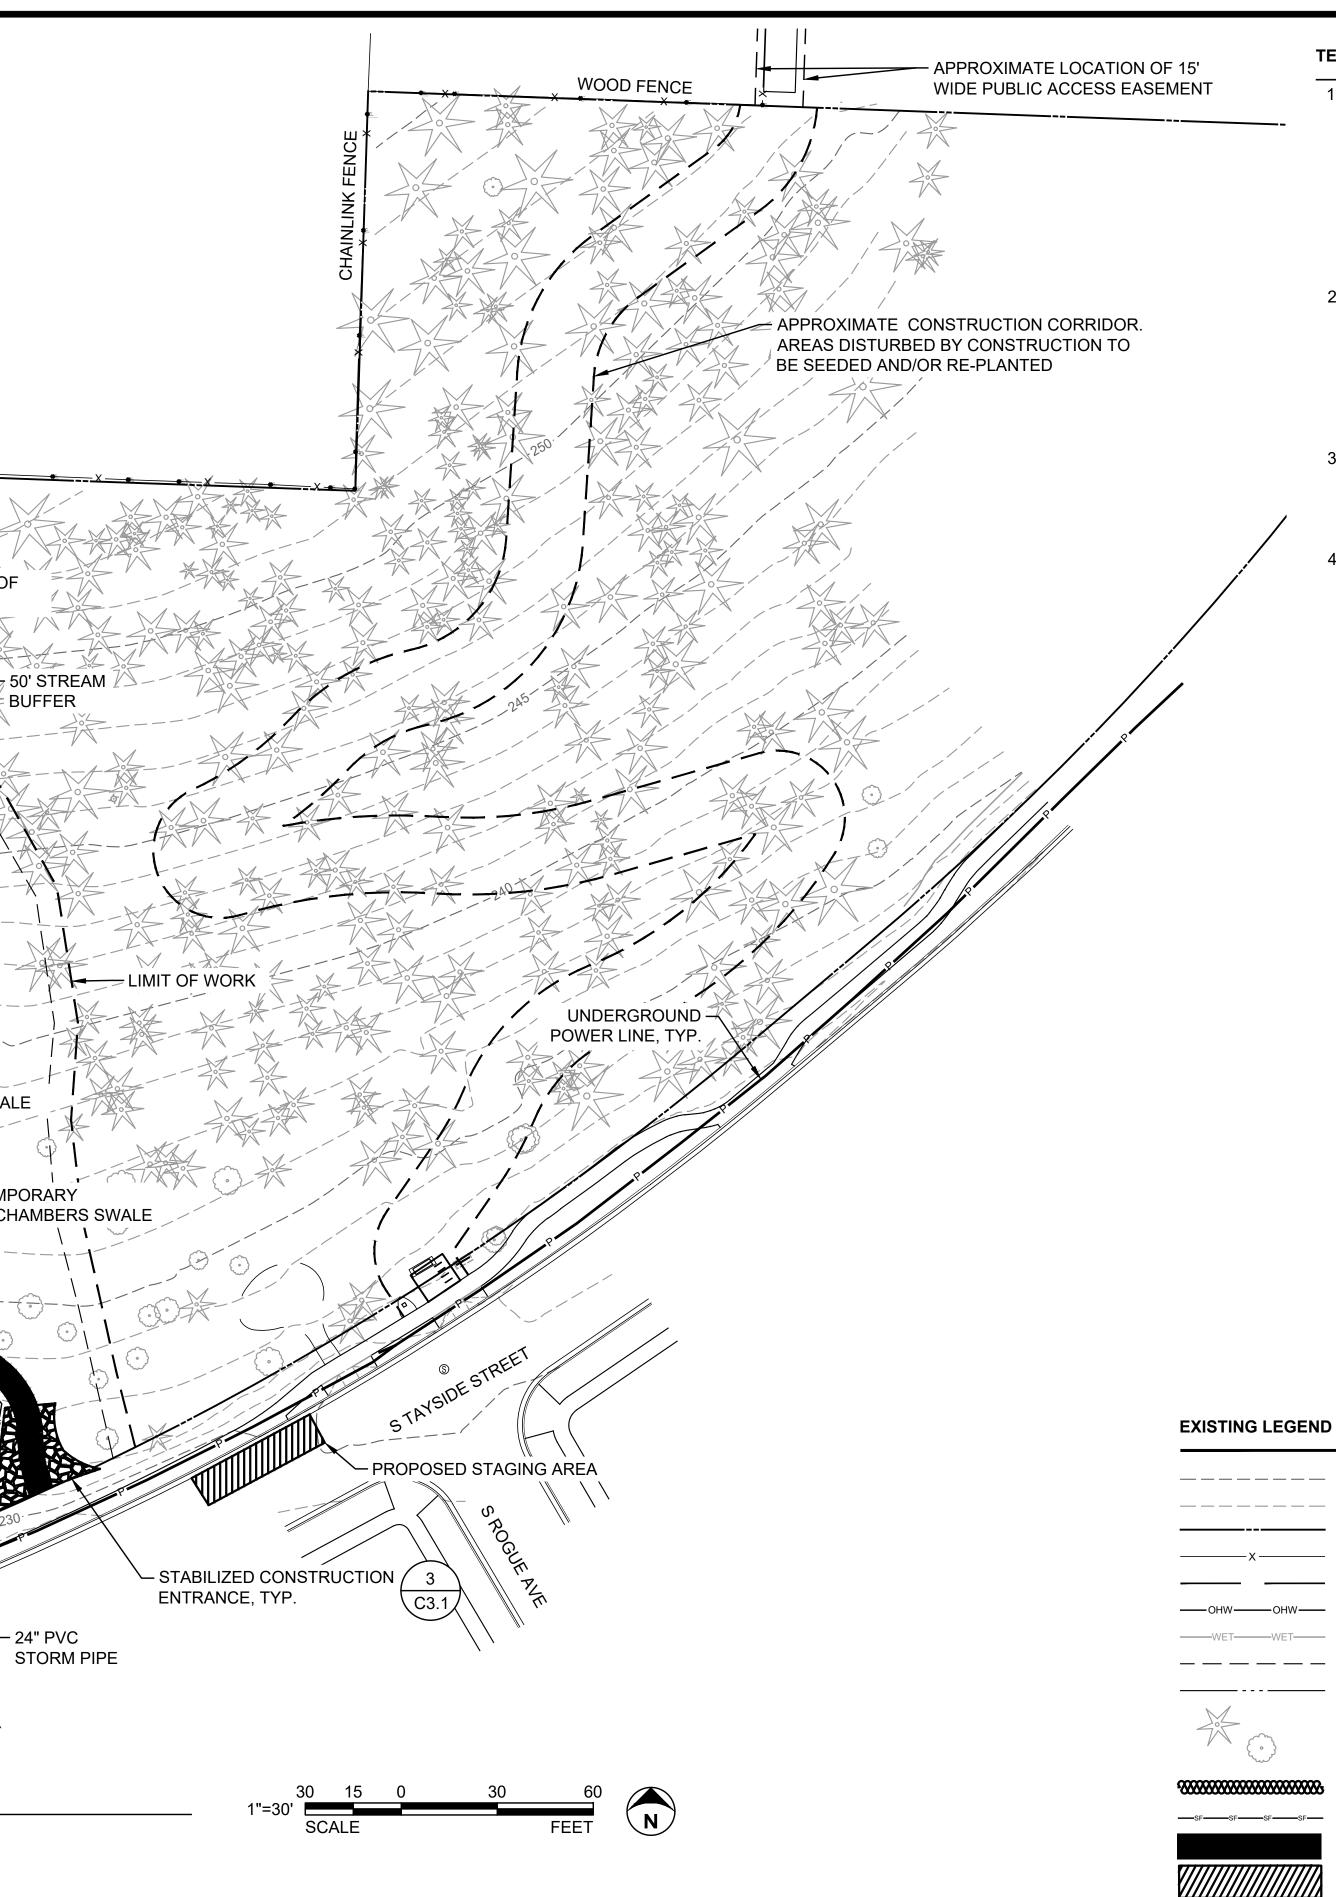
SHEET 2 OF 20



	EXISTING MAJOR CONTOUR
	EXISTING MINOR CONTOUR
	PROPERTY LINE
	FENCE
	TOP OF BANK
—OHW——	ORDINARY HIGH WATER
WET-	WETLAND
	50' WETLAND OR STREAM BUFFER
	SWALE CENTERLINE
	EXISTING CONIFEROUS TREE
	EXISTING DECIDUOUS TREE

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WIRE FENCE _ _ _ _ 50' STREAM -BUFFER EXISTING TOP OF SANK, TYP. – 50' WETLAND BUFFER - 50' STREAM BUFFER) STRAW WATTLE, TYP. 🛶 C3.1 \bigcirc - WETLAND APPROX. EXTENTS -OF GRADING, TYP. - CHAMBERS SWALE PROPOSED TEMPORARY CHAMBERS SWALE PRIMARY ACCESS ROUTE CROSSING OF CHAMBERS SWALE C3.1 SEDIMENT FENCE, TYP. -SEDIMENT FENCE FOR INLET PROTECTION WORK ADJACENT TO WETLAND IS LIMITED -TO PLANTING ONLY, SEE SHT L3.1 - 24" PVC CONSTRUCTION ACCESS, STAGING, AND TESC PLAN 1 -



TESC NOTES

- 1. THE TESC PLAN IS A SUGGESTED LAYOUT. THE CONTRACTOR SHALL BE RESPONSIBLE FOR IMPLEMENTING ALL TEMPORARY EROSION CONTROL MEASURES. THE EROSION CONTROL MEASURES SHALL BE IN ACCORDANCE WITH ALL FEDERAL, STATE, AND LOCAL REQUIREMENTS. THE CONTRACTOR SHALL BE RESPONSIBLE FOR THE MAINTENANCE AND PERFORMANCE OF THE TEMPORARY EROSION CONTROL MEASURES THROUGHOUT THE DURATION OF THE PROJECT.
- 2. THE CONTRACTOR SHALL BE RESPONSIBLE FOR MANAGING CONSTRUCTION ACTIVITIES TO ENSURE THAT PUBLIC STREETS AND RIGHT-OF-WAYS ARE KEPT CLEAN OF MUD, DUST, AND DEBRIS. DUST ABATEMENT SHALL BE MAINTAINED BY ADEQUATE WATERING OF THE SITE BY THE CONTRACTOR OR OTHER APPLICABLE BMPS.
- 3. THE FINAL STAGING AND STOCKPILING AREAS SHALL BE SELECTED IN THE FIELD BY THE CONTRACTOR IN COORDINATION WITH THE CITY OF SALEM. NO STAGING ALLOWED WITHIN THE OHW OF CHAMBERS SWALE.
- 4. THE CONTRACTOR IS RESPONSIBLE FOR PROTECTING TREES AND THEIR ROOT SYSTEMS AS SHOWN IN THESE PLANS. THE CONTRACTOR SHALL BEAR ALL COSTS FOR DAMAGE OR REMOVAL OF TREES TO THE APPROVAL OF THE OWNER.

	EXISTING MAJOR CONTOUR
	EXISTING MINOR CONTOUR
	PROPERTY LINE
	FENCE
	TOP OF BANK
—онw——	ORDINARY HIGH WATER
-WET	WETLAND
	50' WETLAND OR STREAM BUFFER
	SWALE CENTERLINE
	EXISTING CONIFEROUS TREE
3	EXISTING DECIDUOUS TREE
	STRAW WATTLE
SFSF	SEDIMENT FENCE
	CONSTRUCTION ACCESS
///////	STAGING AREA

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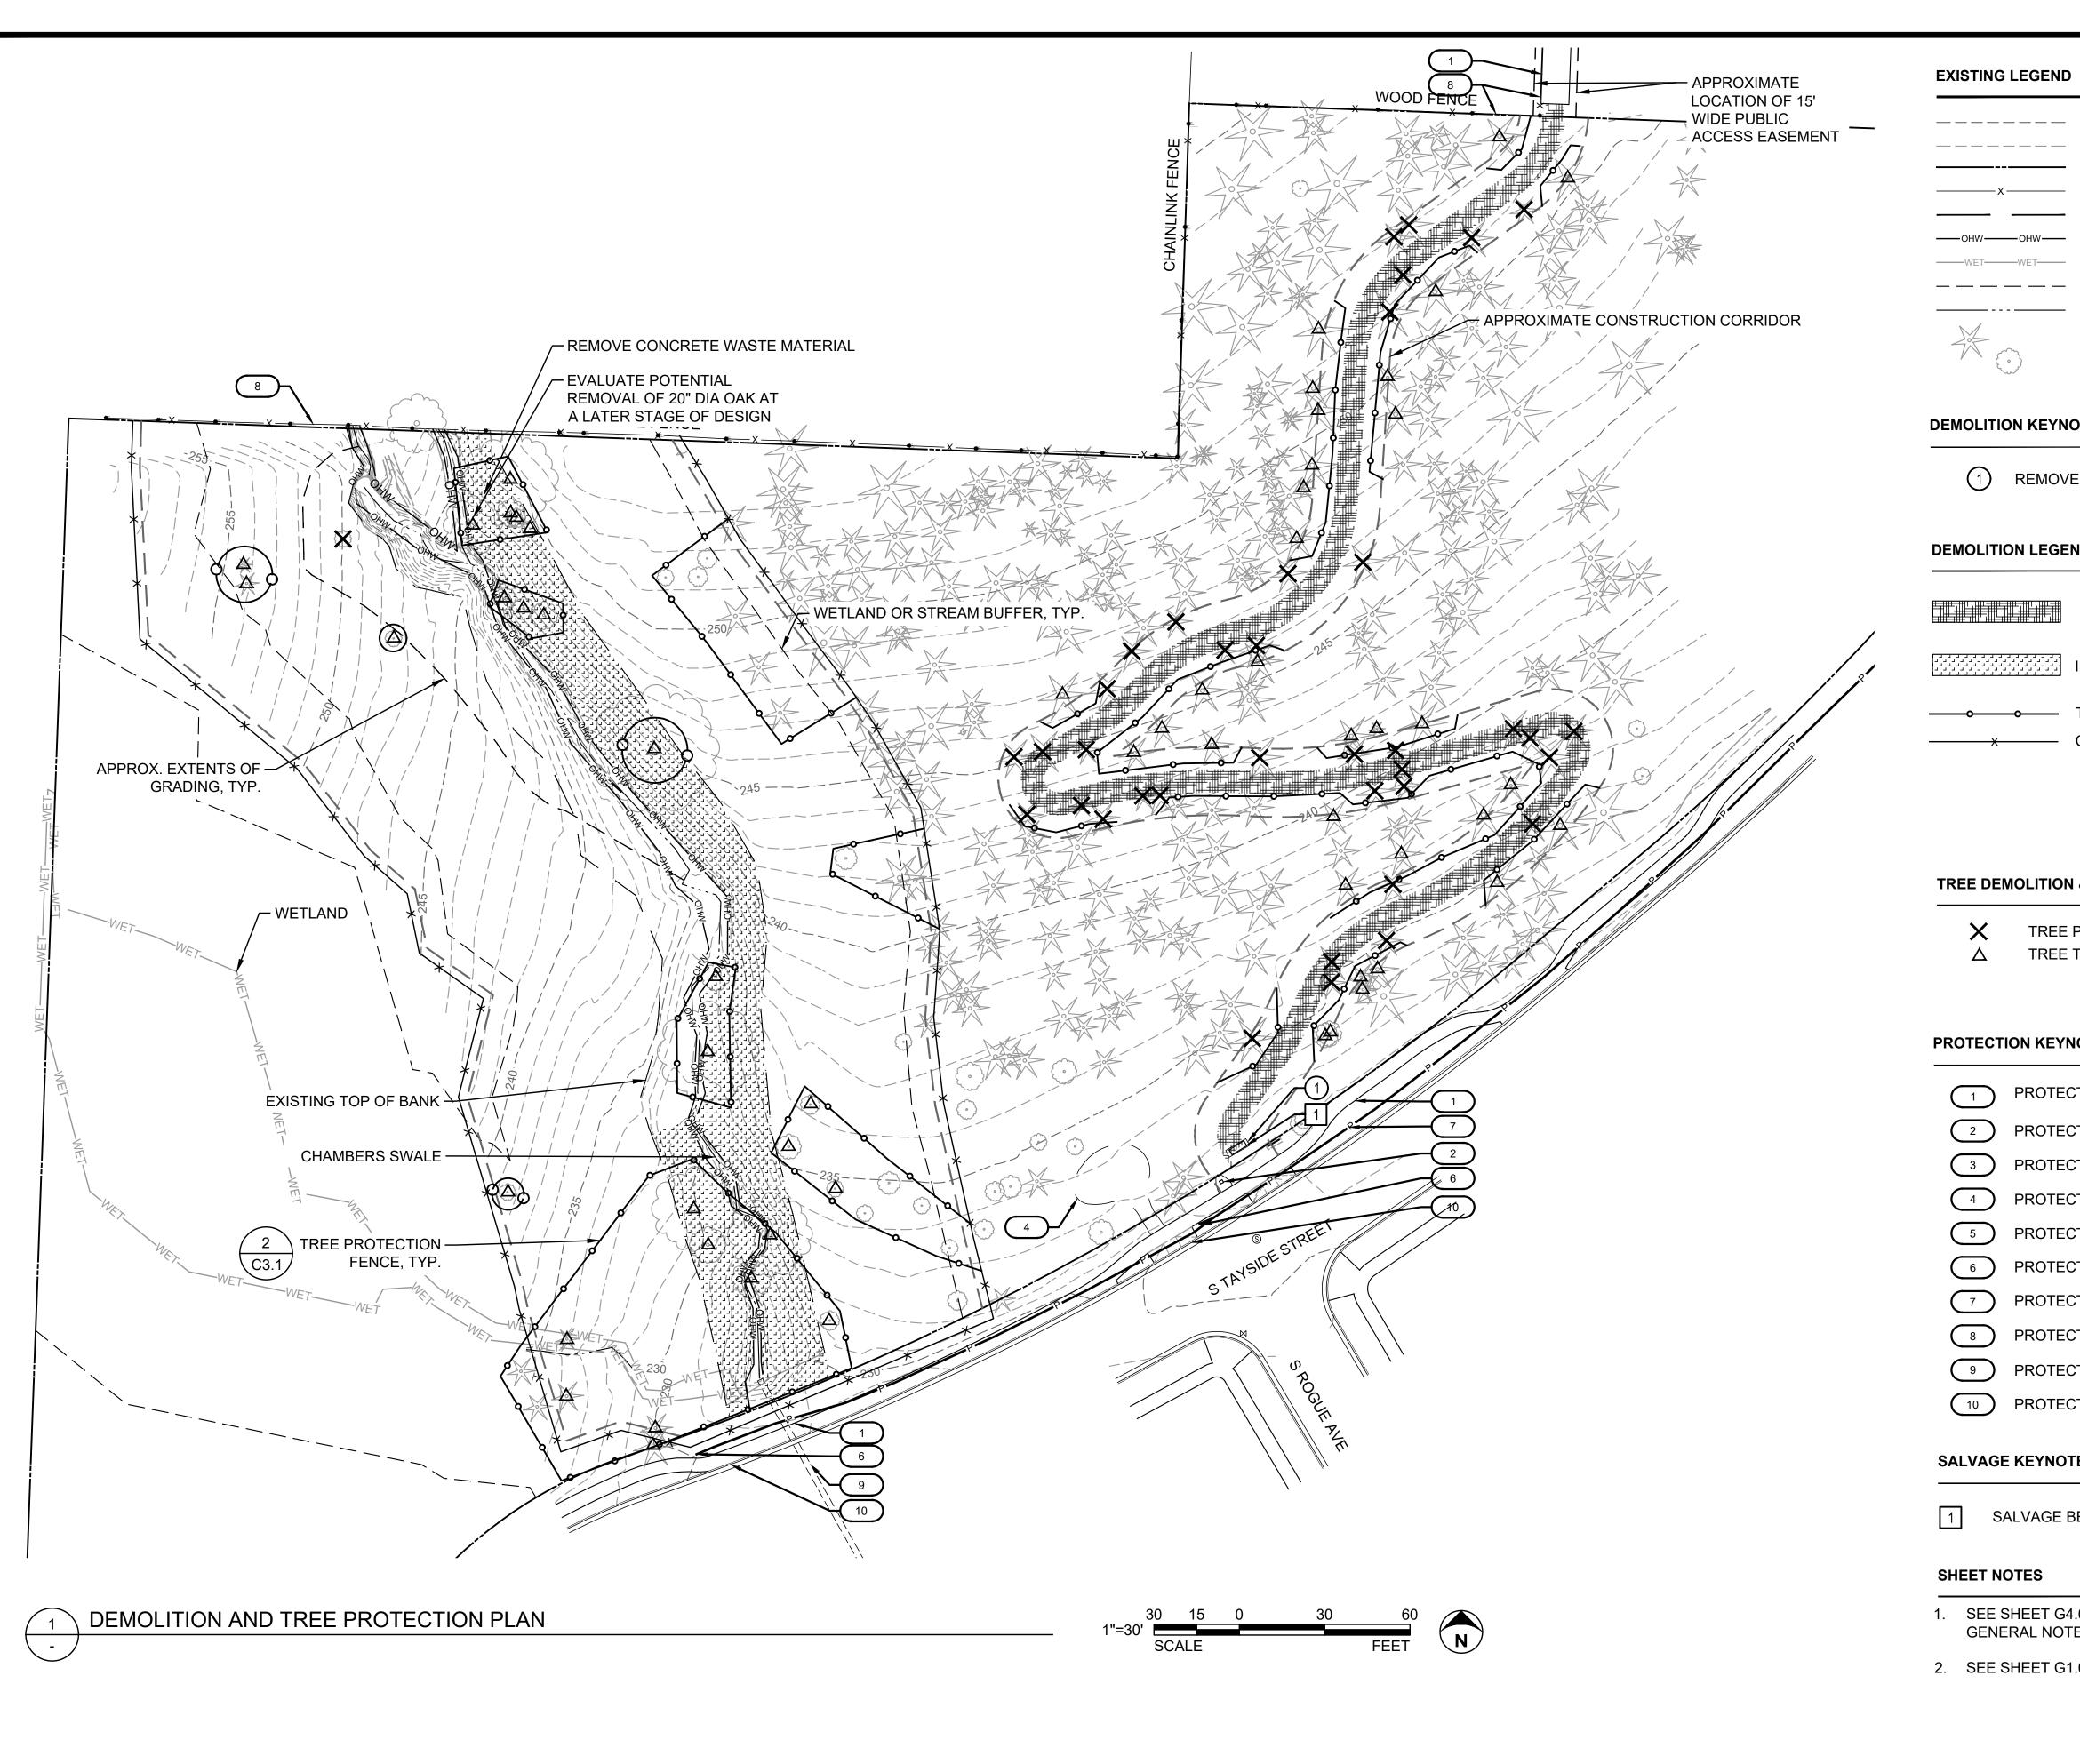
DEMOLITION GENERAL NOTES

- 1. THE CONTRACTOR SHALL SUBMIT A SITE ACCESS PLAN INCLUDING IDENTIFICATION OF STAGING AND STOCKPILE AREAS FOR APPROVAL BY OWNER PRIOR TO COMMENCEMENT OF CONSTRUCTION ACTIVITIES.
- 1. THE CONTRACTOR SHALL INCLUDE IN THE BID THE COST OF REMOVING ANY EXISTING SITE FEATURES AND APPURTENANCES NECESSARY TO ACCOMPLISH THE CONSTRUCTION OF THE PROPOSED SITE IMPROVEMENTS. THE CONTRACTOR SHALL ALSO INCLUDE IN THE BID THE COST NECESSARY TO RESTORE SUCH ITEMS IF THEY ARE SCHEDULED TO REMAIN AS PART OF THE FINAL SITE IMPROVEMENTS.
- 2. THE CITY OF SALEM RESERVES THE RIGHT TO REVIEW ALL MATERIALS DESIGNATED FOR REMOVAL AND TO RETAIN OWNERSHIP OF SUCH MATERIALS. IF THE OWNER RETAINS ANY MATERIAL THE CONTRACTOR SHALL MAKE ARRANGEMENTS WITH THE OWNER TO HAVE THOSE MATERIALS REMOVED OFF SITE AT NO ADDITIONAL COST. SALVAGED ITEMS ARE TO BE PROVIDED TO THE CITY OF SALEM.
- UNLESS SPECIFICALLY NOTED TO BE PRESERVED, STOCKPILED, REUSED, OR RELOCATED, ALL SITE FEATURES 3 SHALL BE REMOVED TO FULL DEPTH WITH THEIR FOOTINGS, ATTACHMENTS, BASE MATERIAL, AND APPURTENANCES.
- REMOVED MATERIAL SHALL BE TRANSPORTED FROM THE SITE AND DISPOSED OF IN A LAWFUL MANNER AT AN 4. ACCEPTABLE DISPOSAL SITE AND AT NO ADDITIONAL COST TO THE OWNER.
- 5. ALL EXISTING SITE FEATURES TO REMAIN SHALL BE PROTECTED THROUGHOUT THE CONSTRUCTION PERIOD. ANY FEATURES DAMAGED DURING CONSTRUCTION OPERATIONS SHALL BE REPAIRED OR REPLACED TO THE SATISFACTION OF THE OWNER'S REPRESENTATIVE AT NO ADDITIONAL COST.
- 6. DURING EARTHWORK OPERATIONS, CONTRACTOR SHALL TAKE CARE TO NOT DISTURB EXISTING MATERIALS TO REMAIN, OUTSIDE THE LIMITS OF EXCAVATION AND BACKFILL AND SHALL TAKE WHATEVER MEASURES NECESSARY, AT THE CONTRACTOR'S EXPENSE. TO PREVENT ANY EXCAVATED MATERIAL FROM COLLAPSING. ALL BACKFILL MATERIALS SHALL BE PLACED AND COMPACTED AS SPECIFIED TO THE SUBGRADE REQUIRED FOR THE INSTALLATION OF THE REMAINDER OF THE CONTRACT WORK.
- 'CLEAR AND GRUB VEGETATION' SHALL INCLUDE REMOVAL OF ALL VEGETATIVE MATERIAL INCLUDING GRASS, 7. SHRUBS, UNDERBRUSH, AND REMOVAL OF ROOTS. REMOVE ALL ORNAMENTAL SHRUBS AND GROUNDCOVER AS SHOWN ON PLANS, INCLUDING ROOTS AND STUMPS, UNLESS OTHERWISE DIRECTED BY OWNER'S REPRESENTATIVE.
- TREES DESIGNATED FOR REMOVAL SHALL BE TAGGED BY CONTRACTOR AND APPROVED BY OWNER'S 8. REPRESENTATIVE PRIOR TO COMMENCEMENT OF CONSTRUCTION.
- 9. ANY EXISTING TREES NOT TAGGED FOR REMOVAL SHALL BE PROTECTED DURING CONSTRUCTION ACTIVITIES.
- 10. THE STORAGE OF MATERIALS AND EQUIPMENT WILL BE PERMITTED AT LOCATIONS APPROVED BY THE CITY OF SALEM OR OWNER'S REPRESENTATIVE. PROTECTION OF STORED MATERIALS AND EQUIPMENT SHALL BE THE SOLE **RESPONSIBILITY OF THE CONTRACTOR.**
- 11. STRIP & STORE EXISTING TOPSOIL FOR LATER REUSE WHERE APPROPRIATE, AND AS NOTED ON PLAN, WITH APPROPRIATE EROSION AND SEDIMENT CONTROLS. DO NOT STRIP EXISTING TOPSOIL WITHIN DRIP IRRIGATION ZONES.

TREE PROTECTION NOTES

- 1. CONTRACTOR SHALL PRESERVE AND PROTECT ALL TREES ON SITE UNLESS OTHERWISE NOTED.
- 2. TREE PROTECTION FENCING SHALL BE INSTALLED PRIOR TO THE COMMENCEMENT OF ANY SITE WORK AND SHALL REMAIN IN PLACE UNTIL SUBSTANTIAL COMPLETION IS ACCEPTED AND REMOVAL IS AUTHORIZED BY THE OWNER IN WRITING.
- 3. TREE PROTECTION FENCING SHALL BE MONITORED DAILY AND REPAIRED OR REPLACED IF DAMAGED.
- 4. CONTRACTOR MAY TEMPORARILY OPEN FENCE TO CONDUCT WORK SHOWN WITHIN TREE PROTECTION FENCING AREAS. UNDER NO CIRCUMSTANCES SHALL VEHICLES BE DRIVEN OR PARKED WITHIN FENCE LIMITS. FENCE SHALL BE REPLACED WHEN WORK IS COMPLETE OR AT THE END OF EACH DAY, WHICHEVER OCCURS FIRST. NO STORAGE OF MATERIALS WITH TREE PROTECTION. WORK WITHIN TREE PROTECTION TO BE COMPLETED USING HAND-TOOLS ONLY.
- 5. CONTRACTOR TO ACQUIRE APPROVAL FROM CITY OF SALEM ARBORIST PRIOR TO CUTTING ROOTS GREATER THAN 3-INCHES IN DIAMETER.
- 6. TREES IDENTIFIED FOR REMOVAL WITHIN THE CRITICAL ROOT ZONE OF TREES TO REMAIN SHALL BE REMOVED WITH CARE TO PROTECT ADJACENT TREES AND ROOTS. STUMPS SHALL BE GROUND MINIMUM 3-INCHES BELOW ADJACENT GRADE AND LEFT IN PLACE UNLESS THEY CONFLICT WITH SITE IMPROVEMENTS. CUT STUMPS SHALL HAVE NO EXPOSURE ABOVE FINISH GRADE.
- 7. TREES IDENTIFIED FOR REMOVAL OUTSIDE THE DRIPLINE OF OTHER TREES SHALL HAVE STUMPS GROUND TO A MINIMUM OF 3-INCHES BELOW GRADE AND/OR HAVE ROOT BALLS REMOVED AND LARGE ROOTS CUT TO FACILITATE SITE DEVELOPMENT. CONTRACTOR SHALL NOT REMOVE THE ROOTS OF ANY TREES WITHIN THE THE CRITICAL ROOT ZONE OF TREE TO REMAIN WITHOUT PRIOR WRITTEN APPROVAL OF THE CITY OF SALEM ARBORIST.
- 8. CONTRACTOR SHALL PRESERVE ON SITE LOGS GREATER THAN 12-INCH DBH AND 4-FOOT LENGTH FOR REUSE AS AS DESIRE LINE DECOMMISSIONING MATERIAL AS APPROVED BY OWNER'S REPRESENTATIVE.
- 9. PRIOR TO START OF CONSTRUCTION CONTRACTOR SHALL INSTALL TREE PROTECTION FENCING AND SET UP INSPECTION WITH CITY OF SALEM ARBORIST TO VERIFY IT HAS BEEN INSTALLED.

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REVISIONS # DATE DESCRIPTION
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DOCUMENTATION SHEET TITLE DEMOLITION & TREE PROTECTION NOTES SHEET NUMBER G4.0 SHEET 5 OF 20



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WET-	WETLAND
	50' WETLAND OR STREAM BUFFER
	SWALE CENTERLINE
	EXISTING CONIFEROUS TREE
	EXISTING DECIDUOUS TREE
w	

DEMOLITION KEYNOTES (NOT ALL NOTES APPEAR ON EACH SHEET)

REMOVE CONCRETE BENCH PAD

DEMOLITION LEGEND

	CLEAR AND GRUB, NO HEAVY EQUIPMENT. PROTECT (E) TREE ROOTS
	INVASIVE PLANT REMOVAL AREA
	TREE PROTECTION FENCE CONSTRUCTION FENCE

TREE DEMOLITION & PROTECTION LEGEND

TREE PROPOSED FOR DEMOLITION TREE TO REMAIN

PROTECTION KEYNOTES (NOT ALL NOTES APPEAR ON EACH SHEET)

- 1 PROTECT IN PLACE CONCRETE/ASPHALT PAVING
- 2 PROTECT IN PLACE LITTLE LIBRARY & PAVERS
- 3 PROTECT IN PLACE INFORMATION BOARD
- 4 PROTECT IN PLACE GRAVEL PAVING
 - PROTECT IN PLACE PICNIC TABLE
 - PROTECT IN PLACE LIGHT POLE, TYP.
- 7 PROTECT IN PLACE UTILITIES, TYP.
- 8 PROTECT IN PLACE FENCE, TYP.
- Image: 9PROTECT IN PLACE STORM PIPE
- 10 PROTECT IN CURB AND GUTTER

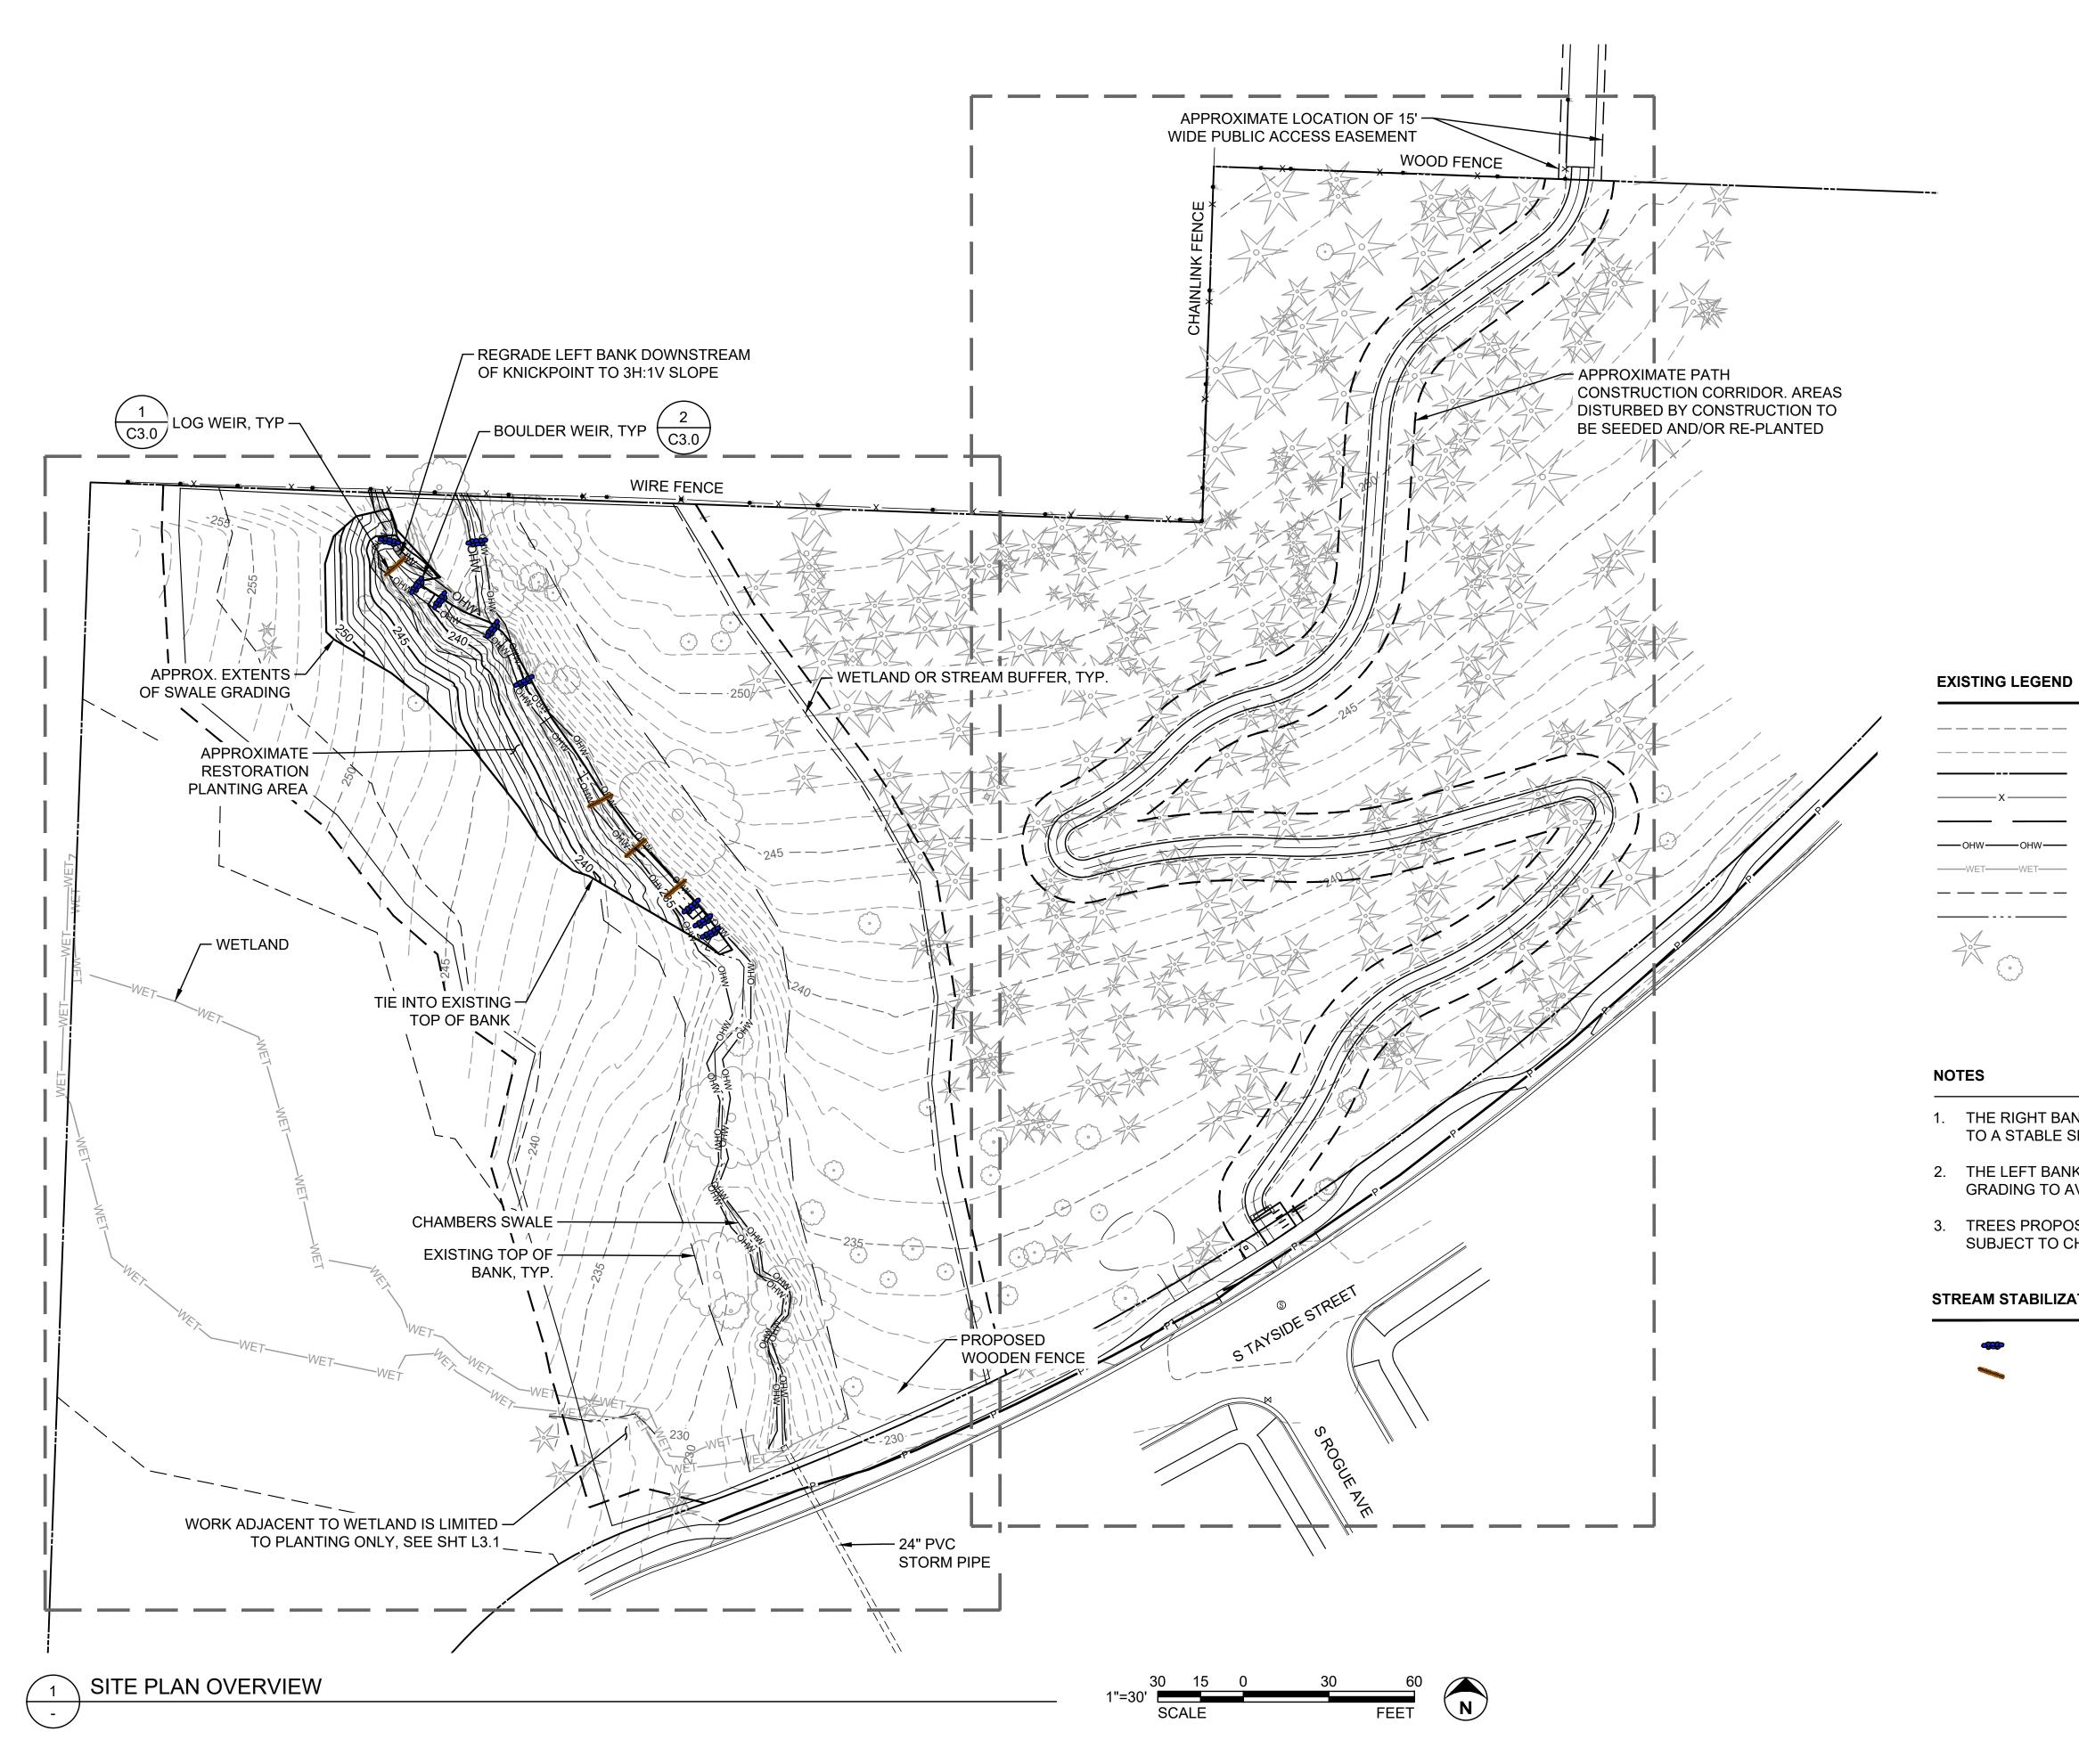
SALVAGE KEYNOTES (NOT ALL NOTES APPEAR ON EACH SHEET)

SALVAGE BENCH, PROVIDE TO OWNER

1. SEE SHEET G4.0 FOR DEMOLITION AND TREE PROTECTION GENERAL NOTES.

2. SEE SHEET G1.0 FOR GENERAL PROJECT NOTES.

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PHASE 30% CONSTRUCTION DOCUMENTATION
SHEET TITLE
DEMOLITION & TREE PROTECTION PLAN
sheet number G4.1



	EXISTING MAJOR CONTOUR
	EXISTING MINOR CONTOUR
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	TOP OF BANK
—онw——	ORDINARY HIGH WATER
-WET	WETLAND
	50' WETLAND OR STREAM BUFFER
	SWALE CENTERLINE
	EXISTING CONIFEROUS TREE
	EXISTING DECIDUOUS TREE
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1. THE RIGHT BANK OF CHAMBERS SWALE SHALL BE REGRADED TO A STABLE SLOPE OF 3 HORIZONTAL TO 1 VERTICAL.

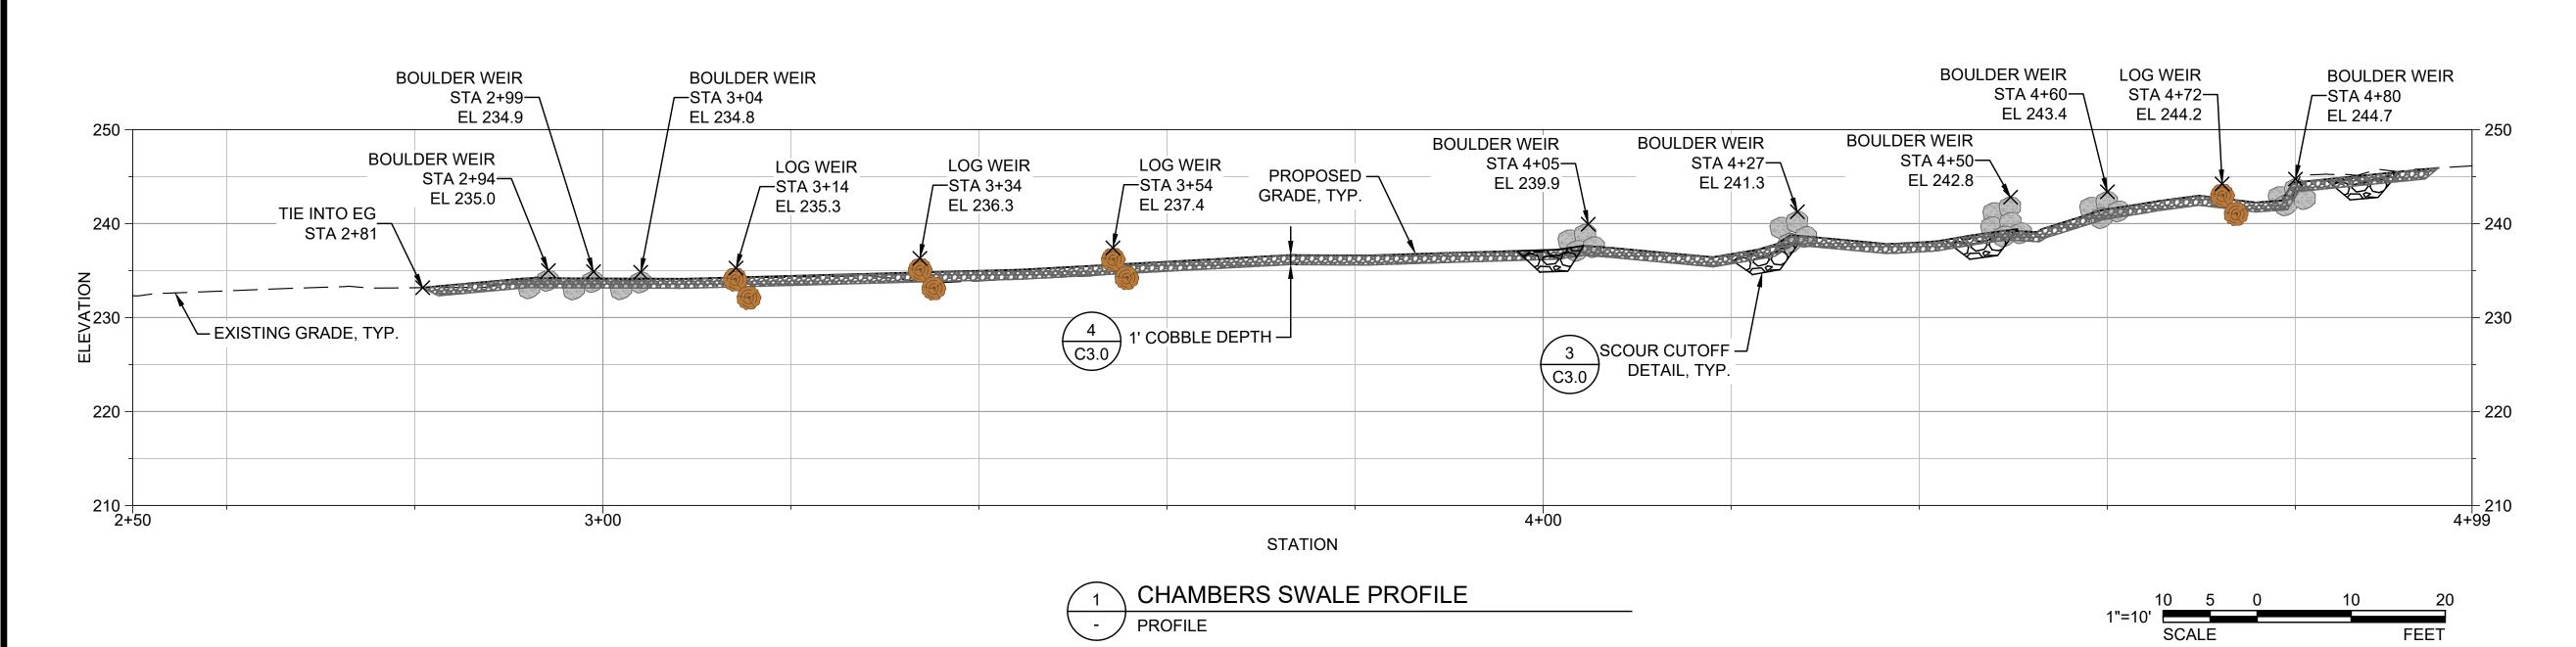
2. THE LEFT BANK OF CHAMBERS SWALE WILL UNDERGO MINIMAL GRADING TO AVOID DISTURBING ESTABLISHED TREES.

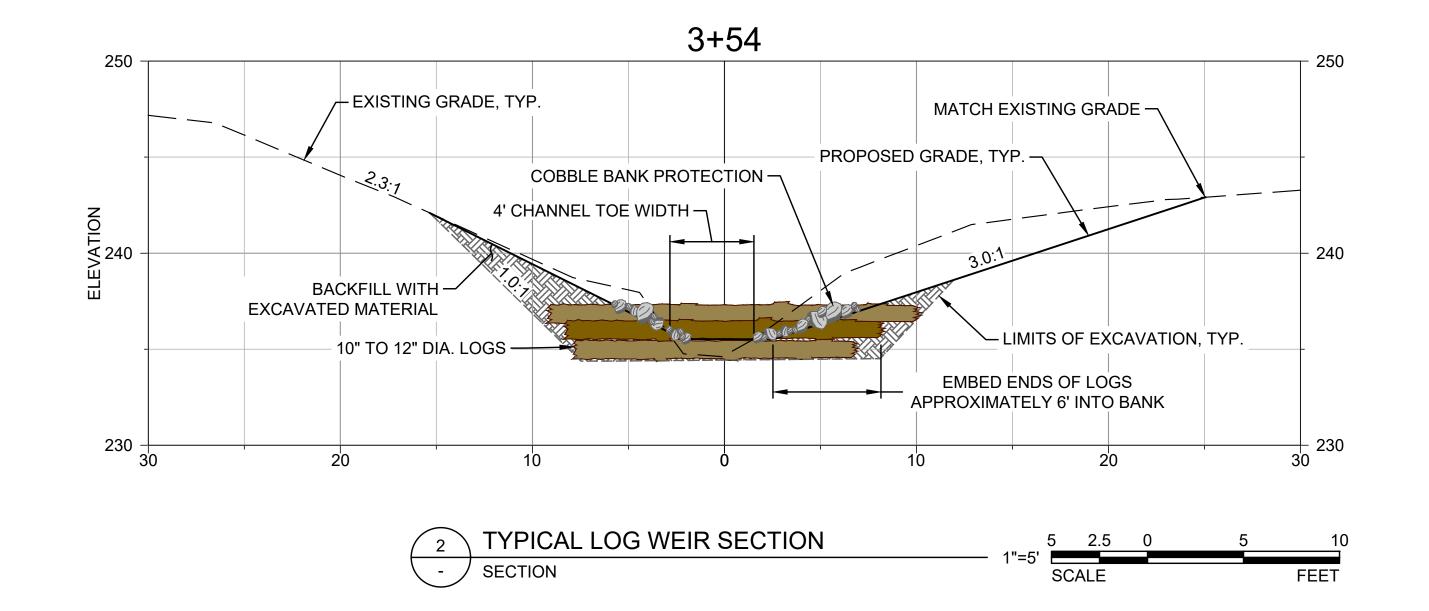
3. TREES PROPOSED FOR DEMOLITION ARE APPROXIMATE AND SUBJECT TO CHANGE WITH PLAN DEVELOPMENT.

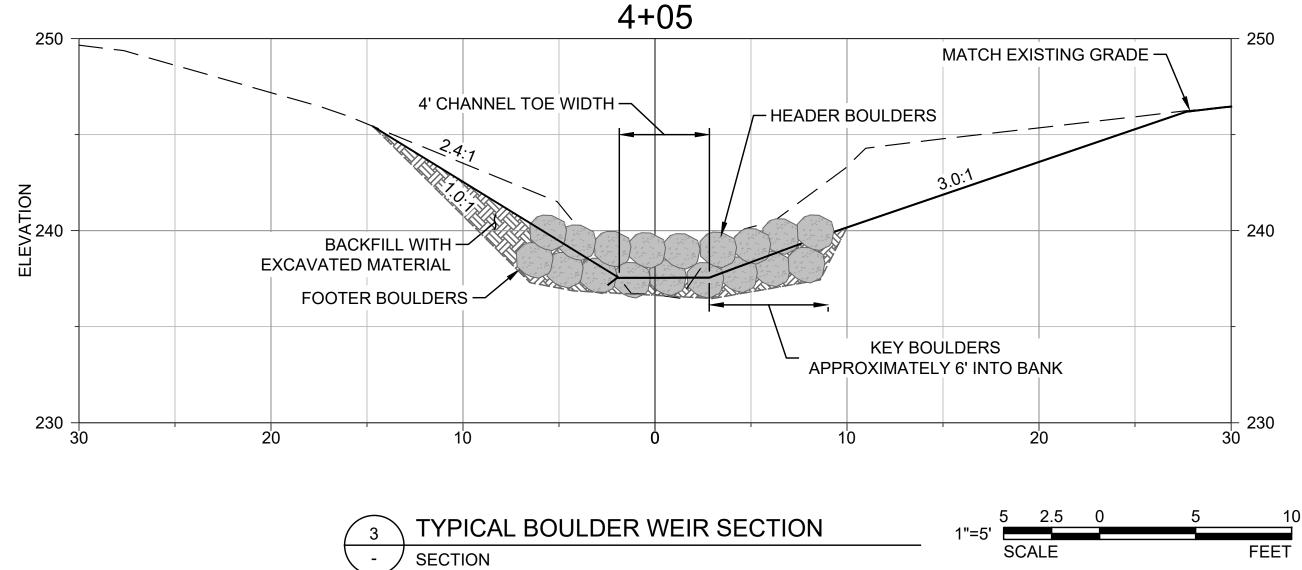
STREAM STABILIZATION LEGEND

BOULDER WEIR LOG WEIR

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BAILEY RIDGE PARK
TAXLOT NUMBER: 083W06CC13900
PROJECT NAME
REVISIONS # DATE DESCRIPTION
DRAWN MFN/TTF CHECKED MAC APPROVED BY MAC
PROJECT # D202200371.02
ISSUE DATE JANUARY 2025 SCALE IS AS SHOWN WHEN PLOTTED TO FULL SIZE (22"x34")
PHASE 30% CONSTRUCTION DOCUMENTATION SHEET TITLE
SITE PLAN
SHEET NUMBER
sheet number C1.0



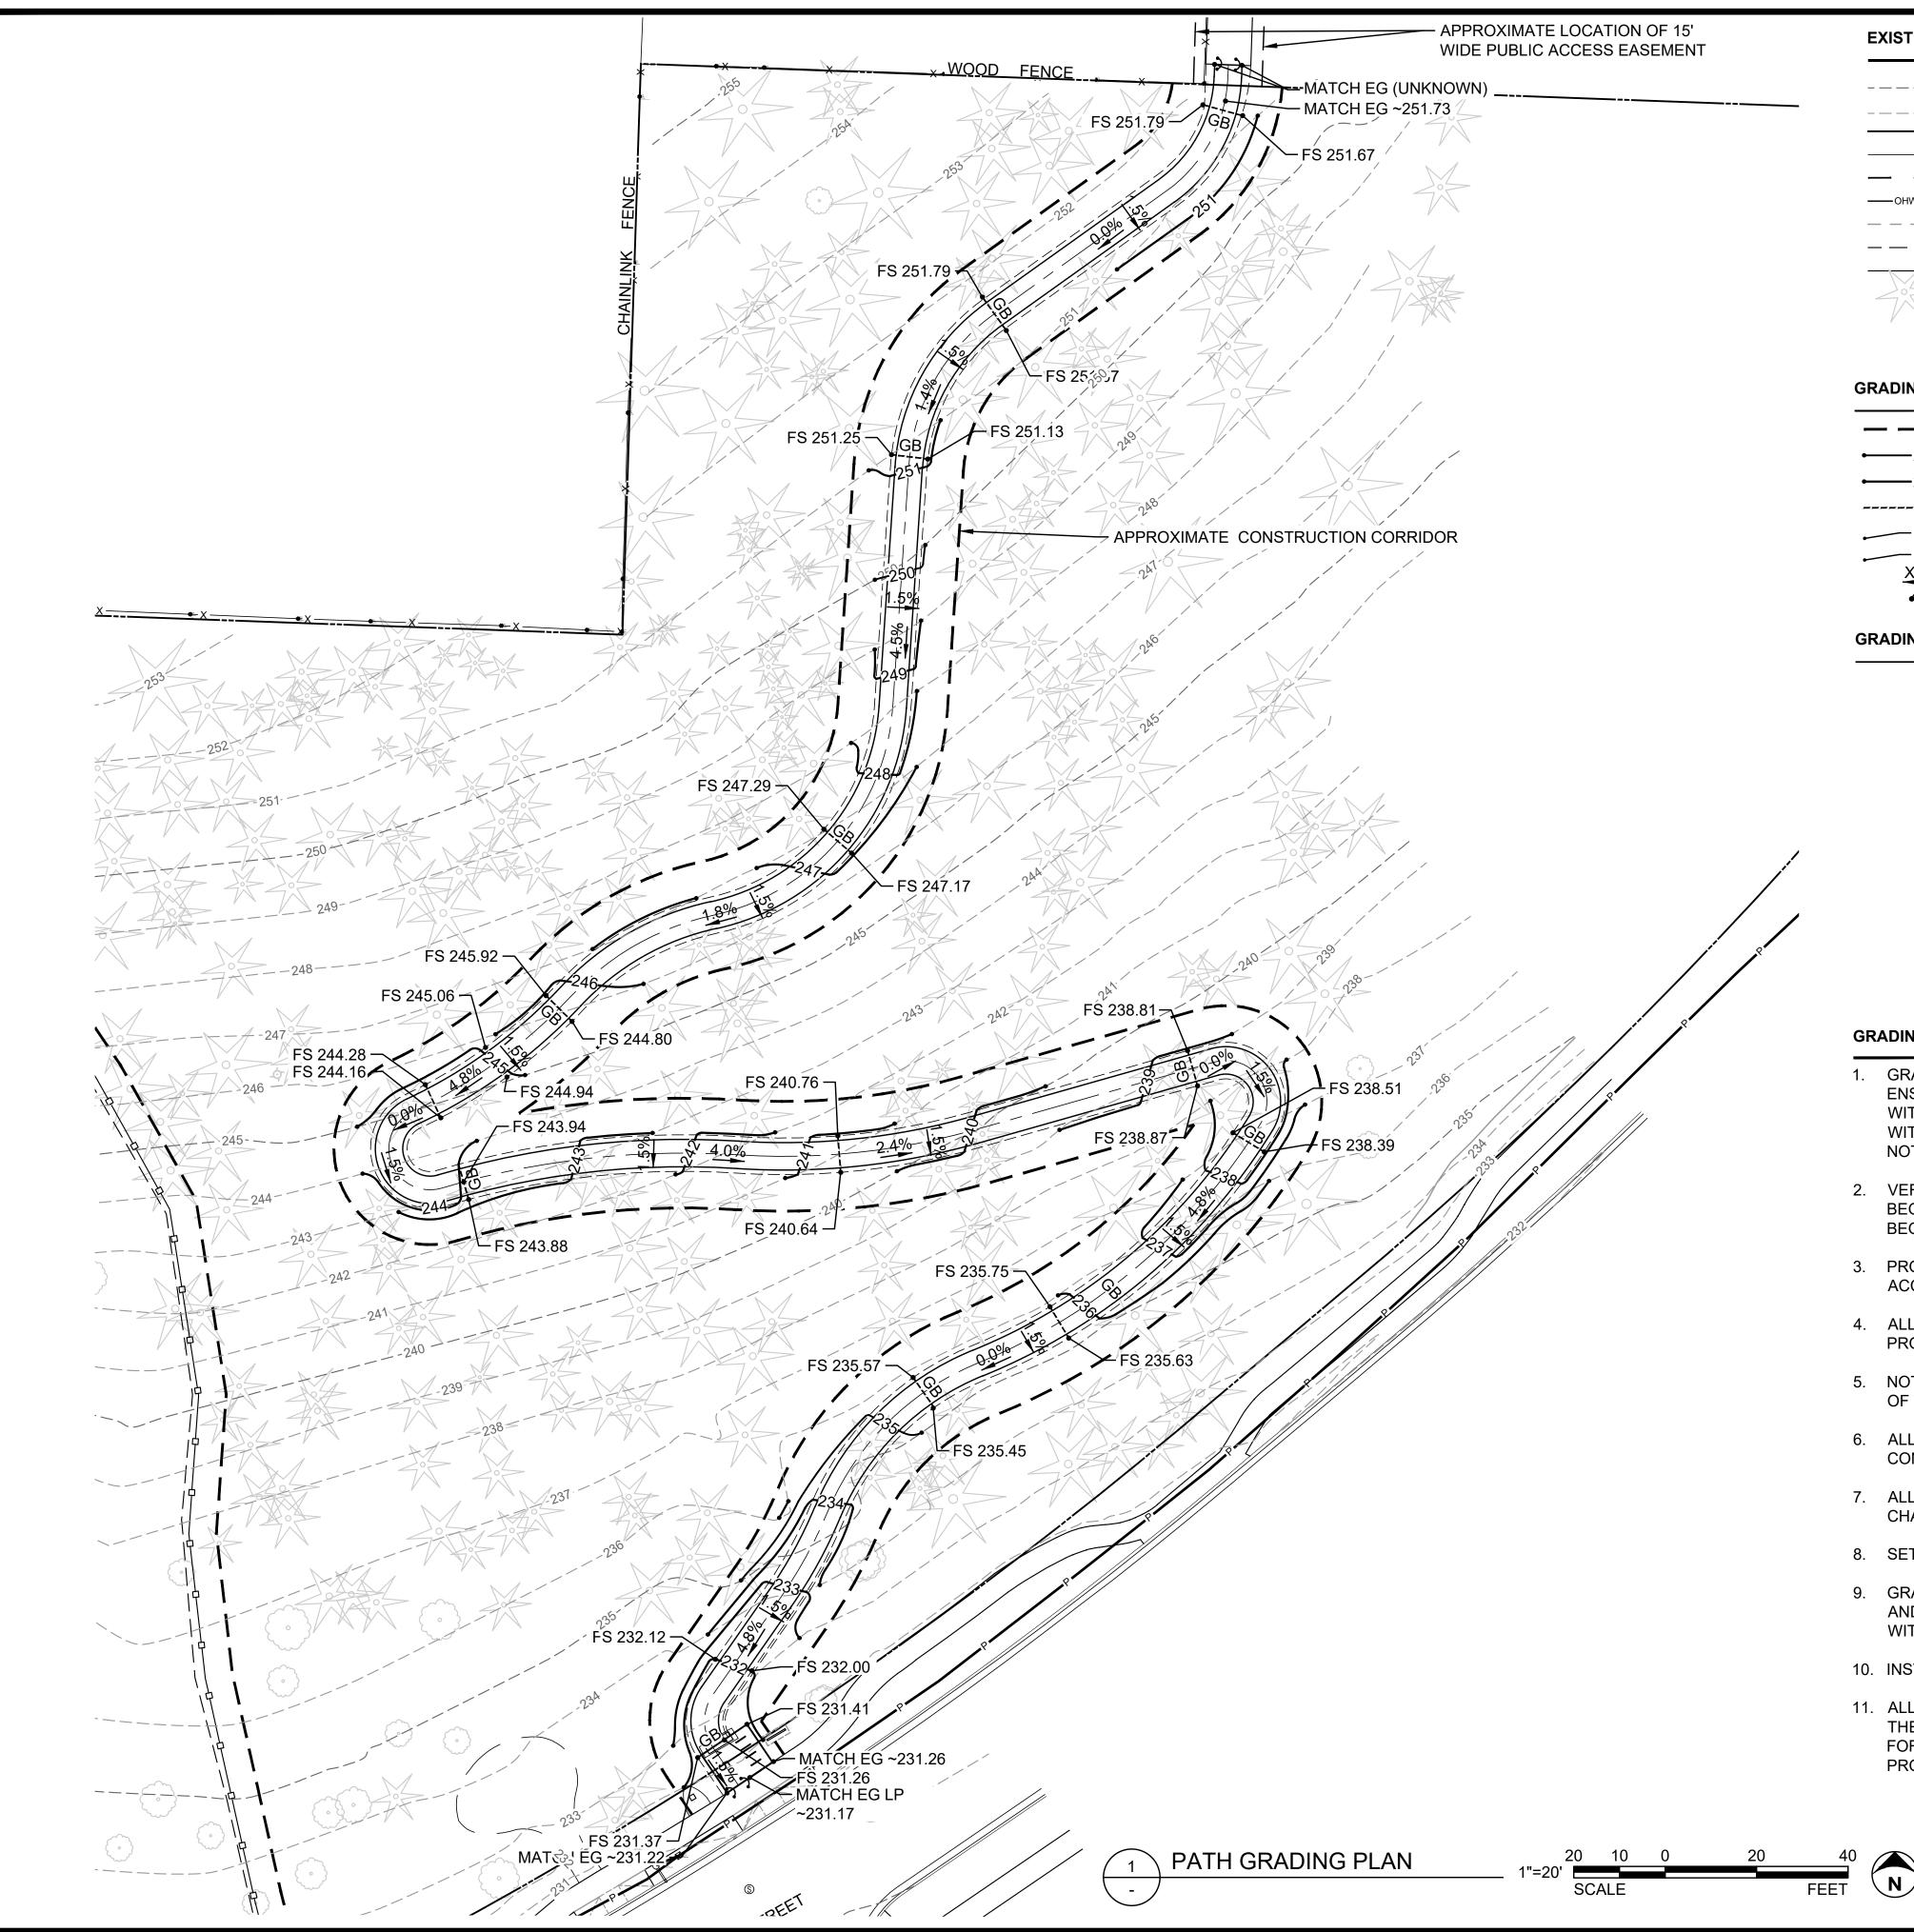




NOTES

- 1. ALL SECTIONS ARE ORIENTED LOOKING DOWNSTREAM.
- 2. SEE SHEET C3.0 FOR ADDITIONAL DROP STRUCTURE DETAILS.
- 3. SEE SHEET C3.0 FOR STREAMBED COBBLE / SEDIMENT MIX INSTALLATION INSTRUCTIONS.

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BAILEY RIDGE PARK
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PLOTTED TO FULL SIZE (22"x34") ├━━━━ 1" ━━━┤
PHASE 30% CONSTRUCTION DOCUMENTATION
SHEET TITLE
SWALE PROFILE AND SECTIONS
<u> </u>



EXISTING LEGEND

		EXISTING MAJOR
		EXISTING MINOR (
		PROPERTY LINE
X		FENCE
		TOP OF BANK
—онw——о	HW	ORDINARY HIGH V
		WETLAND
·		50' WETLAND OR S
		SWALE CENTERLI
		EXISTING CONIFE
	<pre></pre>	EXISTING DECIDU

GRADING LEGEND

	WORK LIMIT LINE
— 245 — •	PROPOSED MAJOR
— 241 —	PROPOSED MINOR
<u>GB</u>	GRADE BREAK
	SPOT ELEVATION -
— XX (XXX.XX)	SPOT ELEVATION -
<u>X.X%</u>	SLOPE
$\mathbf{}$	MATCH ELEVATION

GRADING ABBREVIATIONS

FS	FINISH SURFACE ELE
FG	FINISH GRADE ELEV.
ТС	TOP OF CURB ELEV.
TF	TOP OF FOOTING EL
BC	BOTTOM OF CURB E
TW	TOP OF WALL ELEV.
BW	BOTTOM OF WALL EI
GB	GRADE BREAK
HP	HIGH POINT
LP	LOW POINT
TS	TOP OF SLOPE
BS	BOTTOM OF SLOPE
(EG)	EXISTING GRADE

GRADING GENERAL NOTES:

- NOTED.
- BEGINNING WORK.
- ACCESS PLANS.
- OF TOPSOIL; AND FINE GRADING PRIOR TO PLANTING.
- CONVEYANCES.
- CHANGES.
- WITH PAVING JOINTS.

CONTOUR
CONTOUR

' HIGH WATER

ND OR STREAM BUFFER NTERLINE CONIFEROUS TREE DECIDUOUS TREE

> R CONTOUR CONTOUR

SEE ABBREVIATIONS EXISTING GRADE

EV. LEV. ELEV.

ELEV.

GRADING PLAN IS FOR GENERAL DIRECTION OF THE CONTRACTOR. CONTRACTOR SHALL ENSURE THAT ALL PATHS AND PEDESTRIAN AREAS ARE CONSTRUCTED IN COMPLIANCE WITH ADA STANDARDS FOR ACCESSIBLE DESIGN. PAVED PATHS TO BE CONSTRUCTED WITH 4.8% MAX. RUNNING SLOPE AND 1.5% MAX. CROSS SLOPE UNLESS OTHERWISE

2. VERIFY ACCURACY OF EXISTING GRADES AND INTERPOLATED ELEVATIONS PRIOR TO BEGINNING WORK. NOTIFY OWNER'S REPRESENTATIVE OF ANY DISCREPANCY PRIOR TO

3. PROTECT ALL TREES INDICATED TO REMAIN, SEE DEMOLITION AND CONSTRUCTION

4. ALL PROPOSED GRADES ARE TO MEET AND BLEND IN WITH EXISTING GRADING AT PROJECT LIMIT, PROPERTY LINES, BUILDING LINES AND EXISTING CURBS.

5. NOTIFY OWNER'S REPRESENTATIVE TO REVIEW ROUGH GRADES PRIOR TO PLACEMENT

6. ALL AREAS SHALL HAVE POSITIVE DRAINAGE TO APPROVED DRAINAGE STRUCTURES OR

7. ALL WALKWAYS AND PAVED AREAS SHALL HAVE SMOOTH AND CONTINUOUS ELEVATION

8. SET STRAIGHT GRADES BETWEEN GIVEN ELEVATIONS. UNLESS OTHERWISE INDICATED.

9. GRADE BREAK LINES ARE SHOWN GRAPHICALLY TO ILLUSTRATE DRAINAGE PATTERNS AND ARE NOT TO BE INSTALLED AS ACTUAL JOINT LINES, EXCEPT WHERE THEY COINCIDE

10. INSTALL DRAINS IN PAVING, SQUARE WITH AND ALIGNING TO PAVING JOINTS AS SHOWN.

11. ALL GRADES SHOWN ON THE DRAWINGS ARE BASED UPON THE DATUM ESTABLISHED BY THE SURVEYOR. ENVIRONMENTAL SCIENCE ASSOCIATES ASSUMES NO RESPONSIBILITY FOR ACCURACY OF SURVEYED CONDITIONS AS SHOWN. SURVEY INFORMATION IS PROVIDED FOR REFERENCE ONLY. NOT ALL SURVEYED SPOT ELEVATIONS ARE SHOWN.

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BAILEY
RIDGE PARK
TAXLOT NUMBER: 083W06CC13900
PROJECT NAME
REVISIONS # DATE DESCRIPTION
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REVISIONS # DATE DESCRIPTION BATE DESCRIPTION DRAWN MFN/TTF CHECKED MAC APPROVED BY MAC PROJECT # D202200371.02 ISSUE DATE JANUARY 2025 SCALE IS AS SHOWN WHEN PLOTTED TO FULL SIZE (22"x34")
REVISIONS # DATE DESCRIPTION D MEN/TE MEN/TTF CHECKED MAC MAC APPROVED BY MAC MAC PROJECT # D202200371.02 SCALE IS AS SHOWN WHEN PLOTTED TO FULL SIZE (22"x34") Image: Construction PHASE 30% CONSTRUCTION
REVISIONS # DATE DESCRIPTION D MEN/TE MEN/TTF CHECKED MAC MAC APPROVED BY MAC MAC PROJECT # D202200371.02 SCALE IS AS SHOWN WHEN PLOTTED TO FULL SIZE (22"x34") Image: Construction of the second
REVISIONS # DATE DESCRIPTION DRAWN MFN/TTF MAC DRAWN MFN/TTF MAC APPROVED BY MAC PROJECT # D202200371.02 ISSUE DATE JANUARY 2025 SCALE IS AS SHOWN WHEN PLOTTED TO FULL SIZE (22"x34") # 1"

SHEET 9 OF 20

EXISTING LEGEND

	EXISTING MAJOR CONTOUR
	EXISTING MINOR CONTOUR
	PROPERTY LINE
X	FENCE
	TOP OF BANK
онwонw	ORDINARY HIGH WATER
	WETLAND
	50' WETLAND OR STREAM BUFFER
	SWALE CENTERLINE
	EXISTING CONIFEROUS TREE
	EXISTING DECIDUOUS TREE

MATERIALS GENERAL NOTES:

- 1. CONTRACTOR TO NOTIFY OWNER'S REPRESENTATIVE OF ANY DISCREPANCIES BETWEEN PLANS AND EXISTING CONDITIONS BEFORE STARTING WORK.
- 2. SEE SHEET G4.1 FOR TREE PROTECTION.

MATERIALS LEGEND (NOT ALL HATCHES APPEAR ON EACH SHEET)

DETAIL/SHEET		
1 / L5.0		ASPHALT PAVING
2 / L5.0		CONCRETE PAVING
2 / L5.1		DESIRE LINE DECOMMISSIONING
-	PA	PLANTING AREA

DETAIL KEYNOTES (NOT ALL NOTES APPEAR ON EACH SHEET)

DETAIL/SHEET KEYNOTE

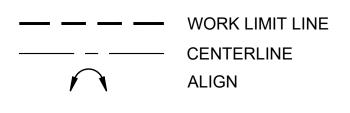
- (1.1) BICYCLE RACK 3 / L5.0 4 / L5.0
 - (1.2) DEER BROWSE FENCE (1,070 LF)

LAYOUT ABBREVIATIONS

AL	ALIGN
CC	COMPOUND CURVE
CL	CENTERLINE
CP	CENTERPOINT
Е	EASTING
EJ	EXPANSION JOINT
EQ	EQUAL
Ν	NORTHING
PC	POINT OF CURVATURE
POB	POINT OF BEGINNING
PT	POINT OF TANGENCY
R	RADIUS
RC	REVERSE CURVE
SJ	CONTRACTION / SCORE JOINT
SP	SPOT
TYP	TYPICAL

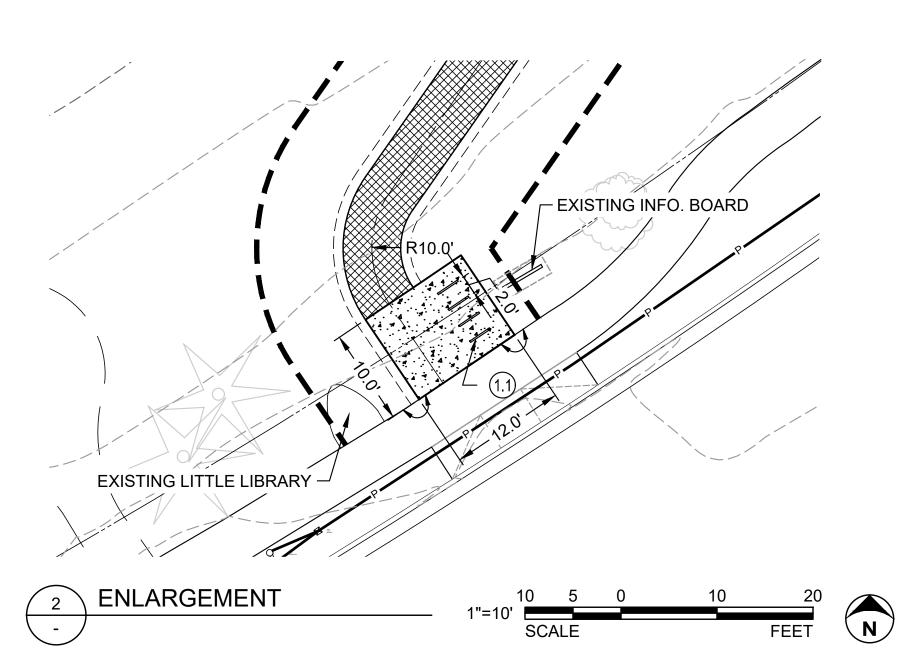
VIF VERIFY IN FIELD

LAYOUT LEGEND

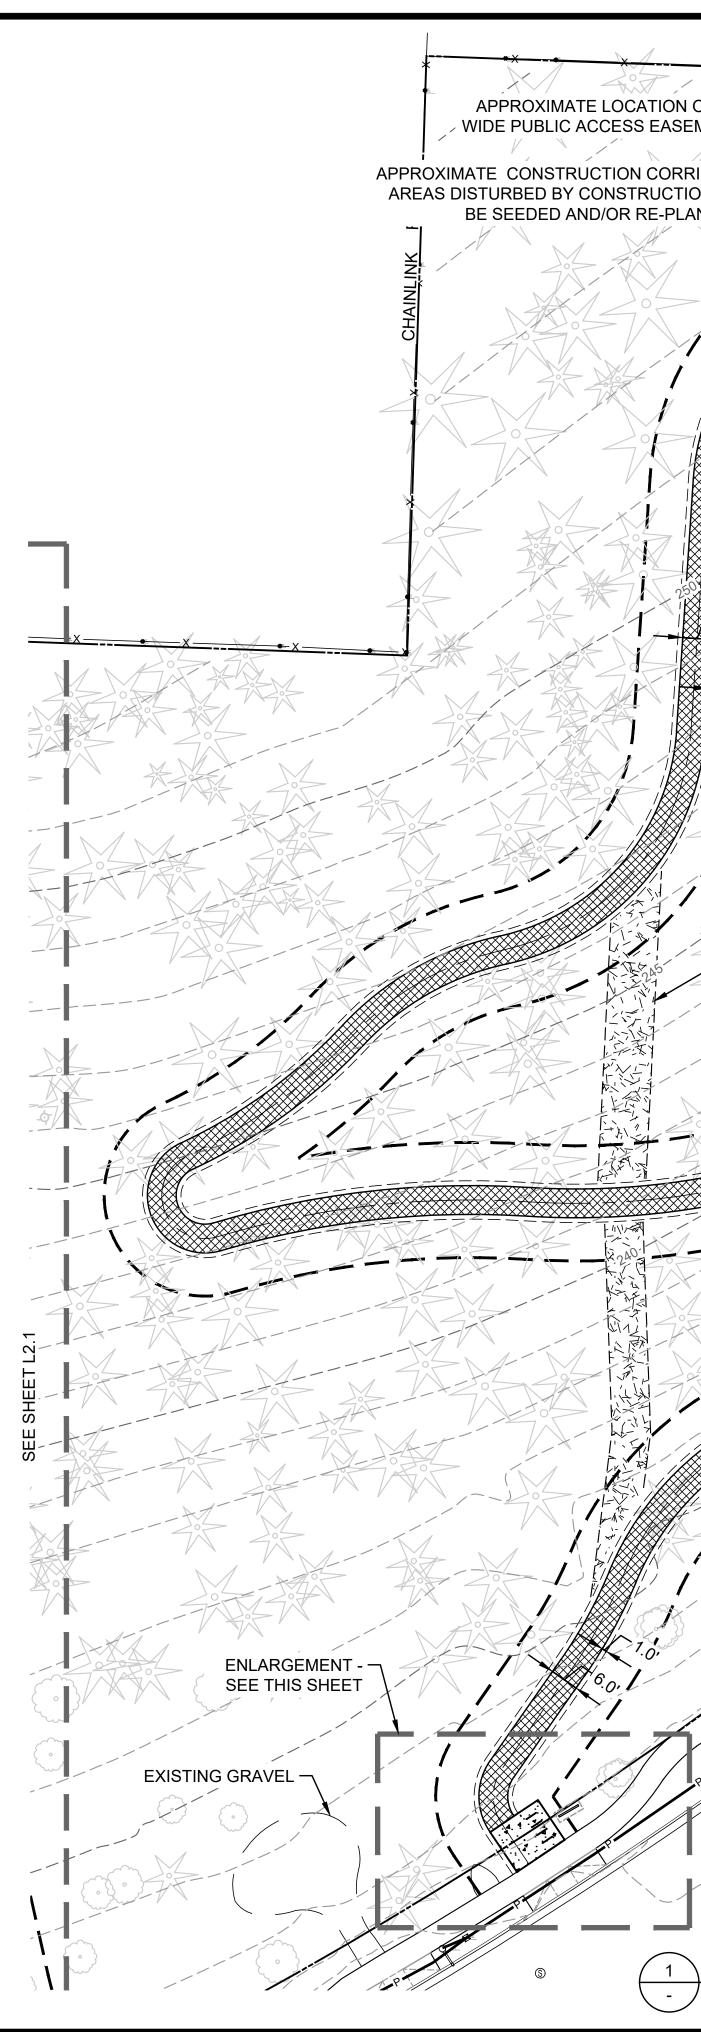


LAYOUT GENERAL NOTES

- DO NOT SCALE FROM DRAWINGS. THE LOCATION OF FEATURES NOT SPECIFICALLY DIMENSIONED MAY NOT BE DETERMINED BY SCALE.
- 2. IF CONFLICTS ARISE IN THE FIELD, CONTACT OWNER'S REPRESENTATIVE IMMEDIATELY FOR RESOLUTION.
- 3. ALL CURVED WALKS AND CURBS SHALL HAVE SMOOTH, CONTINUOUS CURVES AS INDICATED.
- 4. CONTRACTOR TO STAKE PAVING AND FURNISHINGS FOR OWNER'S REPRESENTATIVE'S APPROVAL PRIOR TO INSTALLING FORMWORK.
- 5. OWNER'S REPRESENTATIVE TO APPROVE FORMWORK FOR PAVING, CURBS, AND FURNISHINGS PRIOR TO PLACING CONCRETE.







WOOD FENCE	ESA
N OF 15' SEMENT	
RRIDOR. TION TO	819 SE MORRISON STREET, STE. 310 PORTLAND, OR 97214
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6.0' TYP.	
- 1.0'	
	BAILEY
	RIDGE PARK
APPROXIMATE LOCATION OF EXISTING DESIRE LINE THROUGH TREE GROVE	TAXLOT NUMBER:
	083W06CC13900
	VAME
	PROJECT NAME
	PRO
	REVISIONS # DATE DESCRIPTION
	DRAWN MFN/TTF
	CHECKED MAC APPROVED BY MAC
	PROJECT # D202200371.02
	ISSUE DATE JANUARY 2025
	SCALE IS AS SHOWN WHEN PLOTTED TO FULL SIZE (22"x34") I◄─── 1" ───►I
	PHASE
8	30% CONSTRUCTION DOCUMENTATION
EXISTING SIDEWALK	SHEET TITLE
	MATERIALS &
P	LAYOUT PLAN -
1	EAST
	SHEET NUMBER
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MATERIALS & LAYOUT PLAN - EAST	
	SHEET 10 OF 20

EXISTING LEGEND

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	E 3	EXIS

STING MAJOR CONTOUR STING MINOR CONTOUR OPERTY LINE CE P OF BANK DINARY HIGH WATER TLAND WETLAND OR STREAM BUFFER ALE CENTERLINE STING CONIFEROUS TREE EXISTING DECIDUOUS TREE

SHEET NOTES:

- 1. SEE SHEET L2.0 MATERIALS NOTES.
- 2. SEE SHEET L2.0 LAYOUT NOTES.

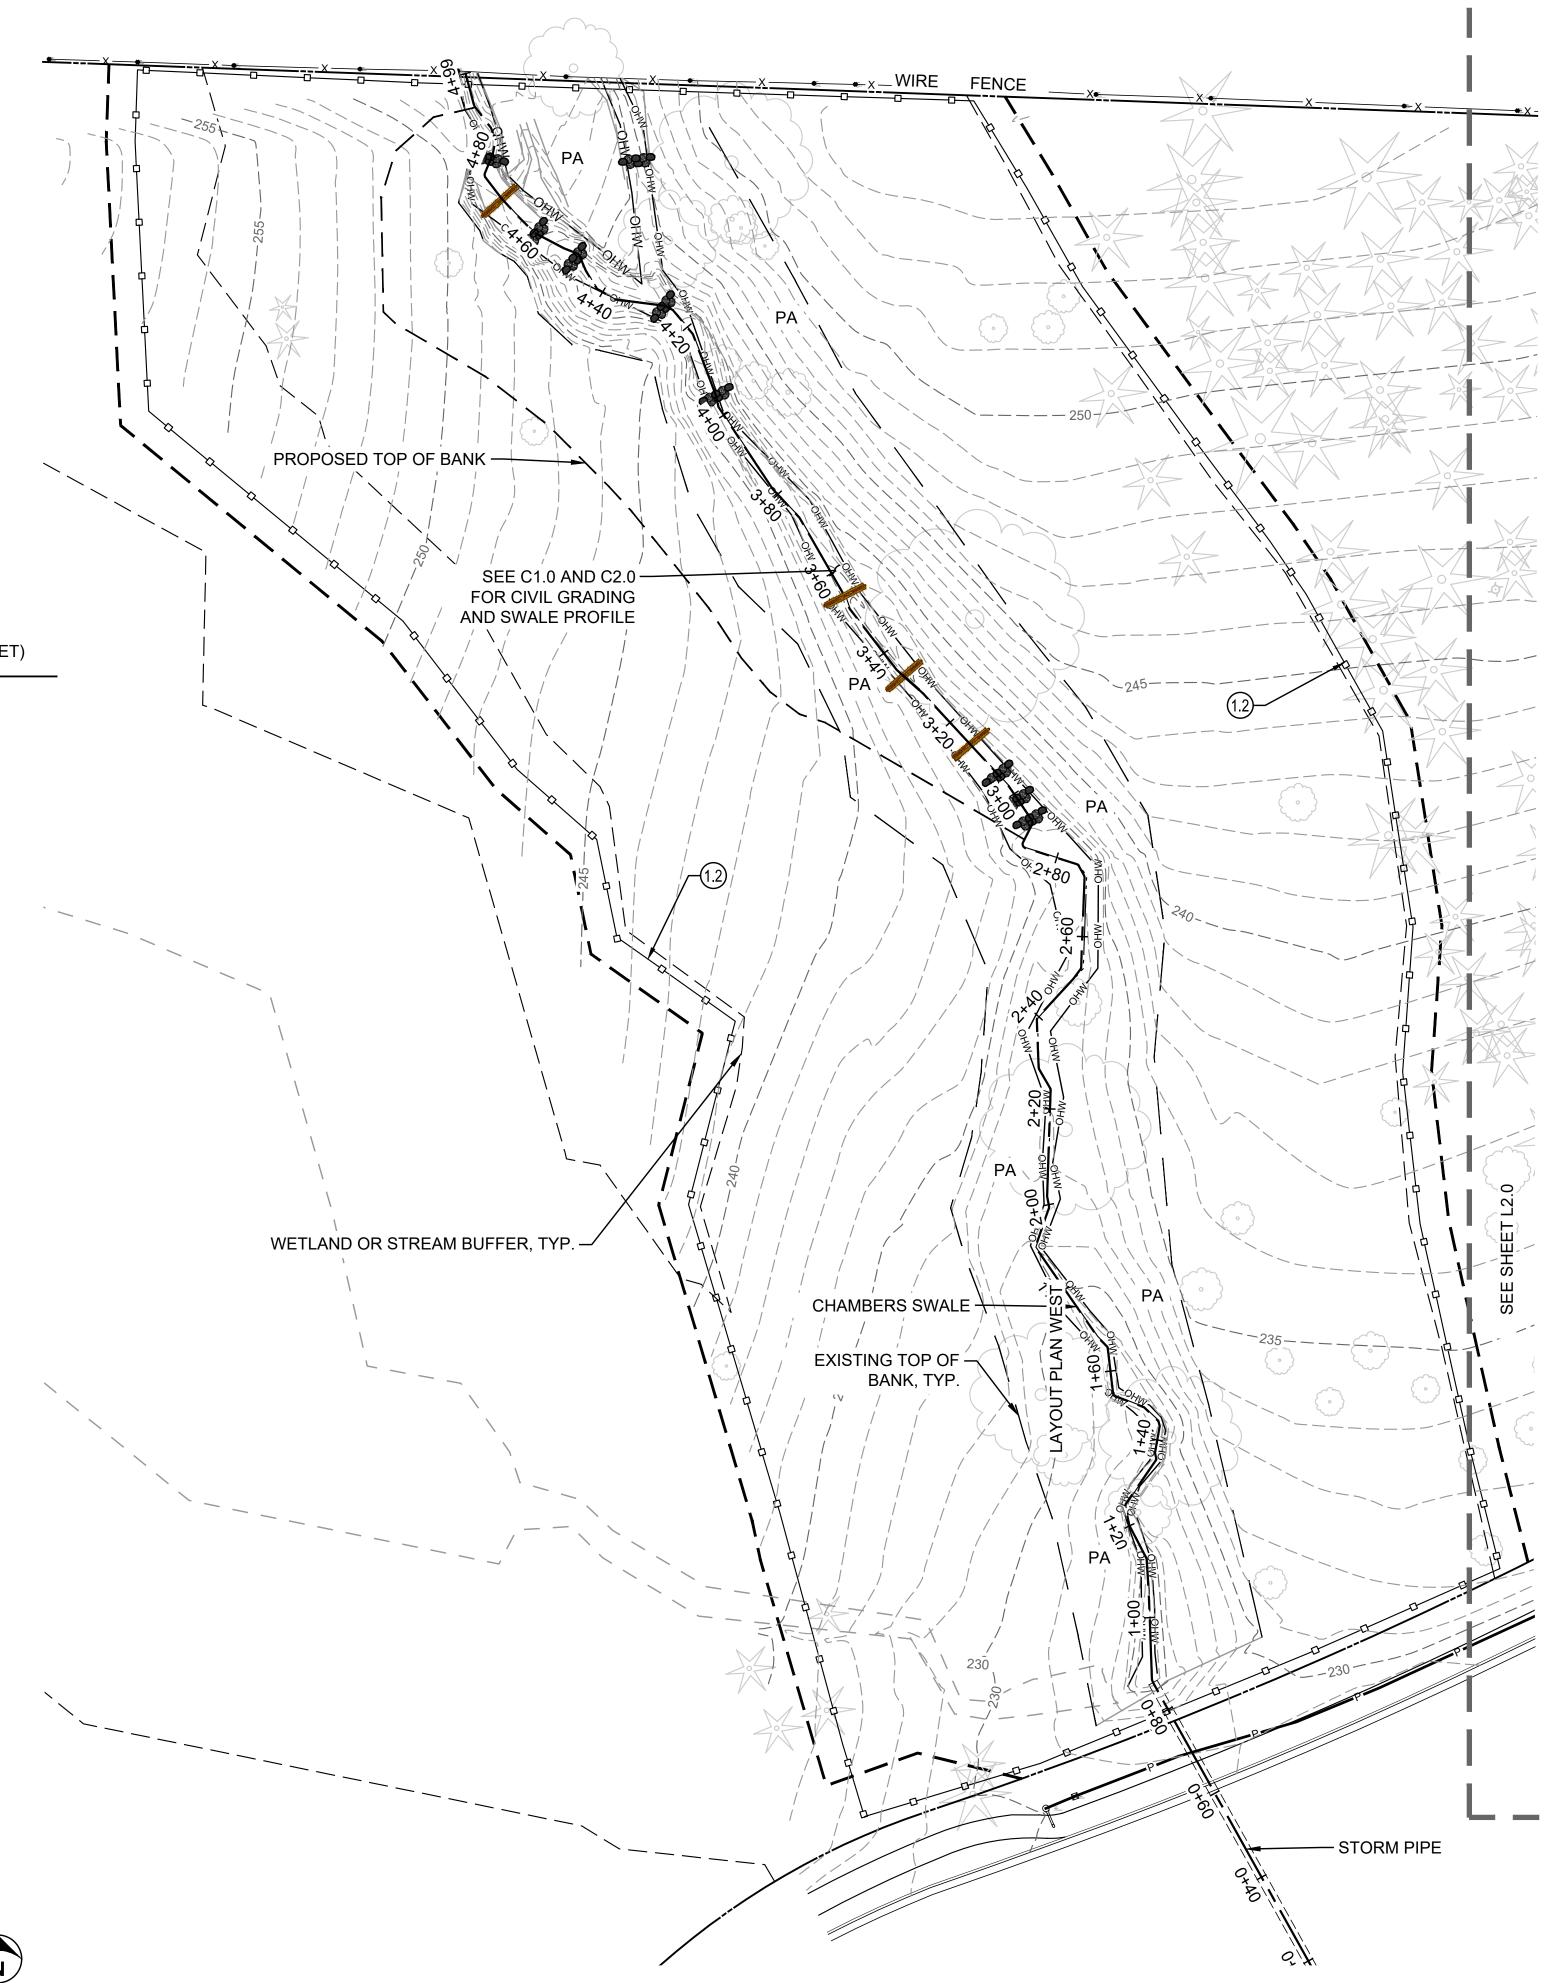
MATERIALS LEGEND (NOT ALL HATCHES APPEAR ON EACH SHEET)

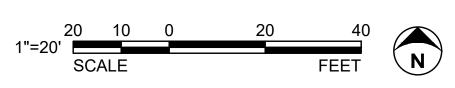
DETAIL/SH	EET	
1 / L5.0		ASPHALT PAVING
2 / L5.0		CONCRETE PAVING
2 / L5.1		DESIRE LINE DECOMMISSIONING
-	PA	PLANTING AREA

DETAIL KEYNOTES (NOT ALL NOTES APPEAR ON EACH SHEET)

DETAIL/SHEET KEYNOTE

3 / L5.0	(1.1) BICYCLE RACK
4 / L5.0	(1.2) DEER BROWSE FENCE (1,070 LF)





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MATERIALS 8	LAYOUT I	PLAN - WEST

໌ 1 -

PLANTING NOTES

- 1. ALL PLANTING AND SEEDING AREAS ARE TO RECEIVE INVASIVE PLANT REMOVAL. INVASIVE PLANTS TO BE REMOVED BY HAND TOOLS ONLY. NO EXISTING TREE ROOTS SHALL BE IMPACTED.
- 2. CONTRACTOR TO VERIFY LOCATION OF EXISTING TREES INDICATED TO REMAIN PRIOR TO SOIL PREPARATION. PROTECT ALL TREES AND SHRUBS INDICATED TO REMAIN. COORDINATE WITH THE OWNER'S REPRESENTATIVE.
- 3. PLANTING AREAS TO BE SUFFICIENTLY CLEANED OF ALL CONSTRUCTION MATERIALS, INCLUDING IMPORTED ROCK, TO THE SATISFACTION OF THE OWNER'S REPRESENTATIVE BEFORE BEGINNING ANY LANDSCAPE WORK.
- 4. IDENTIFY ALL PLANTING AREAS IN FIELD WITH WHITE FIELD-MARKING CHALK OR APPROVED EQUAL. PLANTING BEDS TO BE ADJUSTED AND APPROVED BY OWNER'S REPRESENTATIVE PRIOR TO PLANT LOCATION.
- 5. FOR PLANTING OCCURRING IN MASSES OF SAME SPECIES PLANT, LABELING REFERS TO ALL ADJACENT IDENTICAL SYMBOLS. REFER TO DETAILS AND LEGEND FOR SPACING INFORMATION.
- 6. THE OWNER'S REPRESENTATIVE WILL APPROVE INDIVIDUAL PLANT MATERIAL AND LOCATION OF PLANT MATERIAL PRIOR TO INSTALLATION. REFER TO SPECIFICATIONS FOR PROCEDURE.
- 7. PROVIDE ROOT BARRIER AT HARDSCAPE EDGES FOR ALL TREES WITHIN 5' OF PAVING, CURBS, WALLS, BUILDINGS, UTILITY DUCTS AND OTHER APPURTENANCES. ROOT BARRIER TO EXTEND FOR EXTENTS OF TREE ROOT ZONE/CANOPY.
- 8. PLANT QUANTITIES INDICATED ARE FOR THE CONVENIENCE OF THE CONTRACTOR ONLY. CONTRACTOR IS RESPONSIBLE FOR CONFIRMING PLANT QUANTITIES REQUIRED AND PLANT QUANTITIES AND LOCATIONS SHOWN ON DRAWINGS.
- 9. PROVIDE COIR MAT ON ALL SLOPES WITH GRADIENT OF 3:1 OR GREATER AS DIRECTED IN THE FIELD BY THE OWNER'S REPRESENTATIVE. STAPLE FABRIC TO GROUND WITH METAL STAKES AT 4' O.C.
- 10. HOLD PLANTINGS BACK 18 INCHES FROM EDGE OF PAVING. EXTEND FULL 3 INCH DEPTH MULCH TO EDGE OF PAVING IN PLANTING AREAS.

	JLE: OAK SAVANNAH			1		0.9	
Symbol	Botanical Name	Common Name	% of Mix	Spacing	Туре	Size	Quantity
	Trees				-		
MINNIN AND							
1111	Quercus garryana	Gary Oak	N/A	AS SHOWN	Bareroot	1" CAL	17
, Mult							
	Pinus ponderosa	Ponderosa pine	N/A	AS SHOWN	Bareroot	1" CAL	18
	Arbutus madrona	Pacific madrone	N/A	AS SHOWN	Bareroot	1" CAL	15
l .	•						
	Seed - Upland Savanna Econon						
••••••	PT Lawn Seed 453 Native Dry Pra	airie Mix, 50% grasses, 40% perrenial flower	s, 10% annual f	lowers			
	Botanical Name	Common Name	Application F	Rate (Pounds PLS//	Acre)		
	California Oatgrass	Danthonia californica	According to	manufacturer			
• • • • • • • • • • • • • • • • • • •	Roemer's Fescue	Festuca roemeri	According to	manufacturer			
	Prairie Junegrass	Koeleria macrantha	According to	manufacturer			
,	Pine Bluegrass	Poa secunda (P. scabrella)	According to	manufacturer			
••••••	Meadow Checkermallow	Sidalcea campestris	According to	manufacturer			
· · · · · · · · · · · · · · · · · · ·	Rose Checkermallow	Sidalcea malviflora ssp virgata	According to	manufacturer			
•••••	Western Buttercup	Ranunculus occidentalis	According to	manufacturer			
•••••	Oregon Sunshine	Eriophyllum lanatum	-	manufacturer			
•••••	Western Yarrow	Achillea millefolium	-	manufacturer			
	Lance Self-heal	Prunella vulgaris v. lanceolata	°	manufacturer			
· · · · · · · · · · · · · · · · · · ·	Hall's Aster	Symphyotrichum (Aster) hallii	-	manufacturer			
· • • • • • • • • • • • • • • • • • • •	Farewell to Spring		-	manufacturer			
•••••		Clarkia amoena Collinsia grandiflora	-	manufacturer			
	Large-flowered Blue-eyed Mary	-					
	Purple Godetia	Clarkia purpurea ssp. quadrivulnera	-	manufacturer			
	Large-flowered Collomia	Collomia grandiflora	-	manufacturer			
•••••	Blue Field Gilia	Gilia capitata	-	manufacturer			
	Seablush/Rosy Plectritis	Plectritis congesta		manufacturer			
	Showy Tarweed	Madia elegans	-	manufacturer			
	Purple Sanicle	Sanicula bipinnatifida	According to	manufacturer			
• • • • • • • • • • • • • • • • • • • •	•		6	Total Pounds PL	S/Acre		
	Planting Area Prep	SEE SPECIFICATIONS					
	Topsoil	SEE SPECIFICATIONS					
	Mulch	SEE SPECIFICATIONS					

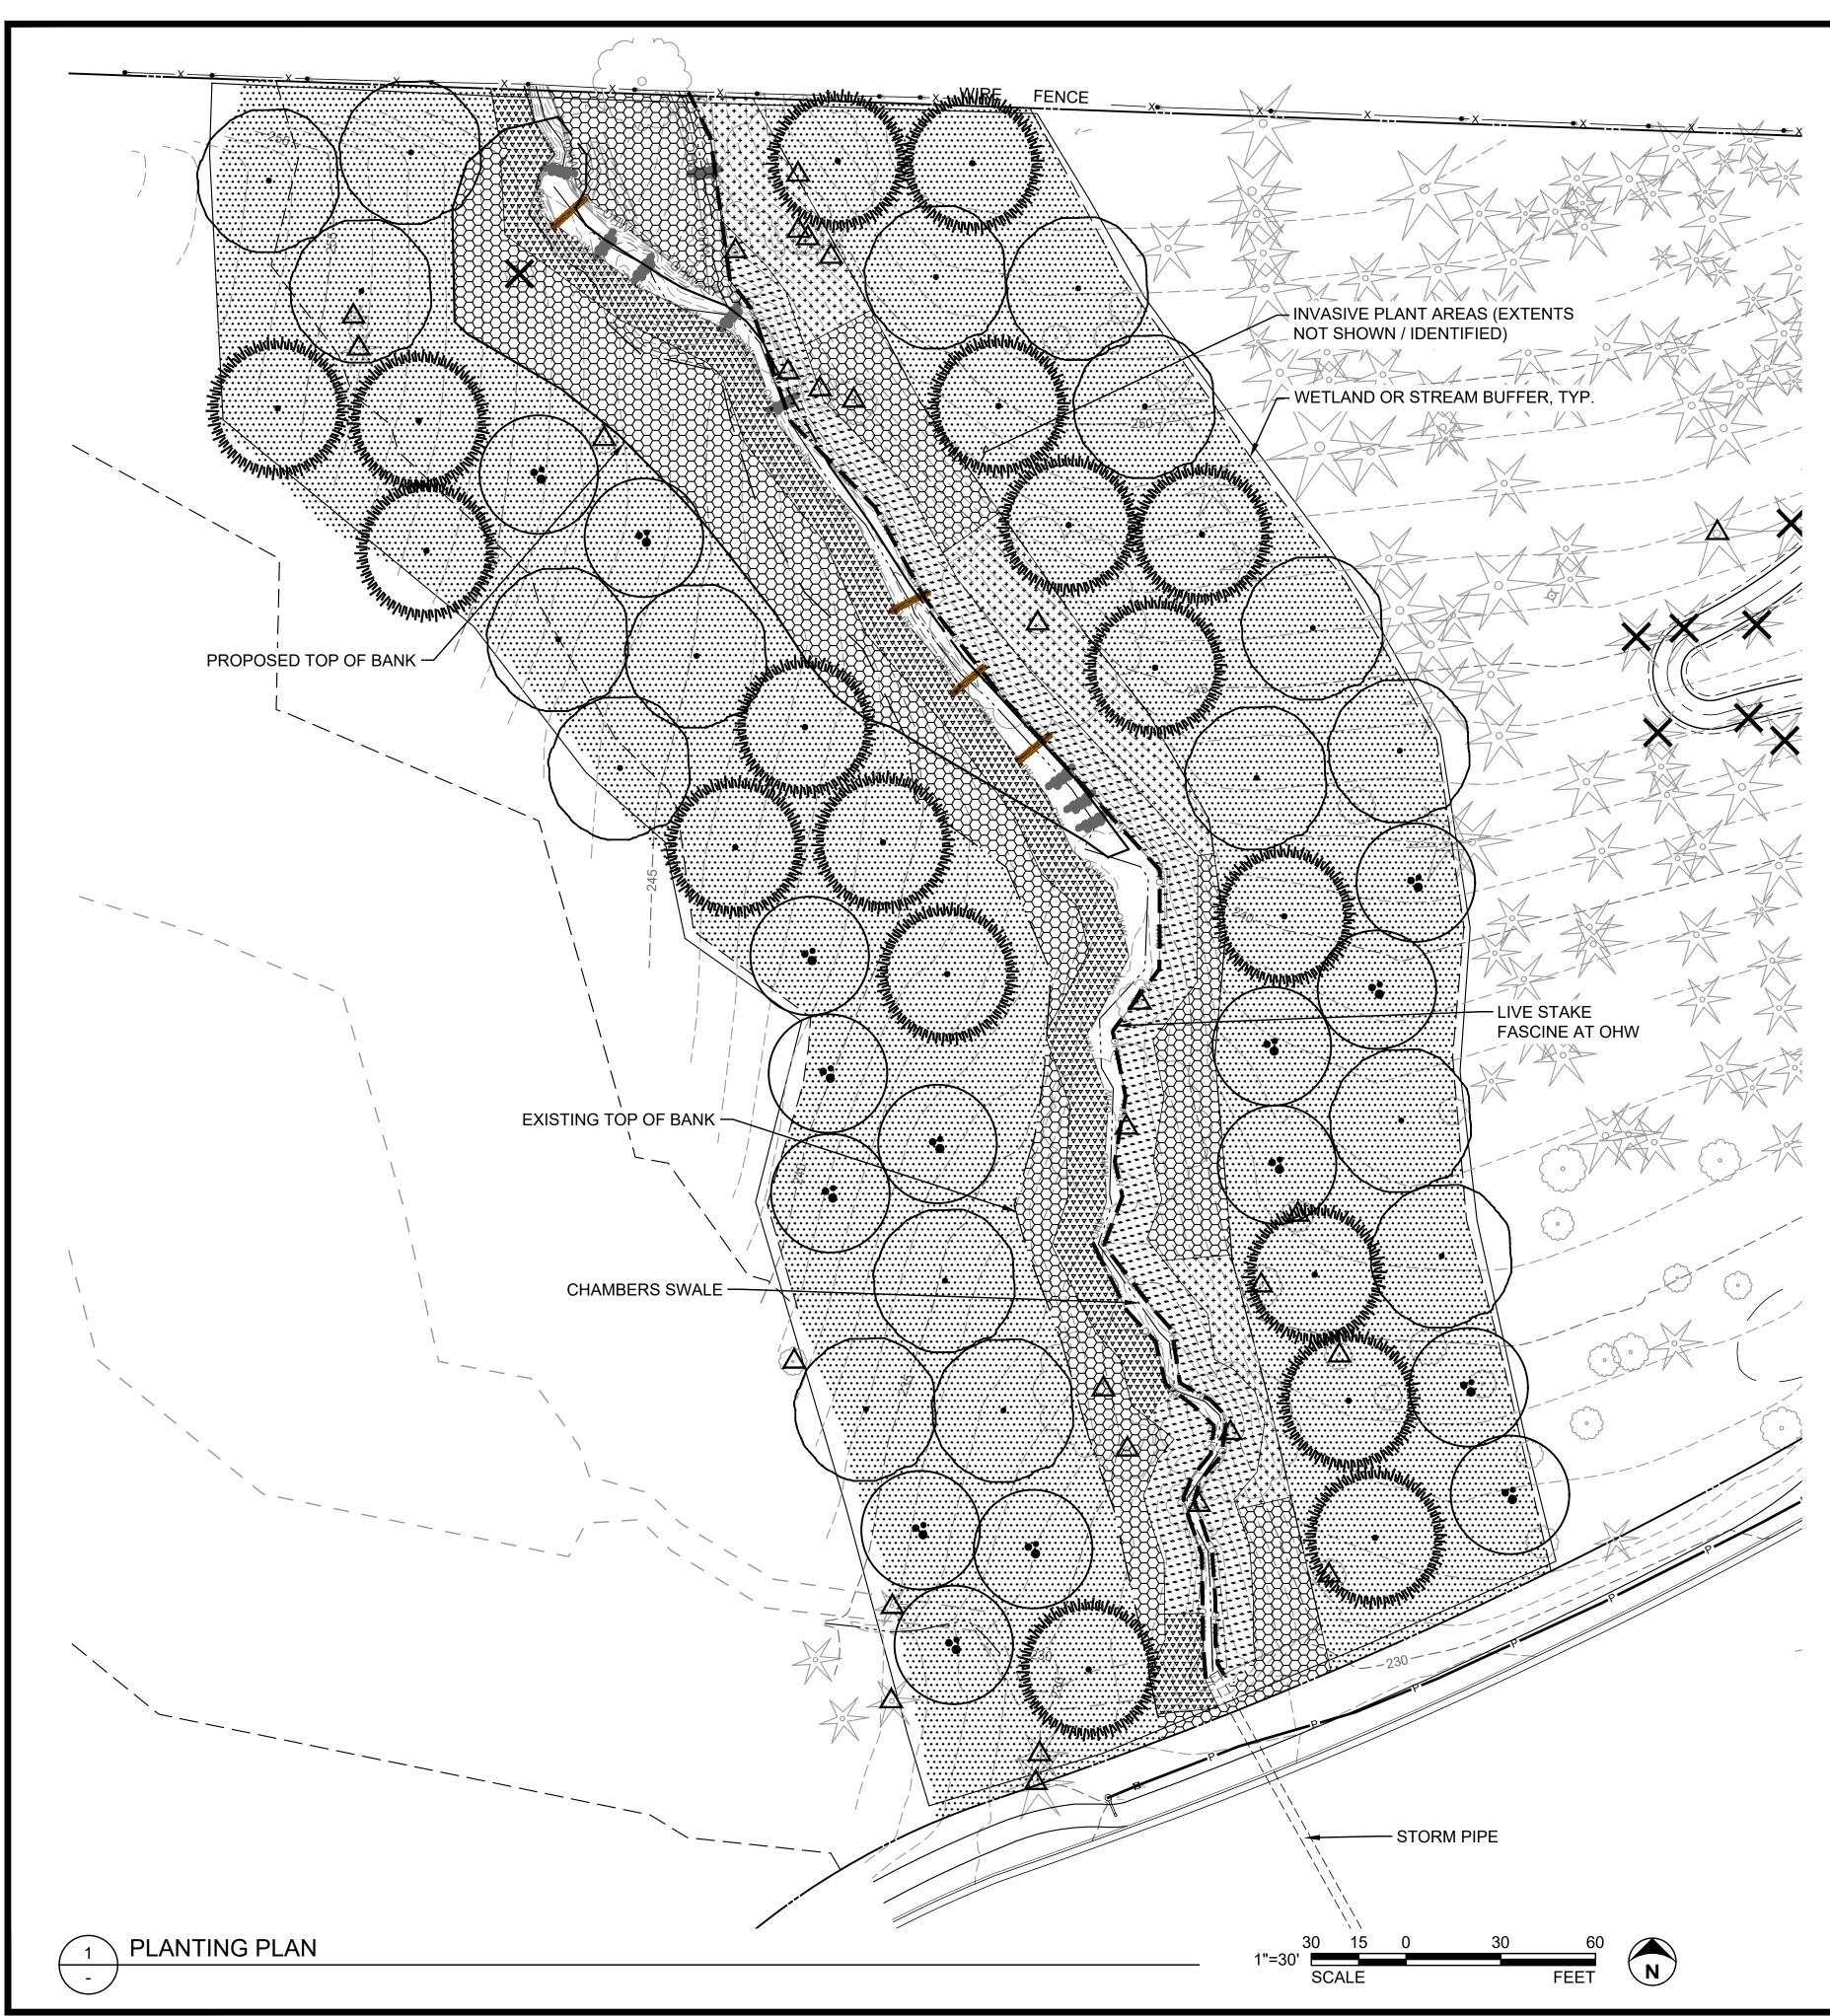
ANT SCHEDU	LE: LIVE STAKES AT UNDIS	URBED LOWER RIPARIAN				3,204	Square Feet
Symbol	Botanical Name	Common Name	% of Mix	Spacing	Туре	Size	Quantity
	Live Stakes				•	· · · · ·	
	Cornus sericea	Red twig dogwood	16%	36" O.C.	LIVE STAKE	36" LENGTH	68
	Physocarpus capitatus	Pacific ninebark	16%	36" O.C.	LIVE STAKE	36" LENGTH	68
	Spiraea douglasii	Douglas spirea	16%	36" O.C.	LIVE STAKE	36" LENGTH	68
	Salix hookeriana	Hooker's Willow	16%	36" O.C.	LIVE STAKE	36" LENGTH	68
	Salix lucida ssp. lasiandra	Pacific Willow	16%	36" O.C.	LIVE STAKE	36" LENGTH	68
	Salix sitchensis	Sitka Willow	16%	36" O.C.	LIVE STAKE	36" LENGTH	68

PLANT SCHEDU	LE: LIVE STAKES AT SENSIT	IVE PLANTING AREA				2,221	Square Feet
Symbol	Botanical Name	Common Name	% of Mix	Spacing	Туре	Size	Quantity
******	Live Stakes	·					
· · · · · · · · · · · · · · · · · · ·	Cornus sericea	Red twig dogwood	16%	5' O.C.	LIVE STAKE	36" LENGTH	19
* * * * * * * * * * * * * * * * * * * *	Physocarpus capitatus	Pacific ninebark	16%	5' O.C.	LIVE STAKE	36" LENGTH	19
+ + + + + + + + + + + + + + + + + + +	Spiraea douglasii	Douglas spirea	16%	5' O.C.	LIVE STAKE	36" LENGTH	19
+ + + + + + + + + + + + + + + + + + +	Salix hookeriana	Hooker's Willow	16%	5' O.C.	LIVE STAKE	36" LENGTH	19
• • • • • • • • • • • • • • • • • • • •	Salix lucida ssp. lasiandra	Pacific Willow	16%	5' O.C.	LIVE STAKE	36" LENGTH	19
+ `+ ` + `+ `+ `+ `+ `+ `+ `+ + + + + +	Salix sitchensis	Sitka Willow	16%	5' O.C.	LIVE STAKE	36" LENGTH	19

PLANT SCHEDU	LE: LOWER RIPARIAN					2,922	Square Feet
Symbol	Botanical Name	Common Name	% of Mix	Spacing	Туре	Size	Quantity
, , , , , , , , , , , , , , , , , , , 	Trees				•		
* * * * * * * * * * * * * * * * * * *	Alnus rubra	Red Alder	33%	20' O.C.	CONTAINER	1 GAL	3
* * * * * * * * * * * * * * * * * * *	Fraxinus latifolia	Oregon Ash	33%	20' O.C.	CONTAINER	1 GAL	3
* * * * * * * * * * * * * * * * * * *	Salix lucida ssp. lasiandra	Pacific Willow	33%	20' O.C.	CONTAINER	1 GAL	3
~ ~ ~ ~ ~ ~ ~ ~ ~ ~ ~ ~ ~ ~ ~ ~ ~ ~ ~	Shrubs						
~ ~ ~ ~ ~ ~ ~ ~ ~ ~ ~ ~ ~ ~ ~ ~ ~ ~ ~	Cornus sericea	Red twig dogwood	14%	5' O.C.	CONTAINER	1 GAL	20
.	Salix hookeriana	Hooker's Willow	14%	5' O.C.	CONTAINER	1 GAL	20
~ ~ ~ ~ ~ ~ ~ ~ ~ ~ ~ ~ ~ ~ ~ ~ ~ ~ ~	Salix lucida ssp. lasiandra	Pacific Willow	14%	5' O.C.	CONTAINER	1 GAL	20
* * * * * * * * * * * * * * * * * * *	Salix sitchensis	Sitka Willow	14%	5' O.C.	CONTAINER	1 GAL	20
* * * * * * * * * * * * * * * * * * *	Rubus spectabilis	Salmonberry	14%	5' O.C.	CONTAINER	1 GAL	20
* * * * * * * * * * * * * * * * * * *	Physocarpus capitatus	Pacific ninebark	14%	5' O.C.	CONTAINER	1 GAL	20
~ ~ ~ ~ ~ ~ ~ ~ ~ ~ ~ ~ ~ ~ ~ ~ ~ ~ ~	Spiraea douglasii	Douglas spirea	14%	5' O.C.	CONTAINER	1 GAL	20
,	Herbaceous						
~ ~ ~ ~ ~ ~ ~ ~ ~ ~ ~ ~ ~ ~ ~ ~ ~ ~ ~	Beckmannia syzigachne	American Slough Grass	16%	30" O.C.	PLUG	10 CUBIC INCH	55
~ ~ ~ ~ ~ ~ ~ ~ ~ ~ ~ ~ ~ ~ ~ ~ ~ ~ ~	Carex obnupta	Slough Sedge	16%	30" O.C.	PLUG	10 CUBIC INCH	55
* * * * * * * * * * * * * * * * * * *	Glyceria striata	Fowl Mannagrass	16%	30" O.C.	PLUG	10 CUBIC INCH	55
~ ~ ~ ~ ~ ~ ~ ~ ~ ~ ~ ~ ~ ~ ~ ~ ~ ~ ~	Juncus effusus ssp. Pacificus	Pacific Rush	16%	30" O.C.	PLUG	10 CUBIC INCH	55
~ ~ ~ ~ ~ ~ ~ ~ ~ ~ ~ ~ ~ ~ ~ ~ ~ ~ ~	Juncus effusus ssp.		16%	30" O.C.	PLUG	10 CUBIC INCH	55
~ ~ ~ ~ ~ ~ ~ ~ ~ ~ ~ ~ ~ ~ ~ ~ ~ ~ ~	Juncus patens	Spreading Rush	16%	30" O.C.	PLUG	10 CUBIC INCH	55

PLANT SCHEDU	LE: UPPER RIPARIAN					7,631	Square Feet
Symbol	Botanical Name	Common Name	% of Mix	Spacing	Туре	Size	Quantity
35353555	Trees	•			•		
3838888	Acer macrophyllum	Big Leaf Maple	16%	20' O.C.	CONTAINER	1" CAL	4
888888	Corylus cornuta	Beaked Hazlenut	16%	20' O.C.	CONTAINER	1" CAL	4
	Crataegus douglasii	Black Hawthorne	16%	20' O.C.	CONTAINER	1" CAL	4
388888	Quercus garryana	Gary Oak	16%	20' O.C.	CONTAINER	1" CAL	4
3333333	Pinus ponderosa	Ponderosa pine	16%	20' O.C.	CONTAINER	1" CAL	4
888888	Arbutus madrona	Pacific madrone	16%	20' O.C.	CONTAINER	1" CAL	4
388888	Shrubs		•		•	••	
3333333	Amelanchier alnifolia	Serviceberry	14%	5' O.C.	CONTAINER	1 GAL	51
888886	Holodiscus discolor	Ocean Spray	14%	5' O.C.	CONTAINER	1 GAL	51
388888	Mahonia aquifolium	Oregon Grape	14%	5' O.C.	CONTAINER	1 GAL	51
	Physocarpus capitatus	Pacific Ninebark	14%	5' O.C.	CONTAINER	1 GAL	51
88888	Symphoricarpos albus	Snowberry	14%	5' O.C.	CONTAINER	1 GAL	51
36666666	Spiraea douglasii	Douglas spirea	14%	5' O.C.	CONTAINER	1 GAL	51
	Polystichum munitum	Sword fern	14%	5' O.C.	CONTAINER	1 GAL	51
88888	Herbaceous		•	•	•		
3636366	Achillea millefolium	Common Yarrow	14%	30" O.C.	PLUG	10 CUBIC INCH	190
******	Acmispon americanus var. americanus	American bird's-foot trefoil	14%	30" O.C.	PLUG	10 CUBIC INCH	190
888888	Bromus sitchensis/carinatus	Alaska Brome	14%	30" O.C.	PLUG	10 CUBIC INCH	190
	Elymus glaucus	Wild Rye	14%	30" O.C.	PLUG	10 CUBIC INCH	190
388888	Hordeum brachyantherum	Meadow Barley	14%	30" O.C.	PLUG	10 CUBIC INCH	190
33333333	Potentilla gracilis	Slender Cinquefoil	14%	30" O.C.	PLUG	10 CUBIC INCH	190
888888	Sidalcea campestris	Meadow Checkermallow	14%	30" O.C.	PLUG	10 CUBIC INCH	190

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STAMP PRELIMINARY
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OWNER
CITY OF Salem AT YOUR SERVICE
BAILEY
RIDGE PARK
TAXLOT NUMBER: 083W06CC13900
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	PROPERTY LINE
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	WETLAND
	50' WETLAND OR STREAM BUFFER
	SWALE CENTERLINE
	EXISTING CONIFEROUS TREE
	EXISTING DECIDUOUS TREE

1. SEE SHEET L3.0 FOR PLANTING NOTES AND LEGENDS.

2. SEE SHEET G4.1 FOR TREE DEMOLITION AND PROTECTION.

PLANTING LEGEND

OAK SAVANNAH

UPPER RIPARIAN PLANTING

LOWER RIPARIAN PLANTING

LIVE STAKES AT UNDISTURBED LOWER RIPARIAN LIVES STAKES AT SENSITIVE PLANTING AREA

LIVE STAKE FASCINE AT OHW

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IRRIGATION EQUIPMENT

SYMBOL	DESCRIPTION
	- POINT OF CONNECTION TO WATER SUPPLY - WATER METER
	IRRIGATION LATERAL - ABOVE GRADE, CLASS
	IRRIGATION MAINLINE - BELOW GRADE, 2-INC

TBD

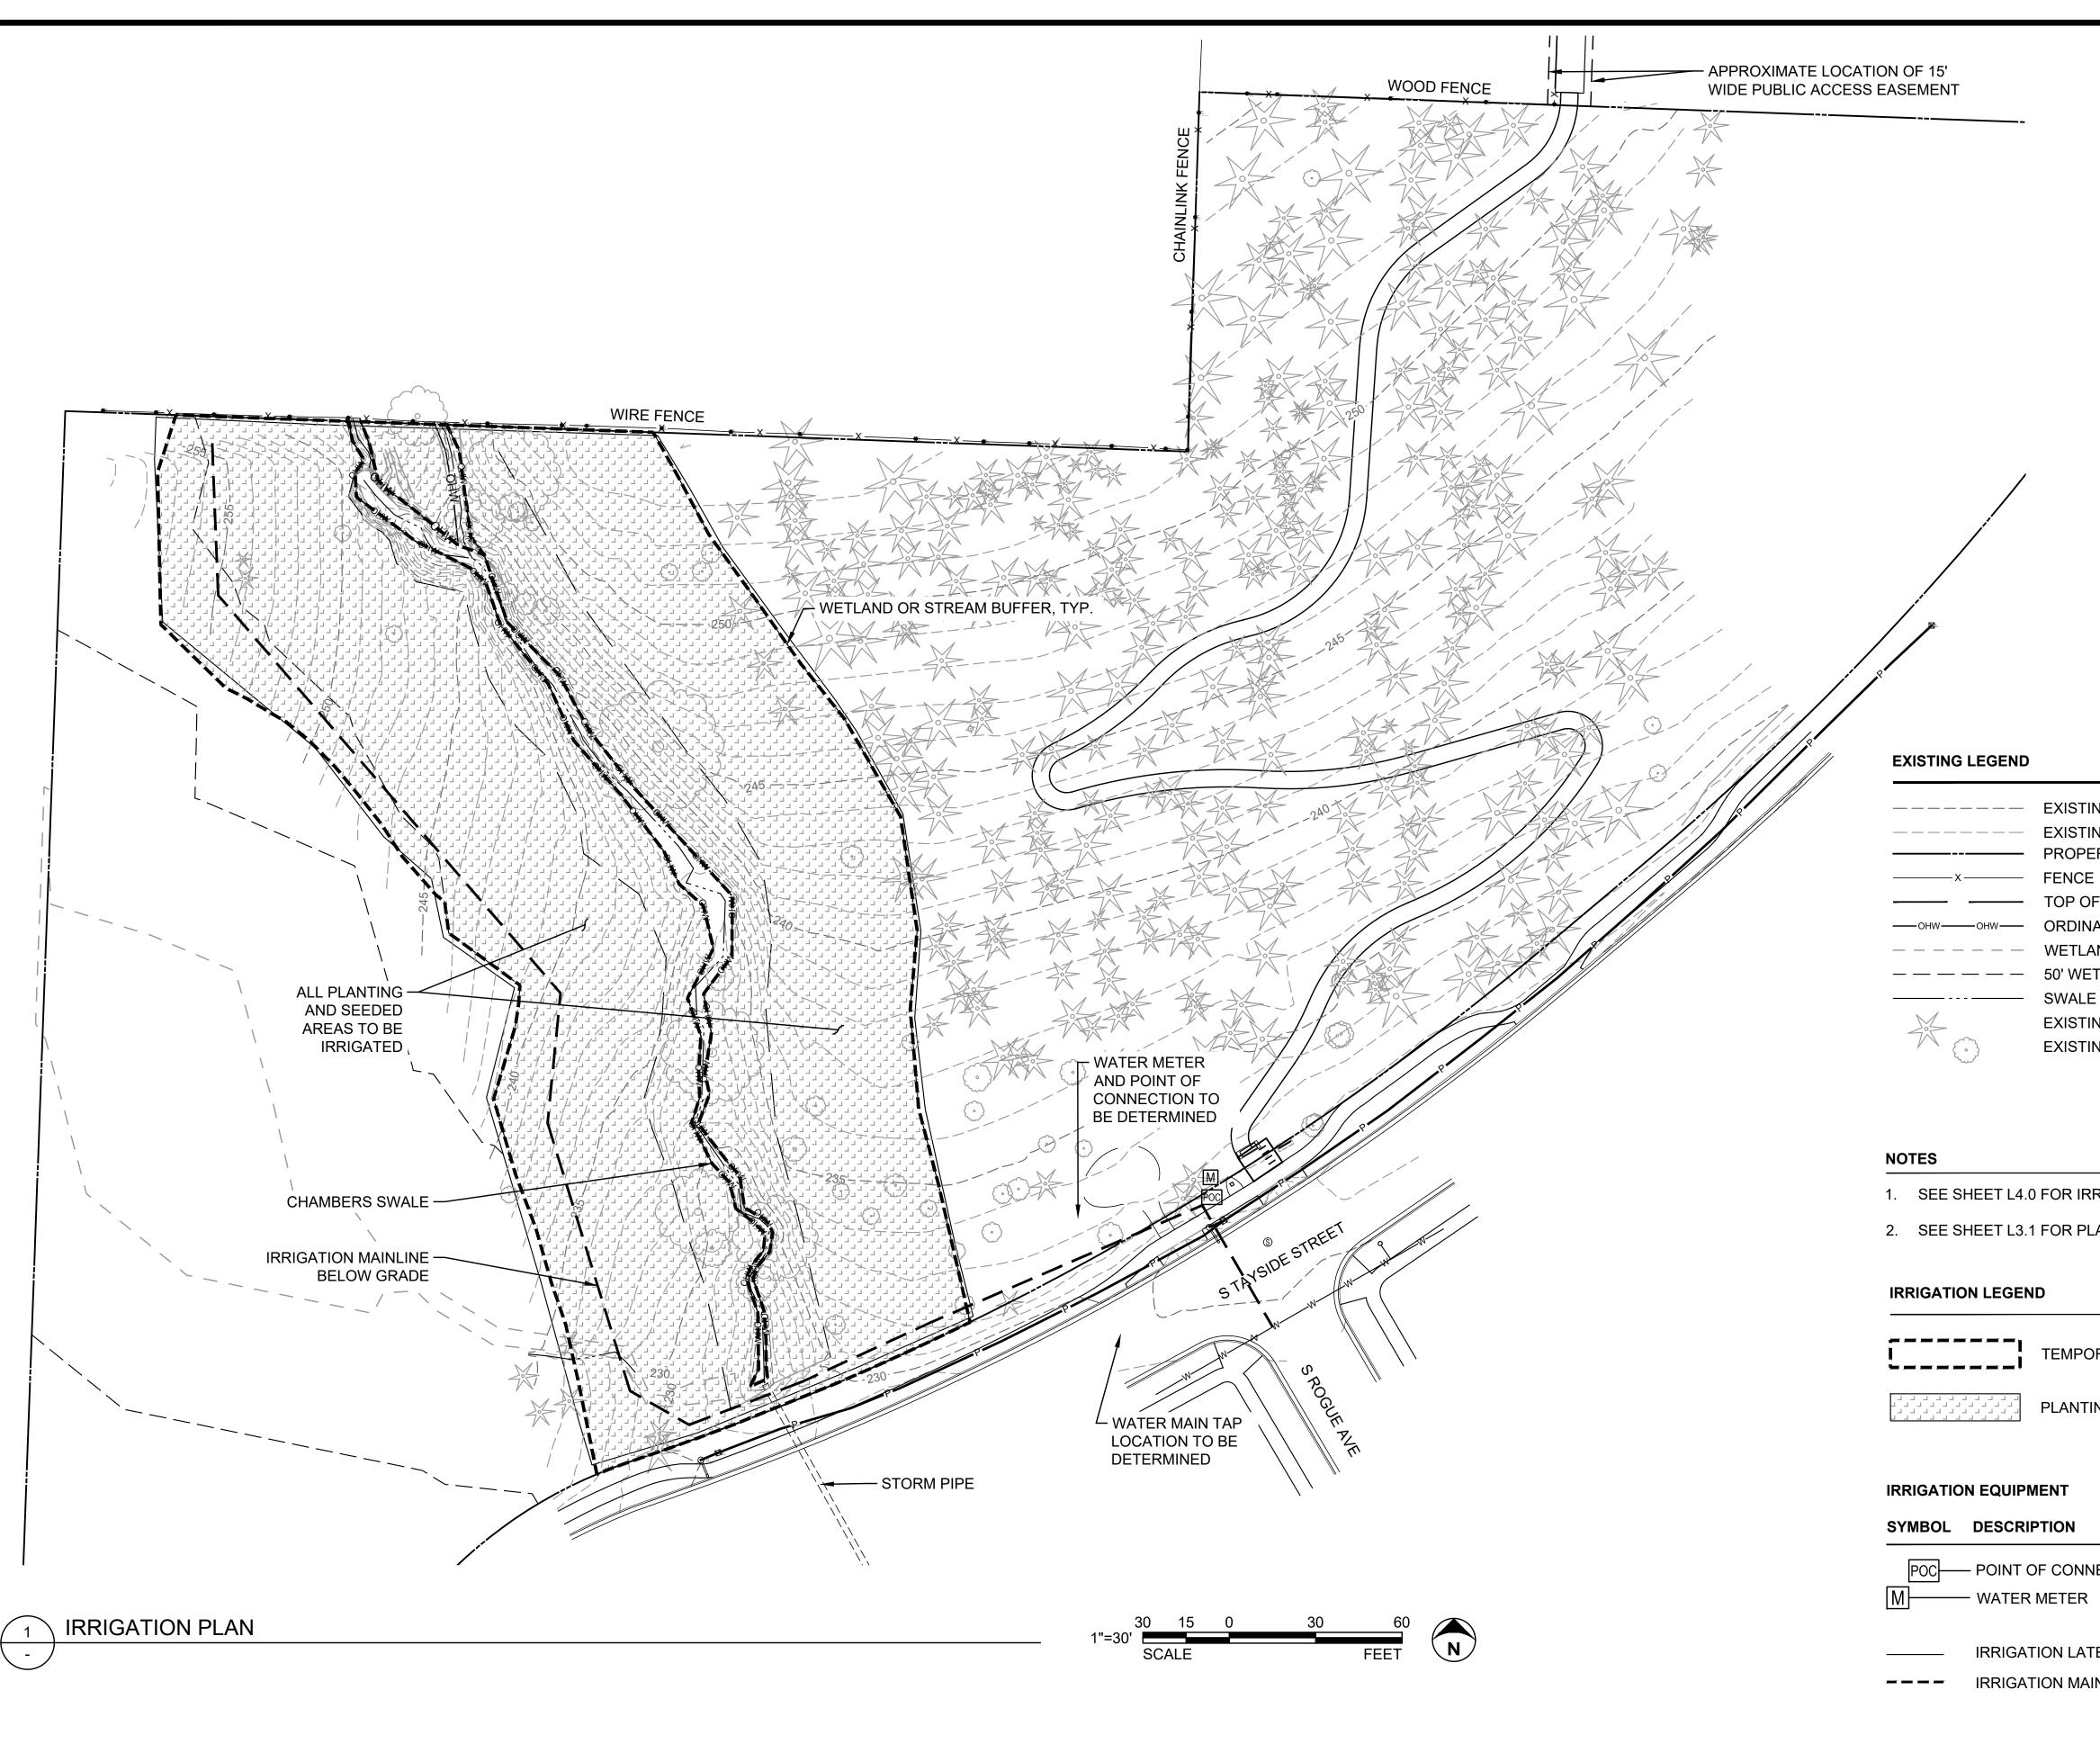
IRRIGATION NOTES

1. 1. IRRIGATION SYSTEM TO BE DESIGN BUILD BY CONTRACTOR.

- 2. CONTRACTOR TO SUBMIT IRRIGATION SYSTEM PLAN FOR WRITTEN APPROVAL FROM OWNERS REPRESENTATIVE PRIOR TO CONSTRUCTION.
- 3. THE CONTRACTOR SHALL INSPECT THE SITE AND VERIFY CONDITIONS AND DIMENSIONS PRIOR TO CONSTRUCTION. NOTIFY OWNER'S REPRESENTATIVE IMMEDIATELY OF ANY DISCREPANCIES AFFECTING SYSTEM PERFORMANCE PRIOR TO BEGINNING WORK.
- 4. INSTALL IRRIGATION SYSTEM IN ACCORDANCE WITH ALL APPLICABLE CODES AND ORDINANCES.
- 5. IRRIGATION LINES SHOWN WITHIN PAVED AREAS ARE FOR GRAPHIC CLARITY ONLY. IRRIGATION HEADS AND PIPES ARE TO BE PLACED WITHIN LANDSCAPED AREAS WITH THEIR LOCATIONS MODIFIED AS REQUIRED TO AVOID PLANT MATERIALS, UTILITIES, AND OTHER OBSTRUCTIONS. PLACE LINES IN COMMON TRENCHES WHERE POSSIBLE.
- 6. COORDINATE ALL IRRIGATION WORK WITH OTHER TRADES INVOLVED. COORDINATE IRRIGATION P.O.C. AND LOCATION OF AUTOMATIC CONTROLLER.
- 7. ALL VALVE BOXES WILL BE PLACED IN A MANNER WHICH FACILITATES ACCESS FOR MAINTENANCE. LOCATE VALVE BOXES IN PLANTING AREAS WHEREVER POSSIBLE. SIZE BOXES TO ACCOMMODATE COMPLETE VALVE ASSEMBLY INCLUDING UNIONS.
- 8. ALL COMPONENTS OF IRRIGATION SYSTEM SHALL BE INSTALLED AND ADJUSTED TO PROVIDE ADEQUATE COVERAGE AND ELIMINATE OVERSPRAY ONTO BUILDINGS, ROADS, AND WALKWAYS. CONTRACTOR IS **RESPONSIBLE FOR PROVIDING A COMPLETE WORKING SYSTEM.**
- 9. THIS SYSTEM REQUIRES A MINIMUM STATIC PRESSURE OF XX P.S.I. AND MAXIMUM FLOW OF XX GPM. THE P.O.C.S, HEAD LAYOUTS, AND ZONES ARE BASED ON THIS DATA AND DATA SHOWN IN THE IRRIGATION SCHEDULE. NOTIFY OWNER'S REPRESENTATIVE PRIOR TO COMMENCING WORK IF ACTUAL FIELD DATA DIFFERS FROM THIS INFORMATION.
- 10. IRRIGATION LATERALS ARE SIZED AT VALVE AND CONTINUING IN DIRECTION OF FLOW. REDUCTIONS IN PIPE SIZE ARE LABELED BEGINNING DOWNSTREAM OF NEAREST FITTING. ALL LATERALS ARE MINIMUM 1" OR SAME SIZE AS UPSTREAM PIPE UNLESS OTHERWISE NOTED.
- 11. ADJUST ALL MAINLINE ALIGNMENTS TO ENSURE THEY ARE NOT IN CONFLICT WITH PROPOSED PAVING. FIELD VERIFY ALIGNMENTS AND CONNECTION POINTS.
- 12. INSTALL ALL LATERAL LINES AS CLOSE TO THE HARDSCAPE AS POSSIBLE. AVOID TRENCHING NEAR EXISTING TREES TO BE PRESERVED.
- 13. INSTALL ALL IRRIGATION PIPES IN SCHEDULE 40 PVC SLEEVES BELOW ALL PAVED SURFACES. COORDINATE PLACEMENT OF SLEEVES WITH APPLICABLE TRADES.
- 14. CONTRACTOR SHALL REFER TO ANY APPLICABLE SPECIAL PROVISIONS INCLUDED AS PART OF THESE CONTRACT DOCUMENTS.
- 15. THE CONTRACTOR SHALL PERFORM A STATIC PRESSURE TEST AT THE EXISTING BACKFLOW BEFORE THE START OF WORK AND PROVIDE A SUBMITTAL TO THE LANDSCAPE ARCHITECT STATING PRESSURE AND LOCATION WITH PHOTOGRAPH OF PRESSURE GAUGE IN SUBMITTAL.
- 16. THE CONTRACTOR IS RESPONSIBLE FOR PROVIDING ANY TEMPORARY IRRIGATION TO ESTABLISH PLANTING AS A PART OF THIS CONTRACT.
- 17. THE CONTRACTOR SHALL ADJUST IRRIGATION IN EXISTING IRRIGATED LAWN AREAS TO MAINTAIN HEAD-TO-HEAD COVERAGE.
- 18. THE CONTRACTOR SHALL CONFIRM LAYOUT AND LOCATIONS OF ALL VALVE BOXES WITH THE LANDSCAPE ARCHITECT OR CITY REPRESENTATIVE PRIOR TO INSTALLATION.
- 19. THE CONTRACTOR SHALL INSTALL BLOW OUT VALVE AFTER EACH DOUBLE CHECK VALVE AT THE END OF ALL NEWLY-INSTALLED MAINLINES. BLOW OUT VALVE SHALL BE QUICK COUPLER VALVE AS SHOWN ON THE IRRIGATION SCHEDULE, THIS SHEET.
- 20. FINAL LOCATION OF CONTROLLERS TO BE CONFIRMED IN THE FIELD BY OWNER OR OWNERS REPRESENTATIVE.

SS 200 PVC (NOT SHOWN) CH SCH 40 PVC

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RIDGE PARK
TAXLOT NUMBER:
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- EXISTING MINOR CONTOUR
 - ----- PROPERTY LINE
 - TOP OF BANK
 - ORDINARY HIGH WATER
- ---- WETLAND
- — — 50' WETLAND OR STREAM BUFFER
- ---- SWALE CENTERLINE
 - EXISTING CONIFEROUS TREE
 - EXISTING DECIDUOUS TREE

1. SEE SHEET L4.0 FOR IRRIGATION NOTES AND LEGENDS.

2. SEE SHEET L3.1 FOR PLANTING PLAN.

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TEMPORARY IRRIGATION AREA - 0.9 AC

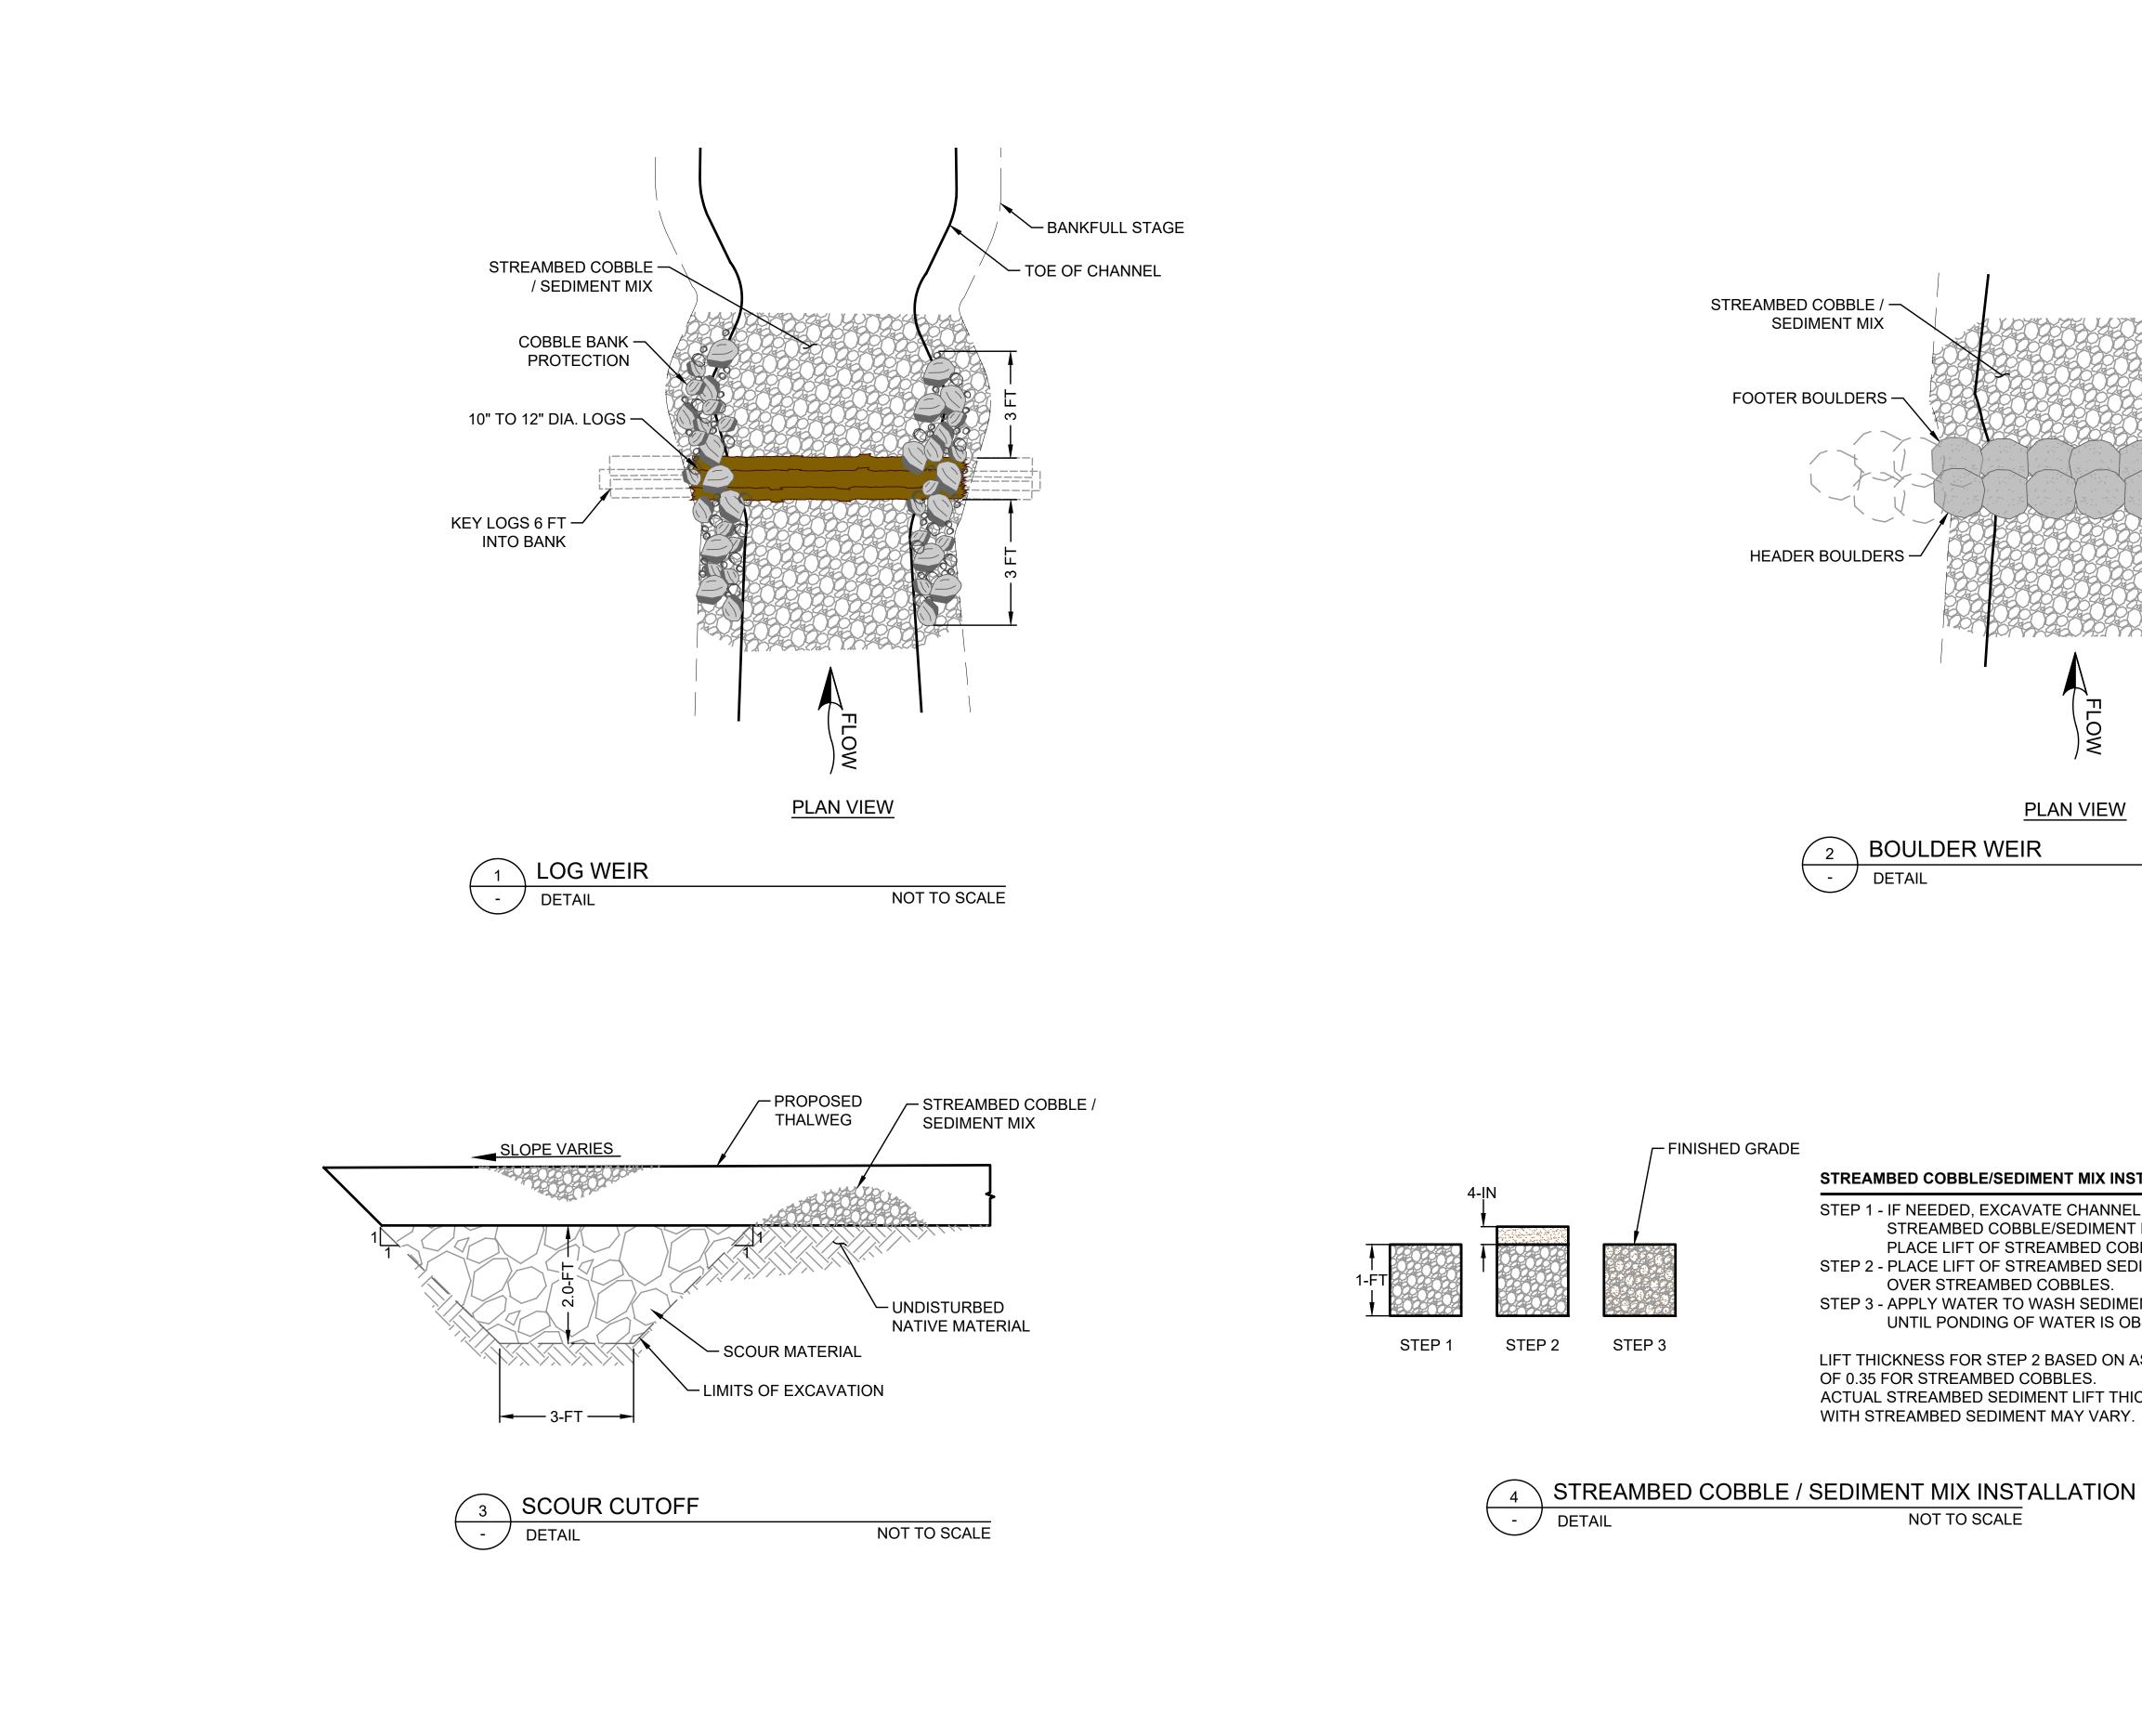
PLANTING OR SEEDING AREA

POC POINT OF CONNECTION TO WATER SUPPLY

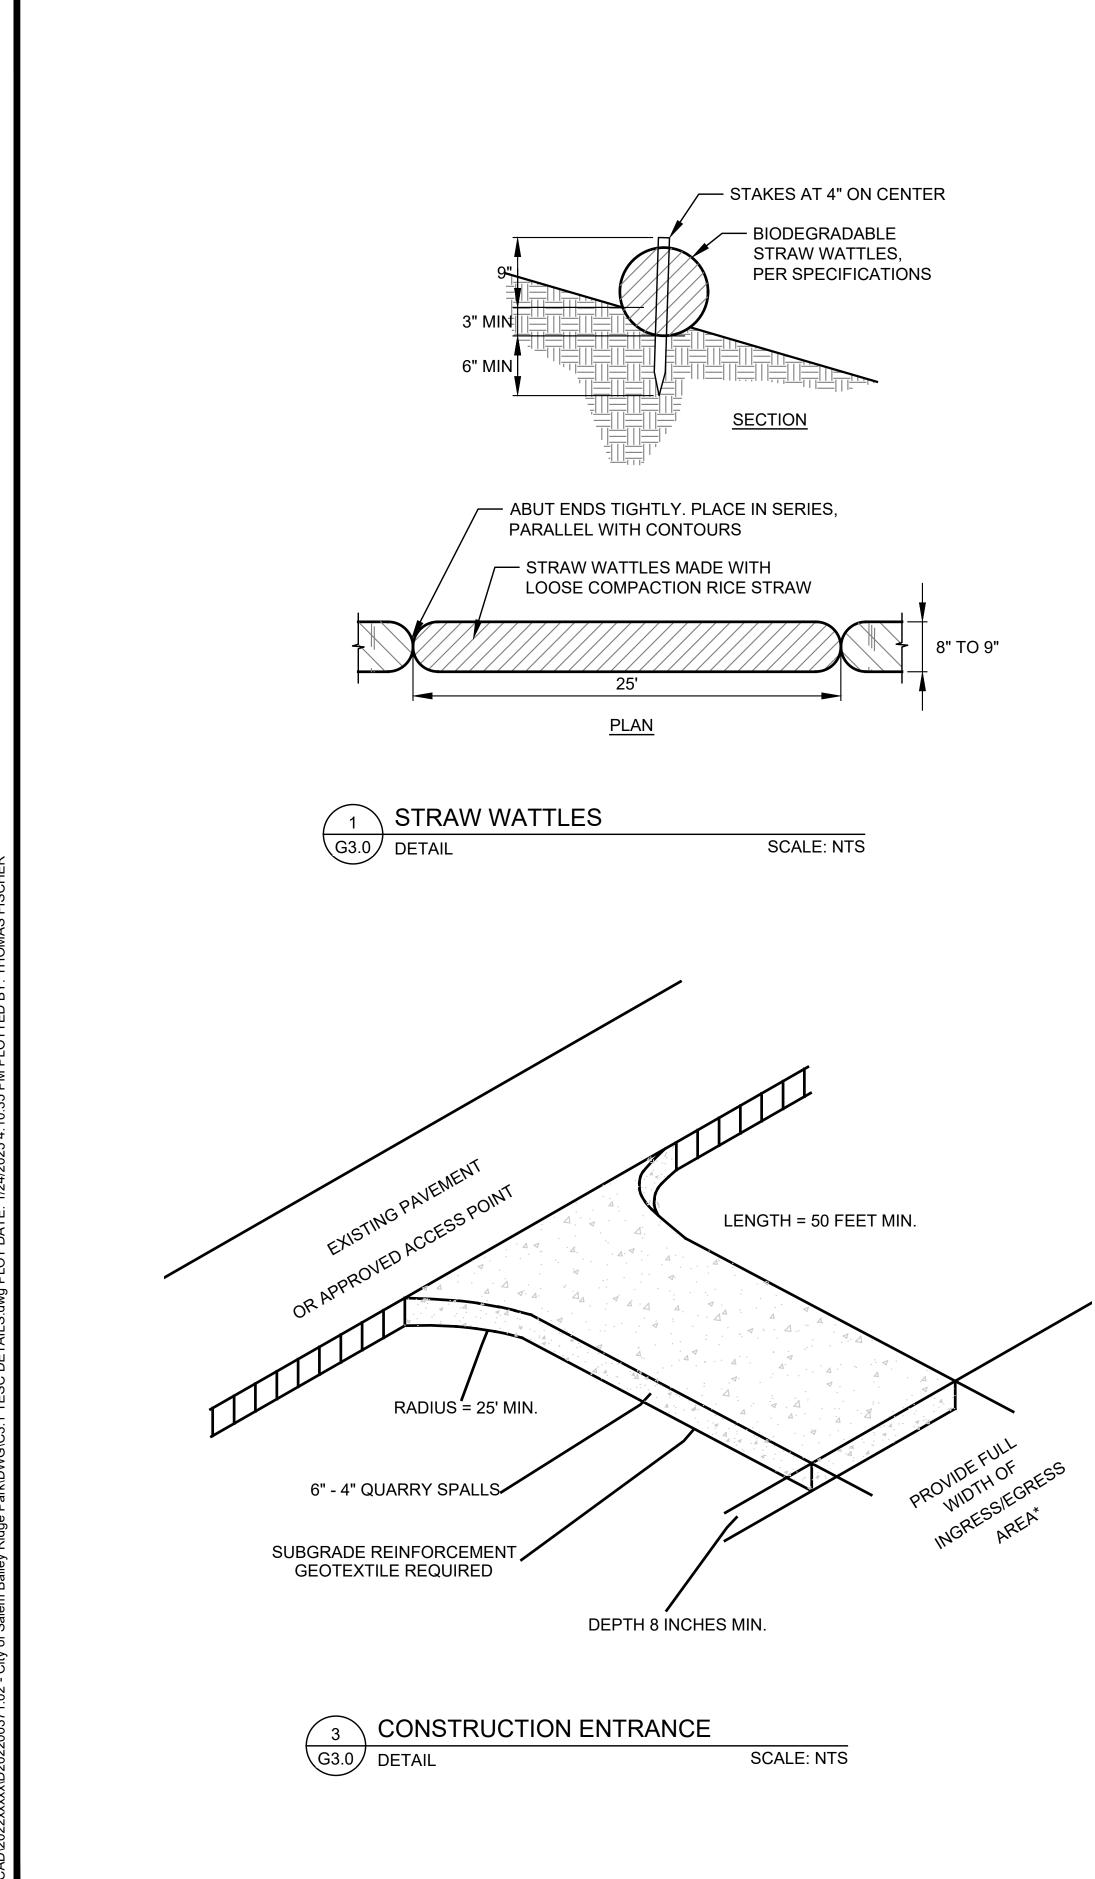
IRRIGATION LATERAL - ABOVE GRADE, CLASS 200 PVC (NOT SHOWN) IRRIGATION MAINLINE - BELOW GRADE, 2-INCH SCH 40 PVC

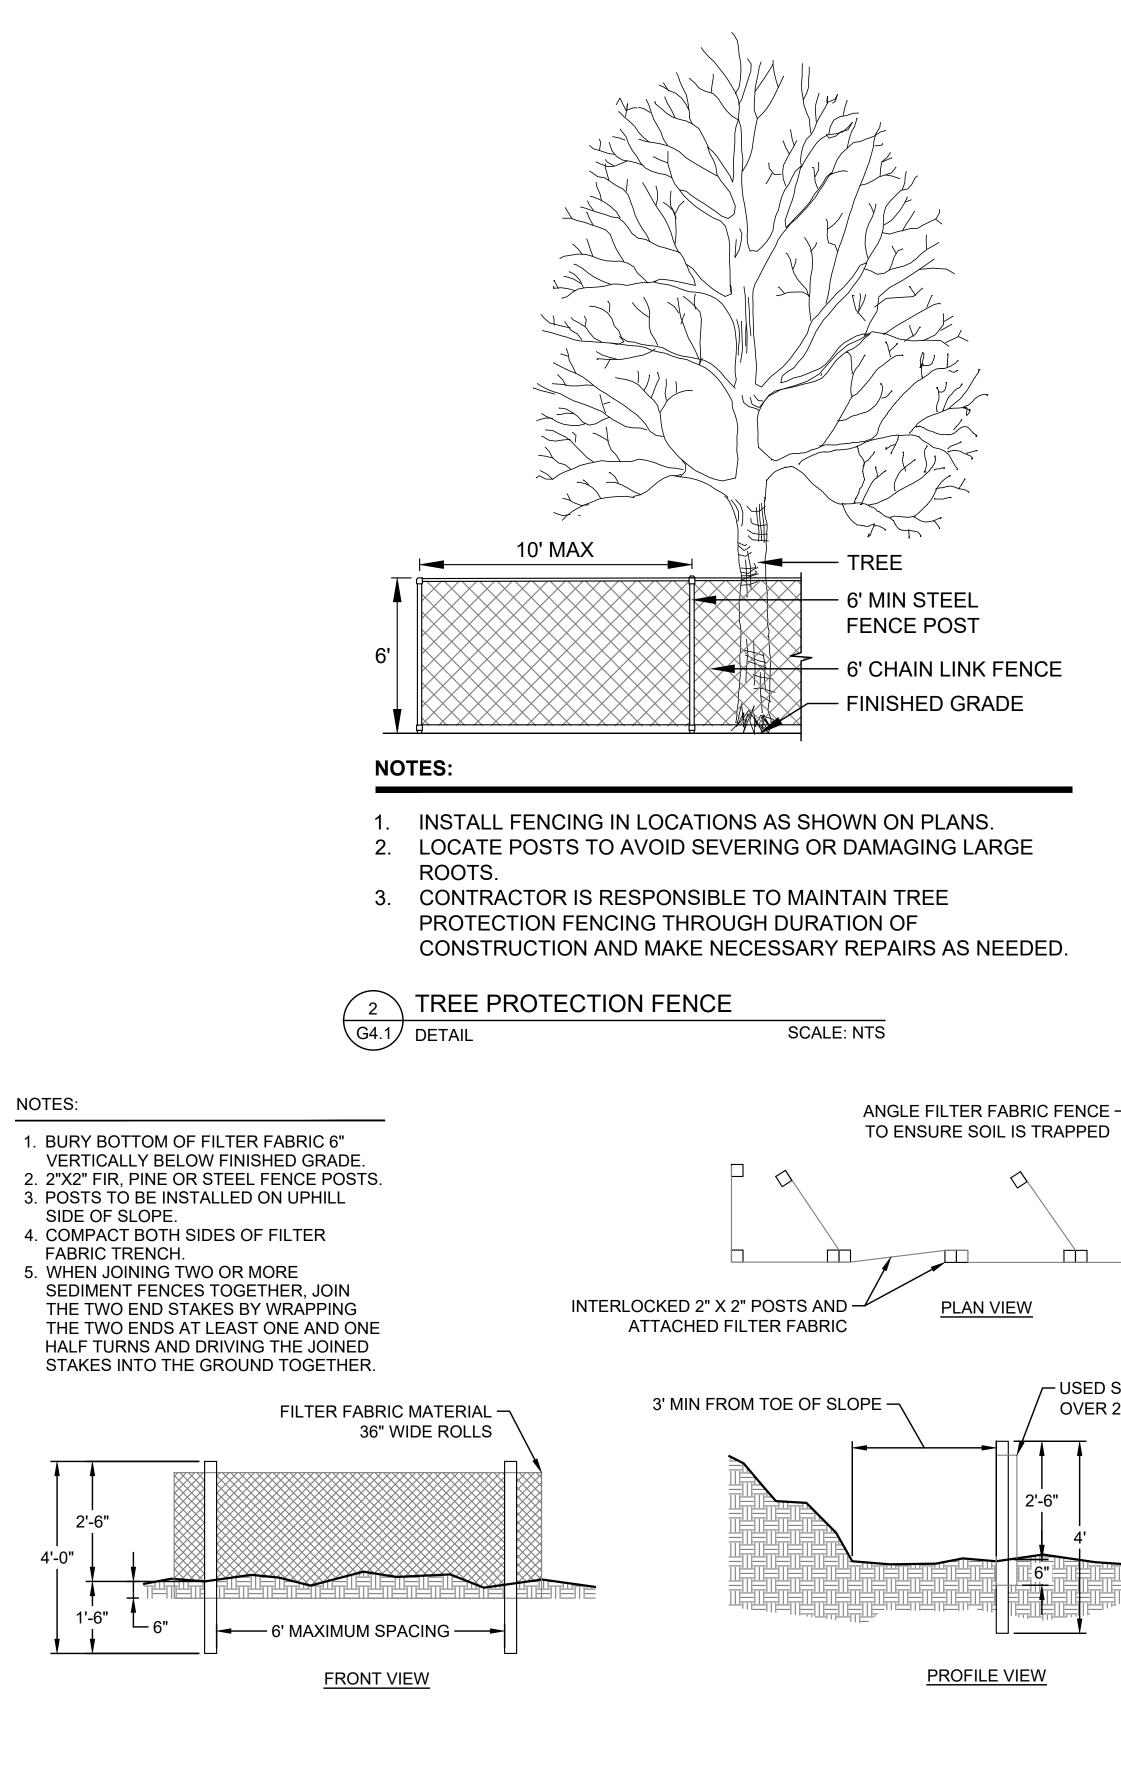
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OWNER
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BAILEY RIDGE PARK
TAXLOT NUMBER: 083W06CC13900
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	BAILEY RIDGE PARK
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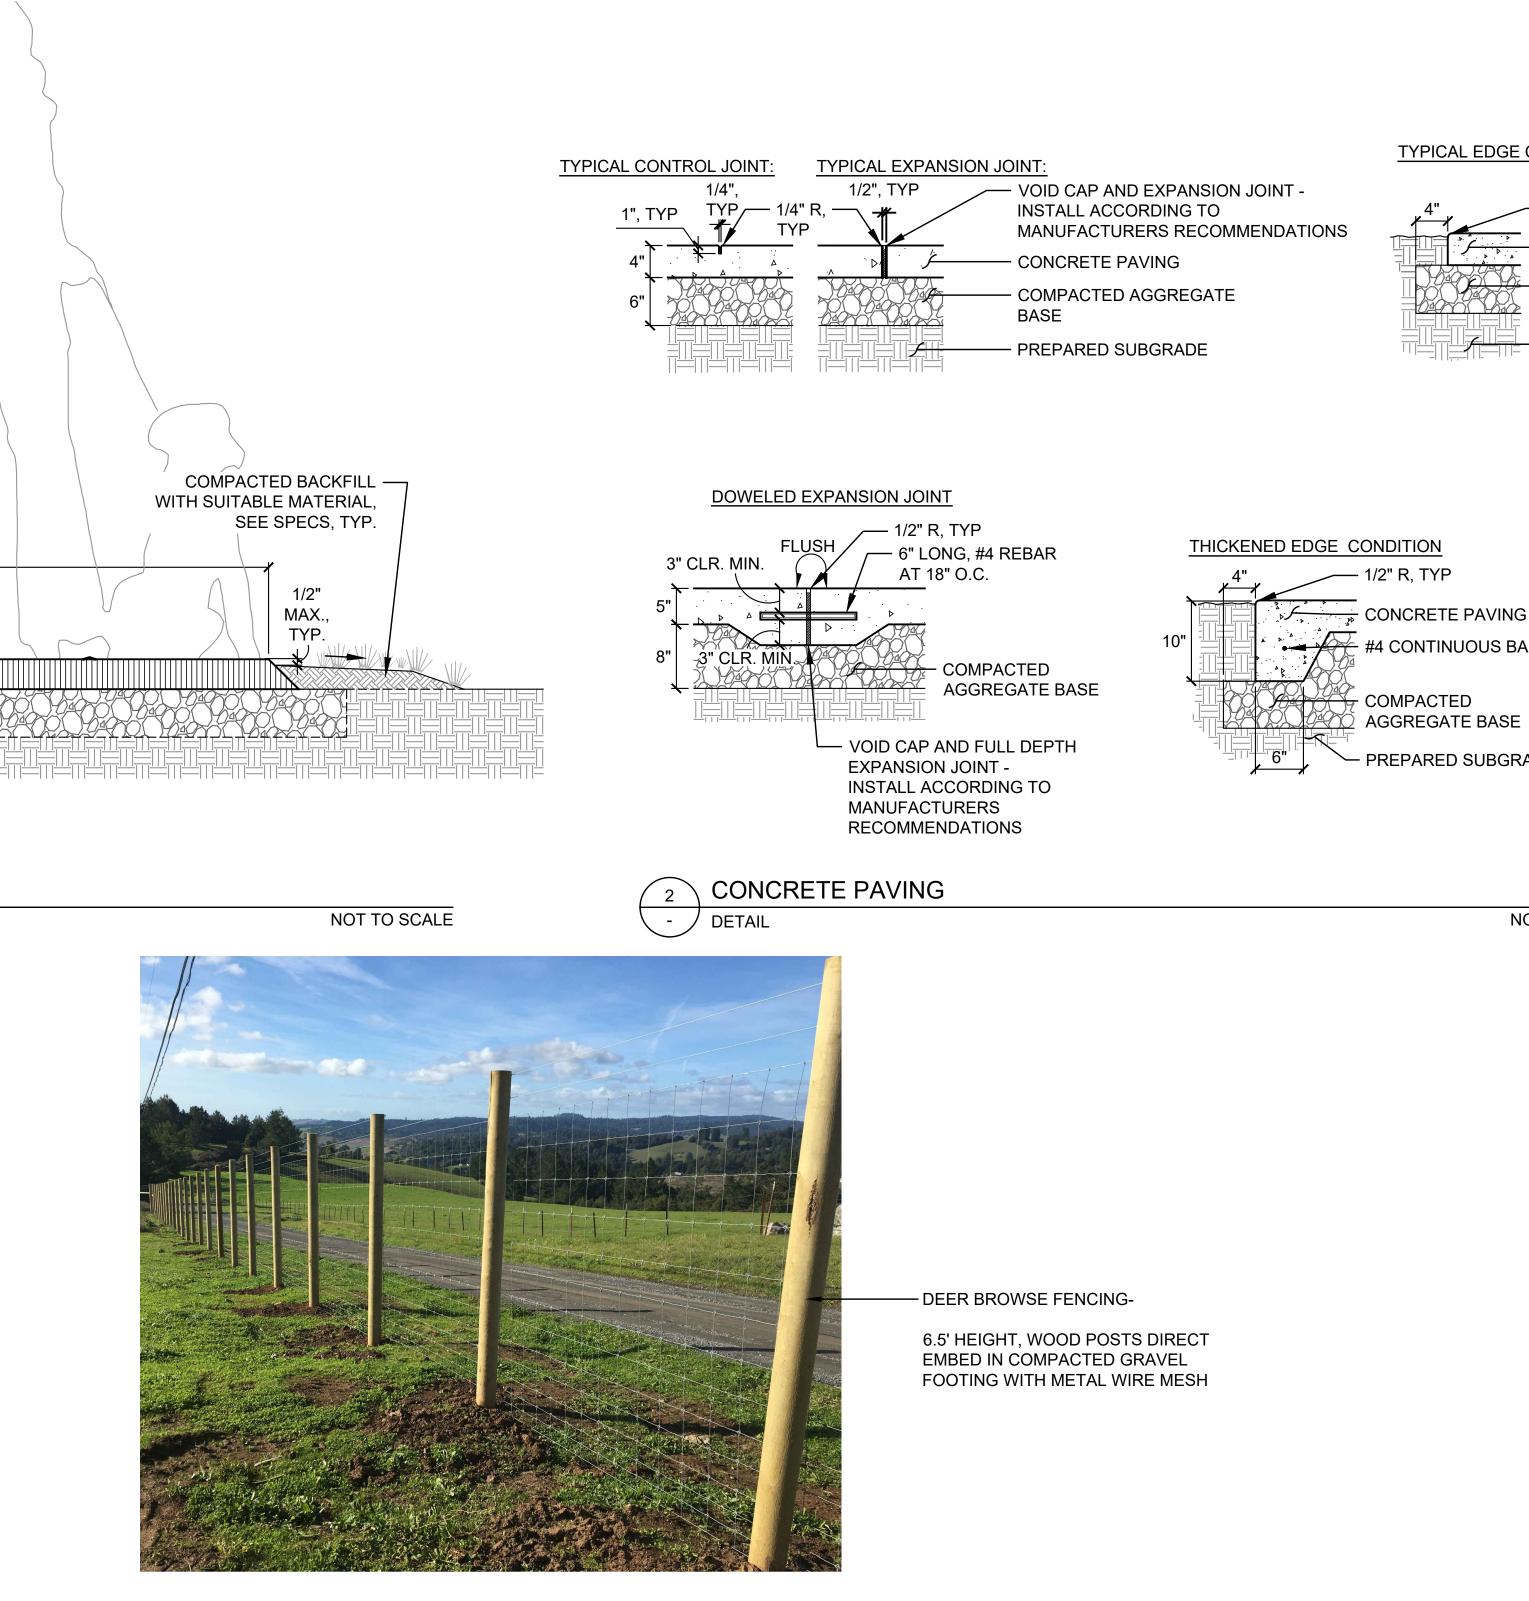




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NOTES: 1. PATHS TO BE 4.8% MAX. PREVAILING SLOPE AND 1.5% MAX. CROSS SLOPE IN ALL CONDITIONS. HAND TAMP EDGES — AT 45°, TYP. 1'-0" SHOULDER, 1.5% MAX. CROSS SLOPE, 3:1 MAX SIDE — TYP. BOTH SIDES TREAD WIDTH - 6'- ϕ " SLOPE, TYP. FINISH SURFACE — EXISTING — GRADE, TYP. 2 1/2" - 1.5% MAX CROSS SLOPE = 4 ASPHALT PAVING (SINGLE LIFT) -COMPACTED AGGREGATE BASE -PREPARED SUBGRADE ASPHALT PAVING - / DETAIL BICYCLE RACK, SEE -SPECS FOR PRODUCT EACH MOUNTING LOCATION. INSTALL ACCORDING TO MANUFACTURERS - CONCRETE PAVING FINISH RECOMMENDATIONS. SURFACE, SEE PLANS CONTRACTOR TO PROVIDE APPROPRIATE SIZE ANCHORS TO MEET INSTALLATION REQUIREMENTS SECTION 2" CLEAR 🕆 MIN., TYP. 3" CLEAR MIN., TYP. **ELEVATION BICYCLE RACK** 3 DETAIL NOT TO SCALE -

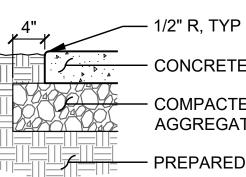


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NOT TO SCALE

TYPICAL EDGE CONDITION



- CONCRETE PAVING - COMPACTED AGGREGATE BASE PREPARED SUBGRADE

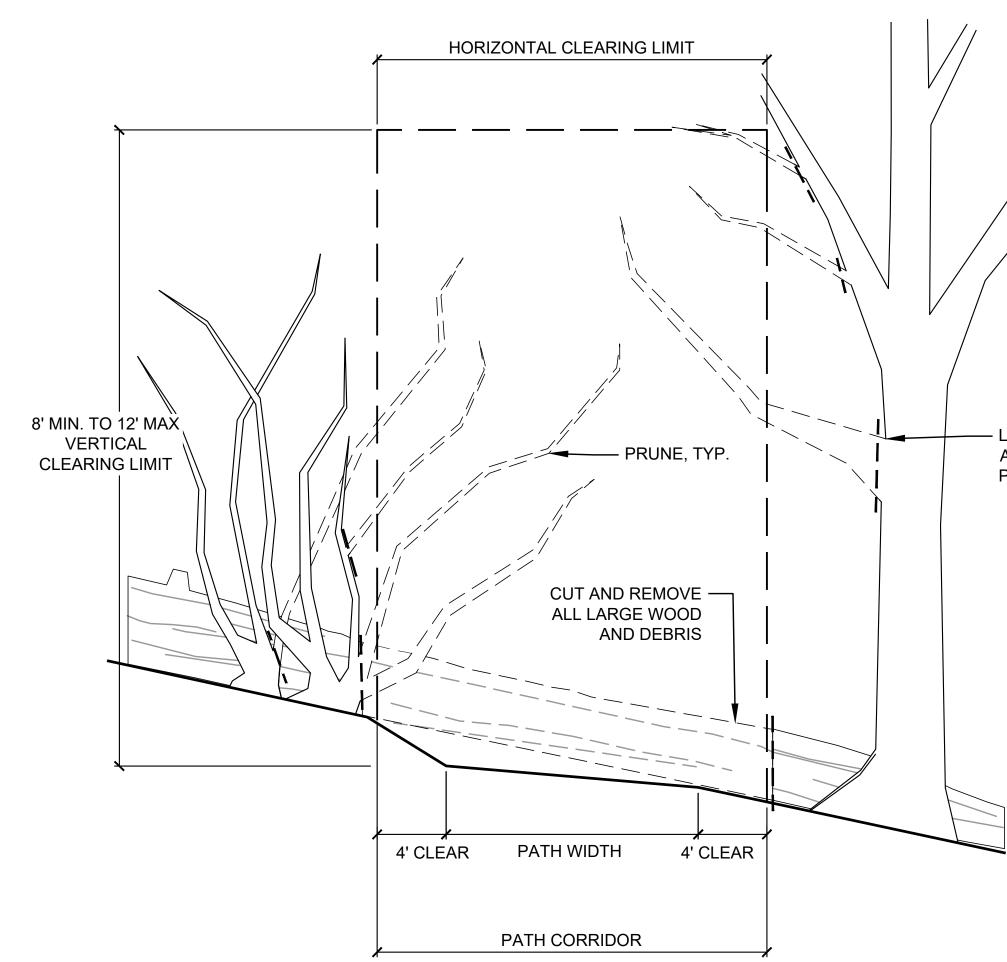
THICKENED EDGE CONDITION

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NOTES:

- 1. ALL PATH AND TRAIL CONSTRUCTION SHALL INCLUDE STANDARD CLEARING LIMITS AS FOLLOWS:
- 1.1. BRUSH AND BRANCHES 36" ABOVE GROUND LEVEL SHALL BE REMOVED TO A HEIGHT OF 8' WITHIN 36" OF THE TRAIL.
- 1.2. ALL VEGETATION BELOW 36" HEIGHT SHALL BE CUT BACK TO THE WIDTH OF THE TRAIL PLUS 3 FT FROM TRAIL EDGE, TYP.
- 1.3. FALLEN LOGS SHALL BE CUT 3 FT FROM THE EDGE OF THE TRAIL.
- 2. WITHIN THE DESIGNED PATH CORRIDOR, REMOVE ALL SURFACE ROOTS PRIOR TO COMPACTING FINISH GRADE SURFACE. ENSURE THAT THE NATIVE SOIL IS STRIPPED OF ORGANIC MATERIAL. ROOTS LESS THAN 2" DIAMETER MAY BE LEFT IN PLACE WITHIN TRAIL CORRIDORS.



- LIMBS TO BE REMOVED AT COLLAR TO AVOID PROTRUDING STUBS, TYP.

TBD

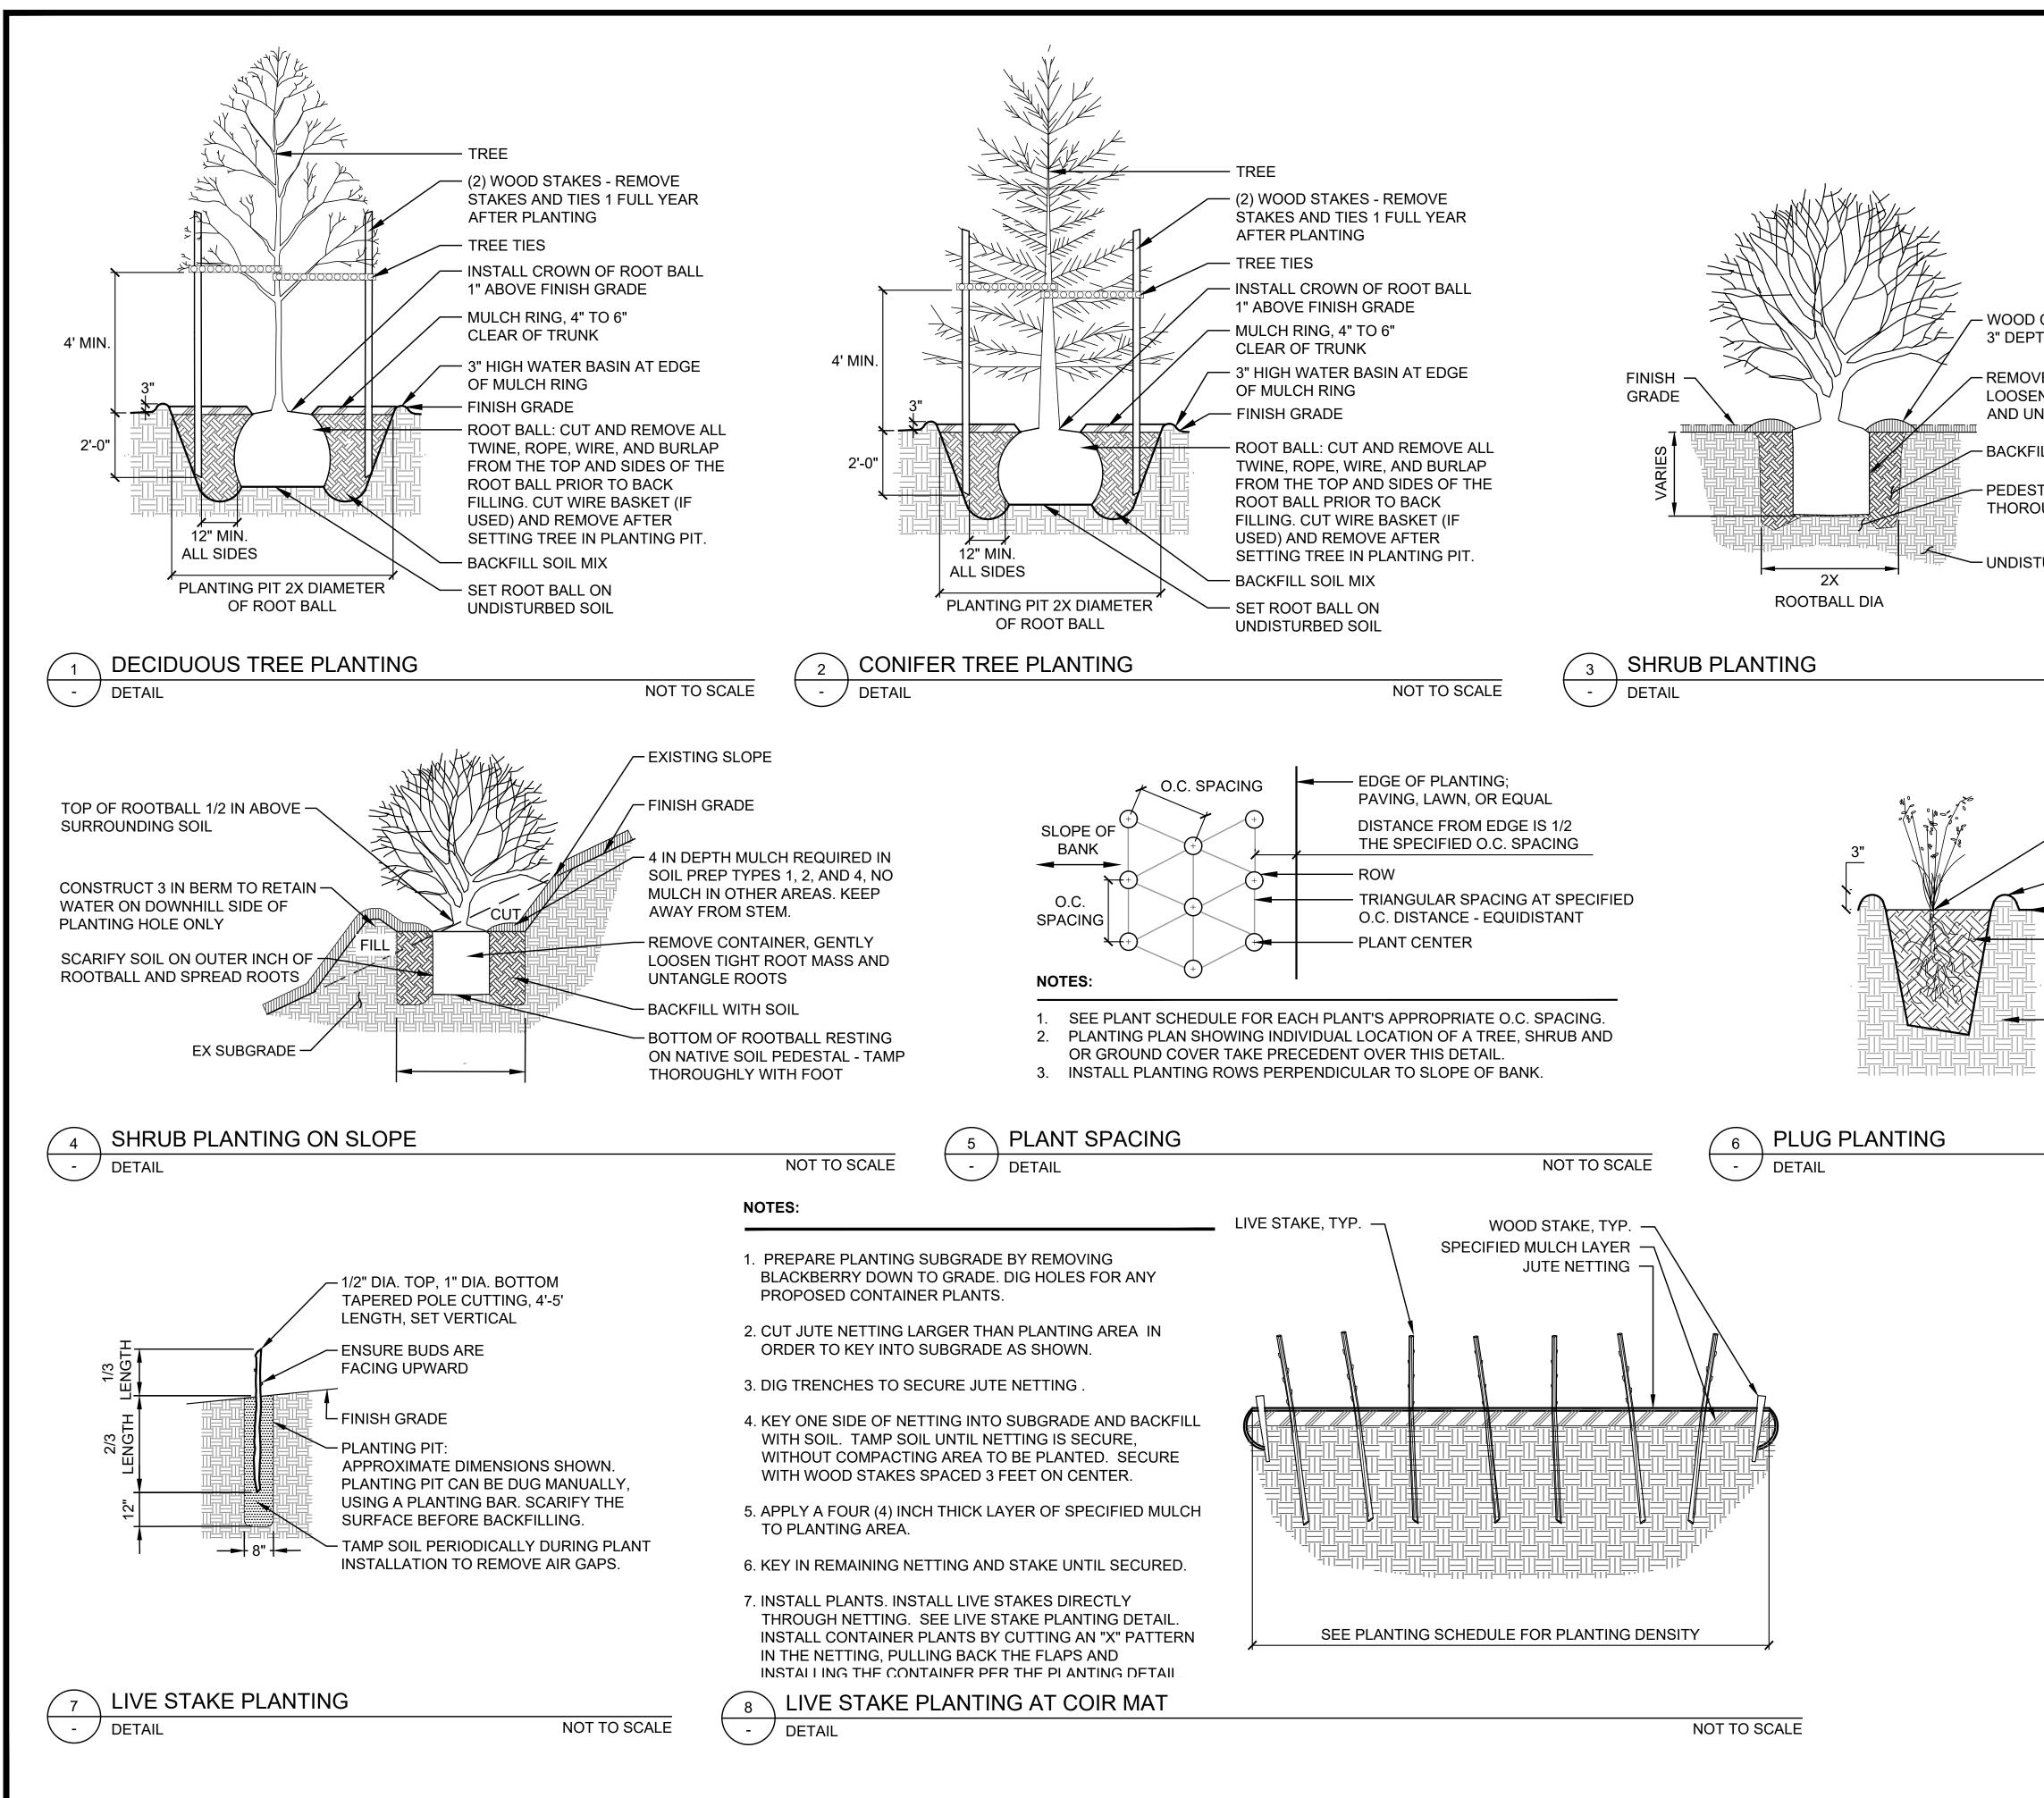
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	ESA
	819 SE MORRISON STREET, STE. 310 PORTLAND, OR 97214 OFFICE - 503.274.2010 WWW.ESASSOC.COM
	STAMP PRELIMINARY -
CHIP MULCH RING, TH, 3' DIAMETER	NOT FOR CONSTRUCTION
/E CONTAINER, GENTLY N TIGHT ROOT MASS NTANGLE ROOTS	OWNER
ILL WITH NATIVE SOIL	
TAL OF EXISTING SOIL. TAMP DUGHLY WITH FOOT ONLY	CITY OF Salem AT YOUR SERVICE
TURBED SUBGRADE	
NOT TO SCALE	
	BAILEY RIDGE PARK
PLACE ROOT COLLAR HIGHER THAN SURROUNDING GRADE	
WATERING BASIN 3" HIGH	TAXLOT NUMBER: 083W06CC13900
FINISH GRADE	Ш
PLANT WITH DIBBLE OR METAL BAR OF A DIAMETER SLIGHTLY LARGER THAN ROOT MASS OF PROPAGULE FOR DIGGING HOLE	PROJECT NAME
UNDISTURBED SOIL	REVISIONS # DATE DESCRIPTION
NOT TO SCALE	
	DRAWNTTFCHECKEDMACAPPROVED BYMAC
	PROJECT # D202200371.02
	ISSUE DATE JANUARY 2025 SCALE IS AS SHOWN WHEN PLOTTED TO FULL SIZE (22"x34")
	PHASE 30% CONSTRUCTION DOCUMENTATION
	SHEET TITLE
	PLANTING DETAILS
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	SHEET 20 OF 20