July 26, 2024



Bryce Bishop, Senior Planner City of Salem Community Development Planning Division 555 Liberty Street SE, Room 305 Salem, OR 97301

RE: 1105 Front Street NE – The Cannery (Reference No. 24-106451-PLN) Completeness Response

Mr. Bishop,

Please accept this letter and the accompanying materials as Applicant's response to the City's July 19, 2024, second review comments letter regarding application 24-106451-PLN (Attachment A). We believe the materials provided here fully respond to the items outlined in the City's letter and establish the necessary basis to deem the application complete. We look forward to continuing to work with City staff on any issues, as necessary, during the review and approval process.

Our responses to the incompleteness items are as follows:

Completeness Items

1. <u>Approved Subdivision Name</u>. A copy of the required Marion County Subdivision/Condominium Name Request Form was submitted but the form does not include the approval of the Marion County Surveyor. A copy of the completed form with Marion County Surveyor's approval is needed.

Response: A copy

A copy of the approved Marion County Subdivision/Condominium Name Request Form is included as Attachment B.

2. Additional Comments on Plans.

<u>Preliminary Site Plan</u>

Removed portion of Building 3

Response:

The Preliminary Site Plan has been revised to reflect the removed portion of Building 3 as shown in Attachment C. This item is complete.

Driveway entrances to parking garages

Response:

The driveway entrances have been revised on the Preliminary Site Plan as shown in Attachment C. This item is complete.

Summary tables

Response:

The summary tables on the Preliminary Site Plan have been revised as shown in Attachment C. This item is complete.

Please note Staff's comment regarding the additional two bicycle parking spaces required to accommodate the dwelling unit increase is not applicable and no change has been made. As shown on the Preliminary Site Plan summary tables, 421 bicycle parking spaces are required, and 439 bicycle parking spaces are provided. Per SRC Table 806-9, up to 100 percent of the minimum required bicycle parking spaces are *allowed* to be long-term, they

are not required to be long-term. The surplus in bicycle parking spaces in front of Buildings 1, 2, and 3 provides the additional 2 spaces required for the dwelling unit increase.

<u>Landscape Land Use Diagram and Planting Schedule Level 1</u>

Tree canopy calculations

Response:

A revised Landscape Land Use Diagram is provided in Attachment D. Tree planning islands have been revised to include at least three trees and to meet soil requirements. The parking lot tree canopy coverage is now 42 percent of the total parking area, exceeding the required 40 percent canopy coverage. This item is met.

Tree species

Response:

A revised Planting Schedule is provided in Attachment D. The trees identified as not being within the approved trees for planting in parking lots to achieve required tree canopy coverage have been replaced with trees specified in SRC Table 806-7. This item is met.

Please note that previous application materials indicated that all landscaping will be comprised of native vegetation. Unfortunately, few of the trees specified in SRC Table 806-7 are native species. Applicant's Landscape Architect identified one tree which could be replaced with a native tree; however, there are no suitable options for the other two trees. Although they are not native, the tree species selected have close relatives which are native.

<u>Preliminary Building Elevations and Floor Plans</u>

Compact vehicle parking stall width abutting wall or post

Response:

Vehicle parking spaces within the parking garages in Buildings 1, 2, and 3 have been revised to meet parking space dimensions as shown on the revised Preliminary Building Elevations and Floor Plans in Attachment E. This item is met.

Canopy and balcony projections

Response:

Planned property lines have been modified such that no canopies, balconies, or living space project across a property line as detailed on the revised Preliminary Building Elevations and Floor Plans in Attachment E. The 6th floor living space that projected into the Front Street NE right-of-way has been modified. This item is met.

Bicycle parking spaces

Response:

The bicycle parking spaces have been revised as requested. Refer to the revised Preliminary Building Elevations and Floor Plans in Attachment E. This item is met.

Development Services Comments

1. <u>Willamette Greenway Permit Submittal Requirements</u>. As identified in the Supplemental Completeness Letter dated April 22, 2024, a Class 2 Willamette Greenway Permit is required and

the applicant has not submitted the required items for the Willamette Greenway Permit. Please provide the following additional information:

SRC 600.015(d)(5): A report by a certified engineering geologist or geotechnical engineer demonstrating that the standards specified in SRC 600.025(a)(2) have been met.

• The applicants geotechnical report submitted does not specifically address SRC 600.025(a)(2). Please modify the report or provide a memorandum addressing the development standard.

Response: A memorandum from Applicant's geotechnical engineer addressing SRC 600.025(a)(2) is included as Attachment F. This item is complete.

SRC 600.015(d)(6): A report by a registered professional engineer detailing the hydraulic and flood carrying capacity of the river.

 The applicant's Engineer shall submit a memorandum describing the minimum impact to the flood capacity of the river in order to meet this submittal requirement in lieu of a hydraulic analysis.

Response: A flood capacity memorandum from Applicant's engineer is included as Attachment G. This item is complete.

Items of Concern

- 1. <u>Stormwater Management Design Exceptions</u>. The applicant has met their minimum submittal requirement relating to stormwater management; however, the proposal includes an intention to apply for Design Exceptions for water quality facility depth. The applicant is advised that if the Design Exceptions(s) are not approved, modifications to the site plan may be required.
- 2. <u>Street Tree Plan.</u> Phase 1 of the proposed development has approximately 900-feet of frontage along Front Street NE and includes three (3) street trees on the landscaping plan, one of which conflicts with a fire hydrant. The applicant is advised that additional street trees along Front Street NE are required. The applicant should explore ways to accommodate additional trees along the frontage. The applicant should explore the use of tree wells along the property frontage. Please review the standards listed in PWDS 6.34(e)(4).
- 3. <u>Alternative Street Standard.</u> Front Street NE requires an Alternative Street Standard to allow a modified cross section. The final Front Street improvements will be subject to Railroad requirements after the Railroad Diagnostic Review scheduled for July 16, 2024. Final Front Street improvement requirements will be established in the written railroad diagnostic provided after the on-site meeting.
- 4. <u>Public Utility Easements.</u> SRC 803.035(n) requires a 10-foot public utility easement along all street frontages to accommodate Franchise Utility Companies. It appears the applicant is not proposing any PUEs along Front Street NE. The applicant is advised to submit an alternative PUE plan that can be included in the request for comments to the Utilities providers. If a PUE is requested by a franchise utility company, it may be a condition of approval, which would require modifications to the building layout.
- 5. <u>Driveway Approach Standard Detail.</u> The applicant's plans show the driveway approaches to Front Street NE utilizing PWDS Standard Plan No. 315 where PWDS Standard Plan No. 302 is

required. Conditions of approval for the Driveway Approach Permits will require the driveway approaches be constructed to the appropriate PWDS standard plan.

Response: Applicant acknowledges the items of concern and will continue to coordinate with City staff and other necessary stakeholders.

Additional Information from Applicant

Applicant's traffic engineer prepared an addendum to the Traffic Impact Analysis (TIA) providing an updated trip generation with the adjusted unit count (Attachment H). The memorandum concludes that the change in the number of units from 371 to 382 will not affect the conclusions in the TIA.

Thank you for reviewing our application. We believe these additional clarifications and plan revisions completely respond to the items included in your July 19, 2024, second review comments letter. Please contact me if you require any additional information.

Sincerely,

AKS ENGINEERING & FORESTRY, LLC

Grace Wolff

3700 River Road N, Suite 1

Keizer, OR 97303

(503) 400-6028 | wolffg@aks-eng.com

Attachments:

- A. Land Use Application Completeness Review (July 19, 2024)
- B. Marion County Subdivision Name Approval
- C. Revised Preliminary Land Use Plans
- D. Revised Preliminary Landscape Plans
- E. Revised Preliminary Building Elevations and Floor Plans
- F. Geotechnical Engineering Services Memorandum
- G. Flood Carrying Capacity Memorandum
- H. Traffic Impact Analysis Memorandum

Attachment A: Land Use Application Completeness Review (July 19, 2024)



Community Planning and Development

555 Liberty St. SE / Room 305 • Salem, OR 97301-3503 • 503-588-6173 • www.cityofsalem.net

July 19, 2024

LAND USE APPLICATION COMPLETENESS REVIEW

Second Review Comments

Subject Property: 1105 Front Street NE

Reference Nos.: 24-106451-PLN (Class 3 Site Plan Review, Tentative Subdivision Plan,

Class 1 & 2 Adjustment, Class 2 Driveway Approach Permit)

Applicant: Trent Michels **Phone:**

The Future of Neighborhood Development, LLC **E-Mail:** trent.michels@gmail.com

E-Mail: wolffg@aks-eng.com

Agent: Grace Wolff Phone: 503-400-6028

AKS Engineering & Forestry, LLC

3700 River Road N Keizer, OR 97303

The Planning Division has conducted its review of the revised application materials submitted for the proposed Class 3 Site Plan Review, Tentative Subdivision Plan, Class 1 and 2 Adjustment, and Class 2 Driveway Approach Permit for property located at 1105 Front Street NE. In order to deem the application complete and to continue processing the application, modifications/and or additional information is needed to address the following item(s):

Item:	Description:					
Approved Subdivision Name	approval is needed. Please see the additional staff comments included on the attached plans					
Additional Comments on Plans						
	Development Services Comments					
-	ts - The following items have been identified as required material to be provided deeming the application "complete".					
Willamette Greenway Permit Submittal	As identified in the Supplemental Completeness Letter dated April 22, 2024, a Class 2 Willamette Greenway Permit is required and the applicant has not submitted the required items for the Willamette Greenway Permit. Please provide the following additional information:					
Requirements	SRC 600.015(d)(5): A report by a certified engineering geologist or geotechnical engineer demonstrating that the standards specified in SRC 600.025(a)(2) have been met.					

Item:	Description:
	 The applicants geotechnical report submitted does not specifically address <u>SRC 600.025(a)(2)</u>. Please modify the report or provide a memorandum addressing the development standard.
	SRC 600.015(d)(6): A report by a registered professional engineer detailing the hydraulic and flood carrying capacity of the river.
	 The applicant's Engineer shall submit a memorandum describing the minimum impact to the flood capacity of the river in order to meet this submittal requirement in lieu of a hydraulic analysis.
application; however, are	of following items are not listed in the SRC as specific requirements for a complete e advisories that address areas of concern on the application. Failure to address could result in condition of approval or denial of the application(s).
Stormwater Management – Design Exceptions	The applicant has met their minimum submittal requirement relating to stormwater management; however, the proposal includes an intention to apply for Design Exceptions for water quality facility depth. The applicant is advised that if the Design Exceptions(s) are not approved, modifications to the site plan may be required.
Street Tree Plan	Phase 1 of the proposed development has approximately 900-feet of frontage along Front Street NE and includes three (3) street trees on the landscaping plan, one of which conflicts with a fire hydrant. The applicant is advised that additional street trees along Front Street NE are required. The applicant should explore ways to accommodate additional trees along the frontage. The applicant should explore the use of tree wells along the property frontage. Please review the standards listed in PWDS 6.34(e)(4).
Alternative Street Standard	Front Street NE requires an Alternative Street Standard to allow a modified cross section. The final Front Street improvements will be subject to Railroad requirements after the Railroad Diagnostic Review scheduled for July 16, 2024. Final Front Street improvement requirements will be established in the written railroad diagnostic provided after the on-site meeting.
Public Utility Easements	SRC 803.035(n) requires a 10-foot public utility easement along all street frontages to accommodate Franchise Utility Companies. It appears the applicant is not proposing any PUEs along Front Street NE. The applicant is advised to submit an alternative PUE plan that can be included in the request for comments to the Utilities providers. If a PUE is requested by a franchise utility company, it may be a condition of approval, which would require modifications to the building layout.
Driveway Approach Standard Detail	The applicant's plans show the driveway approaches to Front Street NE utilizing PWDS Standard Plan No. 315 where PWDS Standard Plan No. 302 is required. Conditions of approval for the Driveway Approach Permits will require the driveway approaches be constructed to the appropriate PWDS standard plan.

Your application, which is incomplete, will be deemed complete upon receipt of one of the following:

- 1) All of the missing information;
- 2) Some of the missing information and written notice from you (the applicant) that no other information will be provided; or

3) Written notice from you (the applicant) that none of the missing information will be provided.

You have 180 days from the date the application was first submitted to respond in one of the three ways listed above, or the application will be deemed void.


For questions regarding any of the above requirements, please feel free to contact me directly by calling (503) 540-2399 or via e-mail at bbishop@cityofsalem.net.

The Salem Revised Code may be accessed online at the following location:

https://www.cityofsalem.net/government/laws-rules/salem-revised-code

Sincerely,

Bryce Bishop Planner III

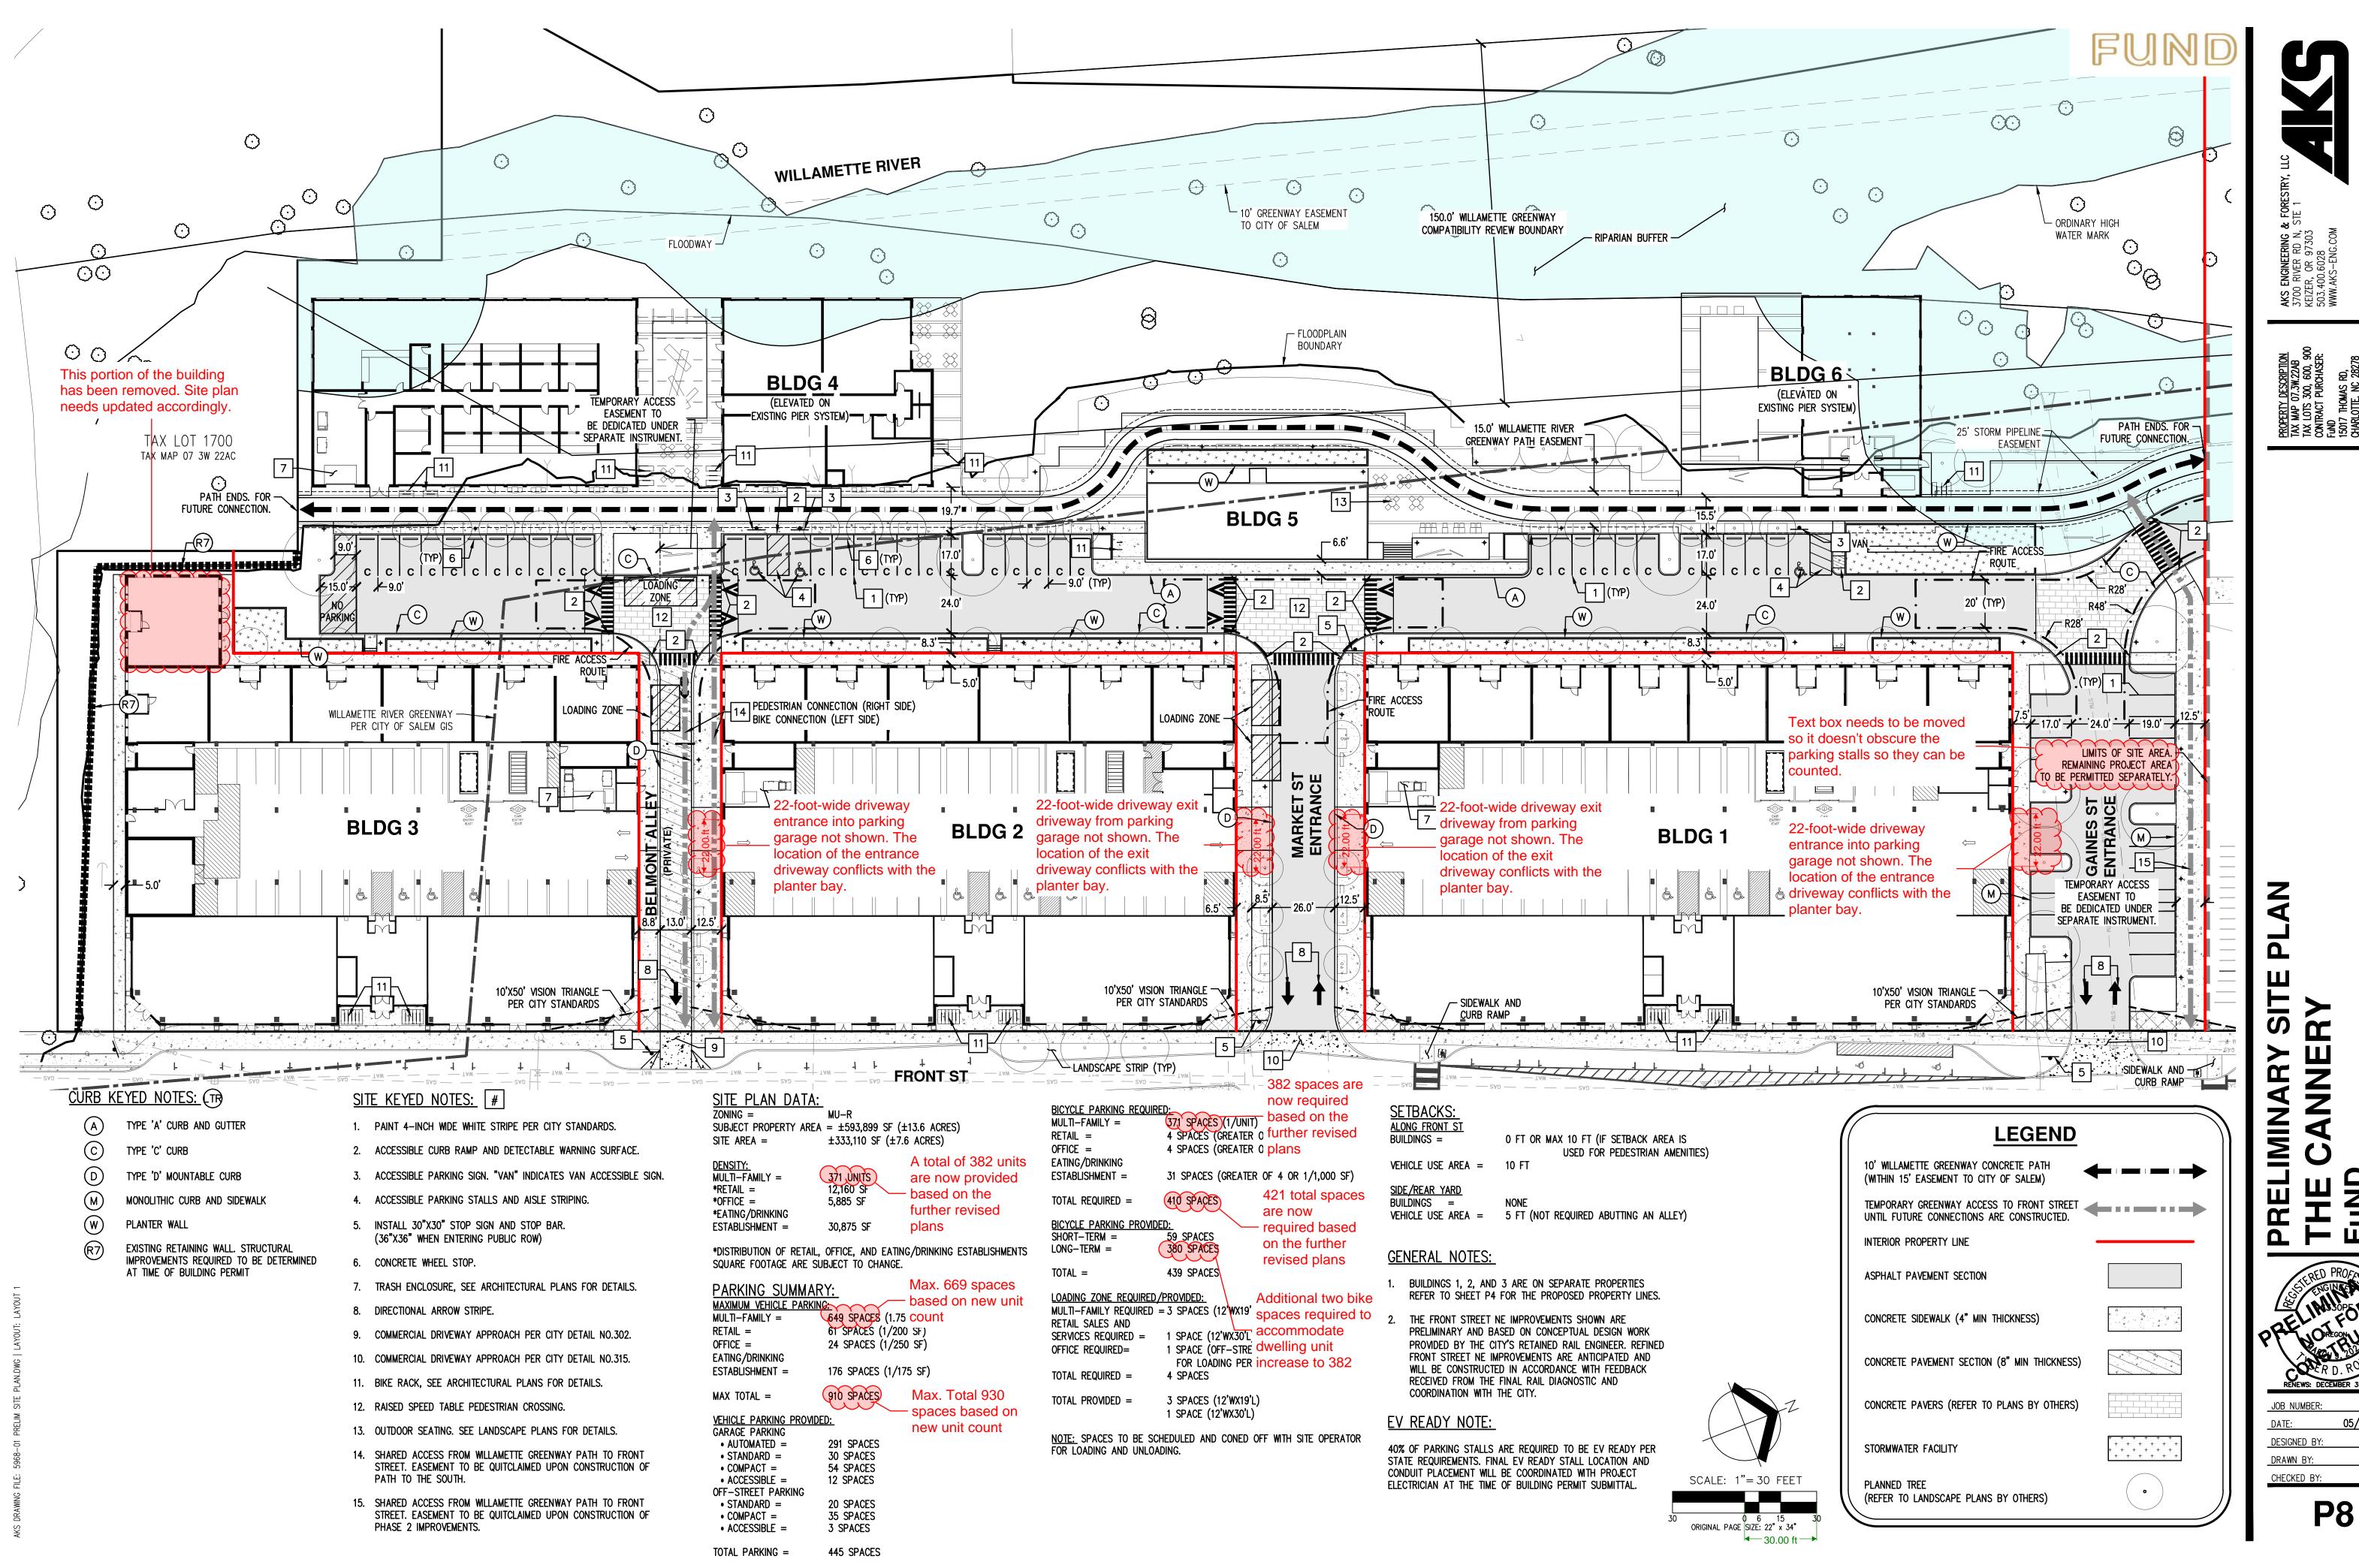

05/31/2024


P8

REVISIONS

SCALE DRAWN BY

2024.03.15 2346-SAC PROJECT NO.

SHEET

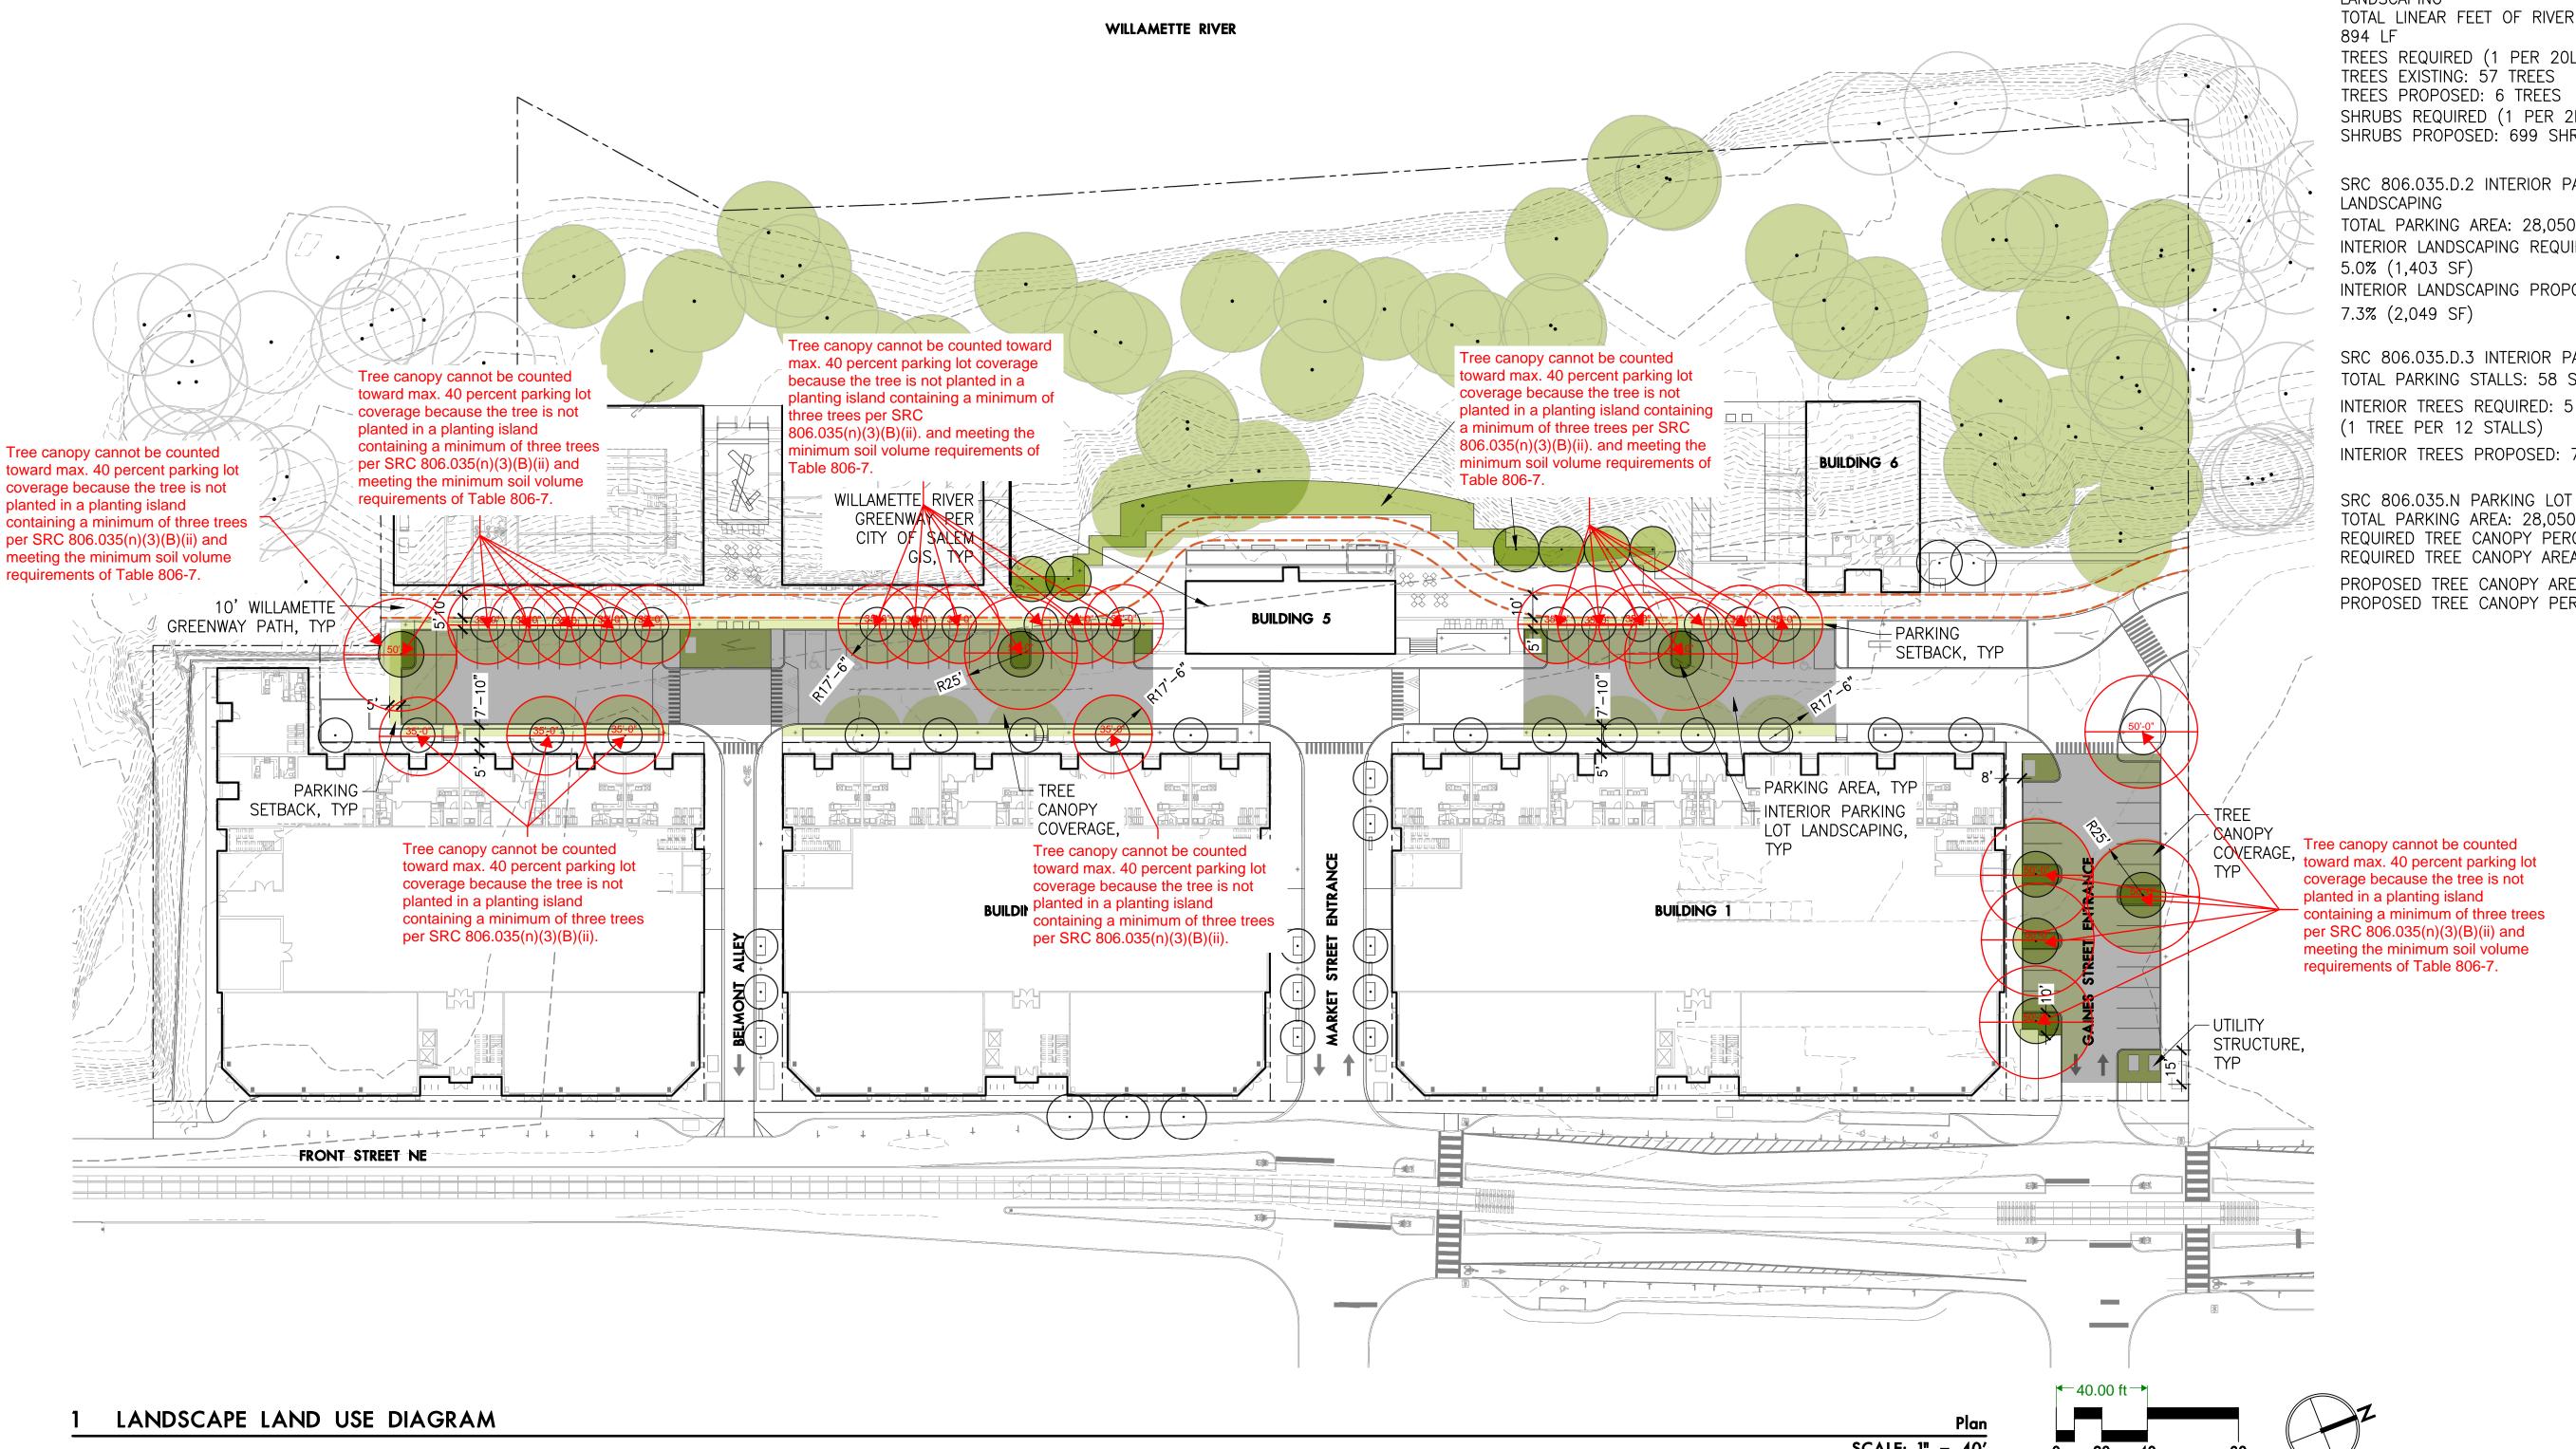

Quaking Aspen is not a species of tree identified in the table of approved trees for planting in parking lots to achieve required tree canopy coverage per SRC 806.035(n)(3)(A)(ii). An alternative species can be approved by providing evidence that the proposed species is native, drought resistant, and will provide a tree canopy area equal to that of either a large tree or small tree as specified in TAble 806-7.

California Black Oak is not a species of tree identified in the table of approved trees for planting in parking lots to achieve required tree canopy coverage per SRC 806.035(n)(3)(A)(ii). An alternative species can be approved by providing evidence that the proposed species is native, drought resistant, and will provide a tree canopy area equal to that of either a large tree or small tree as specified in TAble 806-7.

	PLANT S	CHEDULE	- ONSITE TREES					
	SYMBOL	ABBR	BOTANICAL NAME	COMMON NAME	NATIVE	SIZE/ CONDITION	SPACING	QUANTITY
		TREES						
		АМ	Acer macrophyllum	Big Leaf Maple	YES	3" CAL B&B	AS SHOWN	11
	+	AR	Alnus rubra	Red Alder	YES	3" CAL B&B (SMALL)	AS SHOWN	16
_	+	PP	Parrotia persica 'Vanessa'	Vanessa Ironwood	NO (STREET TREE)	3" CAL B&B	AS SHOWN	3
	+	PT	Populus tremuloides	Quaking Aspen	YES	3" CAL B&B (SMALL)	AS SHOWN	25
	+ +	QK	Quercus kelloggii	California Black Oak	YES	3" CAL B&B (LARGE)	AS SHOWN	8

PLANT S	CHEDULE	- ONSITE PLANTINGS							
SYMBOL	ABBR	BOTANICAL NAME	COMMON NAME	NATIVE	SIZE/ CONDITION	SPACING	QUANTITY		
	SHRUBS	5							
H	COSE	Cornus sericea 'Arctic Fire'	Arctic Fire Redosier Dogwood	YES	#5/CONT. 6'+HT (MATURE)	AS SHOWN	86		
(\star)	MARE	Mahonia repens	Creeping Oregon Grape	YES	#1/CONT.	AS SHOWN	462		
\otimes	GASH	Gaultheria shallon	Salal	YES	#1/CONT.	AS SHOWN	100		
0	VAOV	Vaccinium ovatum	Evergreen Huckleberry	YES	#5/CONT. 6+HT (MATURE)	AS SHOWN	505		
	GROUNI	GROUNDCOVER AND GRASSES							
	ARUV	Arctostaphylos uva-ursi	Kinnikinnick	YES	#1/CONT.	18" O.C.	662		
\bigcirc	DECE	Deschampsia cespitosa	Tufted Hairgrass	YES	#3/CONT.	AS SHOWN	130		
	FRCH	Fragaria chiloensis	Coast Strawberry	YES	#1/CONT.	18" O.C.	2369		
0	НЕМІ	Heuchera micrantha	Smallflowered Alumroot	YES	#1/CONT.	AS SHOWN	159		
	STORMV	WATER PLANTINGS - 5,233 SF							
	CADE	Carex densa	Dense Sedge	YES	#1/CONT.	12" O.C.			
	DECE	Deschampsia cespitosa	Tufted Hair Grass	YES	#1/CONT.	12" O.C.			
	JUPA	Juncus patens	Spreading Rush	YES	#1/CONT.	12" O.C.			

NNERY

LAND USE SUBMITTAL PLANTING SCHEDULE LEVEL 1


REVISIONS


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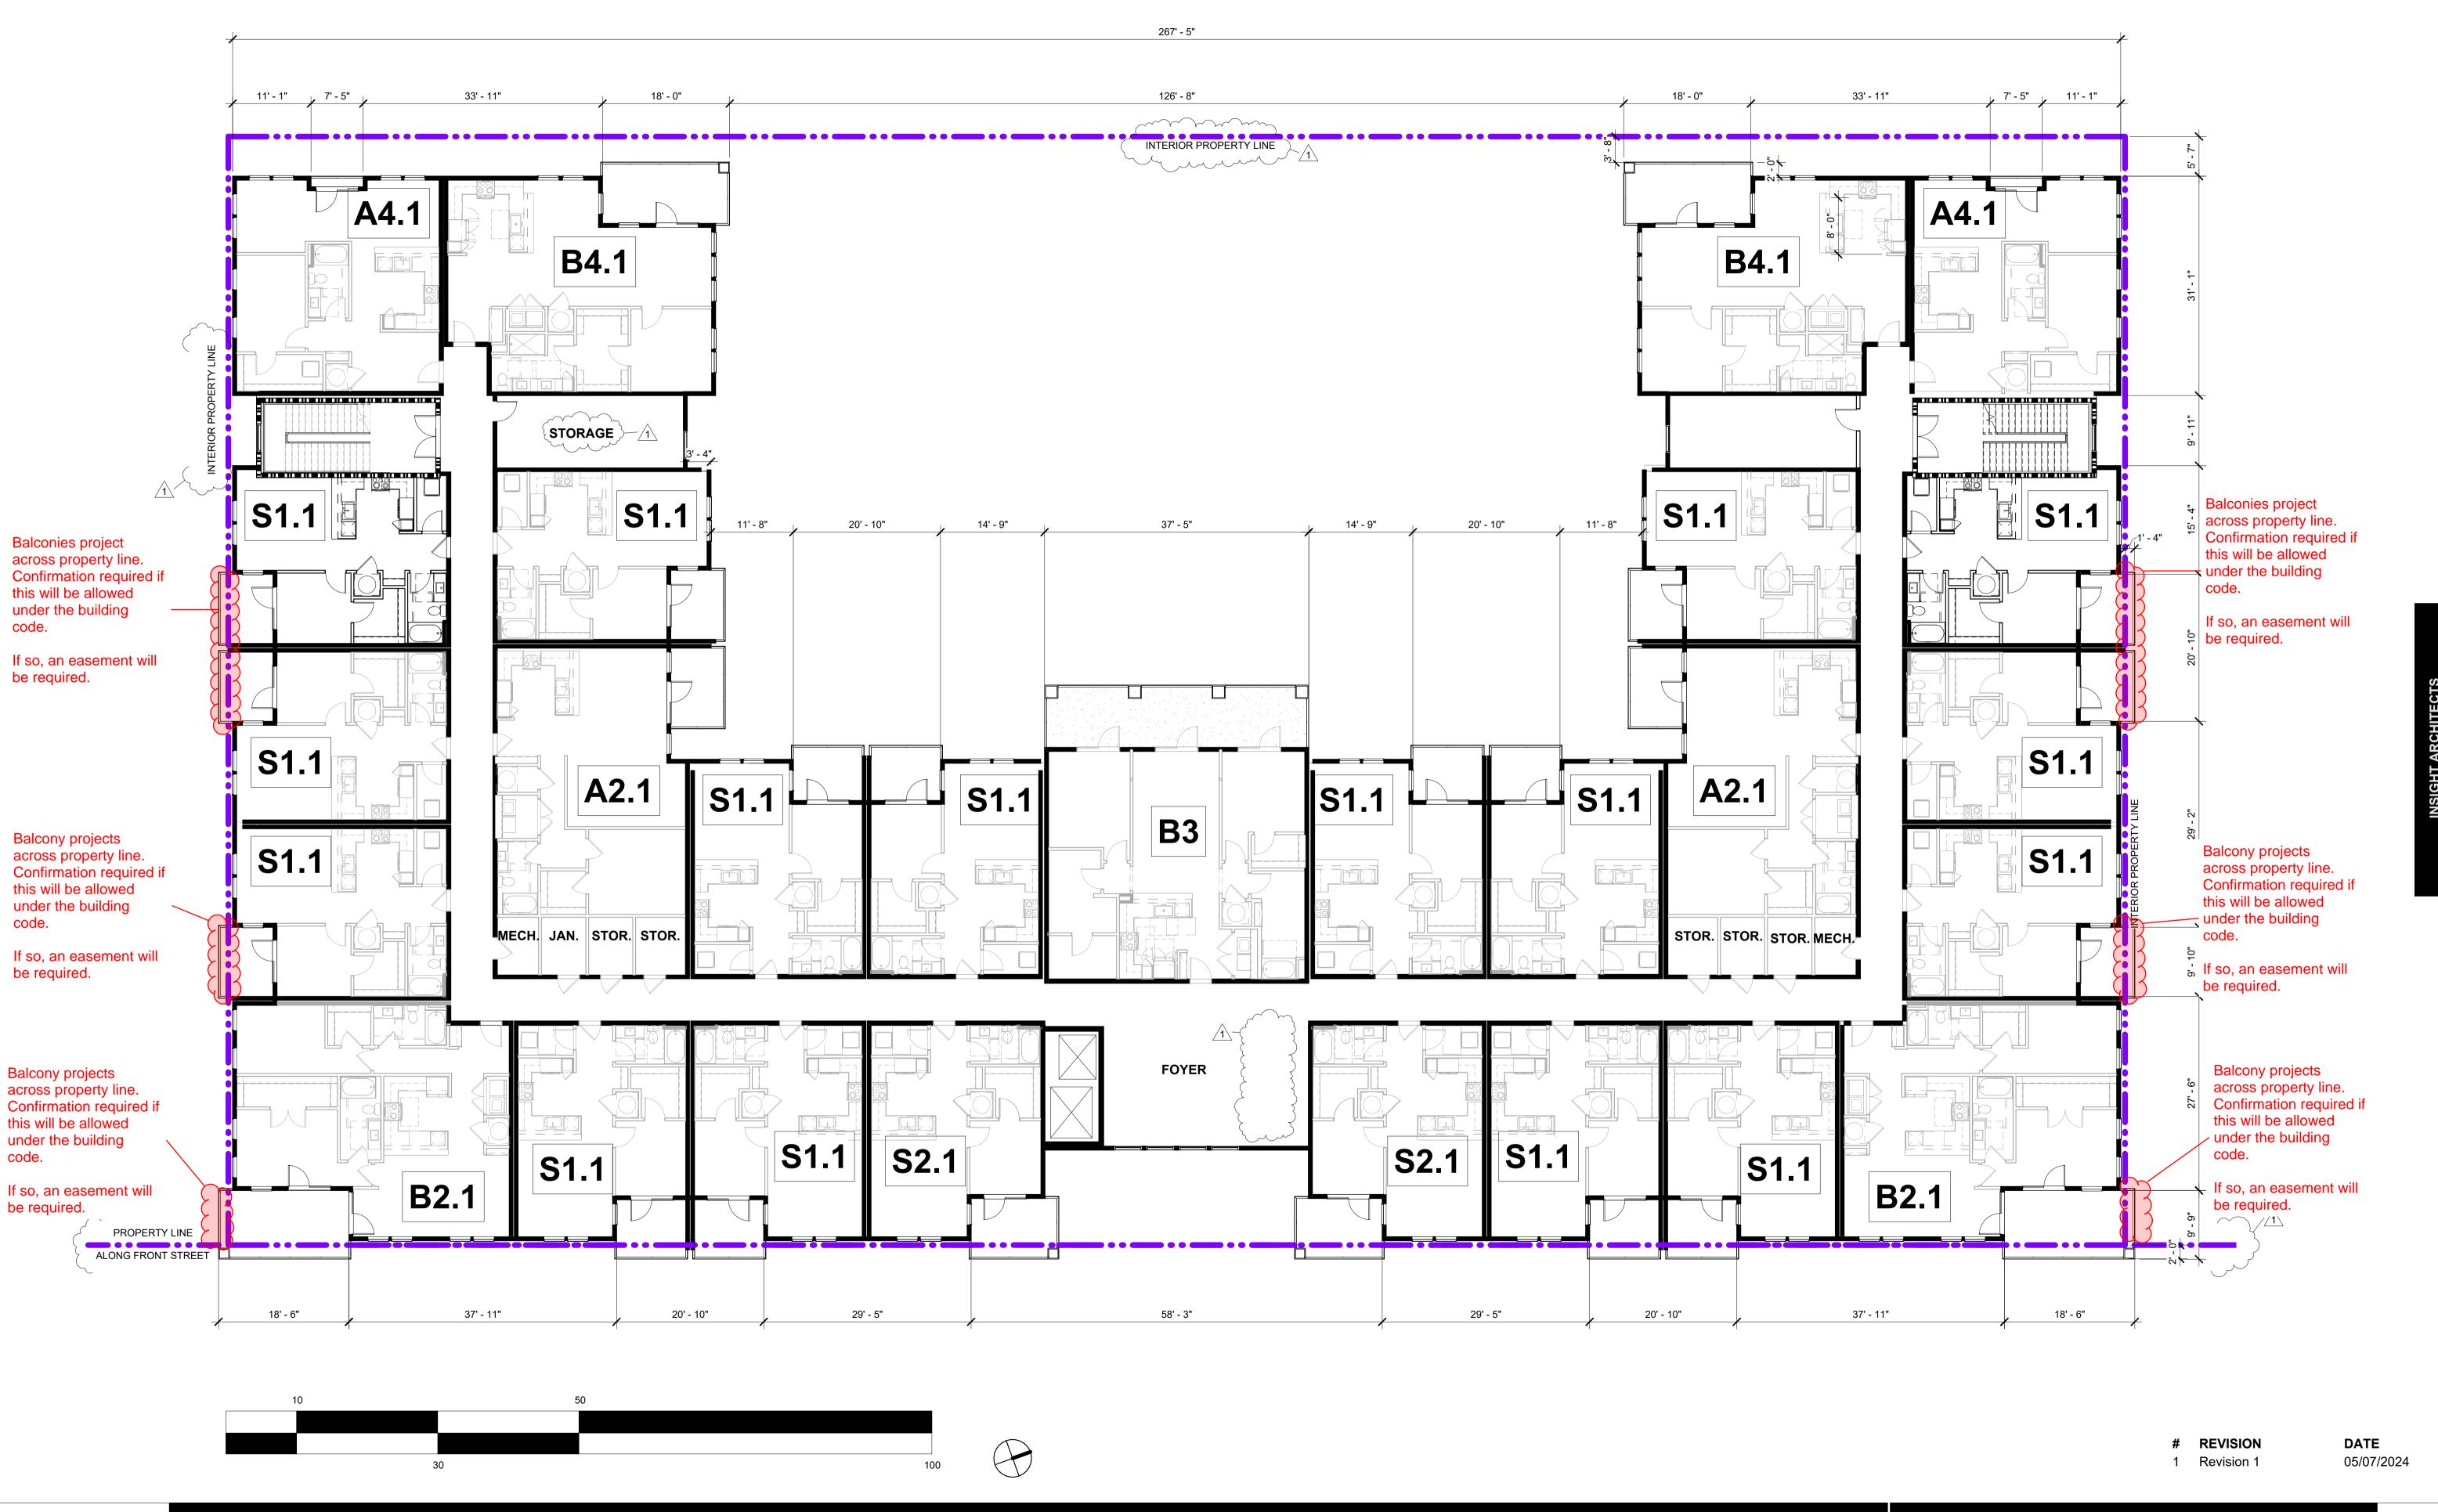
PROJECT NO.

SHEET

2024.03.15



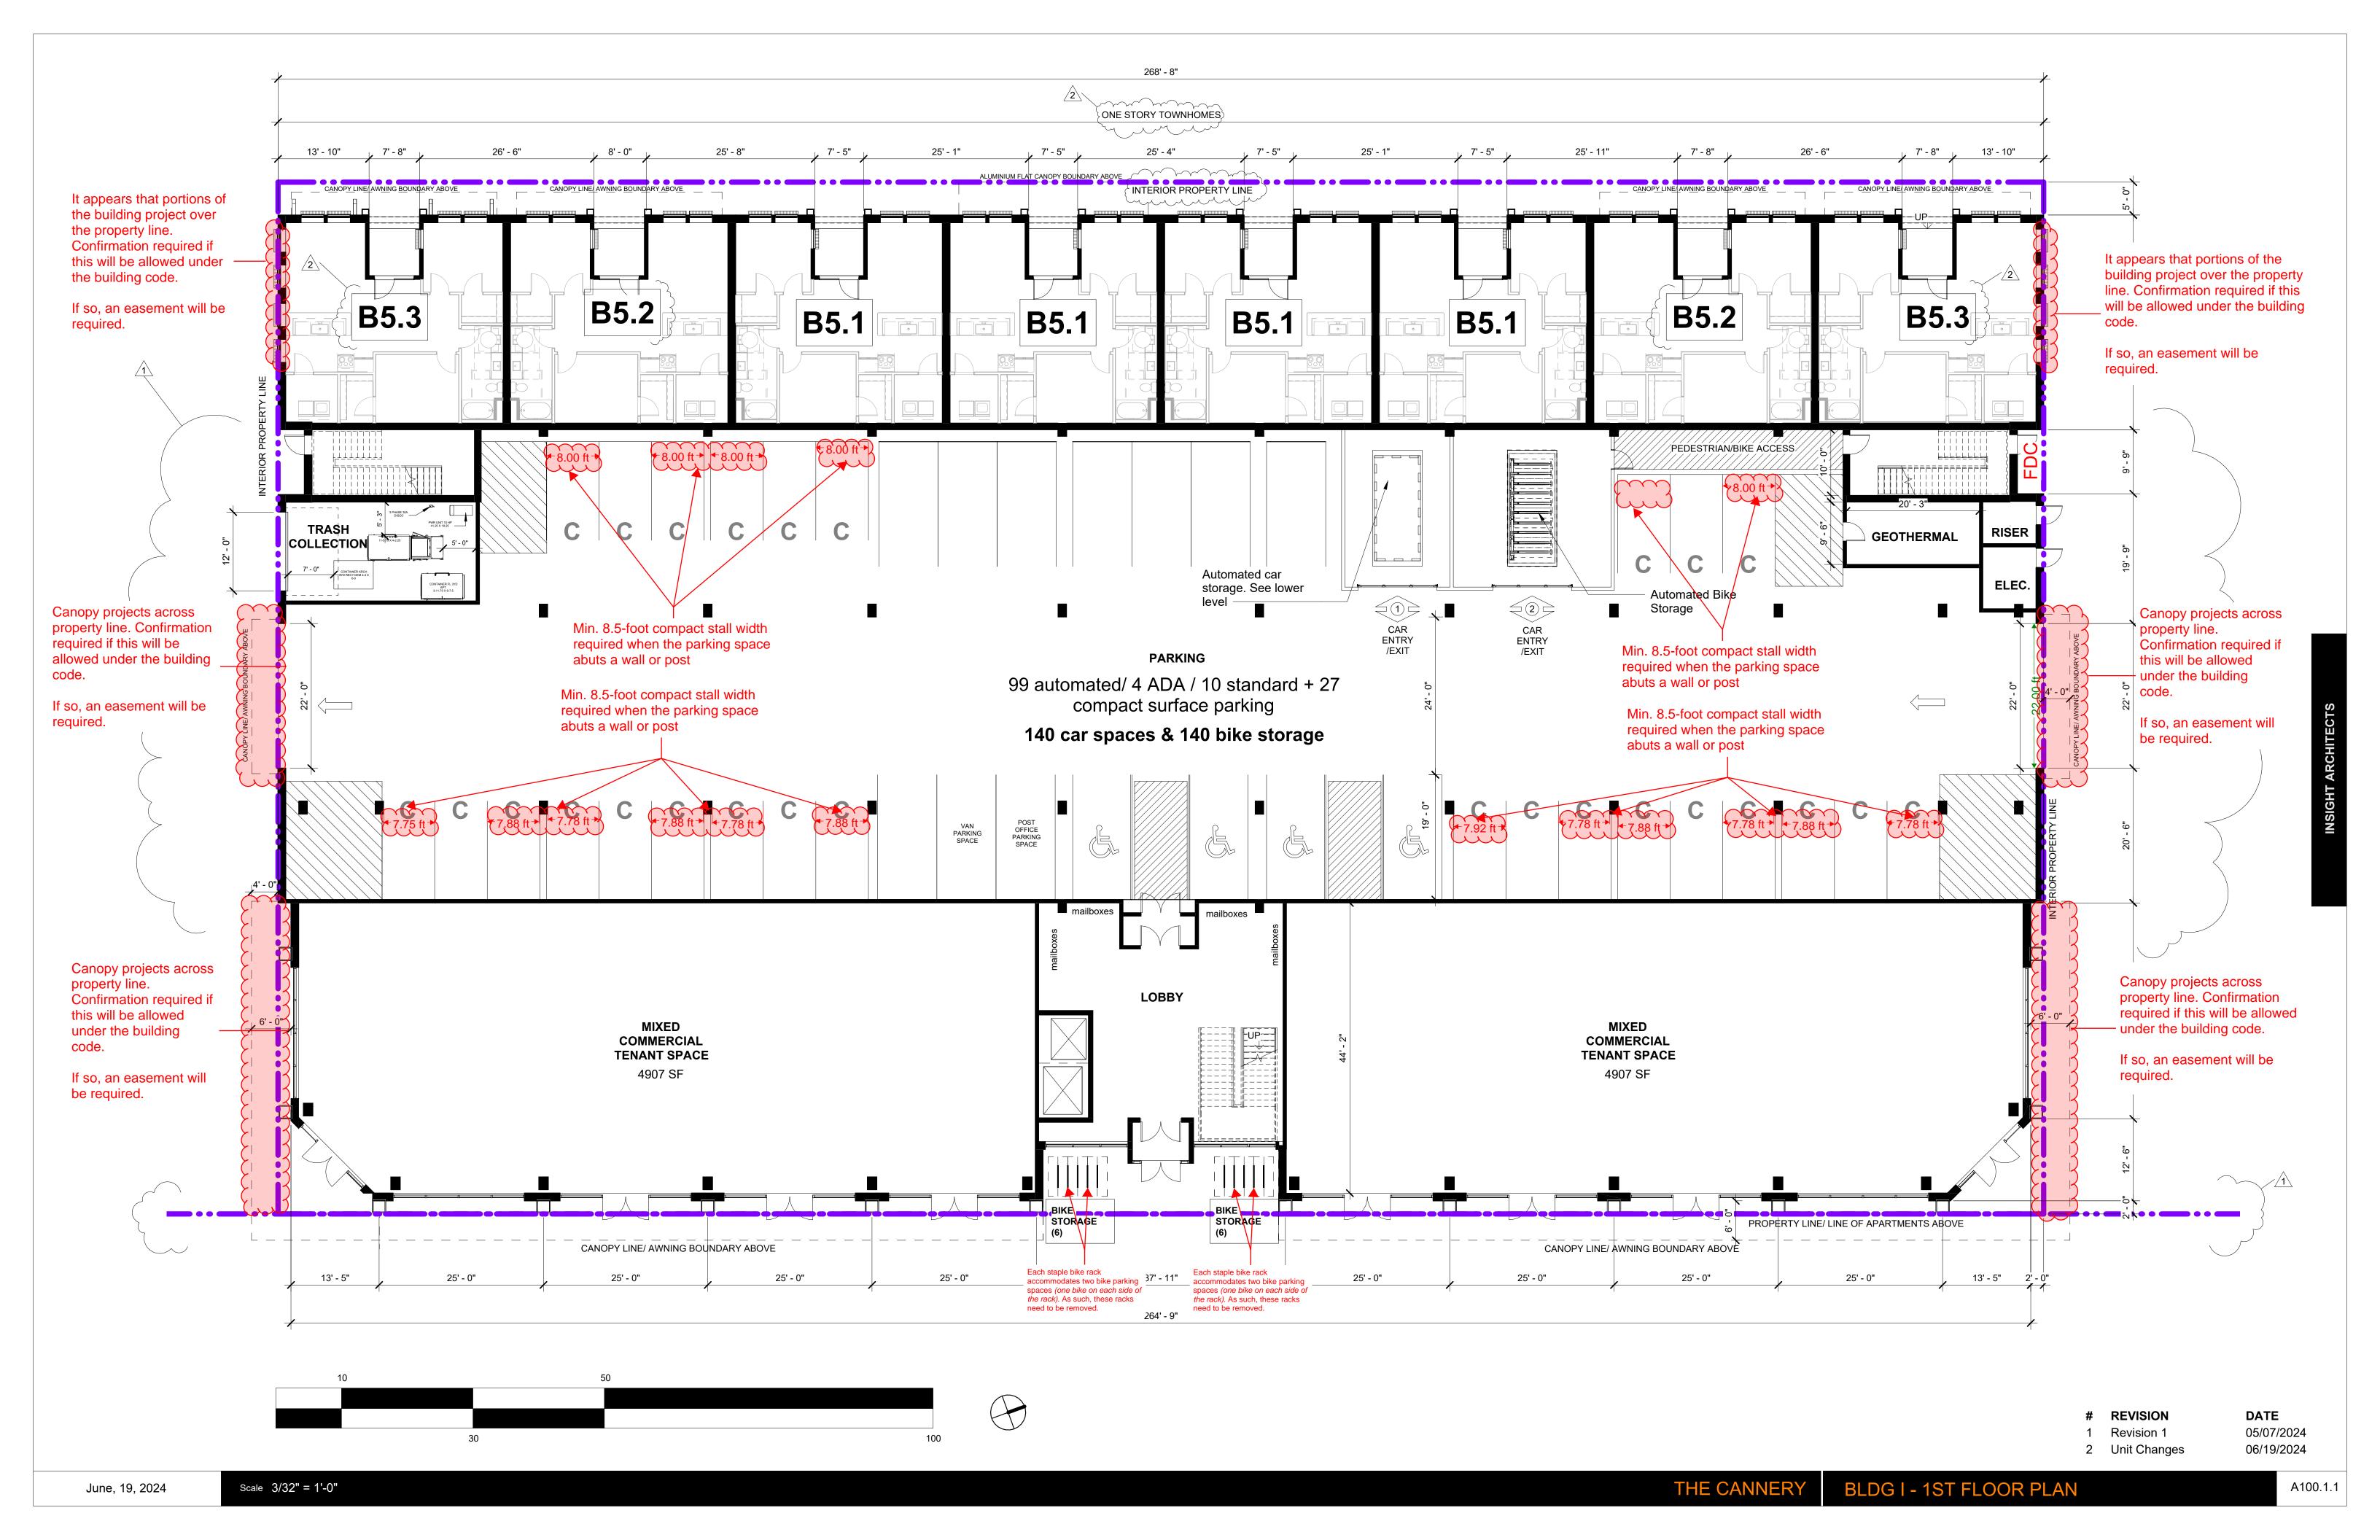


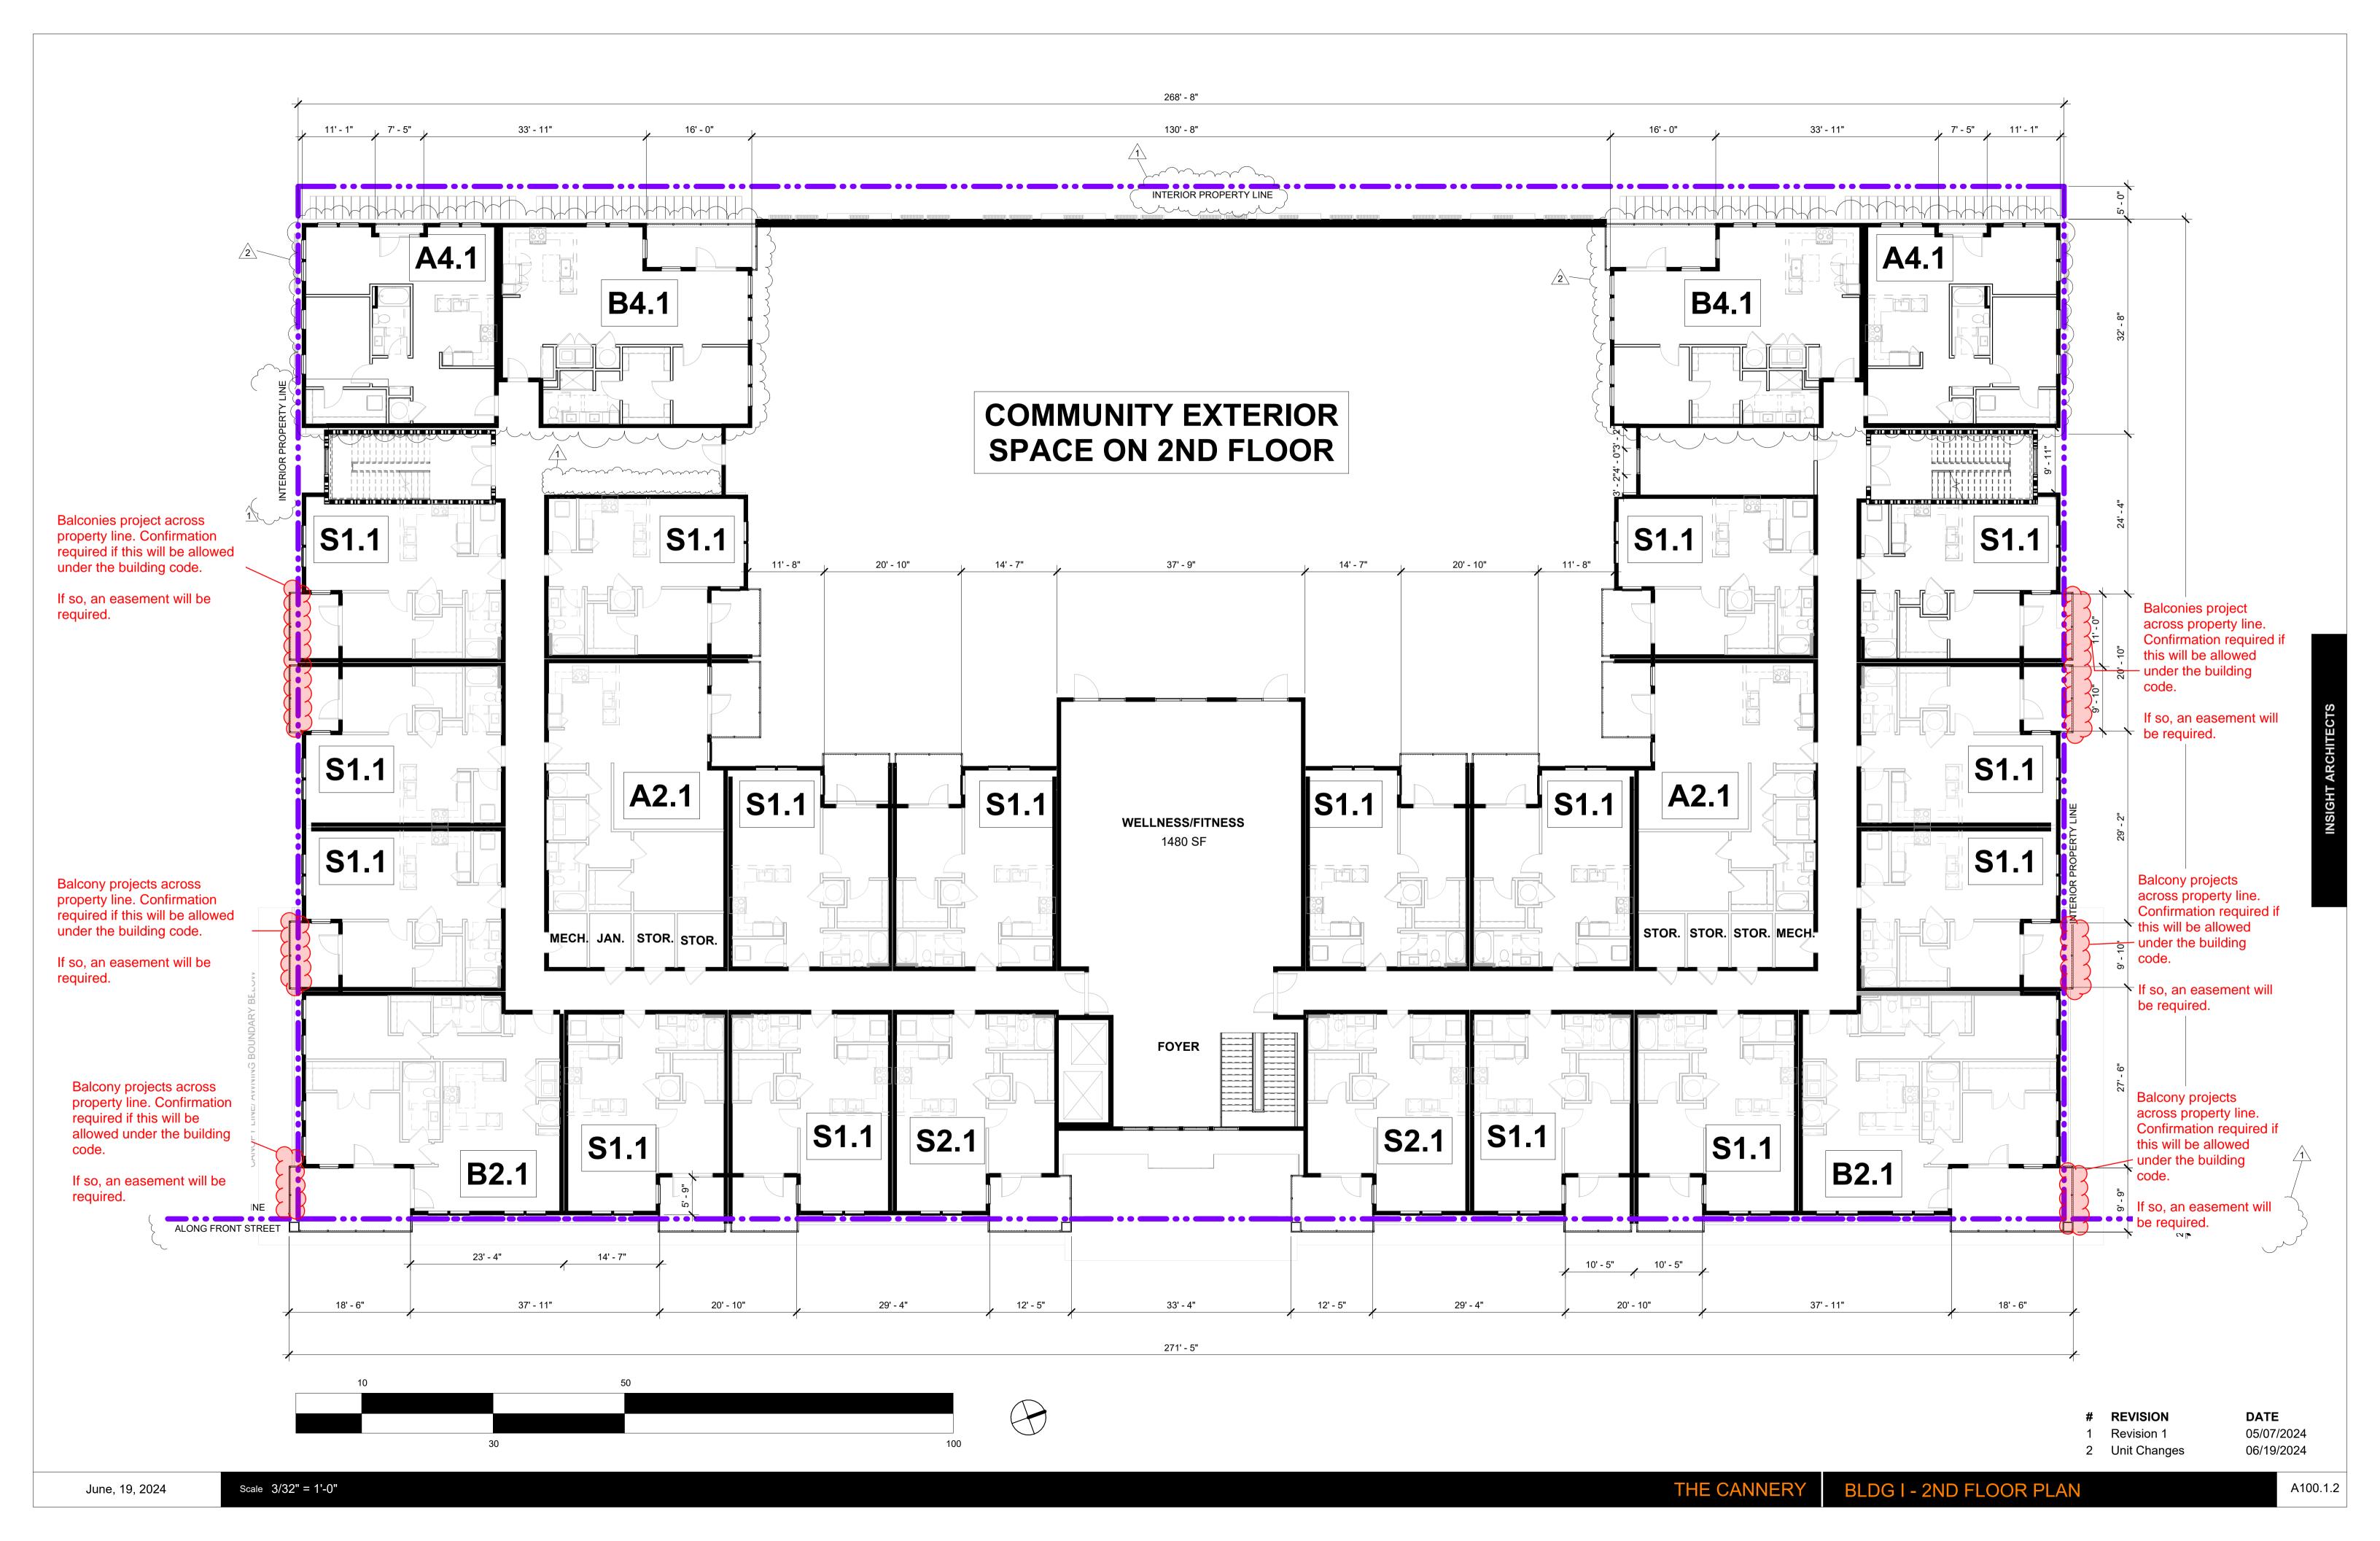

May, 07, 2024 Scale 3/32" = 1'-0"

THE CANNERY

BLDG I -3RD-5TH FLOOR PLAN

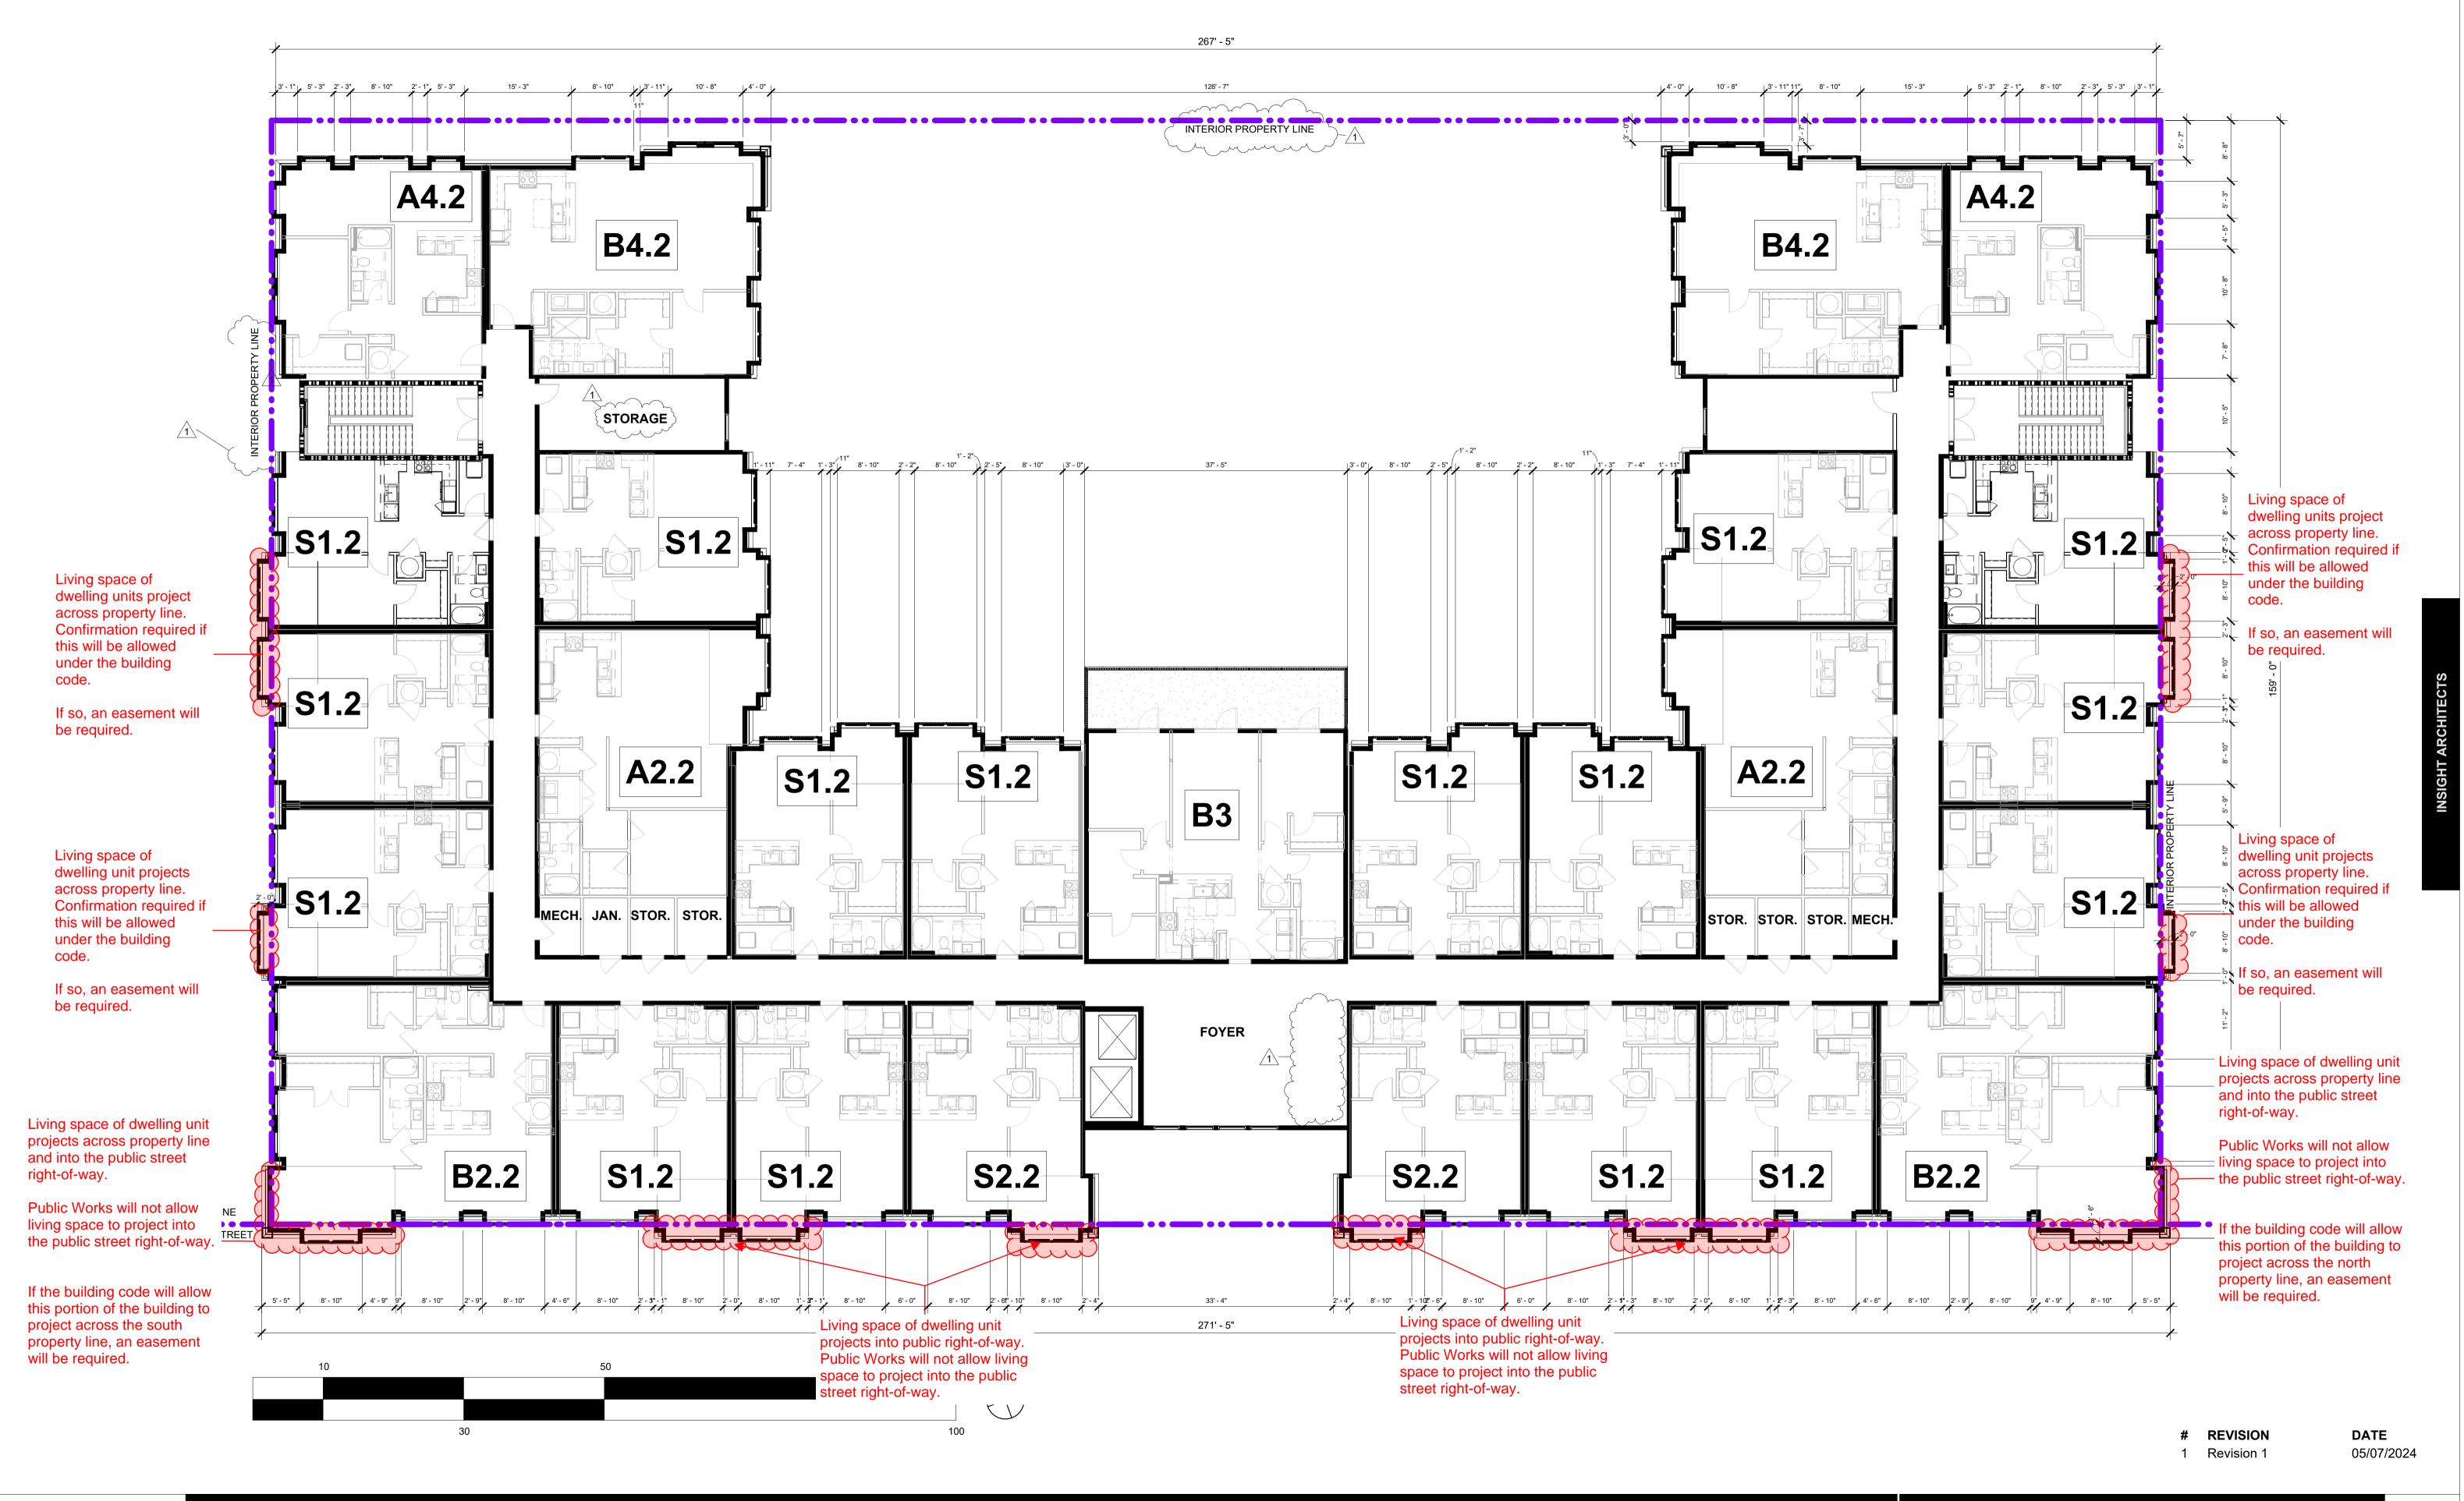



May, 07, 2024 Scale 3/32" = 1'-0"

THE CANNERY BLDG I - 6TH FLOOR PLAN

A100.1.6



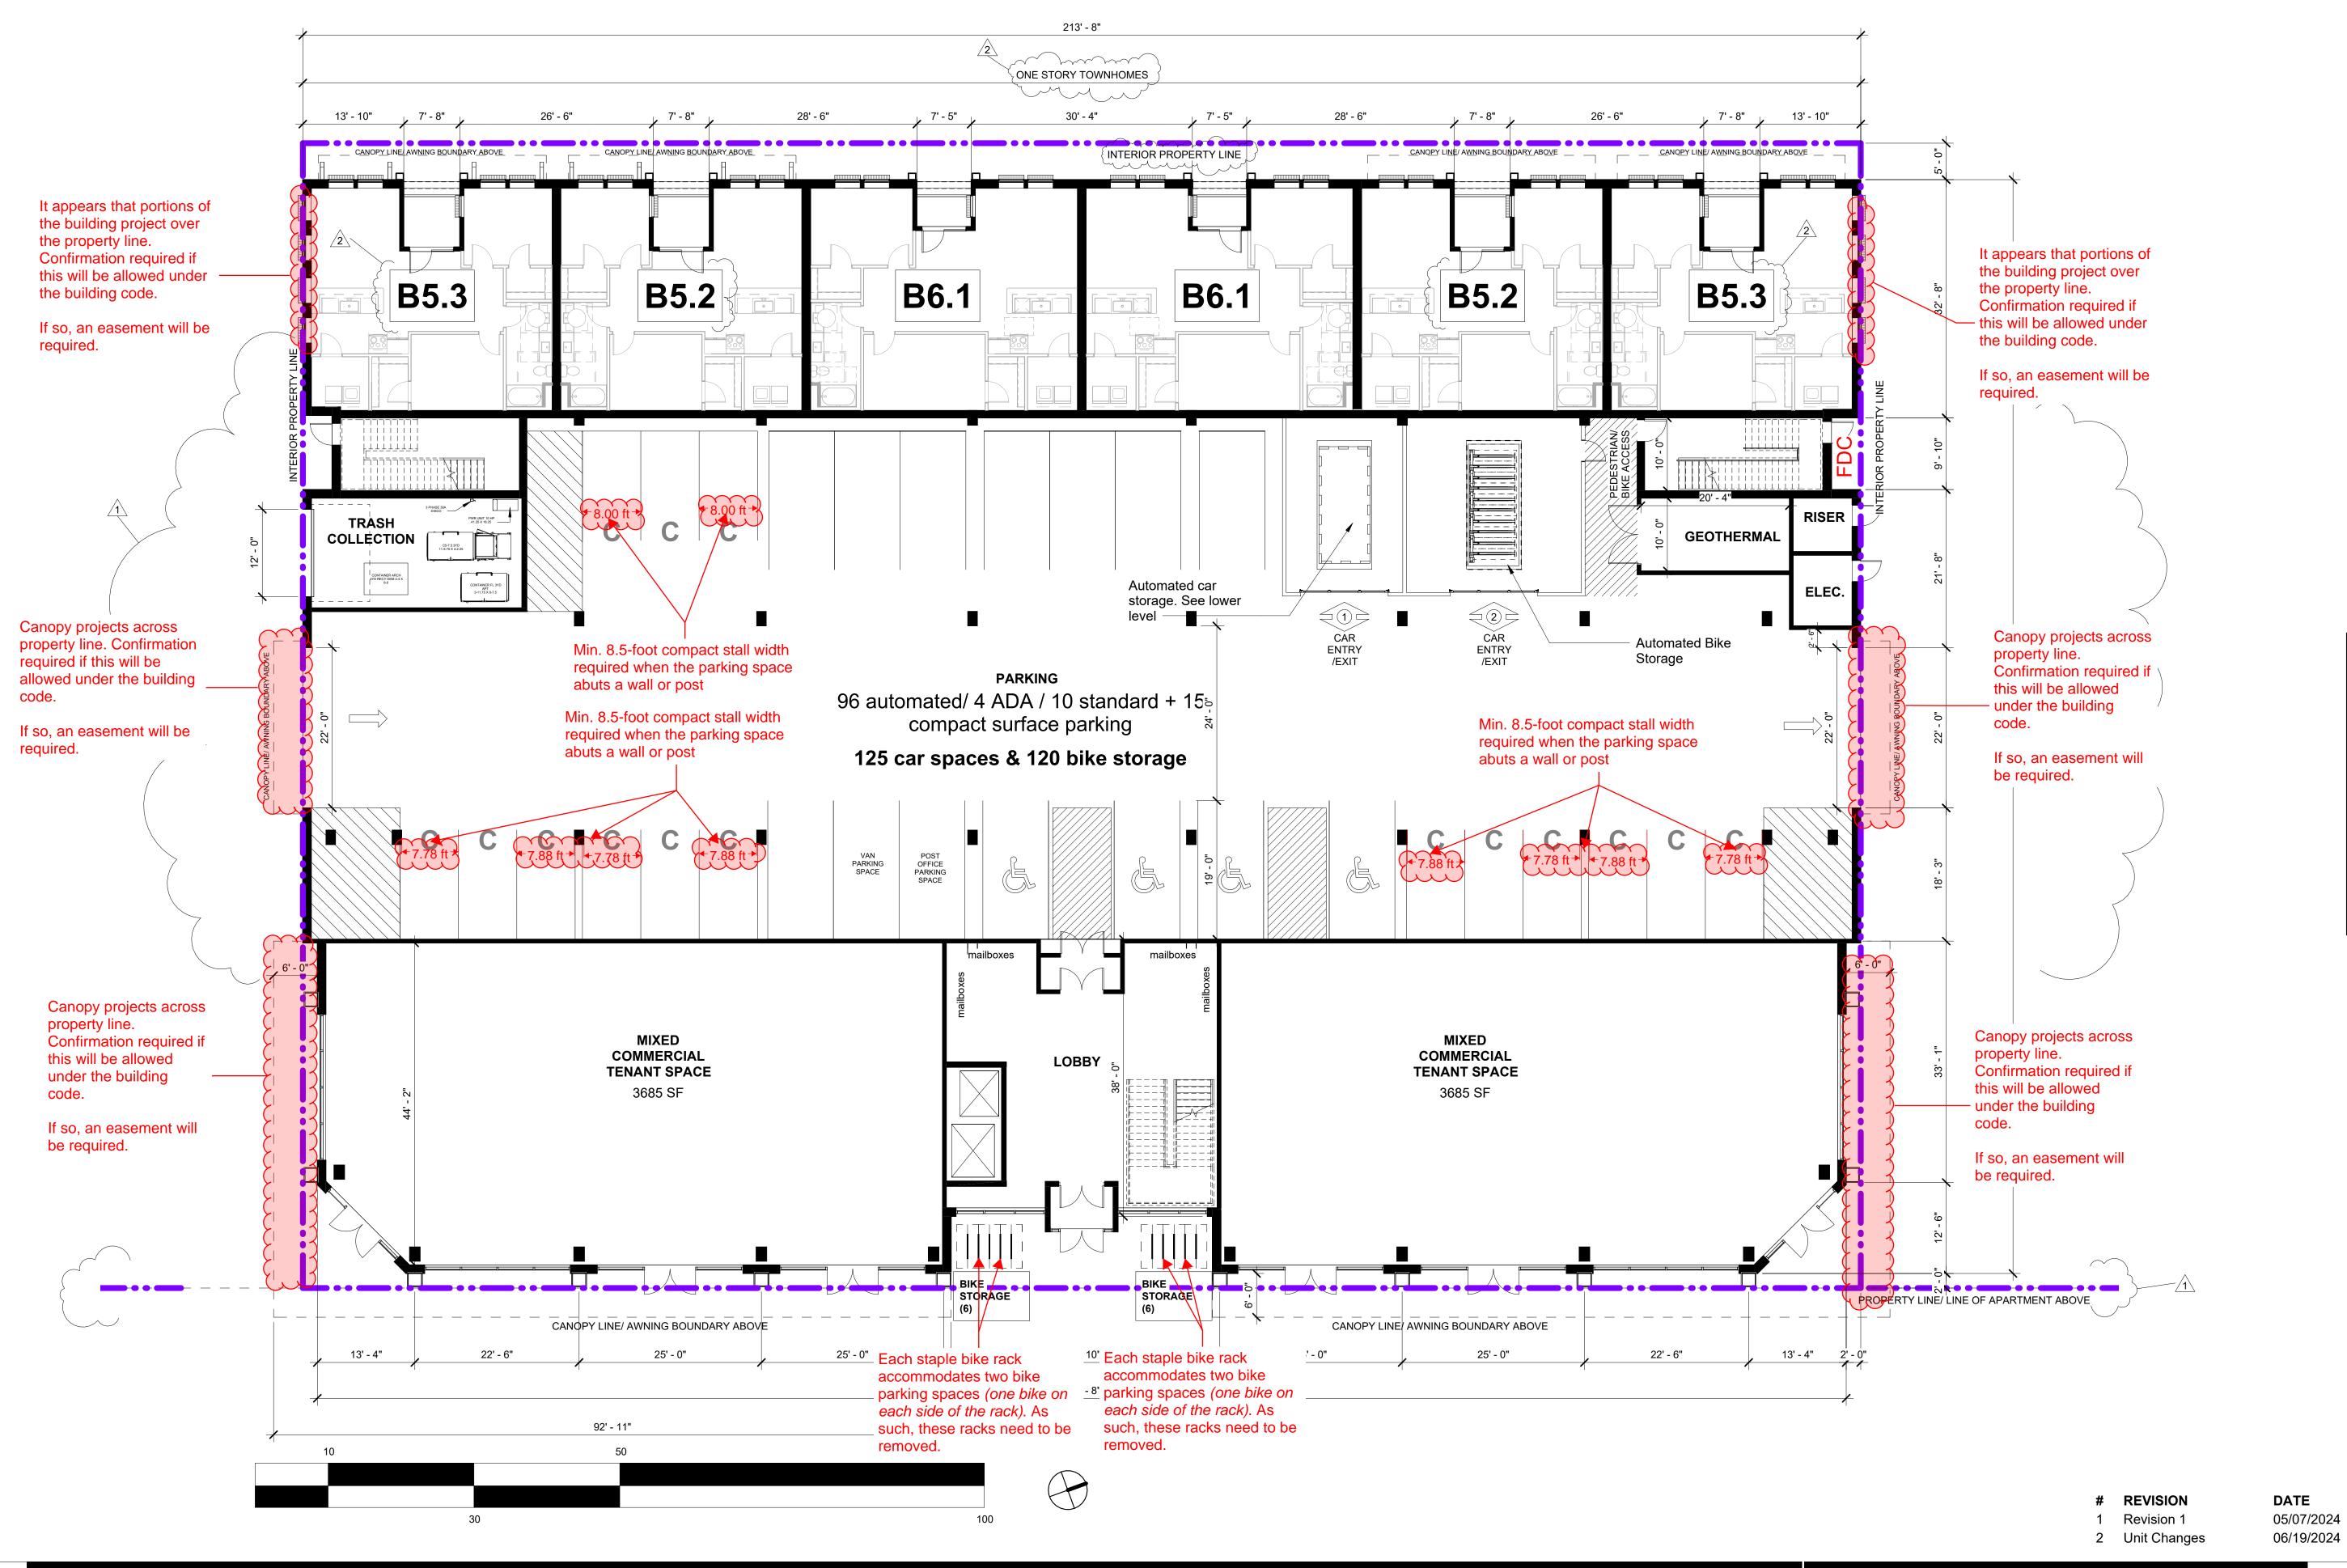

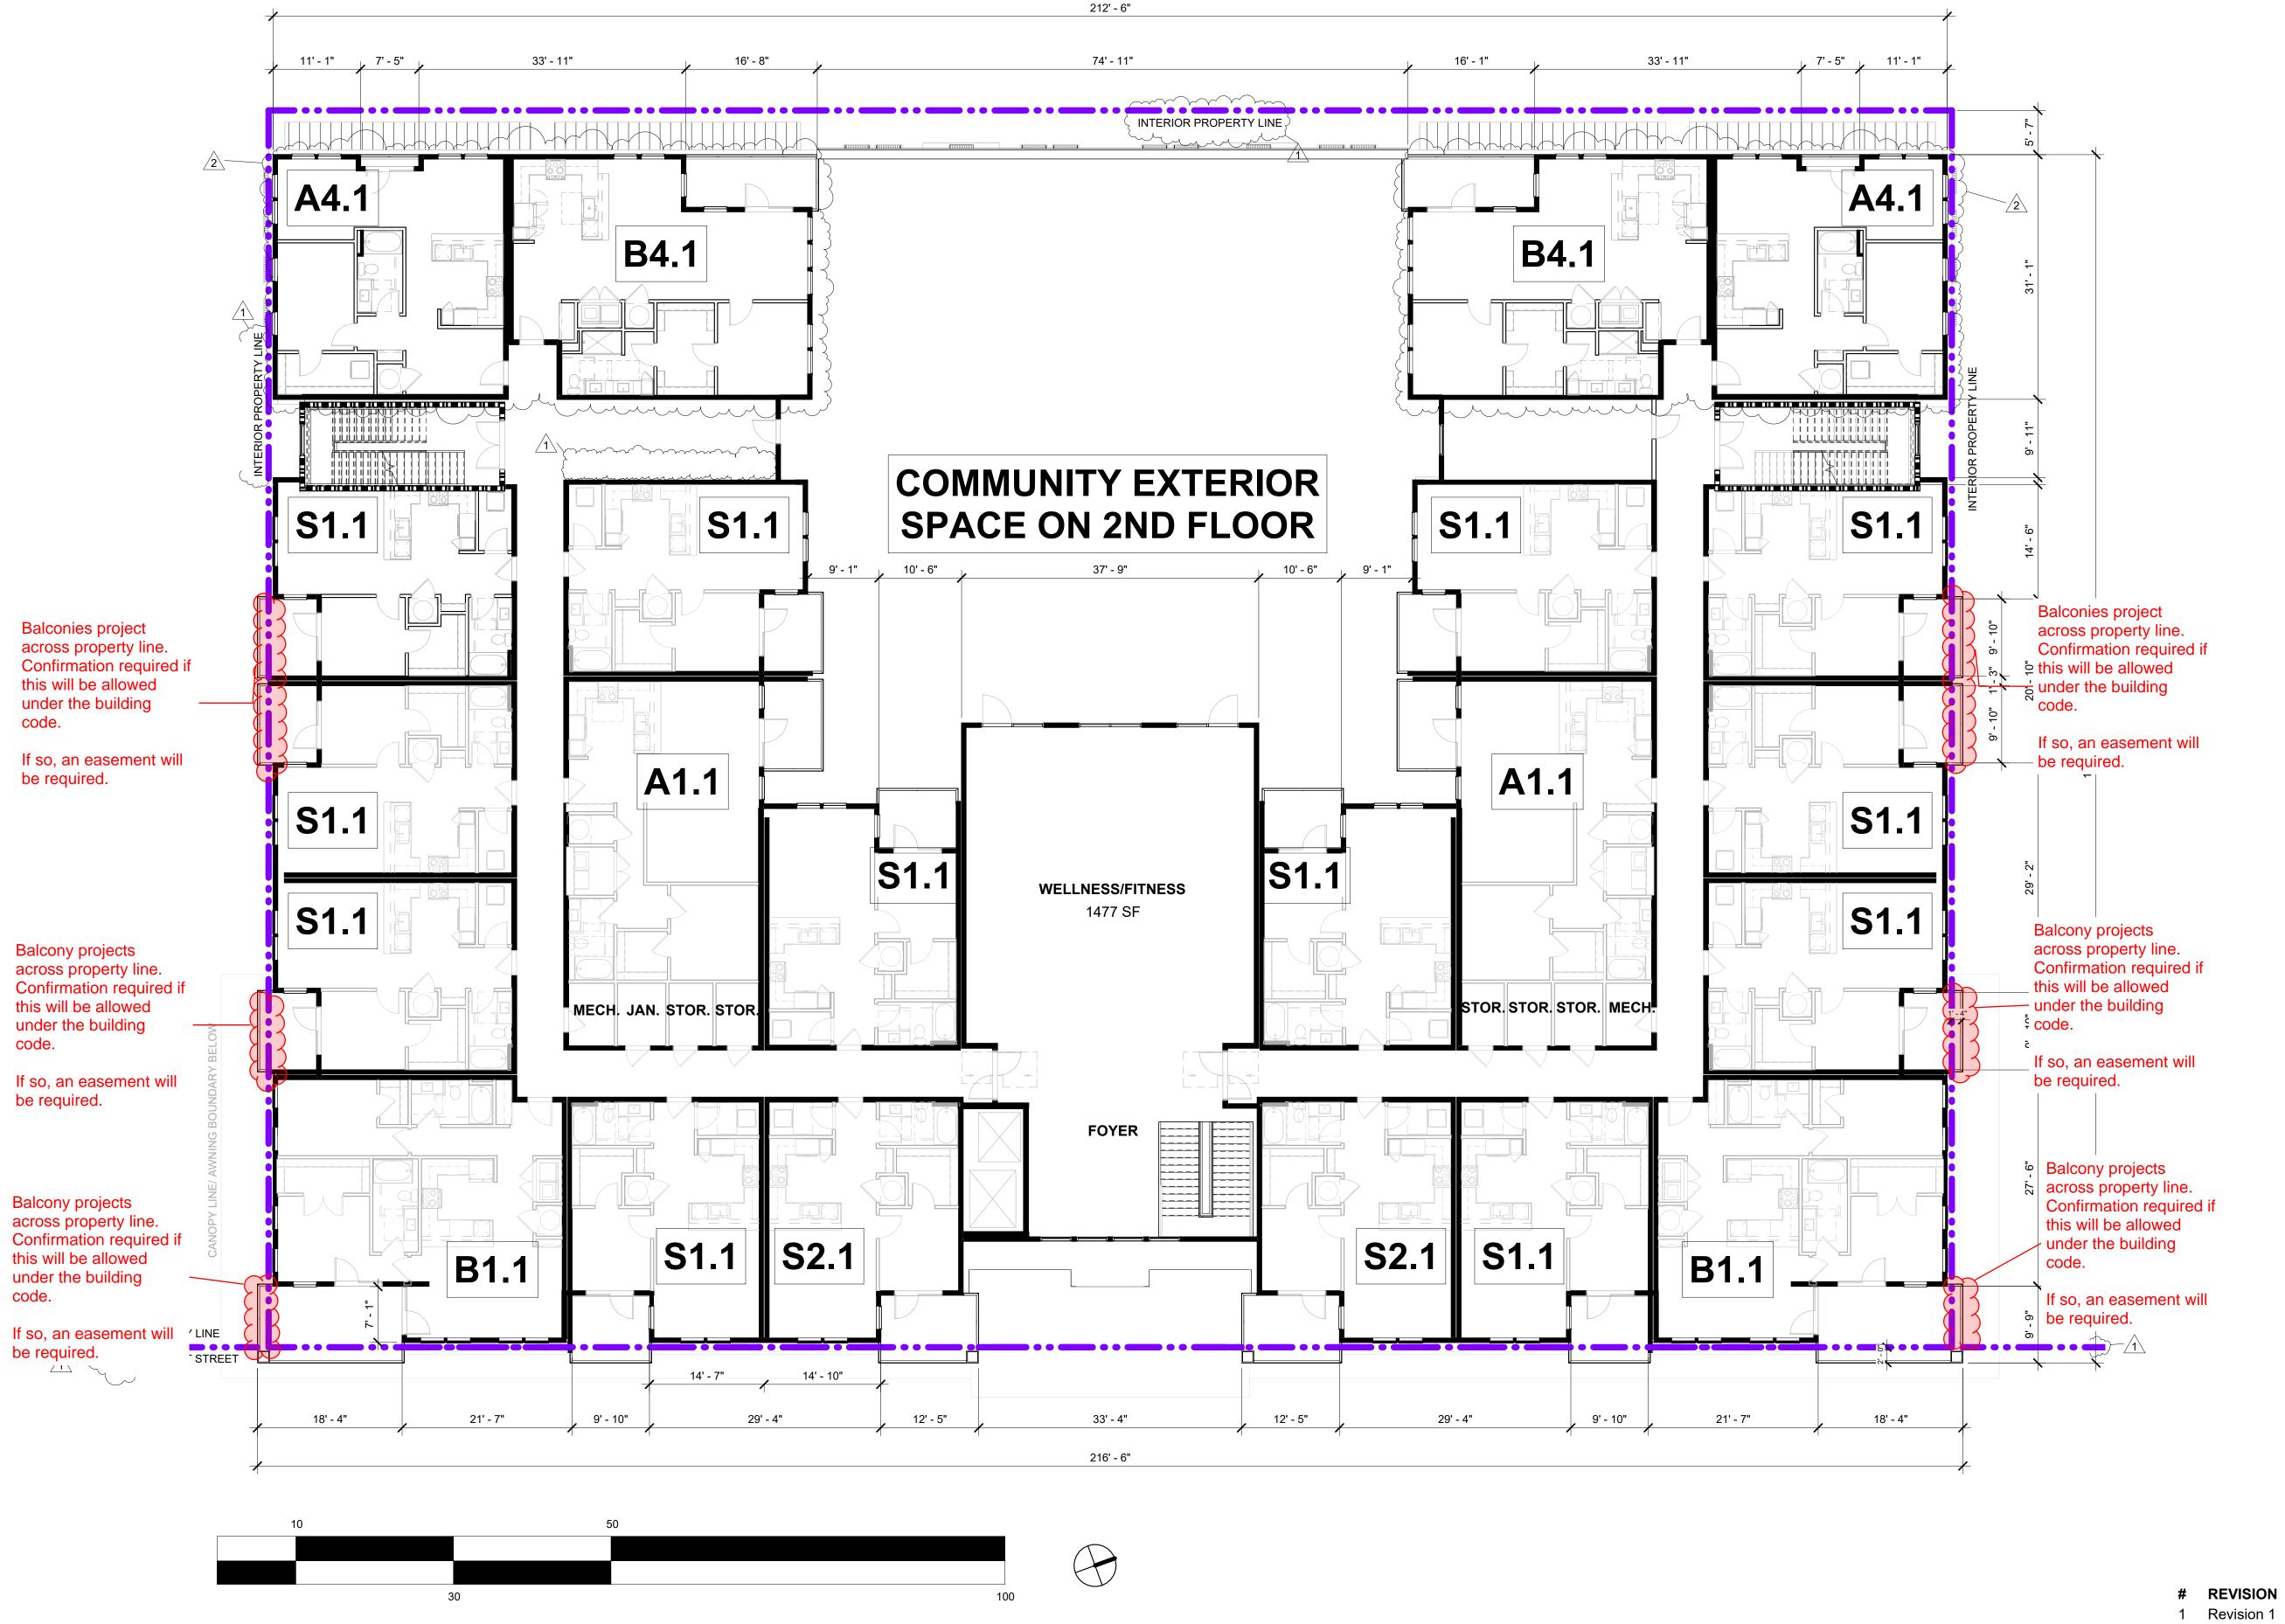

June, 19, 2024 Scale 3/32" = 1'-0" BLDG II - 2ND FLOOR PLAN


DATE



May, 07, 2024

DATE


05/07/2024

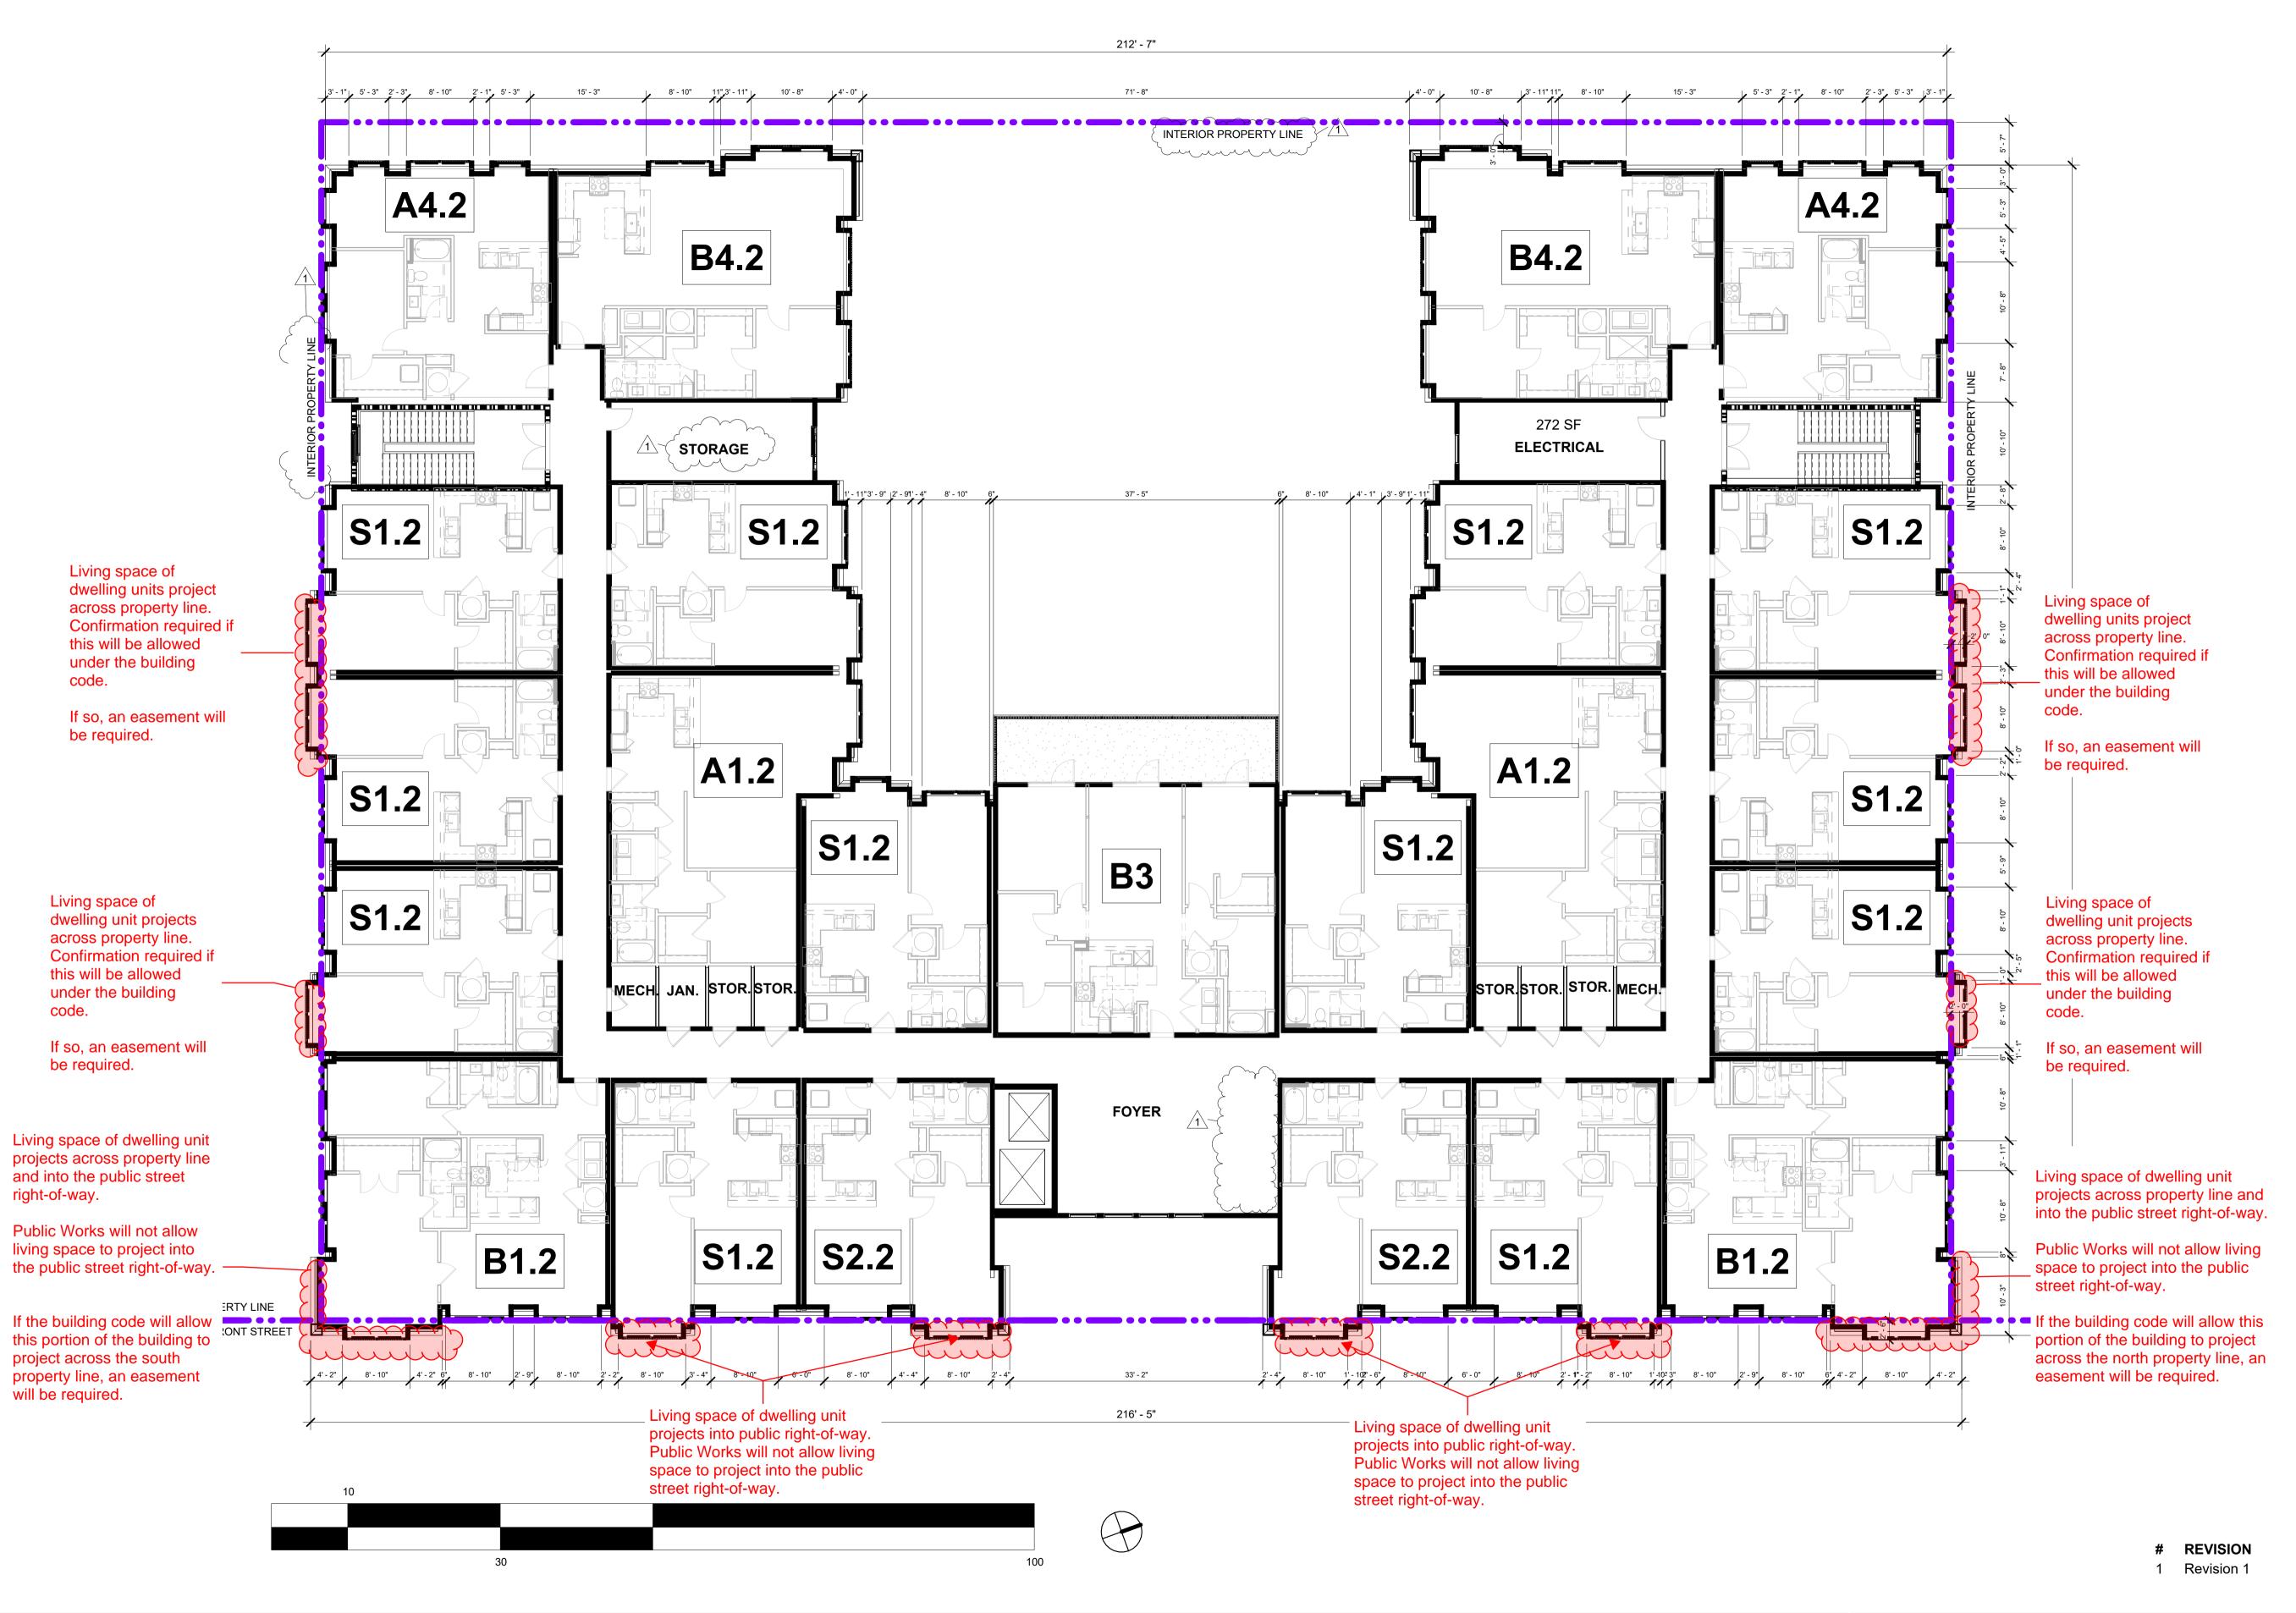

Scale 3/32" = 1'-0" May, 07, 2024

DATE

05/07/2024

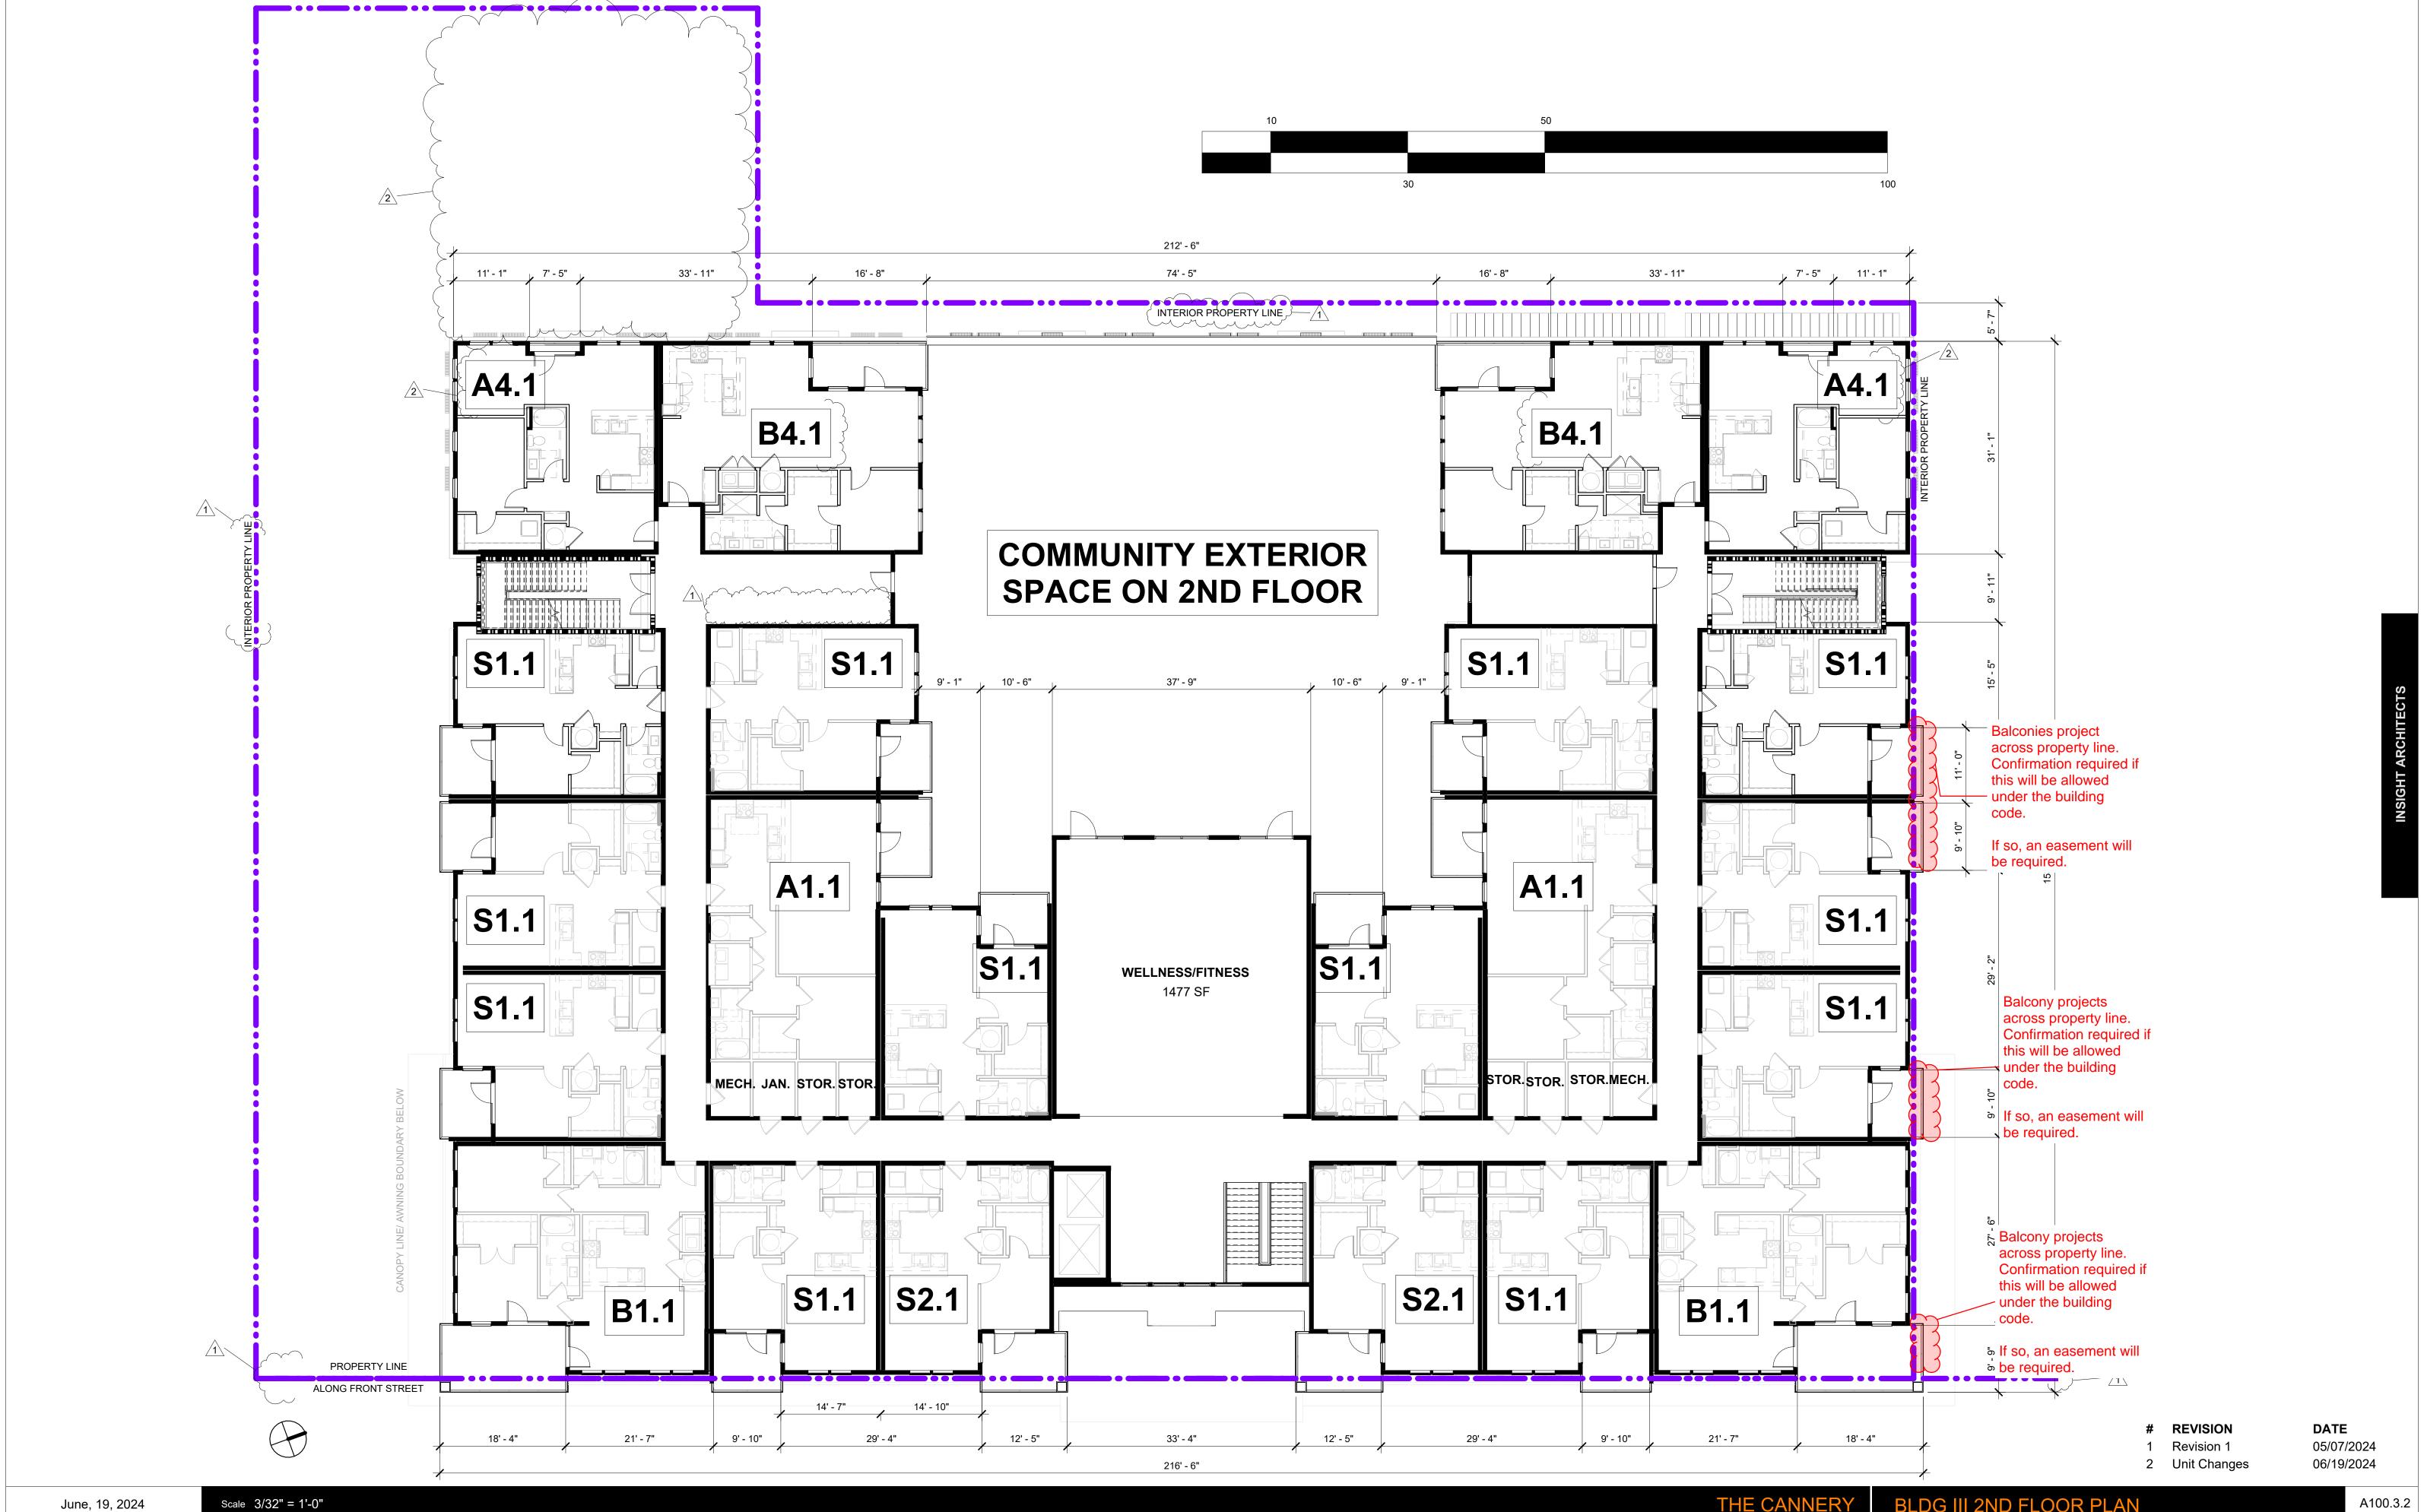


Scale 3/32" = 1'-0"

THE CANNERY

BLDG III 2ND FLOOR PLAN



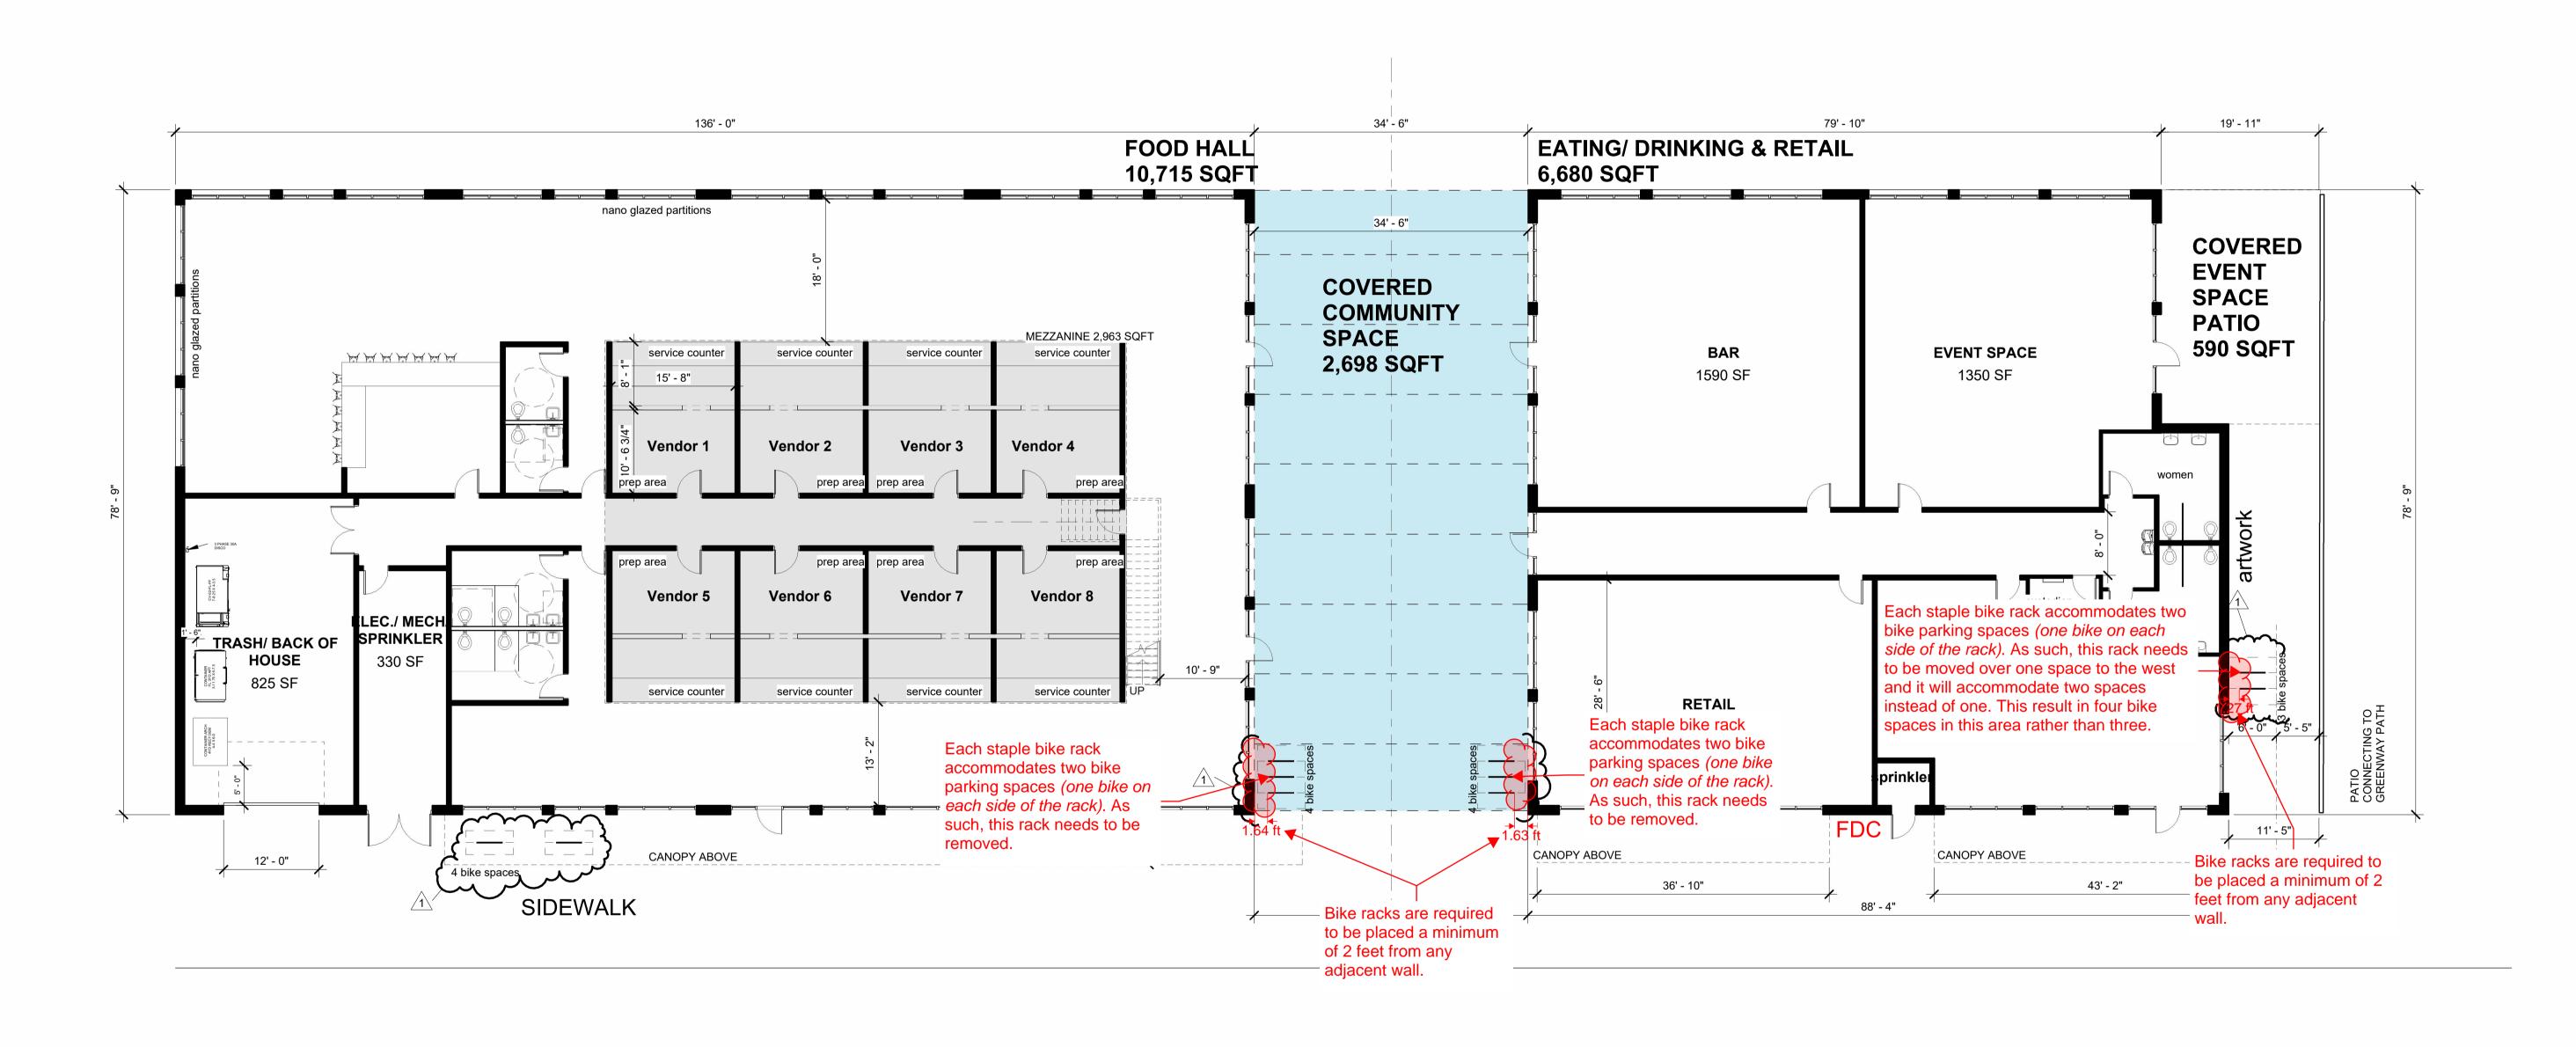

1 FOOD HALL
3/32" = 1'-0"

REVISION 1 Revision 1

05/07/2024


Scale 3/32" = 1'-0"

THE CANNERY - MARKET

A200

DATE

FOOD HALL

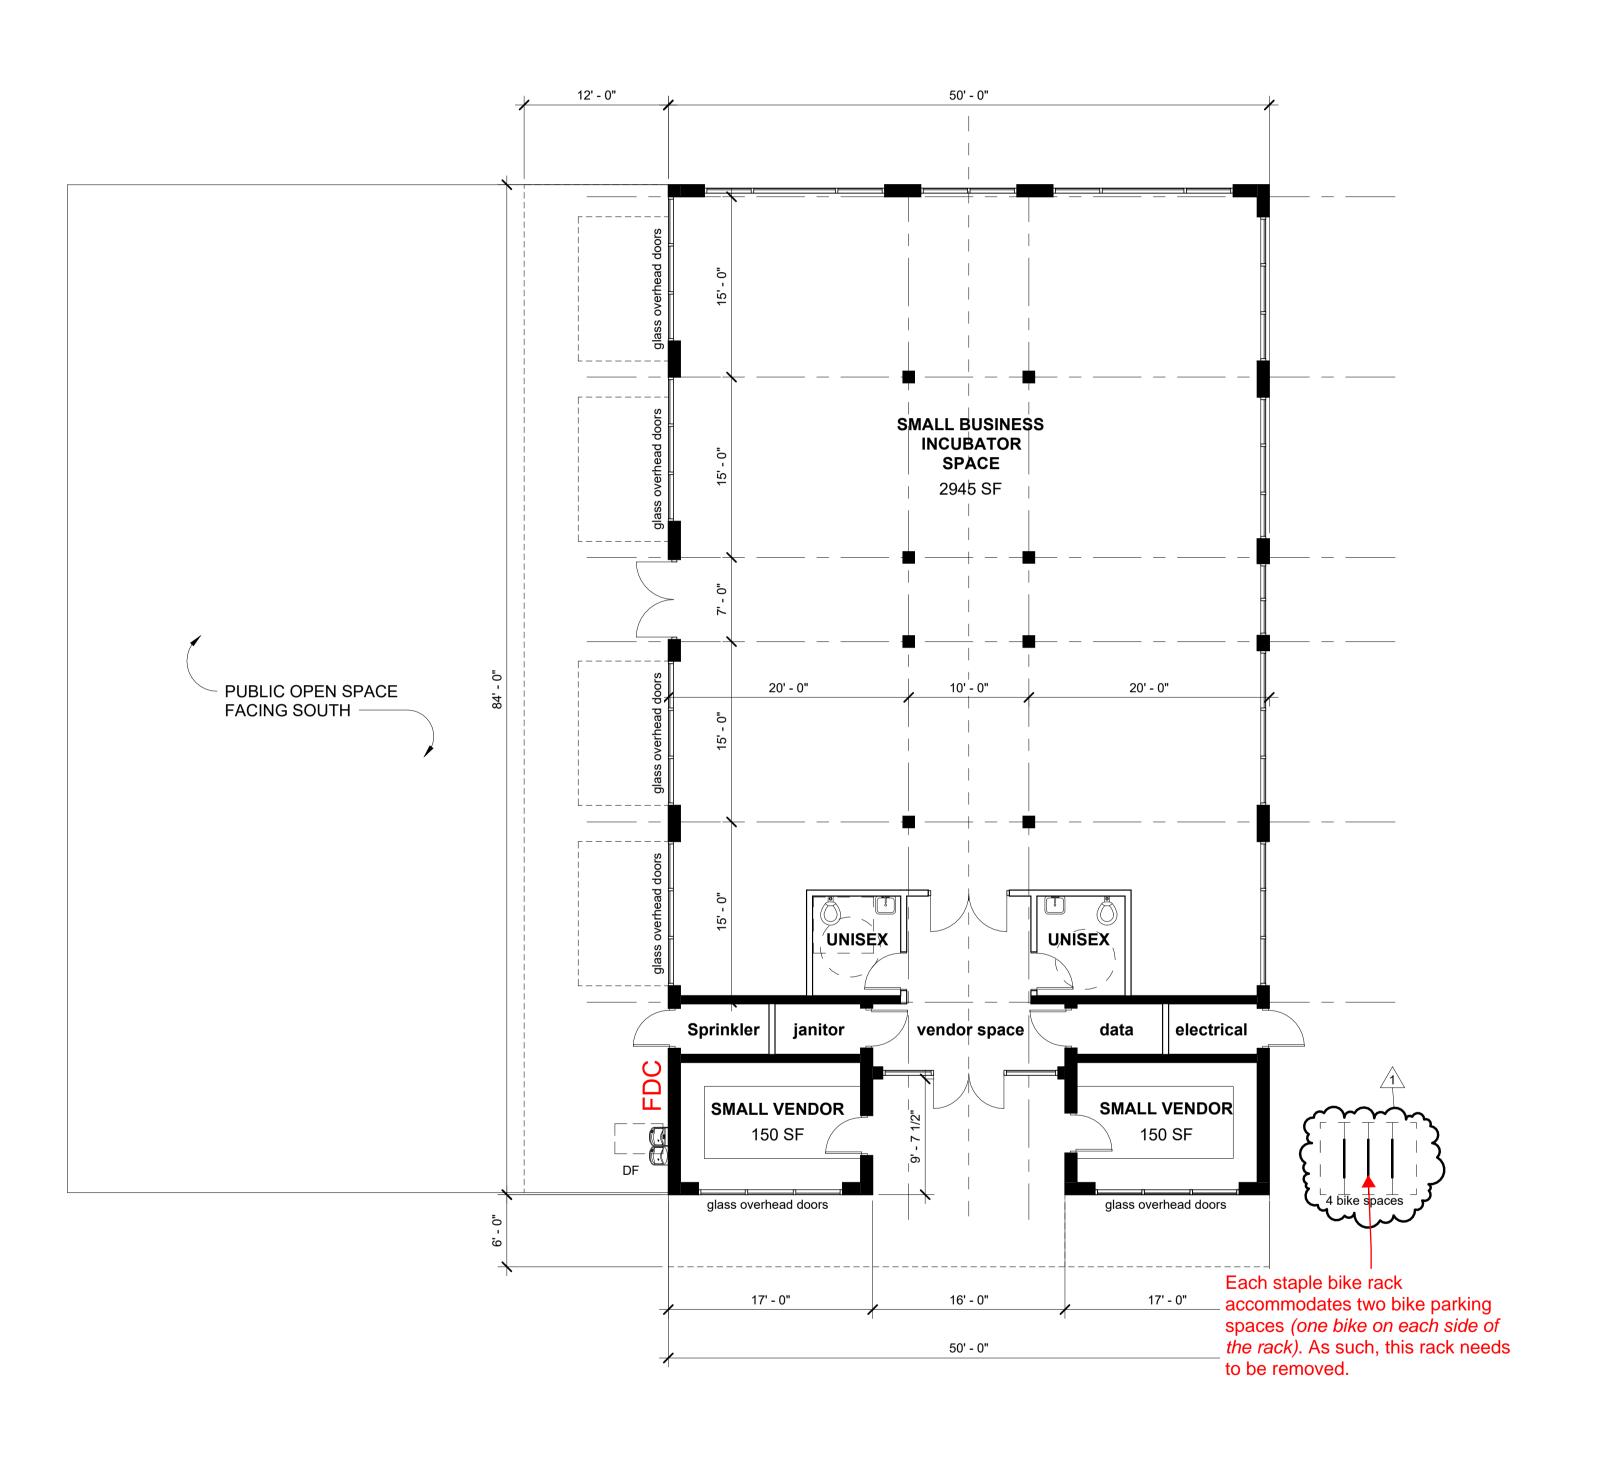

1 1st FLOOR PLAN
1/8" = 1'-0"

TOTAL BUILDING SQFT 4,200 sf <u>COVERED AREA SOUTH: 1,008 sf</u> TOTAL: 5,208 sf

REVISION 1 Revision 1

DATE 05/07/2024

May 07, 2024

Attachment B: Marion County Subdivision Name Approval

MARION COUNTY SUBDIVISION/CONDOMINIUM NAME REQUEST

Marion County Surveyor – 5155 Silverton Road NE, Salem, OR 97305 Fax: 503-588-7970 Phone: 503-588-5155 Email: MarionCountySurveyor@co.marion.or.us

Proposed Subdivision N	ame*: Cannery						
	(Please do not use the word "Subdivision" in the name.)						
Proposed Condominium	Name*:						
	(Must include either the word Condominium, Condominiums, or A Condominium)						
	*Subject to consent by prior party if name was previously used in a recorded plat, per ORS 92.090(1).						
NOTE: Reserved names expire 2 years from original approval date.							
Renewal?	Yes No ✓						
Owner Name:	FRONT STREET PROPERTIES LLC						
Address:	PO BOX 2067, SALEM, OR, 97308						
Email:	jordan@firstcommercialoregon.com						
Phone:	503-364-7400 Date: 05/28/2024						
	subdivision in a city? Yes V No No Name: Salem						
	Tax Map and Taxlot Number: 07 3W 22AB, Tax Lots 300 & 900 Office Use Only						
Date Received:	5/28/24						
Date Received: 5 28 29 Approved as Submitted (approval expires in 2 years) Not Approved for the following reason(s):							
	Marion County Surveyor						

MARION COUNTY SUBDIVISION/CONDOMINIUM NAME REQUEST


Marion County Surveyor – 5155 Silverton Road NE, Salem, OR 97305 Fax: 503-588-7970 Phone: 503-588-5155 Email: MarionCountySurveyor@co.marion.or.us

Proposed Subdivision N	^{ame*} : Cannery
	(Please do not use the word "Subdivision" in the name.)
Proposed Condominium	Name*:
	(Must include either the word Condominium, Condominiums, or A Condominium)
<u></u>	rior party if name was previously used in a recorded plat, per ORS 92.090(1).
NOTE: I	Reserved names expire 2 years from original approval date.
Renewal?	Yes No ✓
Owner Name:	TRUITT PROPERTIES LLC
Address:	PO BOX 2067, SALEM, OR, 97308
Email:	jordan@firstcommercialoregon.com
Phone:	503-364-7400 Date: 05/28/2024
	subdivision in a city? Yes 🗸 No No
	Tax Map and Taxlot Number: 07 3W 22AB, Tax Lot 600
	Office Use Only
Date Received:	5/28/24
	Approved as Submitted <u>(approval expires in 2 years)</u> Not Approved for the following reason(s):
	Marion County Surveyor

Attachment C: Revised Preliminary Land Use Plans

THE CANNERY


PRELIMINARY LAND USE PLANS

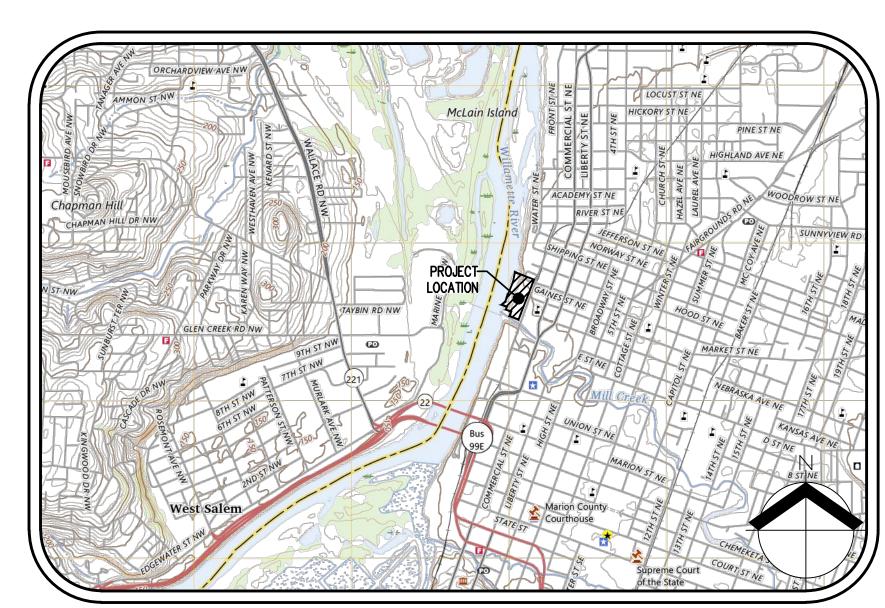

VICINITY MAP

NOT TO SCALE

LEGEND <u>PROPOSED</u> **PROPOSED** DECIDUOUS TREE STORM DRAIN CLEAN OUT CONIFEROUS TREE STORM DRAIN MANHOLE FIRE HYDRANT WATER BLOWOFF WATER METER GAS VALVE WATER VALVE DOUBLE CHECK VALVE P AIR RELEASE VALVE SANITARY SEWER CLEAN OUT O POWER PEDESTAL COMMUNICATIONS RISER **EXISTING** <u>PROPOSED</u> RIGHT-OF-WAY LINE **BOUNDARY LINE** PROPERTY LINE CENTERLINE EDGE OF PAVEMENT EASEMENT FENCE LINE GRAVEL EDGE POWER LINE OVERHEAD WIRE COMMUNICATIONS LIN FIBER OPTIC LINE STORM DRAIN LINE SANITARY SEWER LINE WATER LINE RECLAIMED WATER LINE

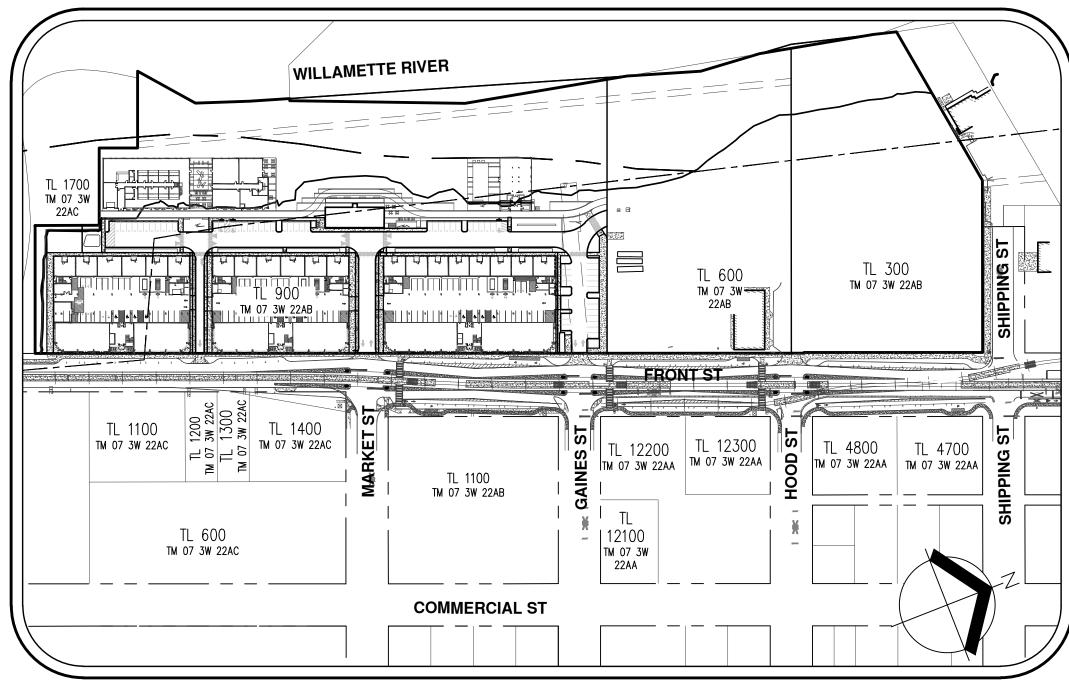

SITE MAP1" = 150'

PROPERTY DESCRIPTION:

MARION COUNTY TAX MAP 07 3W 22AB, TAX LOTS 300, 600, & 900 CITY OF SALEM, OREGON

PROPERTY LOCATION:

1105 FRONT ST NE,

SALEM, OREGON 97301

VERTICAL DATUM

ELEVATIONS ARE BASED ON CITY OF SALEM BENCHMARK NO. 1151, LOCATED AT THE SE CORNER OF SUMMER AND MARION ST. ELEVATION = 161.617 FEET (NGVD 29).

CIVIL ENGINEERING/ SURVEYING/LAND USE

PLANNING FIRM

AKS ENGINEERING & FORESTRY, LLC
ENGINEERING CONTACT: TYLER ROTH, PE
PLANNING CONTACT: GRACE WOLFF
3700 RIVER RD N, STE 1
KEIZER, OR 97303
PH: 503.400.6028
WWW.AKS-ENG.COM

ARCHITECT

INSIGHT ARCHITECTS
CONTACT: KRISTINA HELD, AIA, LEED AP BD+C, CPHC
1307 WEST MOREHEAD ST, STE 108
CHARLOTTE, NC 28208
PH: 704.344.0445

LANDSCAPE ARCHITECT

LANGO HANSEN LANDSCAPE ARCHITECT CONTACT: KYLE TRULEN, PLA, LEED AP 1100 NW GLISAN #3A, PORTLAND, OR 97209 PH: 971.380.3580

CONTRACT PURCHASER/APPLICANT

CONTACT: TRENT MICHELS 15017 THOMAS RD, CHARLOTTE, NC 28278

GEOTECHNICAL FIRM

CENTRAL GEOTECHNICAL SERVICES, LLC CONTACT: JULIO C. VELA, PHD, PE, GE 10240 SW NIMBUS AVE, STE L6 PORTLAND, OR 97223 PH: 503.994.0755

SHEET INDEX

P1 COVER SHEET

C002 EXISTING CONDITIONS PLAN
C003 EXISTING CONDITIONS PLAN

P4 TENTATIVE PLAT

P5 PRELIMINARY ONSITE DEMOLITION PLAN

PRELIMINARY TREE PRESERVATION AND REMOVAL PLAN

PRELIMINARY TREE TABLE

PRELIMINARY SITE PLAN

P9 PRELIMINARY ONSITE GRADING AND DRAINAGE PLAN


10 PRELIMINARY ONSITE GRADING AND DRAINAGE PLAN

P11 PRELIMINARY GRADING AND DRAINAGE SECTIONS

P12 PRELIMINARY COMPOSITE UTILITY PLAN

P13 PRELIMINARY FRONT ST IMPROVEMENTS

P14 CONCEPTUAL LOT 5 AND 6 UTILITY PLAN

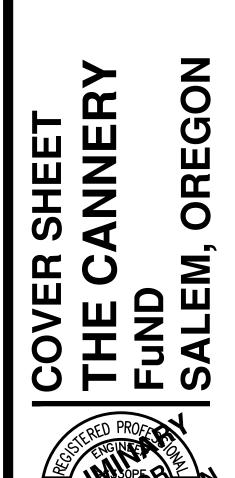


 DATE:
 07/26/2024

 DESIGNED BY:
 TDR

 DRAWN BY:
 MJM

 CHECKED BY:
 TDR

P1

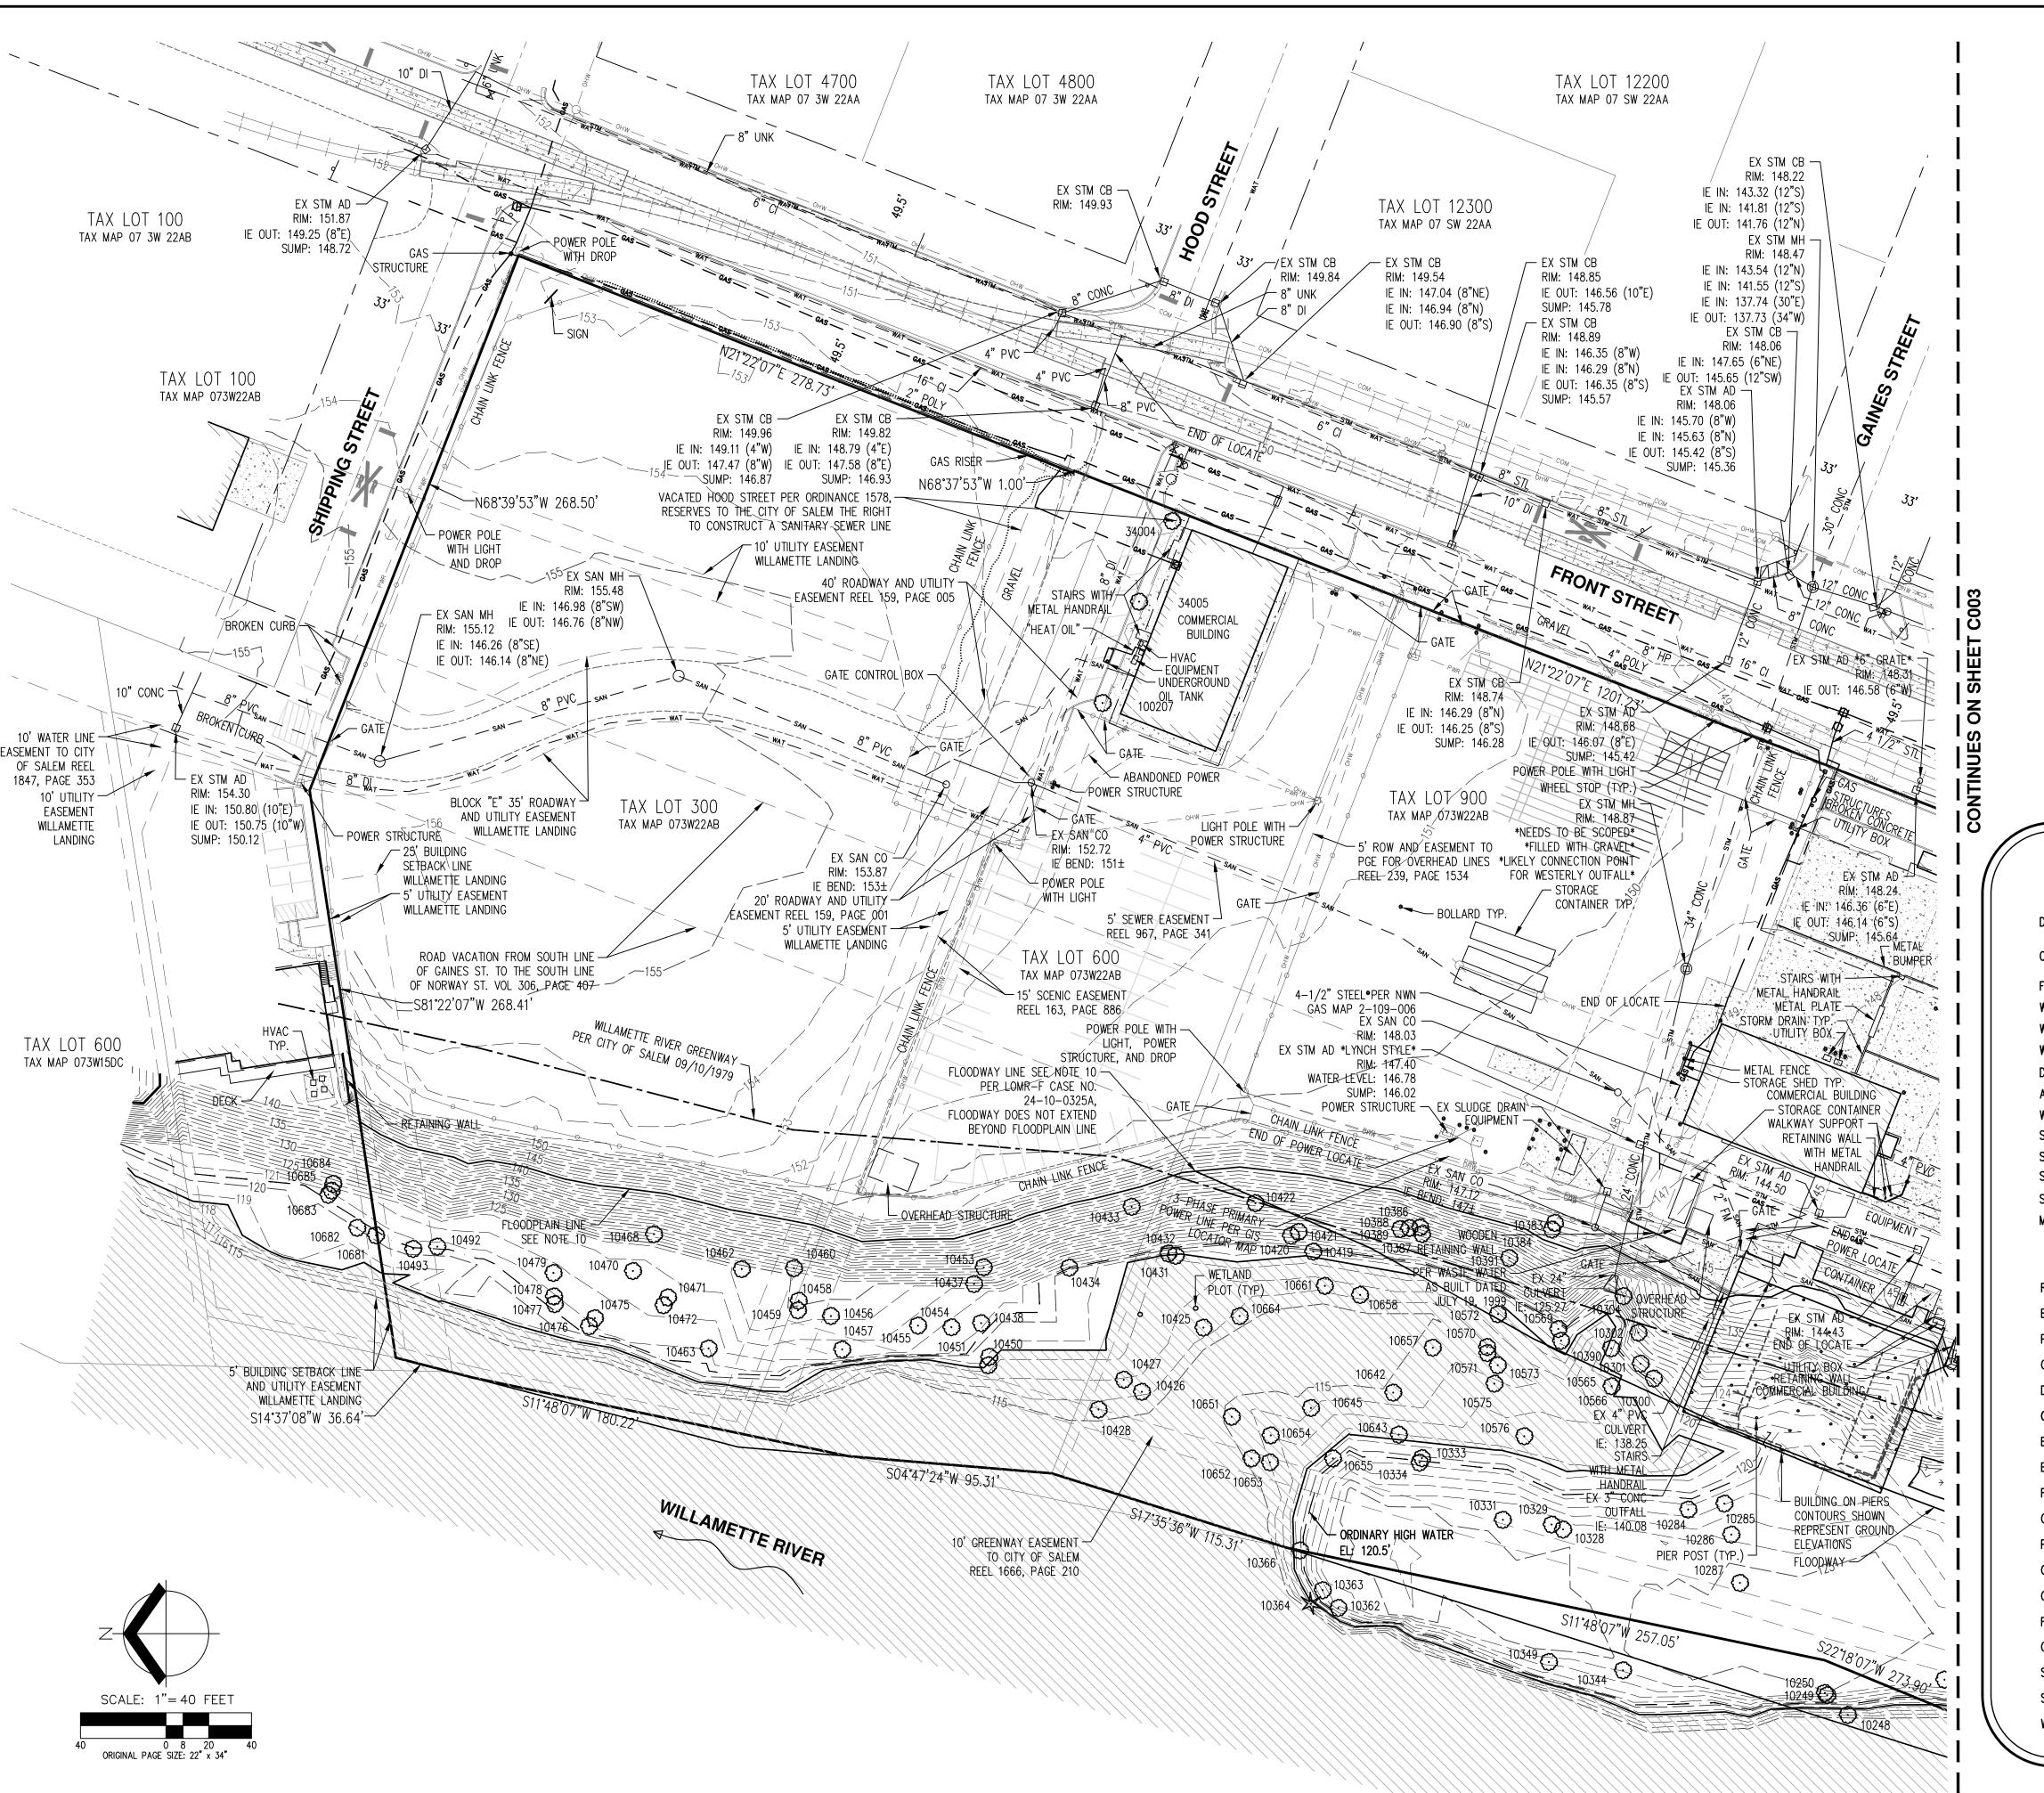



NOTE

1. UTILITIES SHOWN ARE BASED ON FIELD OBSERVATIONS AND LOCATE TICKET NUMBERS 23007190, 23007220, 23007221, 23007271, 23008701, 23008714, 23008722, 23008733, 23009893, 23009901, AND 23009993. THE SURVEYOR MAKES NO GUARANTEE THAT THE UNDERGROUND LOCATES REPRESENT THE ONLY UTILITIES IN THE AREA. CONTRACTORS ARE RESPONSIBLE FOR VERIFYING ALL EXISTING CONDITIONS PRIOR TO BEGINNING CONSTRUCTION.

- 2. FIELD WORK WAS CONDUCTED NOVEMBER 16 TO DECEMBER 12, 2017 AND JANUARY 18 TO JUNE 22, 2023.
- 3. VERTICAL DATUM: ELEVATIONS ARE BASED ON CITY OF SALEM BENCHMARK NO. 1151, LOCATED AT THE SE CORNER OF SUMMER AND MARION ST. ELEVATION = 161.617 FEET (NGVD 29).
- 4. HORIZONTAL DATUM: A LOCAL DATUM PLANE DERIVED FROM STATE PLANE OREGON NORTH 3601 NAD83(2011) EPOCH 2010.00 BY MULTIPLYING BY A PROJECT MEAN GROUND COMBINED SCALE FACTOR OF 1.0001017696 AT A CENTRAL PROJECT POINT WITH INTERNATIONAL FEET STATE PLANE GRID COORDINATES N: 479251.50515 E: 7545303.43662 AND A MERIDIAN CONVERGENCE ANGLE OF -1*47*59*. STATE PLANE COORDINATES WERE DERIVED FROM GPS OBSERVATIONS USING THE TRIMBLE VRS NOW NETWORK. DISTANCES SHOWN ARE INTERNATIONAL FEET GROUND VALUES.
- 5. THIS MAP DOES NOT CONSTITUTE A PROPERTY BOUNDARY SURVEY.
- 6. SURVEY IS ONLY VALID WITH SURVEYOR'S STAMP AND SIGNATURE.
- 7. BUILDING FOOTPRINTS ARE MEASURED TO SIDING UNLESS NOTED OTHERWISE. CONTACT SURVEYOR WITH QUESTIONS REGARDING BUILDING TIES.
- 8. CONTOUR INTERVAL IS 1 FOOT.
- 9. TREES WITH DIAMETER OF 10" AND GREATER ARE SHOWN. TREE DIAMETERS WERE DETERMINED BY VISUAL INSPECTION. TREE INFORMATION IS SUBJECT TO CHANGE UPON ARBORIST INSPECTION.
- 10. FLOODWAY IS SHOWN BY GRAPHICAL OVERLAY OF FEMA FIRMETTE MAP 41047C0333H WITH AN EFFECTIVE DATE OF JANUARY 2, 2003. ZONE AE IS SHOWN BY MAPPING THE BASE FLOOD ELEVATION (BFE) OF 141.1 (NGVD 29). BFE IS PER FLOOD INSURANCE STUDY FOR THE WILLAMETTE RIVER, MARION COUNTY, WITH EFFECTIVE DATE OF OCTOBER 10, 2019. CASE NO. 24-10-0325A

LEGEND

<u>EX</u>	<u>ISTING</u>		EXISTIN
DECIDUOUS TREE	\odot	STORM SEWER CLEAN OUT	0
	M	STORM SEWER CATCH BASIN	
CONIFEROUS TREE	77	STORM SEWER AREA DRAIN	
FIRE HYDRANT	Q	STORM SEWER MANHOLE	
WATER BLOWOFF	Ŷ	GAS METER	O
WATER METER		GAS VALVE	Ø
WATER VALVE	M	GUY WIRE ANCHOR	\leftarrow
DOUBLE CHECK VALVE	\boxtimes	UTILITY POLE	-0-
AIR RELEASE VALVE	۶ [°]	POWER VAULT	Р
WATER MANHOLE	0	POWER JUNCTION BOX	
SANITARY SEWER CLEAN OUT	0	POWER PEDESTAL	
SANITARY SEWER MANHOLE	0	COMMUNICATIONS VAULT	C
SIGN	-	COMMUNICATIONS JUNCTION BOX	\triangle
STREET LIGHT	¢	COMMUNICATIONS RISER	\bigcirc
MAILBOX	[MB]		

RIGHT-OF-WAY LINE		<u>EXISTING</u>	
BOUNDARY LINE			
PROPERTY LINE			
CENTERLINE			
DITCH		->	> -
CURB			
EDGE OF PAVEMENT			
EASEMENT			
FENCE LINE	-00	0 0	
GRAVEL EDGE			
POWER LINE		—— PWR —— —— ——	PWR
OVERHEAD WIRE		— онw — — —	— ОНW —
COMMUNICATIONS LINE		COM	— сом —
FIBER OPTIC LINE		— CFO — — —	- CFO
GAS LINE		— GAS — — —	GAS
STORM SEWER LINE		— stm — — —	— sтм —
SANITARY SEWER LINE		— SAN — — —	SAN
WATER LINE		wat	- — WAT —

G · SURVEYING · NATURAL

AKS ENGINEERING & 3700 RIVER RD N, S KEIZER, OR 97303 503.400.6028 WWW.AKS-ENG.COM

OREGO!

D

3

SALEM 1X LOTS 200, 300, 600, AI

SNDITIONS NN

ISTING CONF

DESIGNED BY: -
DRAWN BY: TJA/AC/NJS

MANAGED BY: DGH/AK/RB

CHECKED BY: BRH

DATE: 7/25/2024


REGISTERED
PROFESSIONAL
LAND SURVEYOR

OREGON
MARCH 14, 2017
BENJAMIN R HUFF
84738PLS
RENEWS: 6/30/25

IOD MILIMPED

JOB NUMBER 5968-01

SHEET **C002**

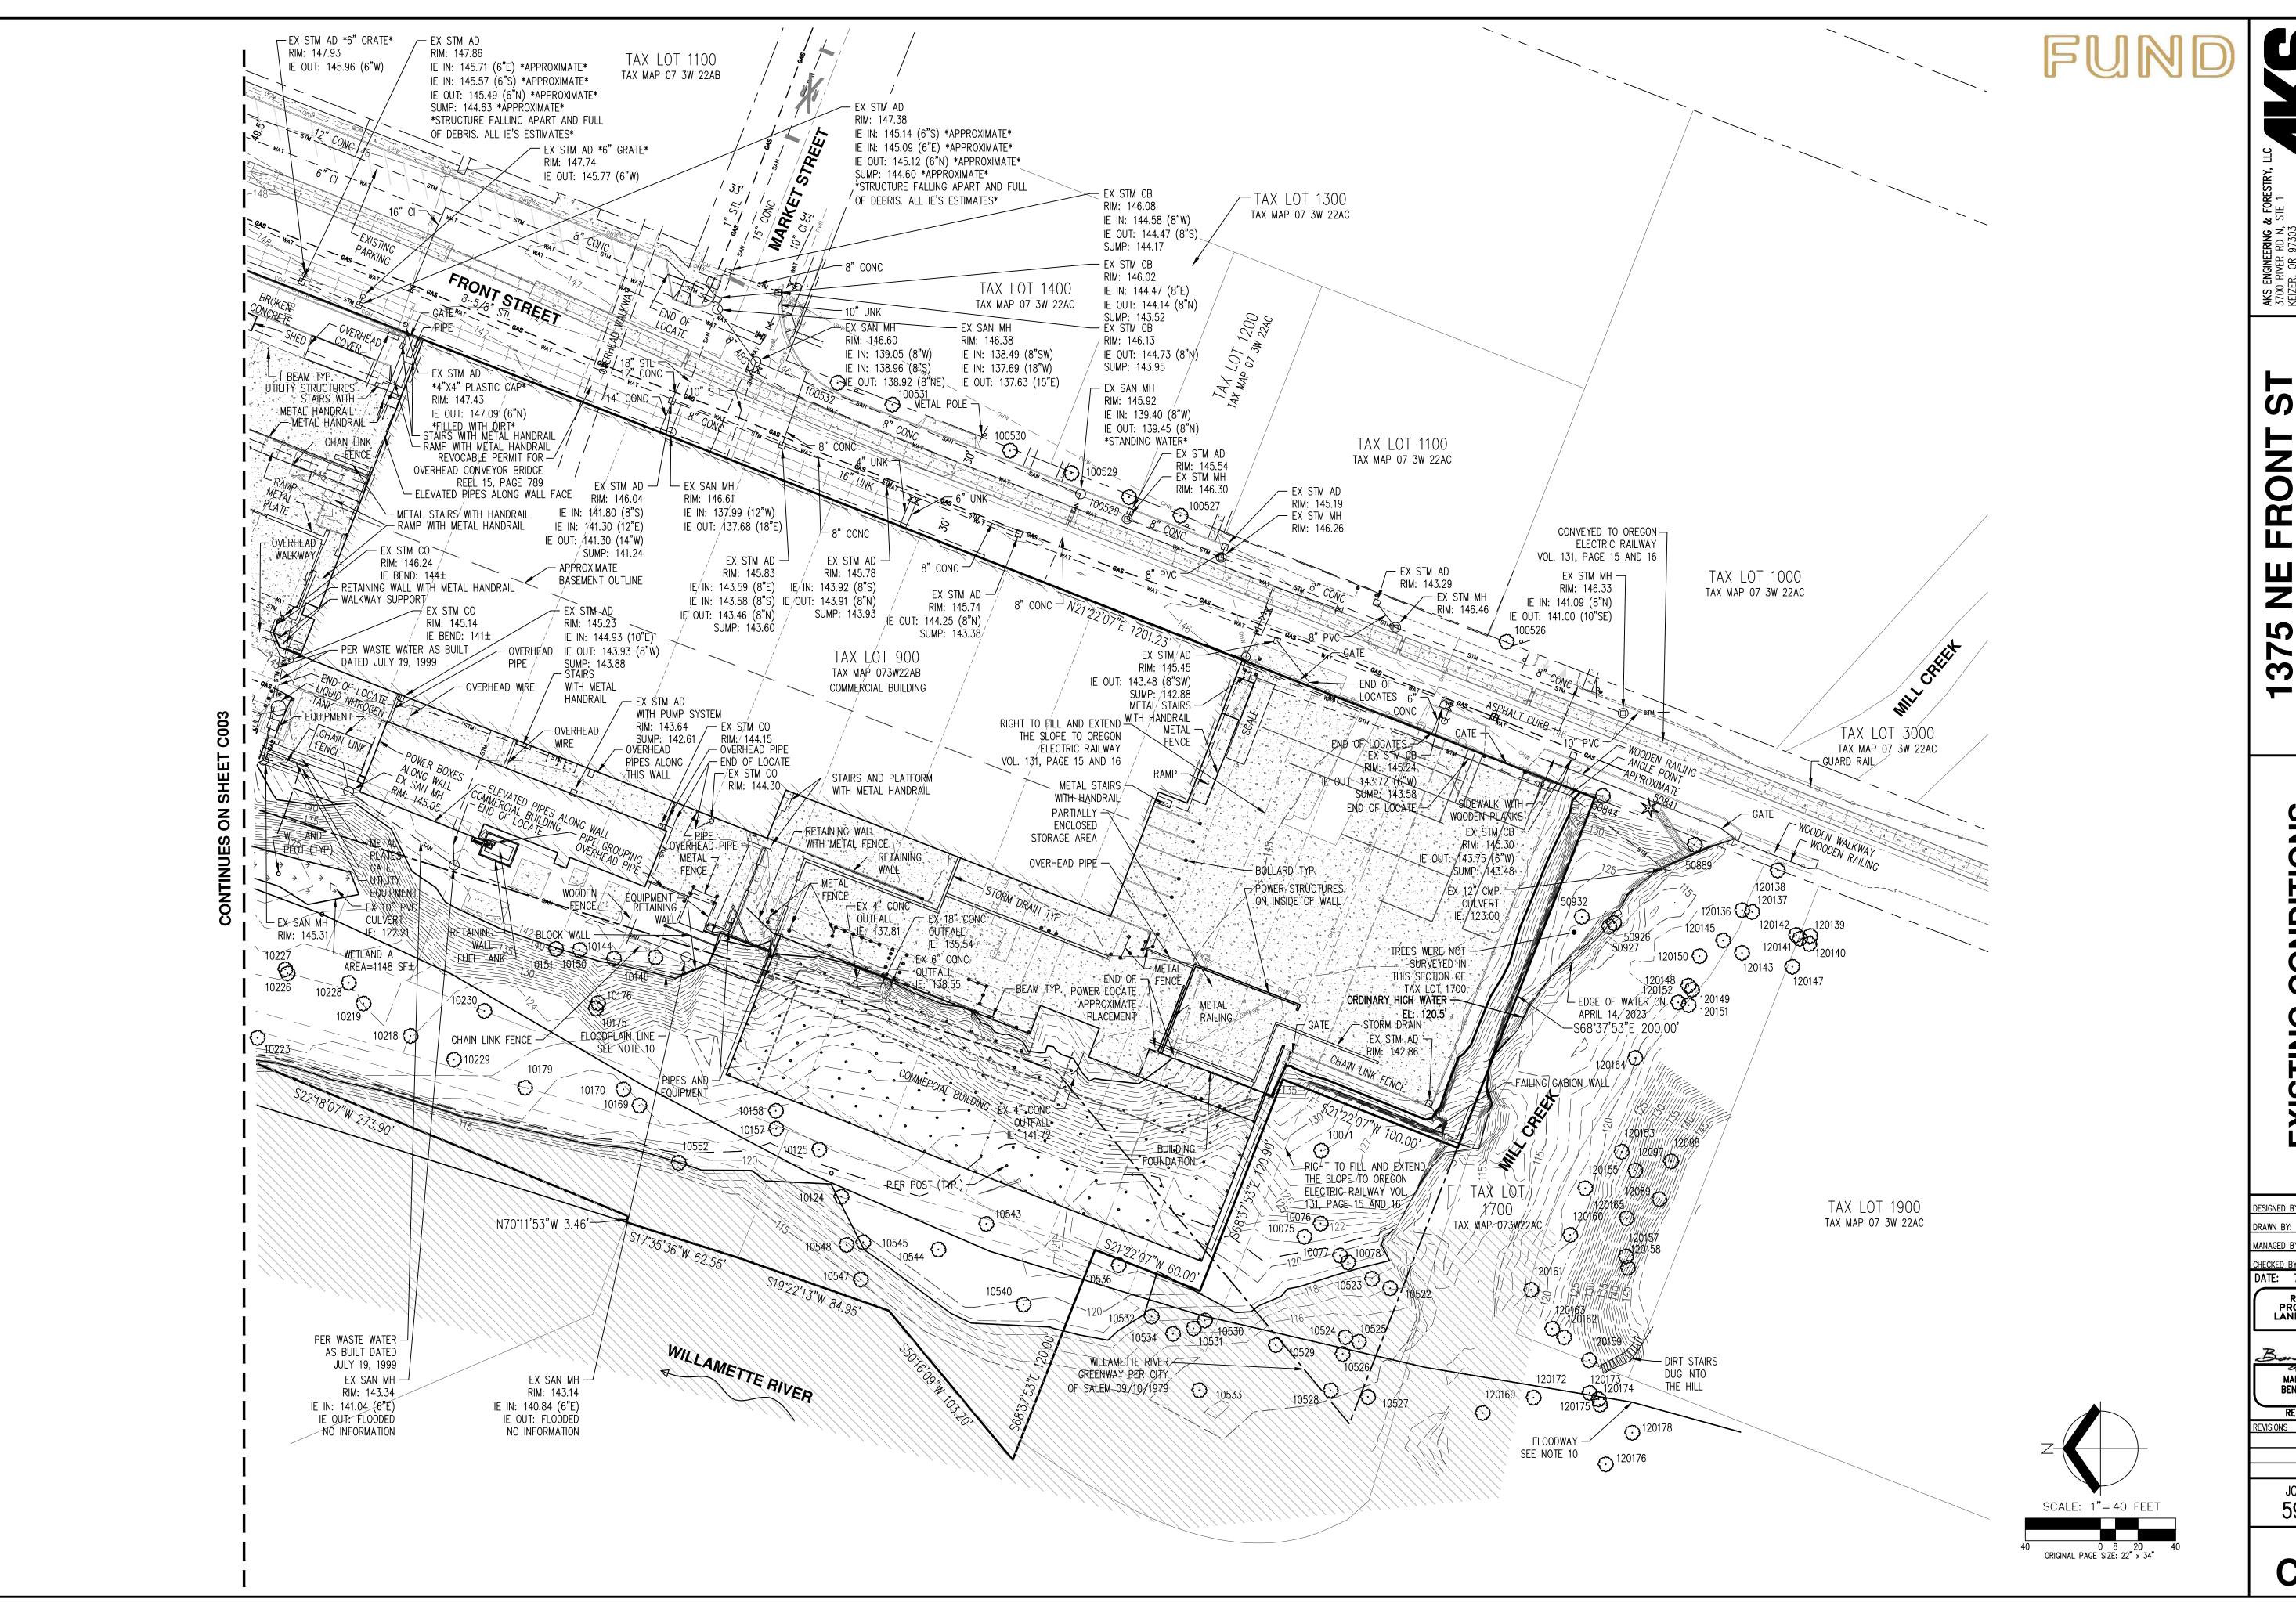

AKS 3700 KEIZE 503.4 WWW.

C

O E NA AN O Ž


TJA/AC/NJS DGH/AK/RE MANAGED BY: DATE: 7/25/2024

REGISTERED PROFESSIONAL LAND SURVEYOR

OREGON
MARCH 14, 2017
BENJAMINE 84738PLS RENEWS: 6/30/25

JOB NUMBER 5968-01

SHEET C003

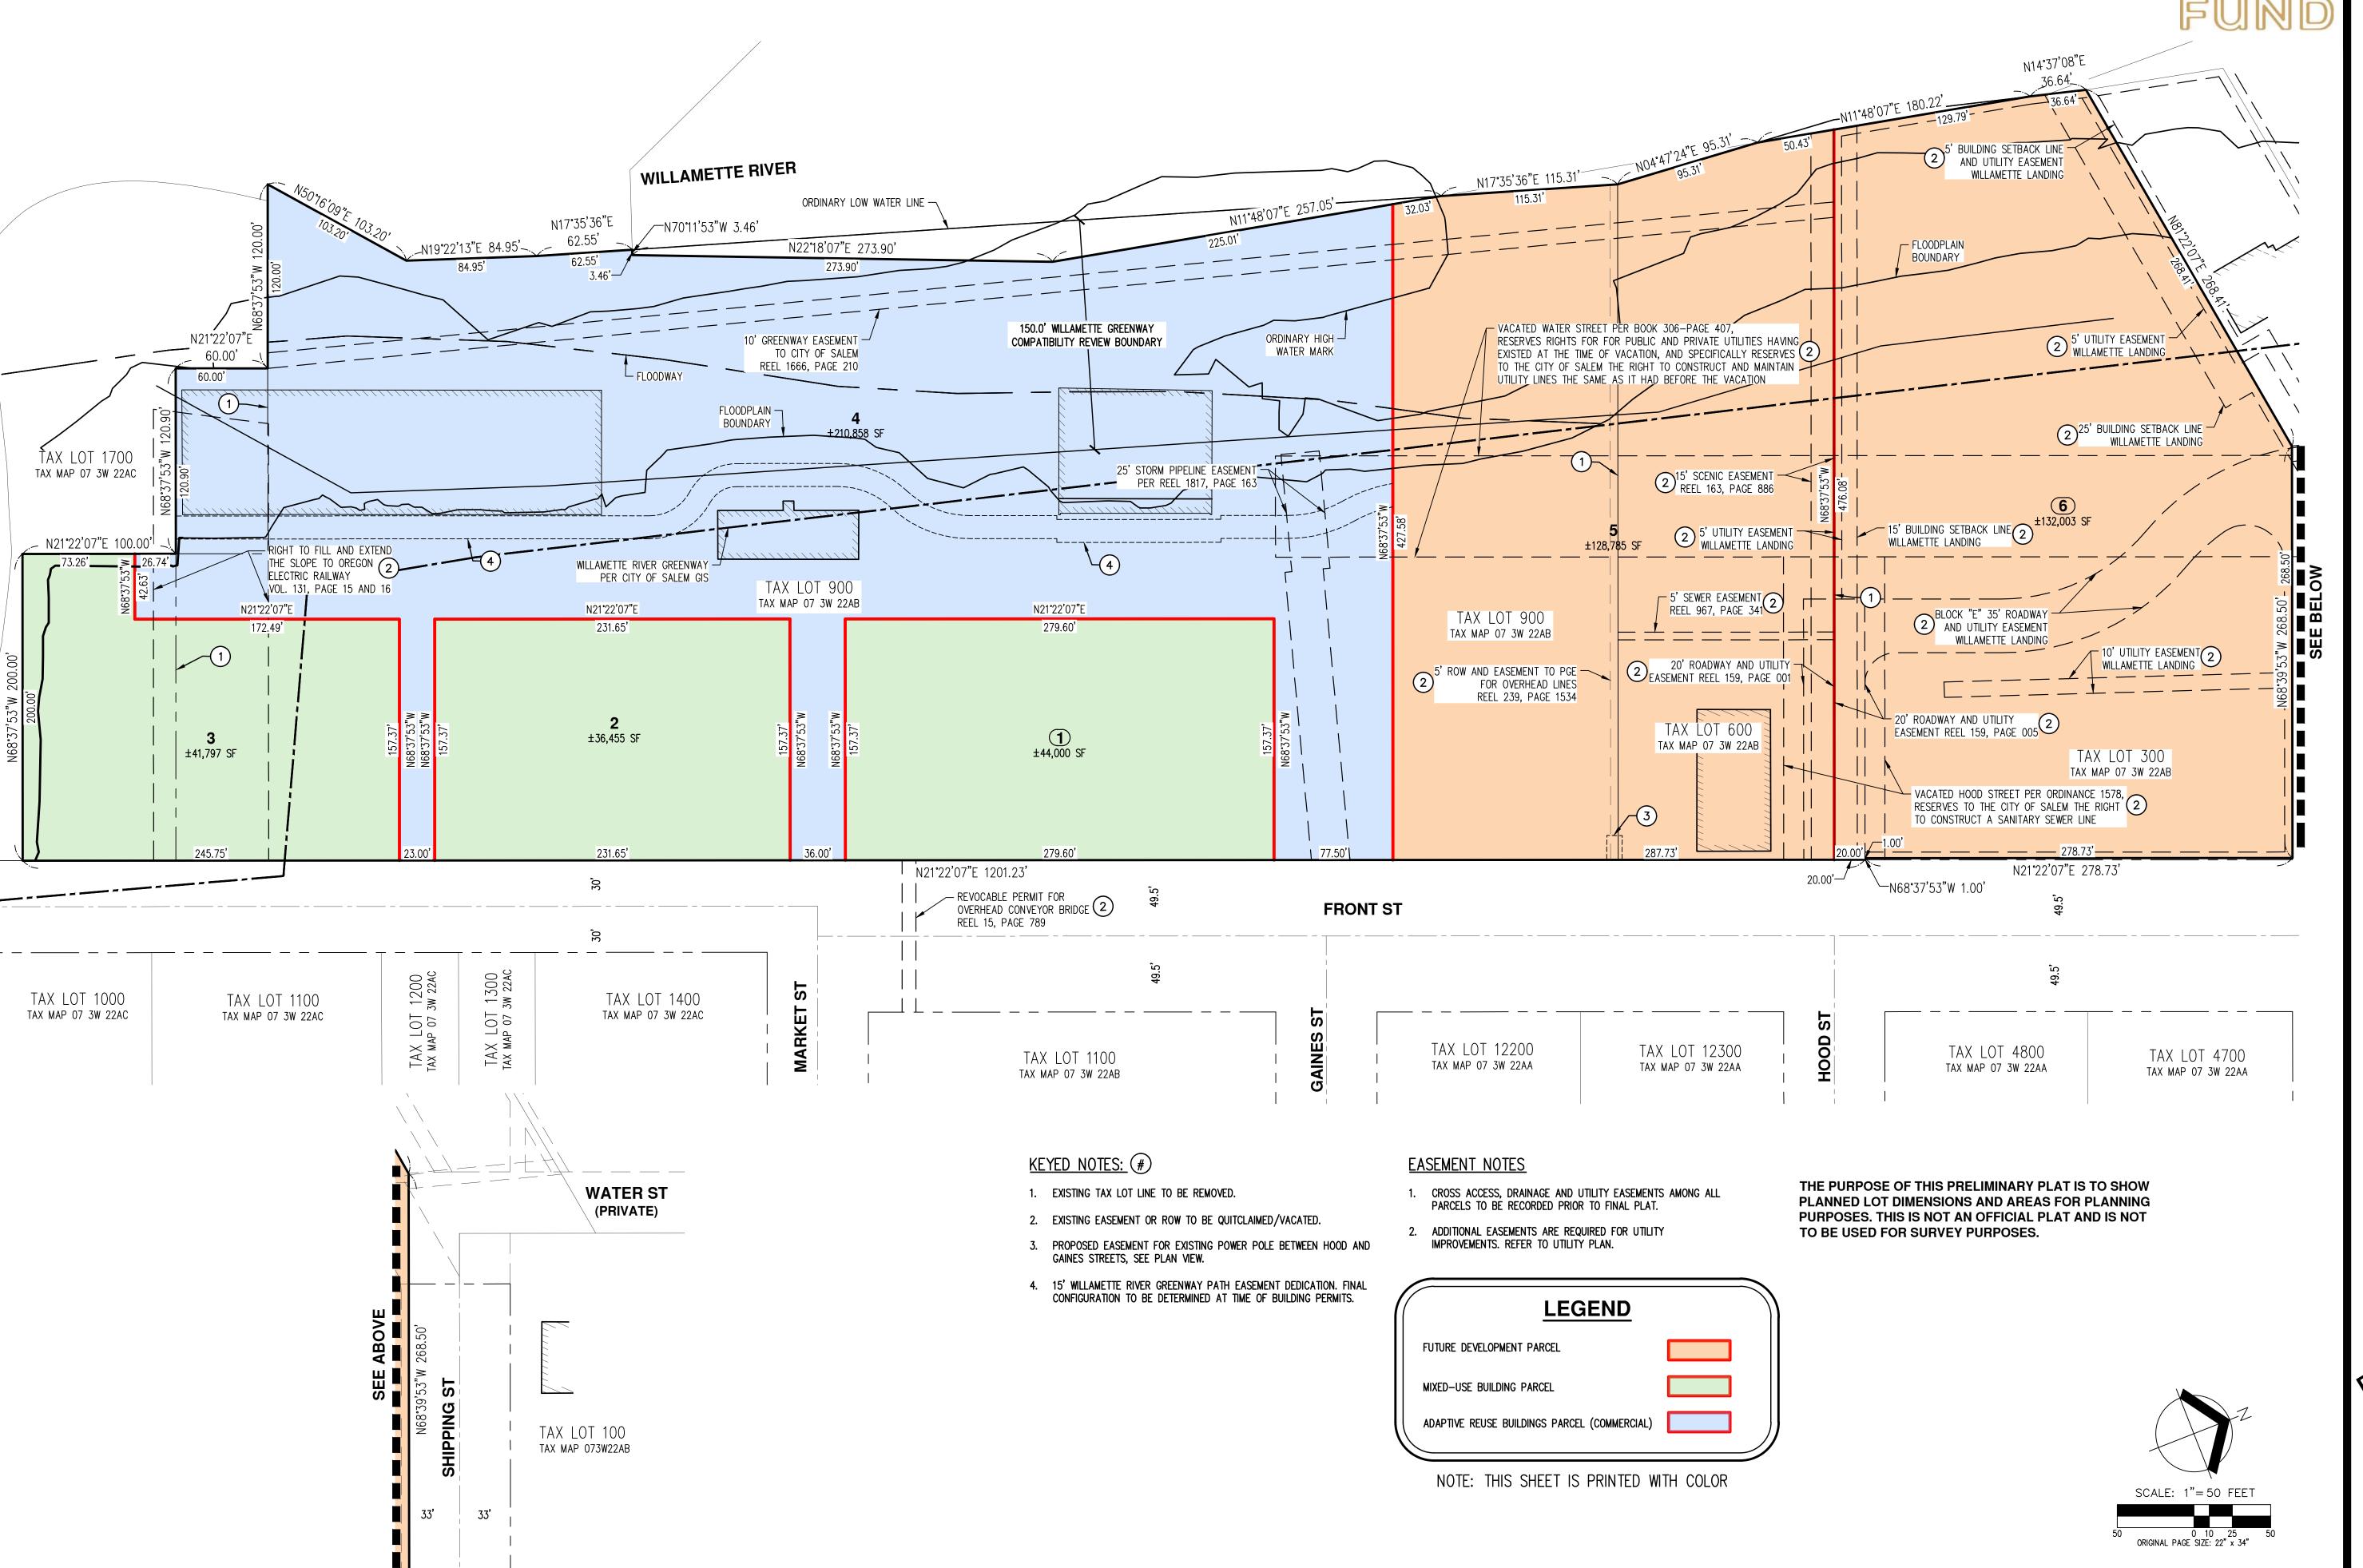

R RD N, STE 1
8 97303
97303
128
ENG.COM
STRING · SURVEYING · NATURAL RESOURCES
RY · PLANNING · LANDSCAPE ARCHITECTURE

3700 RIVER RD N, STE 1 KEIZER, OR 97303 503.400.6028 WWW.AKS-ENG.COM

> IAX LOTS 300, 500, 900 CONTRACT PURCHASER: Fund 15017 THOMAS RD, CHARLOTTE, NC 28278

TENTATIVE PLAT
THE CANNERY
FUND

PROFITE OF PROFITE OF

JOB NUMBER:5968-01DATE:07/26/2024DESIGNED BY:TDRDRAWN BY:MJMCHECKED BY:TDR


P4


EMOLITION PL

07/26/2024

P5



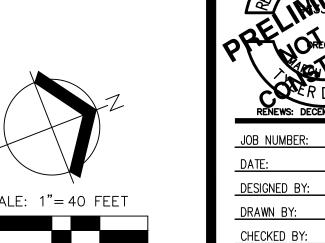

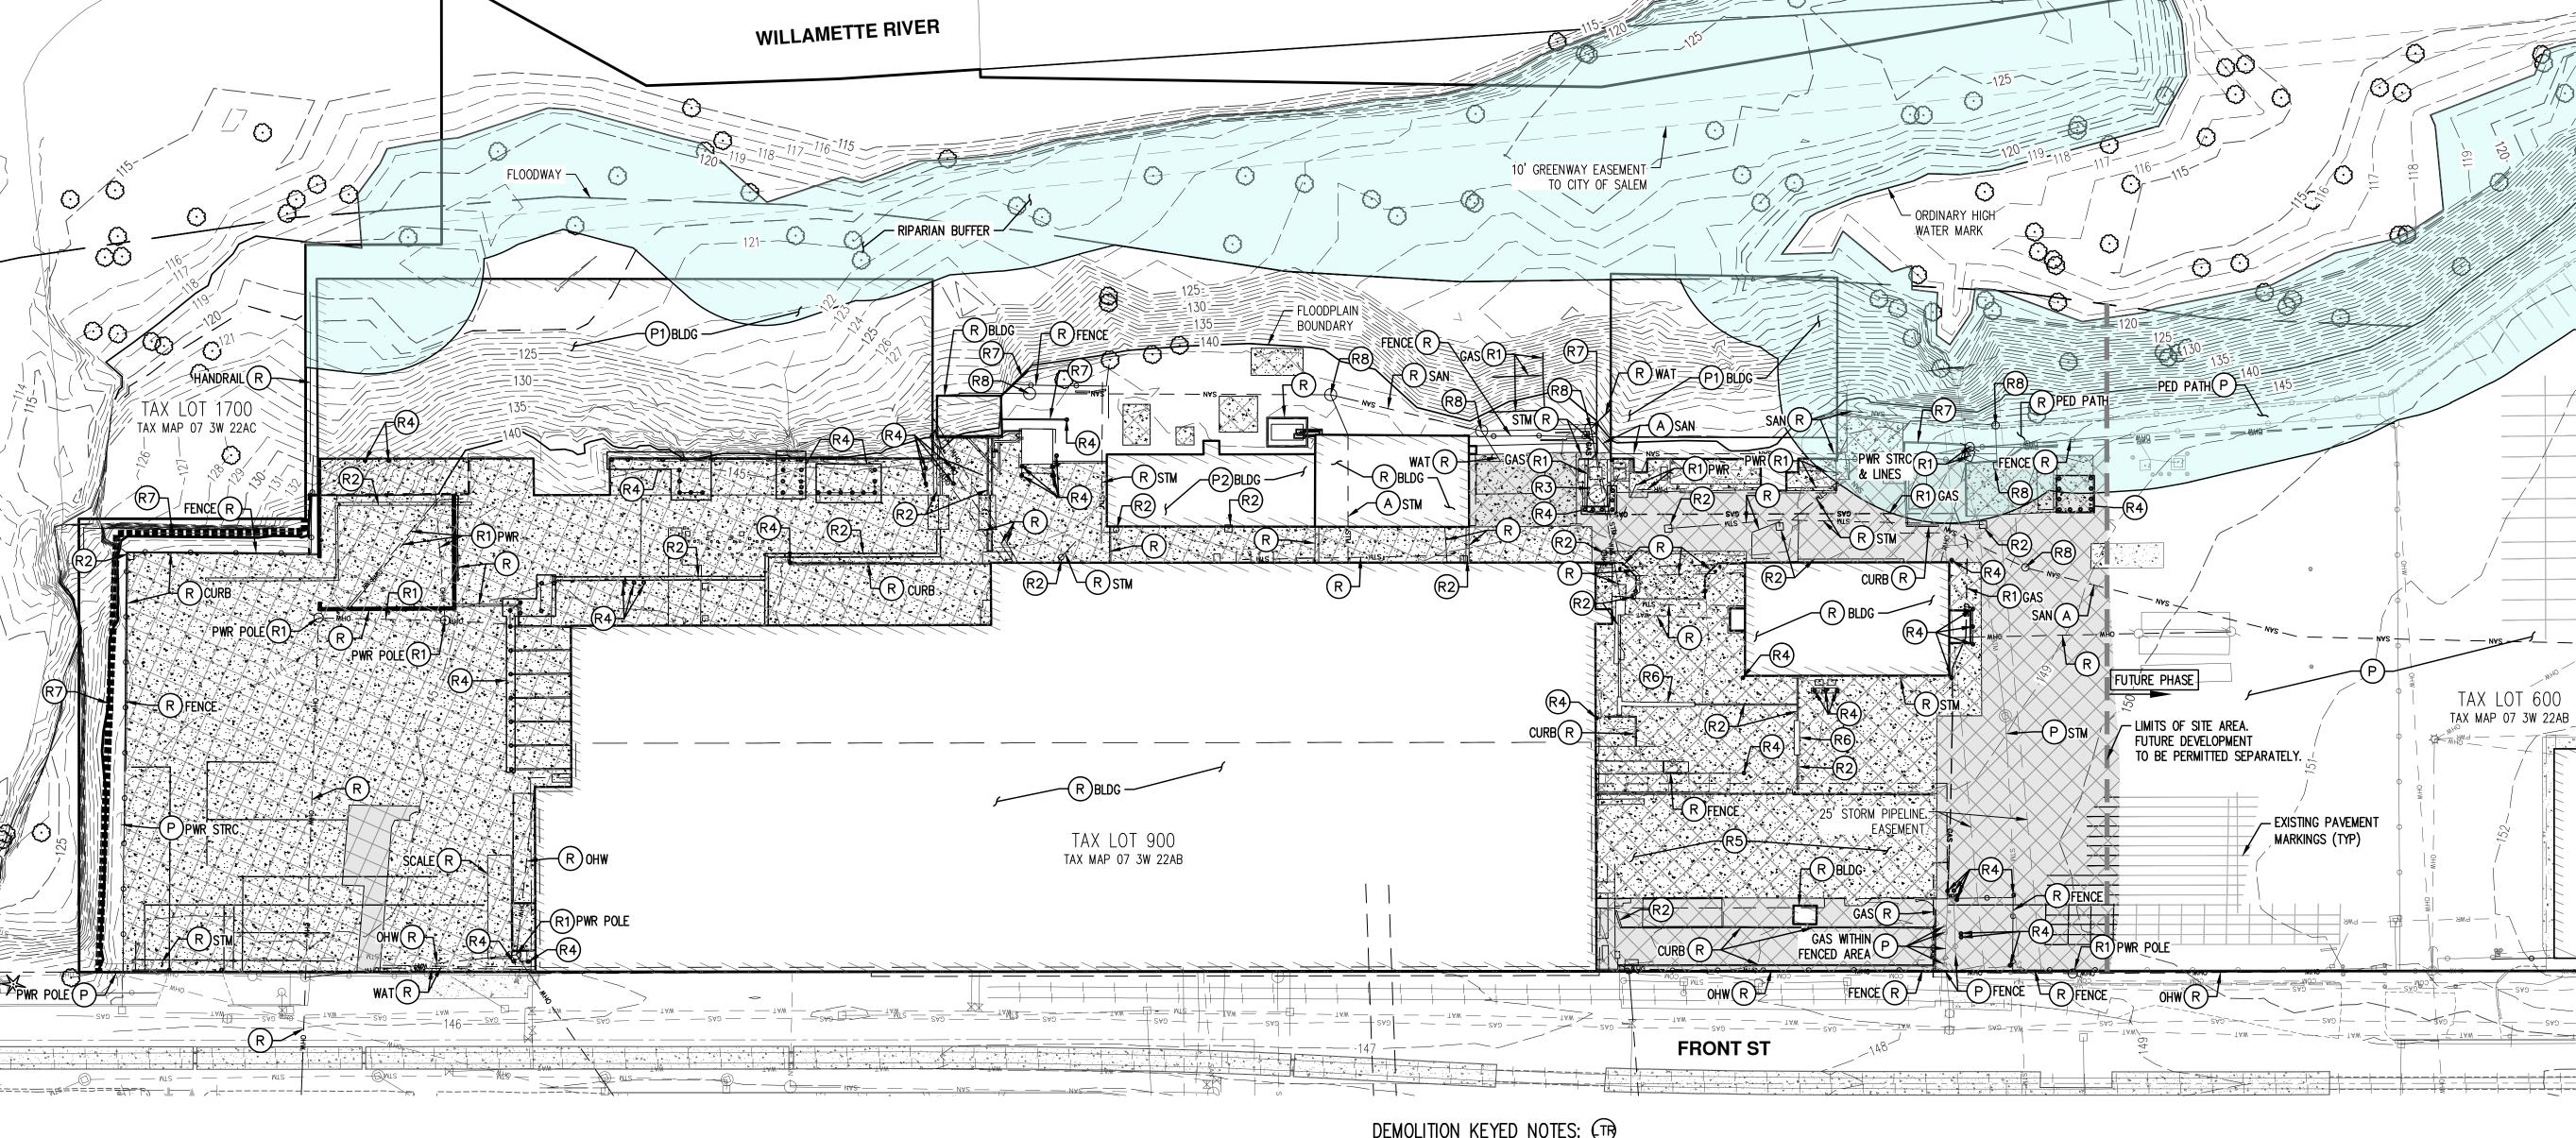

DEMOLITION KEYED NOTES: (TR)

- A PLUG, ABANDON, AND/OR REMOVE EXISTING UTILITY LINES PER CITY AND/OR UTILITY COMPANY STANDARDS.
- PROTECT AT ALL TIMES DURING CONSTRUCTION. ADJUST TO NEW FINISHED GRADE AS REQUIRED. ANY DAMAGE SHALL BE REPAIRED AT CONTRACTOR'S EXPENSE.
- P1 REMOVE EXISTING WALLS AND PROTECT THE PIER AND PLATFORM. REFER TO BUILDING PLANS FOR BUILDING AND STRUCTURAL IMPROVEMENTS.
- P2 REFER TO BUILDING PLANS FOR BUILDING IMPROVEMENTS.
- R CONTRACTOR TO REMOVE AND HAUL OFF SITE FOR DISPOSAL.
- R1 COORDINATE WITH FRANCHISE UTILITY PROVIDER FOR RELOCATION/REMOVAL. IF NO RELOCATION IS REQUIRED CONTRACTOR SHALL PROTECT AT ALL TIMES DURING CONSTRUCTION.
- R2 REMOVE EXISTING STORM STRUCTURE AND HAUL OFF SITE FOR DISPOSAL.
- R3 REMOVE EXISTING NITROGEN TANK. REMOVE AND DECOMMISSION IN ACCORDANCE WITH APPLICABLE STATE REGULATIONS.
- R4 REMOVE EXISTING BOLLARDS AND ATTACHED STRUCTURES.
- R5 REMOVE EXISTING COVERED AREA. METAL TRUSSES TO BE SAVED FOR future reuse.
- R6 REMOVING EXISTING METAL PLATE.
- R7 EXISTING RETAINING WALL. STRUCTURAL IMPROVEMENTS REQUIRED TO BE DETERMINED AT TIME OF BUILDING PERMIT.
- R8 REMOVE EXISTING SANITARY STRUCTURE AND PUMP STATION. HAUL OFF SITE FOR DISPOSAL IN ACCORDANCE WITH STATE REGULATIONS.

EXISTING GROUND CONTOUR (1 FT) EXISTING GROUND CONTOUR (5 FT) — — ·150· — — — 公分 EXISTING TREE TO REMAIN

LEGEND

EXISTING PAVEMENT/CONCRETE TO BE REMOVED

/Ó

PROPERTY DESCRIPTION
TAX MAP 07.3W.22AB
TAX LOTS 300, 600, 900
CONTRACT PURCHASER:
Fund
15017 THOMAS RD,
CHARLOTTE, NC 28278

PRES TREE CANNERY

JOB NUMBER: 07/26/2024 DESIGNED BY: DRAWN BY: CHECKED BY:

P6

JOB NUMBER:	5968-0°
DATE:	07/26/2024
DESIGNED BY:	TDR
DRAWN BY:	MJW
CHECKED BY:	TDR
	•

P7

TREE TABLE					
TREE NUMBER	TYPE	DBH (IN.)	PRESERVE/REMOVE		
10071	DECIDUOUS	19 18	PRESERVE		
10075	DECIDUOUS	12	PRESERVE		
10076	DECIDUOUS	24	PRESERVE		
10077	DECIDUOUS	30	PRESERVE		
10078	DECIDUOUS	34	PRESERVE		
10124	DECIDUOUS	13	PRESERVE		
10125	DECIDUOUS	16	PRESERVE		
10144	DECIDUOUS	27	PRESERVE		
10146	DECIDUOUS	24	PRESERVE		
10150	DECIDUOUS	22	PRESERVE		
10151	DECIDUOUS	26	PRESERVE		
10157	DECIDUOUS	15 11	PRESERVE		
10158	DECIDUOUS	59	PRESERVE		
10169	DECIDUOUS	15	PRESERVE		
10170	DECIDUOUS	47	PRESERVE		
10175	DECIDUOUS	12	PRESERVE		
10176	DECIDUOUS	13 11	PRESERVE		
10179	DECIDUOUS	12	PRESERVE		
*10193	DECIDUOUS	22	REMOVE		
10218	DECIDUOUS	12	PRESERVE		
10219	DECIDUOUS	41	PRESERVE		
10223	DECIDUOUS	11 10	PRESERVE		
10226	DECIDUOUS	15	PRESERVE		
10227	DECIDUOUS	12	PRESERVE		
10228	DECIDUOUS	12 10	PRESERVE		
10229	DECIDUOUS	14	PRESERVE		
10230	DECIDUOUS	11	PRESERVE		
10284	DECIDUOUS	39	PRESERVE		
10285	DECIDUOUS	17	PRESERVE		
10286	DECIDUOUS	10	PRESERVE		
10287	DECIDUOUS	13	PRESERVE		
10300	DECIDUOUS	52	PRESERVE		
10301	DECIDUOUS	54	PRESERVE		
10302	DECIDUOUS	19	PRESERVE		
10304	DECIDUOUS	20 18	PRESERVE		
10328	DECIDUOUS	16 12	PRESERVE		
10329	DECIDUOUS	15	PRESERVE		
10331	DECIDUOUS	42	PRESERVE		
10333	DECIDUOUS	43	PRESERVE		
10334	DECIDUOUS	10	PRESERVE		
10383	DECIDUOUS	18 17	PRESERVE		

NOTE:

* REMOVAL NECESSARY TO ACCOMMODATE PUBLIC WILLAMETTE RIVER GREENWAY TRAIL, EXEMPT PER SRC 808.030(a)(2)(G).

TREE TABLE

TYPE

DECIDUOUS

TREE NUMBER

10384

*10385

10390

10391

10522

10524

10525

10526

10527

10528

10529

10530

10531

10532

10534

10536

10540

10543

10544

10545

10547

10548

10552

10566

10569

10570

10571

10572

10573

10576

*20090

*20091

*20092

50844

50932

DBH (IN.)

15

26 21

UNK

13

28 23 16

34

32

36

44

15 14

11

40

17

42

41

12

10

44

14 11

40

11

13 10

11 11

16

52

73

17

17

10

15

11

27

23

27

8 12 14

30

DECIDUOUS | 28 22 21 19 16 11

DECIDUOUS | 19 14 14 13 12 12

PRESERVE/REMOVE

PRESERVE

REMOVE

PRESERVE

PRESERVE

PRESERVE


REMOVE

REMOVE

REMOVE

PRESERVE

PRESERVE

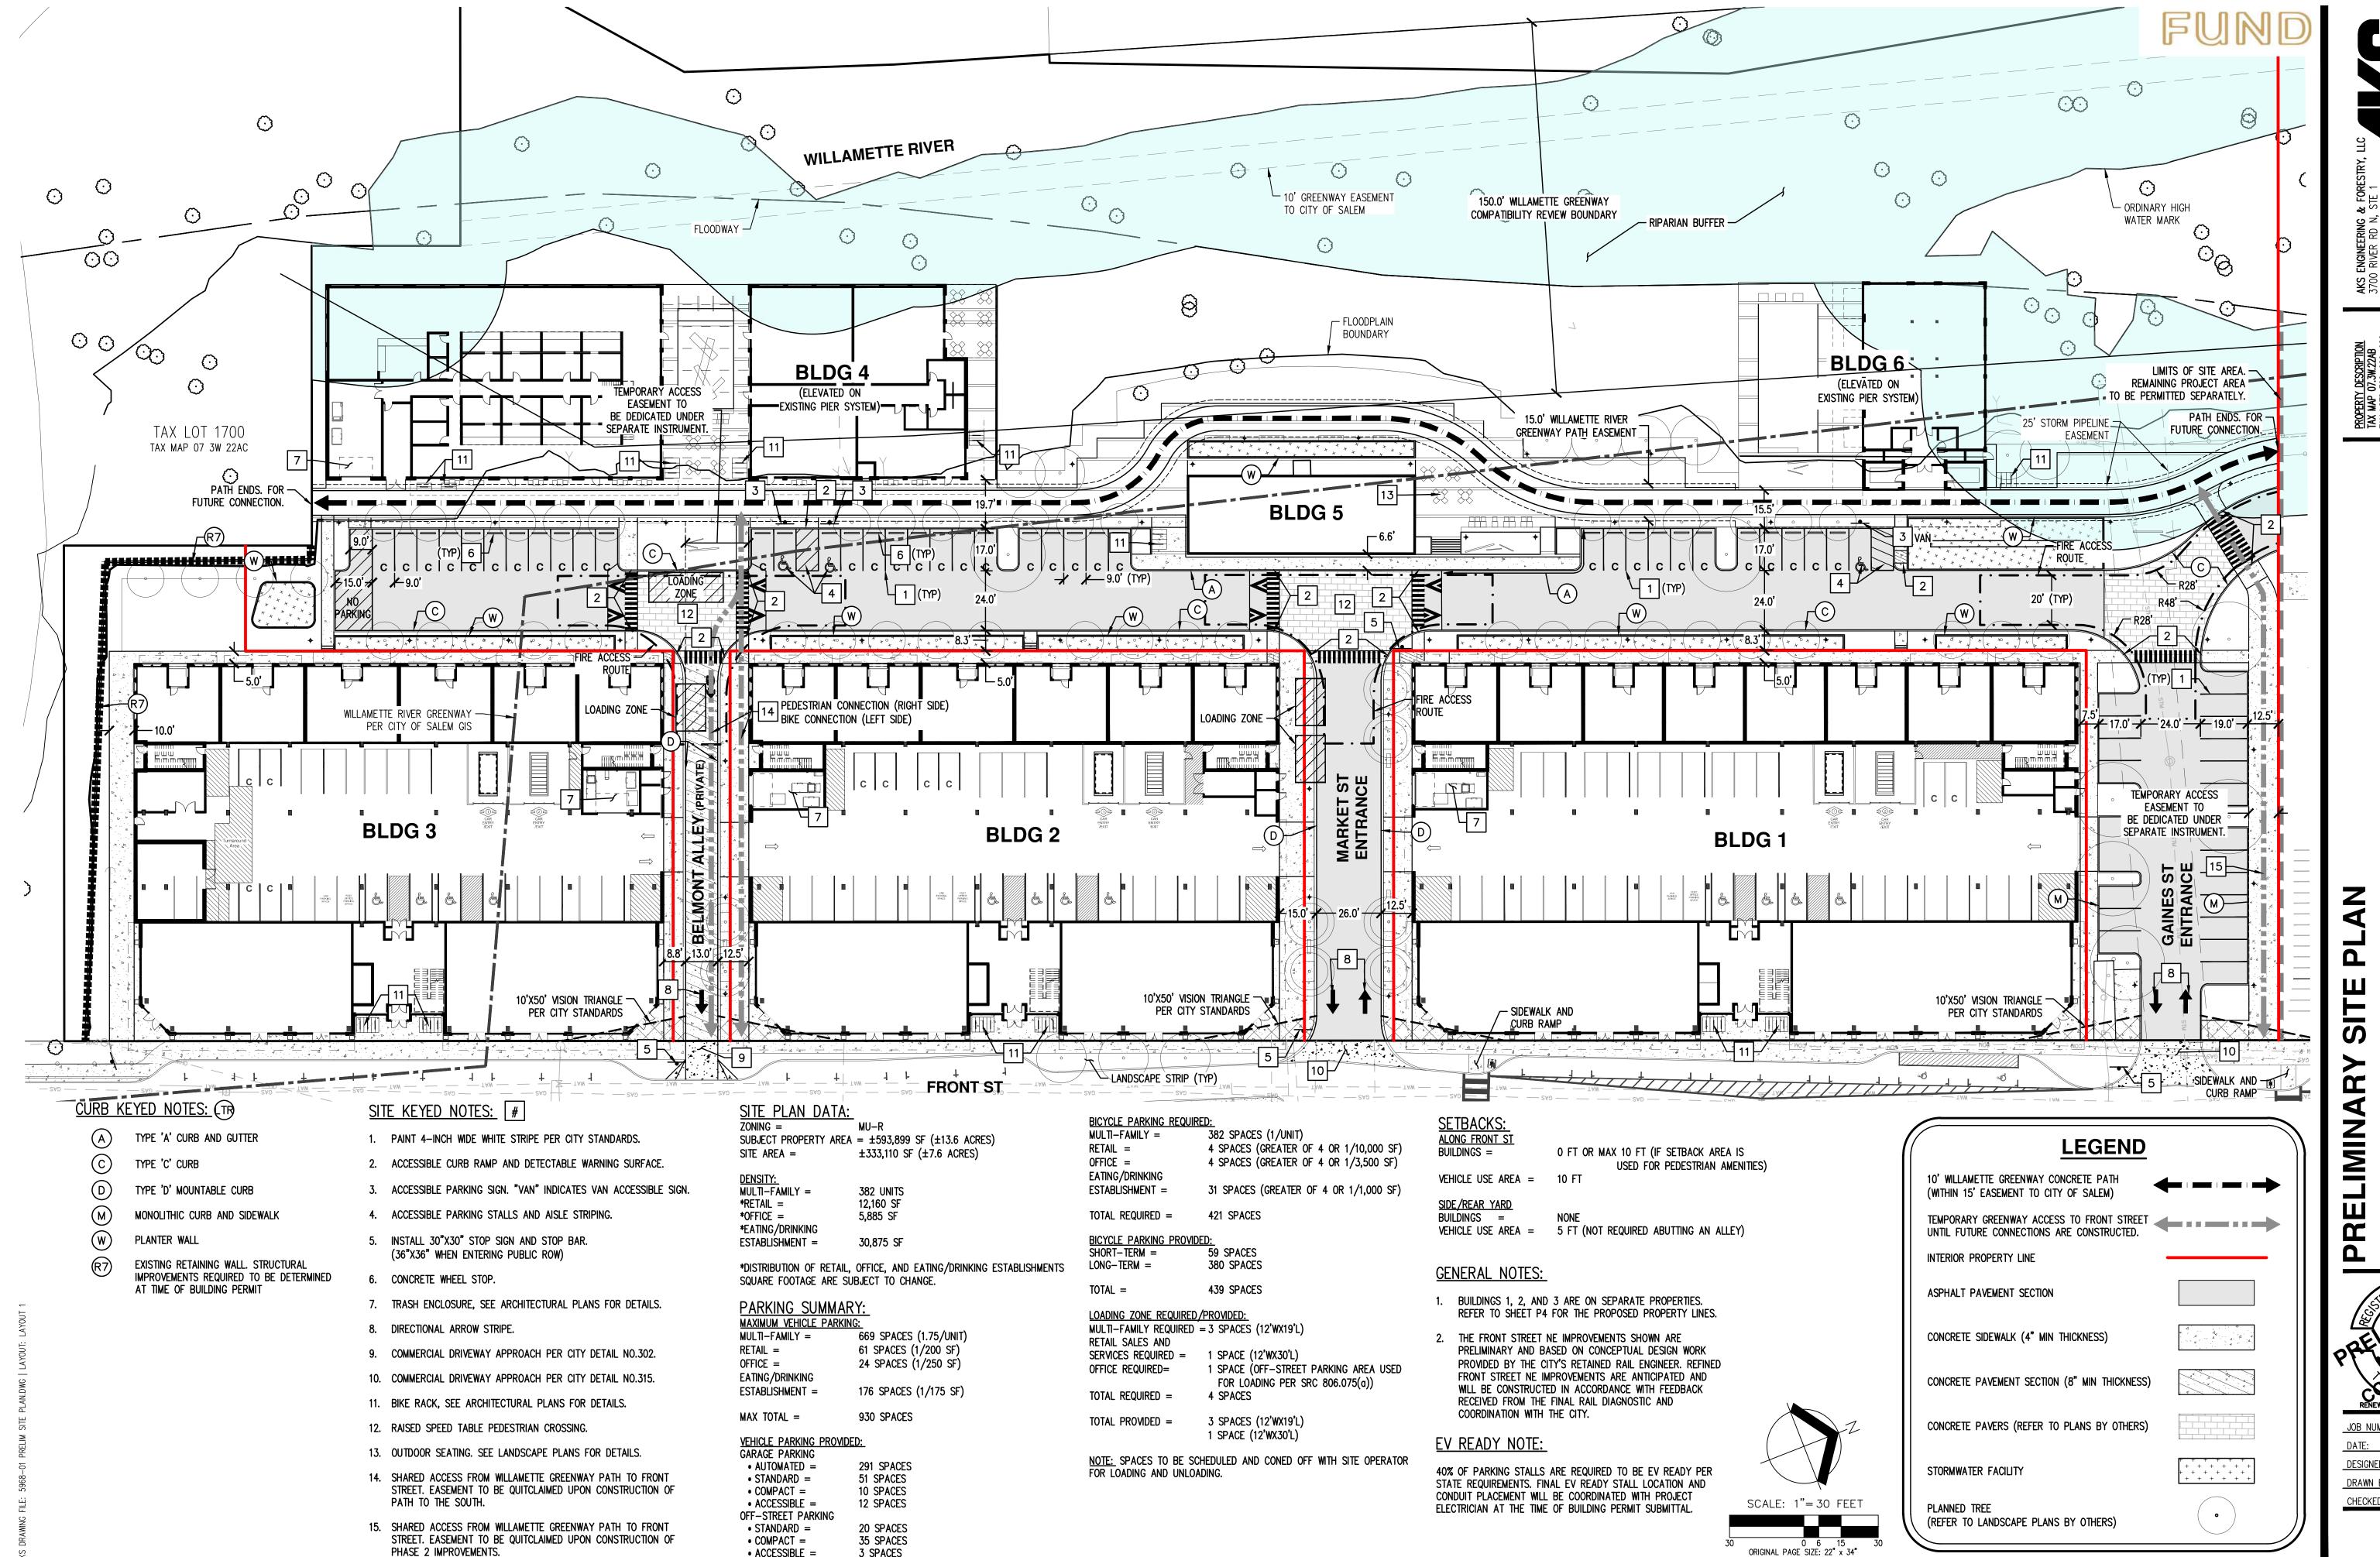

• ACCESSIBLE =


TOTAL PARKING =

3 SPACES

422 SPACES

JOB NUMBER:

07/26/2024 DESIGNED BY: DRAWN BY: CHECKED BY:

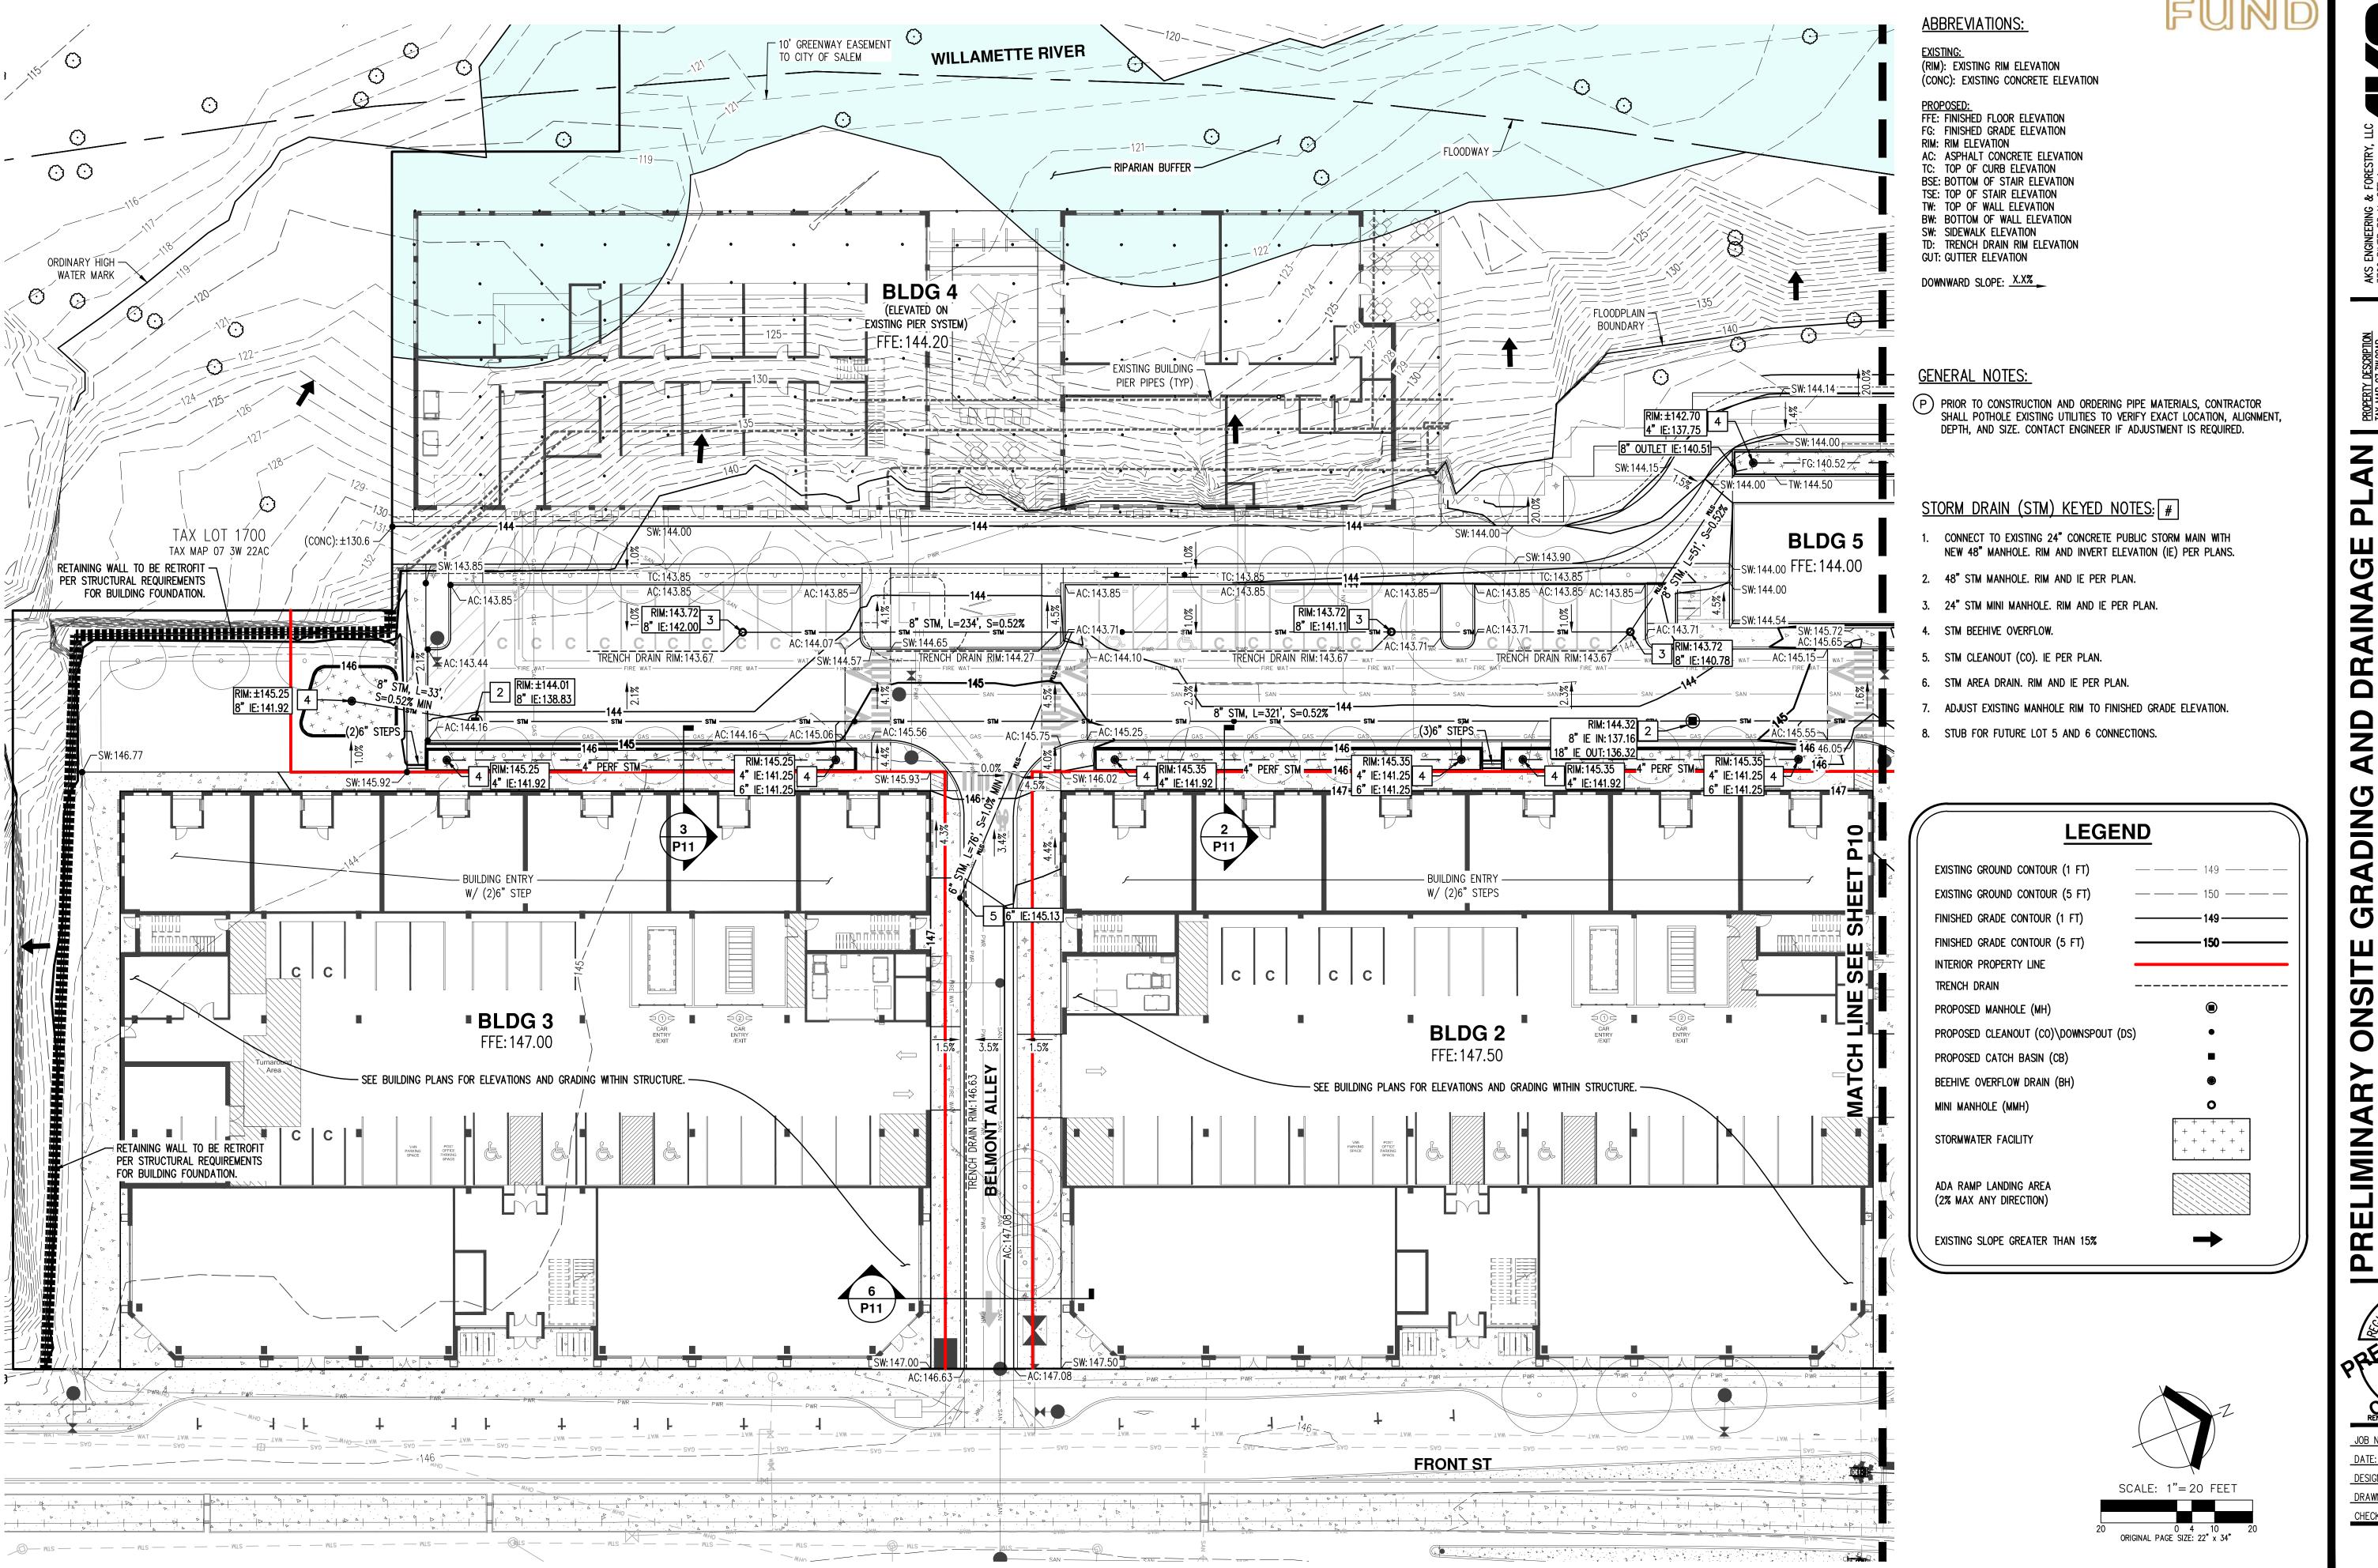

PROPE TAX M TAX L CONTR CONTR FunD 15017

DING

07/26/2024 DESIGNED BY: DRAWN BY: CHECKED BY:

FRONT ST

ABBREVIATIONS:

EXISTING:
(RIM): EXISTING RIM ELEVATION
(CONC): EXISTING CONCRETE ELEVATION

PROPOSED:
FFE: FINISHED FLOOR ELEVATION
FG: FINISHED GRADE ELEVATION
RIM: RIM ELEVATION
AC: ASPHALT CONCRETE ELEVATION
TC: TOP OF CURB ELEVATION
BSE: BOTTOM OF STAIR ELEVATION
TSE: TOP OF STAIR ELEVATION
TW: TOP OF WALL ELEVATION
BW: BOTTOM OF WALL ELEVATION
SW: SIDEWALK ELEVATION
TD: TRENCH DRAIN RIM ELEVATION
GUT: GUTTER ELEVATION


DOWNWARD SLOPE: X.X%


GENERAL NOTES:

P PRIOR TO CONSTRUCTION AND ORDERING PIPE MATERIALS, CONTRACTOR SHALL POTHOLE EXISTING UTILITIES TO VERIFY EXACT LOCATION, ALIGNMENT, DEPTH, AND SIZE. CONTACT ENGINEER IF ADJUSTMENT IS REQUIRED.

STORM DRAIN (STM) KEYED NOTES:

- 1. CONNECT TO EXISTING 24" CONCRETE PUBLIC STORM MAIN WITH NEW 48" MANHOLE. RIM AND INVERT ELEVATION (IE) PER PLANS.
- 2. 48" STM MANHOLE. RIM AND IE PER PLAN.
- 3. 24" STM MINI MANHOLE. RIM AND IE PER PLAN.
- 4. STM BEEHIVE OVERFLOW.
- 5. STM CLEANOUT (CO). IE PER PLAN.
- 6. STM AREA DRAIN. RIM AND IE PER PLAN.
- 7. ADJUST EXISTING MANHOLE RIM TO FINISHED GRADE ELEVATION.
- 8. STUB FOR FUTURE LOT 5 AND 6 CONNECTIONS.

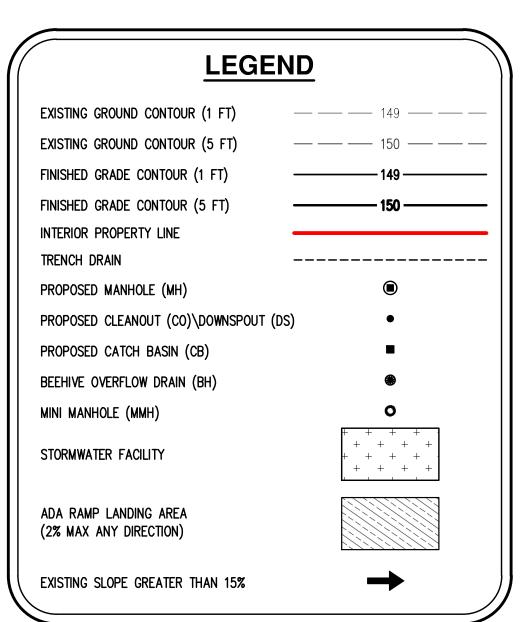

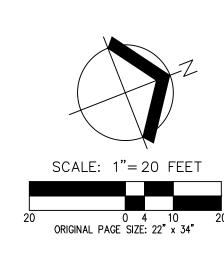

ARY ONSITE GRADING AND DRAINAGE PLAN

PROP TAX L CONT Fund 15017

PRELIMINARY ONSITE OTHER CANNERY

RENEWS: DECEMBER 31, 2024

OB NUMBER: 5968-01

ATE: 07/26/2024

JOB NUMBER: 5968-0

DATE: 07/26/2024

DESIGNED BY: TDF

DRAWN BY: MJM

CHECKED BY: TDF

ABBREVIATIONS:

EXISTING:
(RIM): EXISTING RIM ELEVATION

PROPOSED: FFE: FINISHED FLOOR ELEVATION

FG: FINISHED GRADE ELEVATION

TC: TOP OF CURB ELEVATION BSE: BOTTOM OF STAIR ELEVATION TSE: TOP OF STAIR ELEVATION

TW: TOP OF WALL ELEVATION BW: BOTTOM OF WALL ELEVATION

TD: TRENCH DRAIN RIM ELEVATION

SW: SIDEWALK ELEVATION

GUT: GUTTER ELEVATION

DOWNWARD SLOPE: X.X%

AC: ASPHALT CONCRETE ELEVATION

RIM: RIM ELEVATION

(CONC): EXISTING CONCRETE ELEVATION

SECTIONS **AND DRAINAGE**


GRADING CANNERY **PRELIMINARY**

OREGON


07/26/2024 DESIGNED BY: DRAWN BY: CHECKED BY:

BUILDING WALL DESIGN TBD /-- SW: 143.93 /-- SW: 144.00 SW: 143.85 -SW: 143.90 -FFE:144.0 anamana 🚄 BEEHIVE OVERFLOW: 142.70 2 18" GROWING — WQ:142.63 MEDIUM — TOP OF GROWING MEDIUM: 140.50 3" CHOKER COURSE 12" DRAIN ROCK — IE: 137.75


WINERY PLANTER CROSS-SECTION 1" = 5'

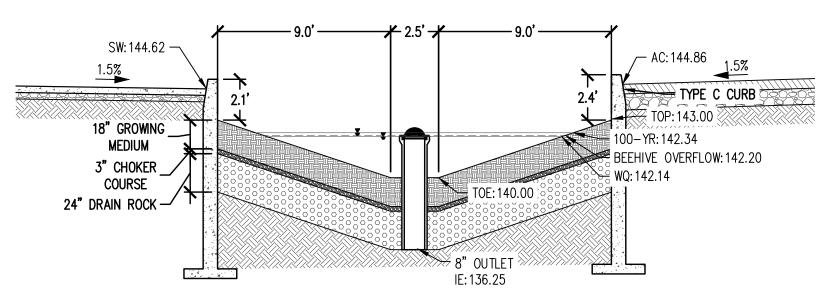


RAIN GARDEN CROSS-SECTION 1" = 5'

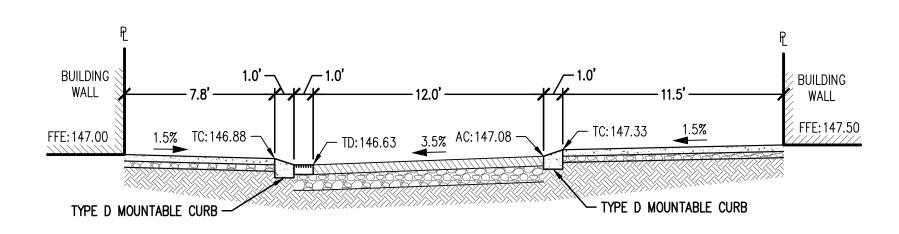

BELMONT ALLEY CROSS-SECTION

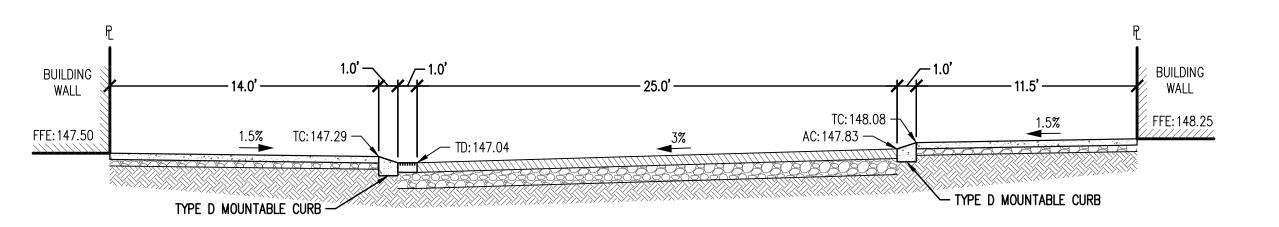

MARKET ST ENTRANCE CROSS-SECTION

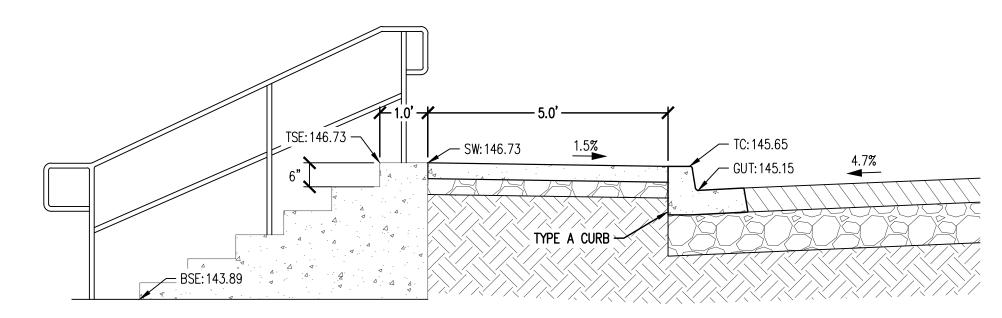

WINERY BUILDING STAIR STEP CONCEPT

BUILDING 1 PLANTER CROSS-SECTION 1" = 2'

TW: 147.25 —


COURSE

12" DRAIN ROCK

TC: 145.91 -

AC: 145.41 —

0.5

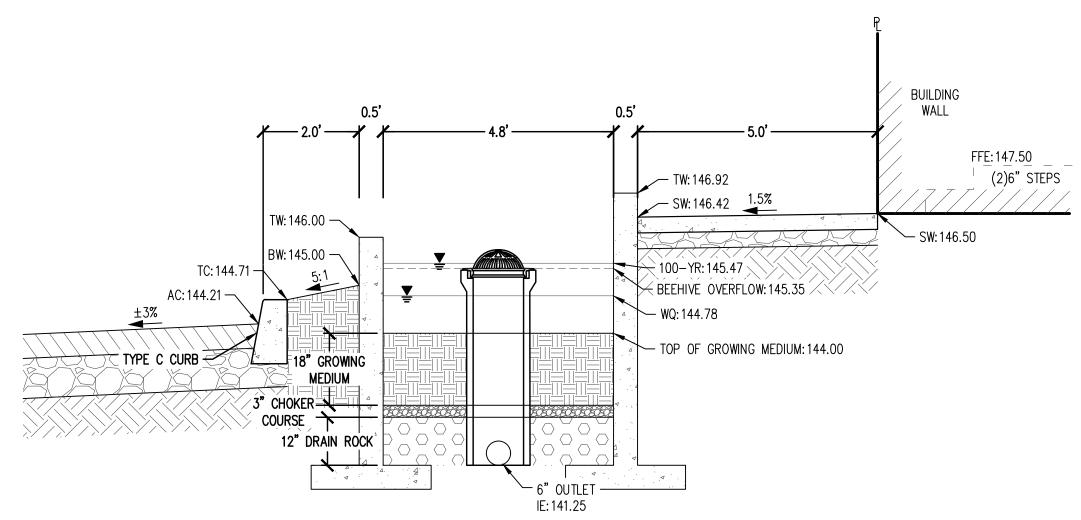

0.5

— TW: 147.67

SW: 147.17

- 100–YR:146.69 〈

BEEHIVE OVERFLOW: 146.55

- TOP OF GROWING MEDIUM: 145.50

BUILDING


WALL

─ SW:147.25


FFE:148.25

(2)6" STEPS

BUILDING 2 PLANTER CROSS-SECTION

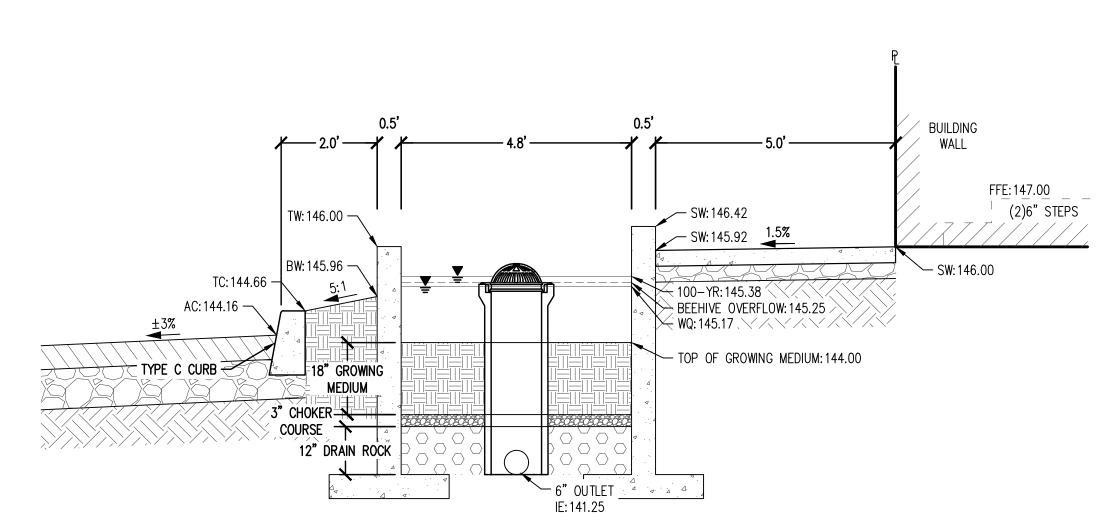

BUILDING 3 PLANTER CROSS-SECTION

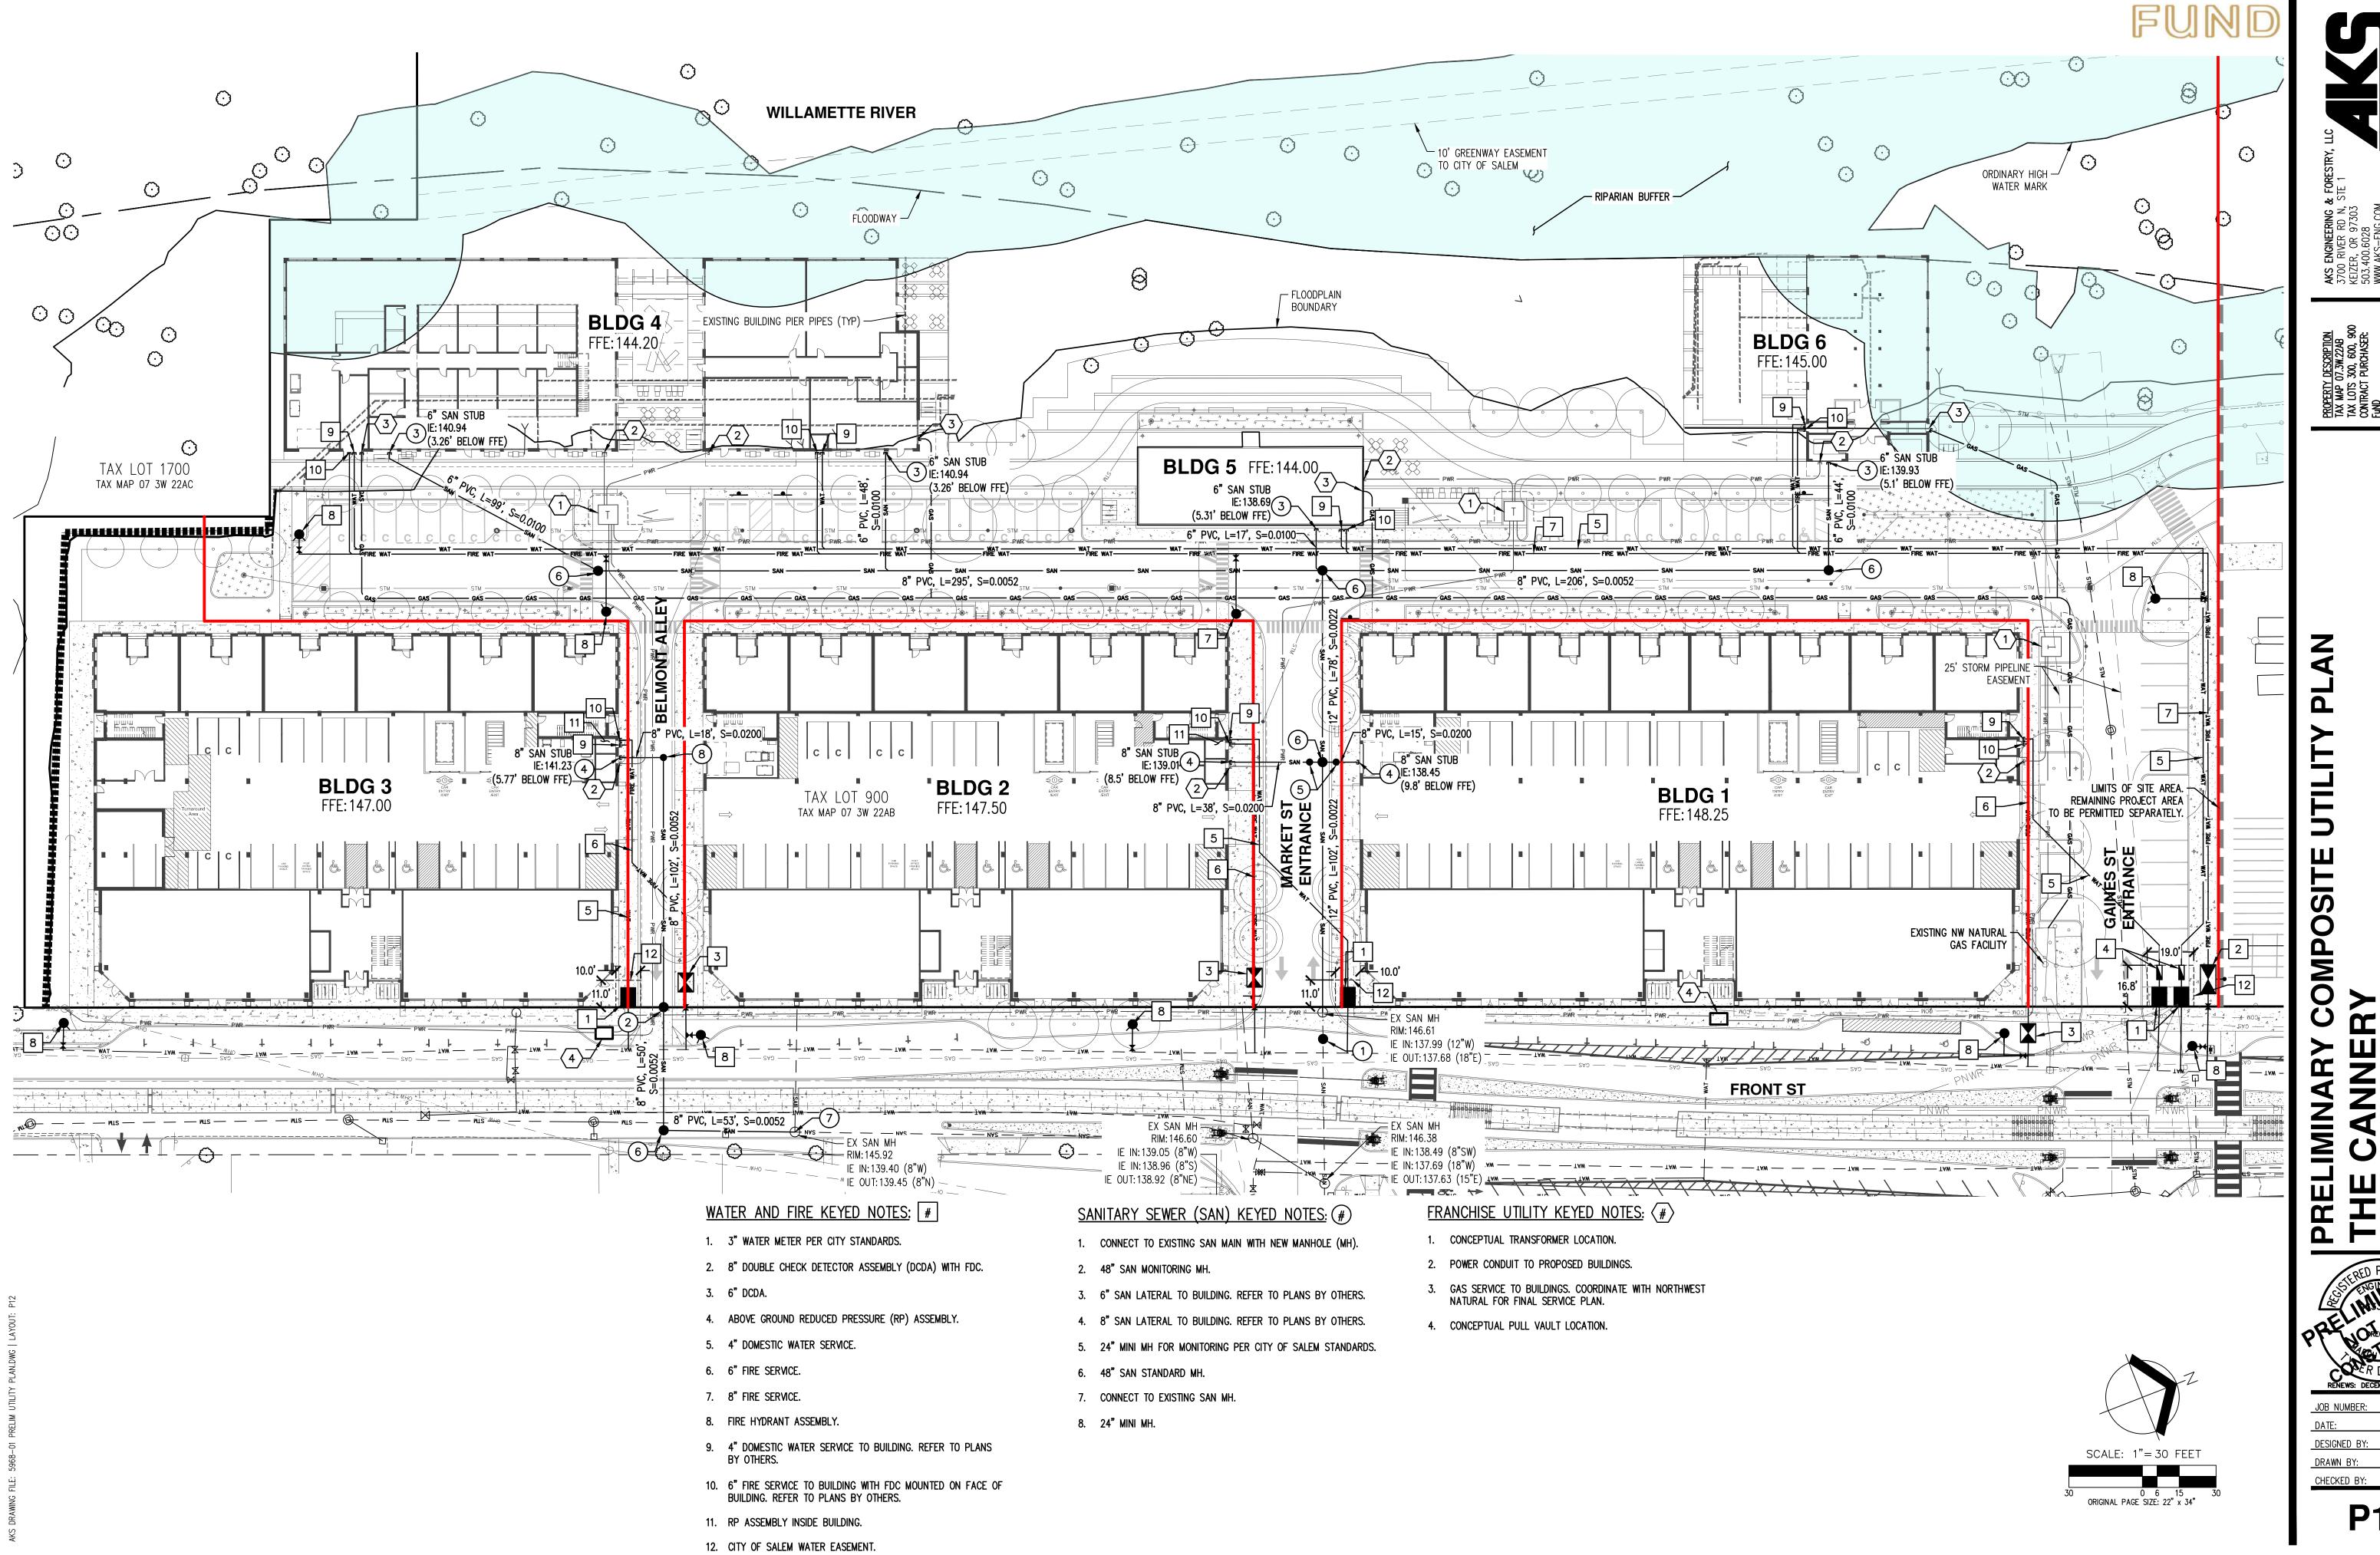


P12


07/26/2024



SCALE: 1"= 40 FEET


DESIGNED BY:

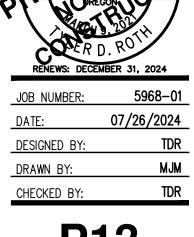


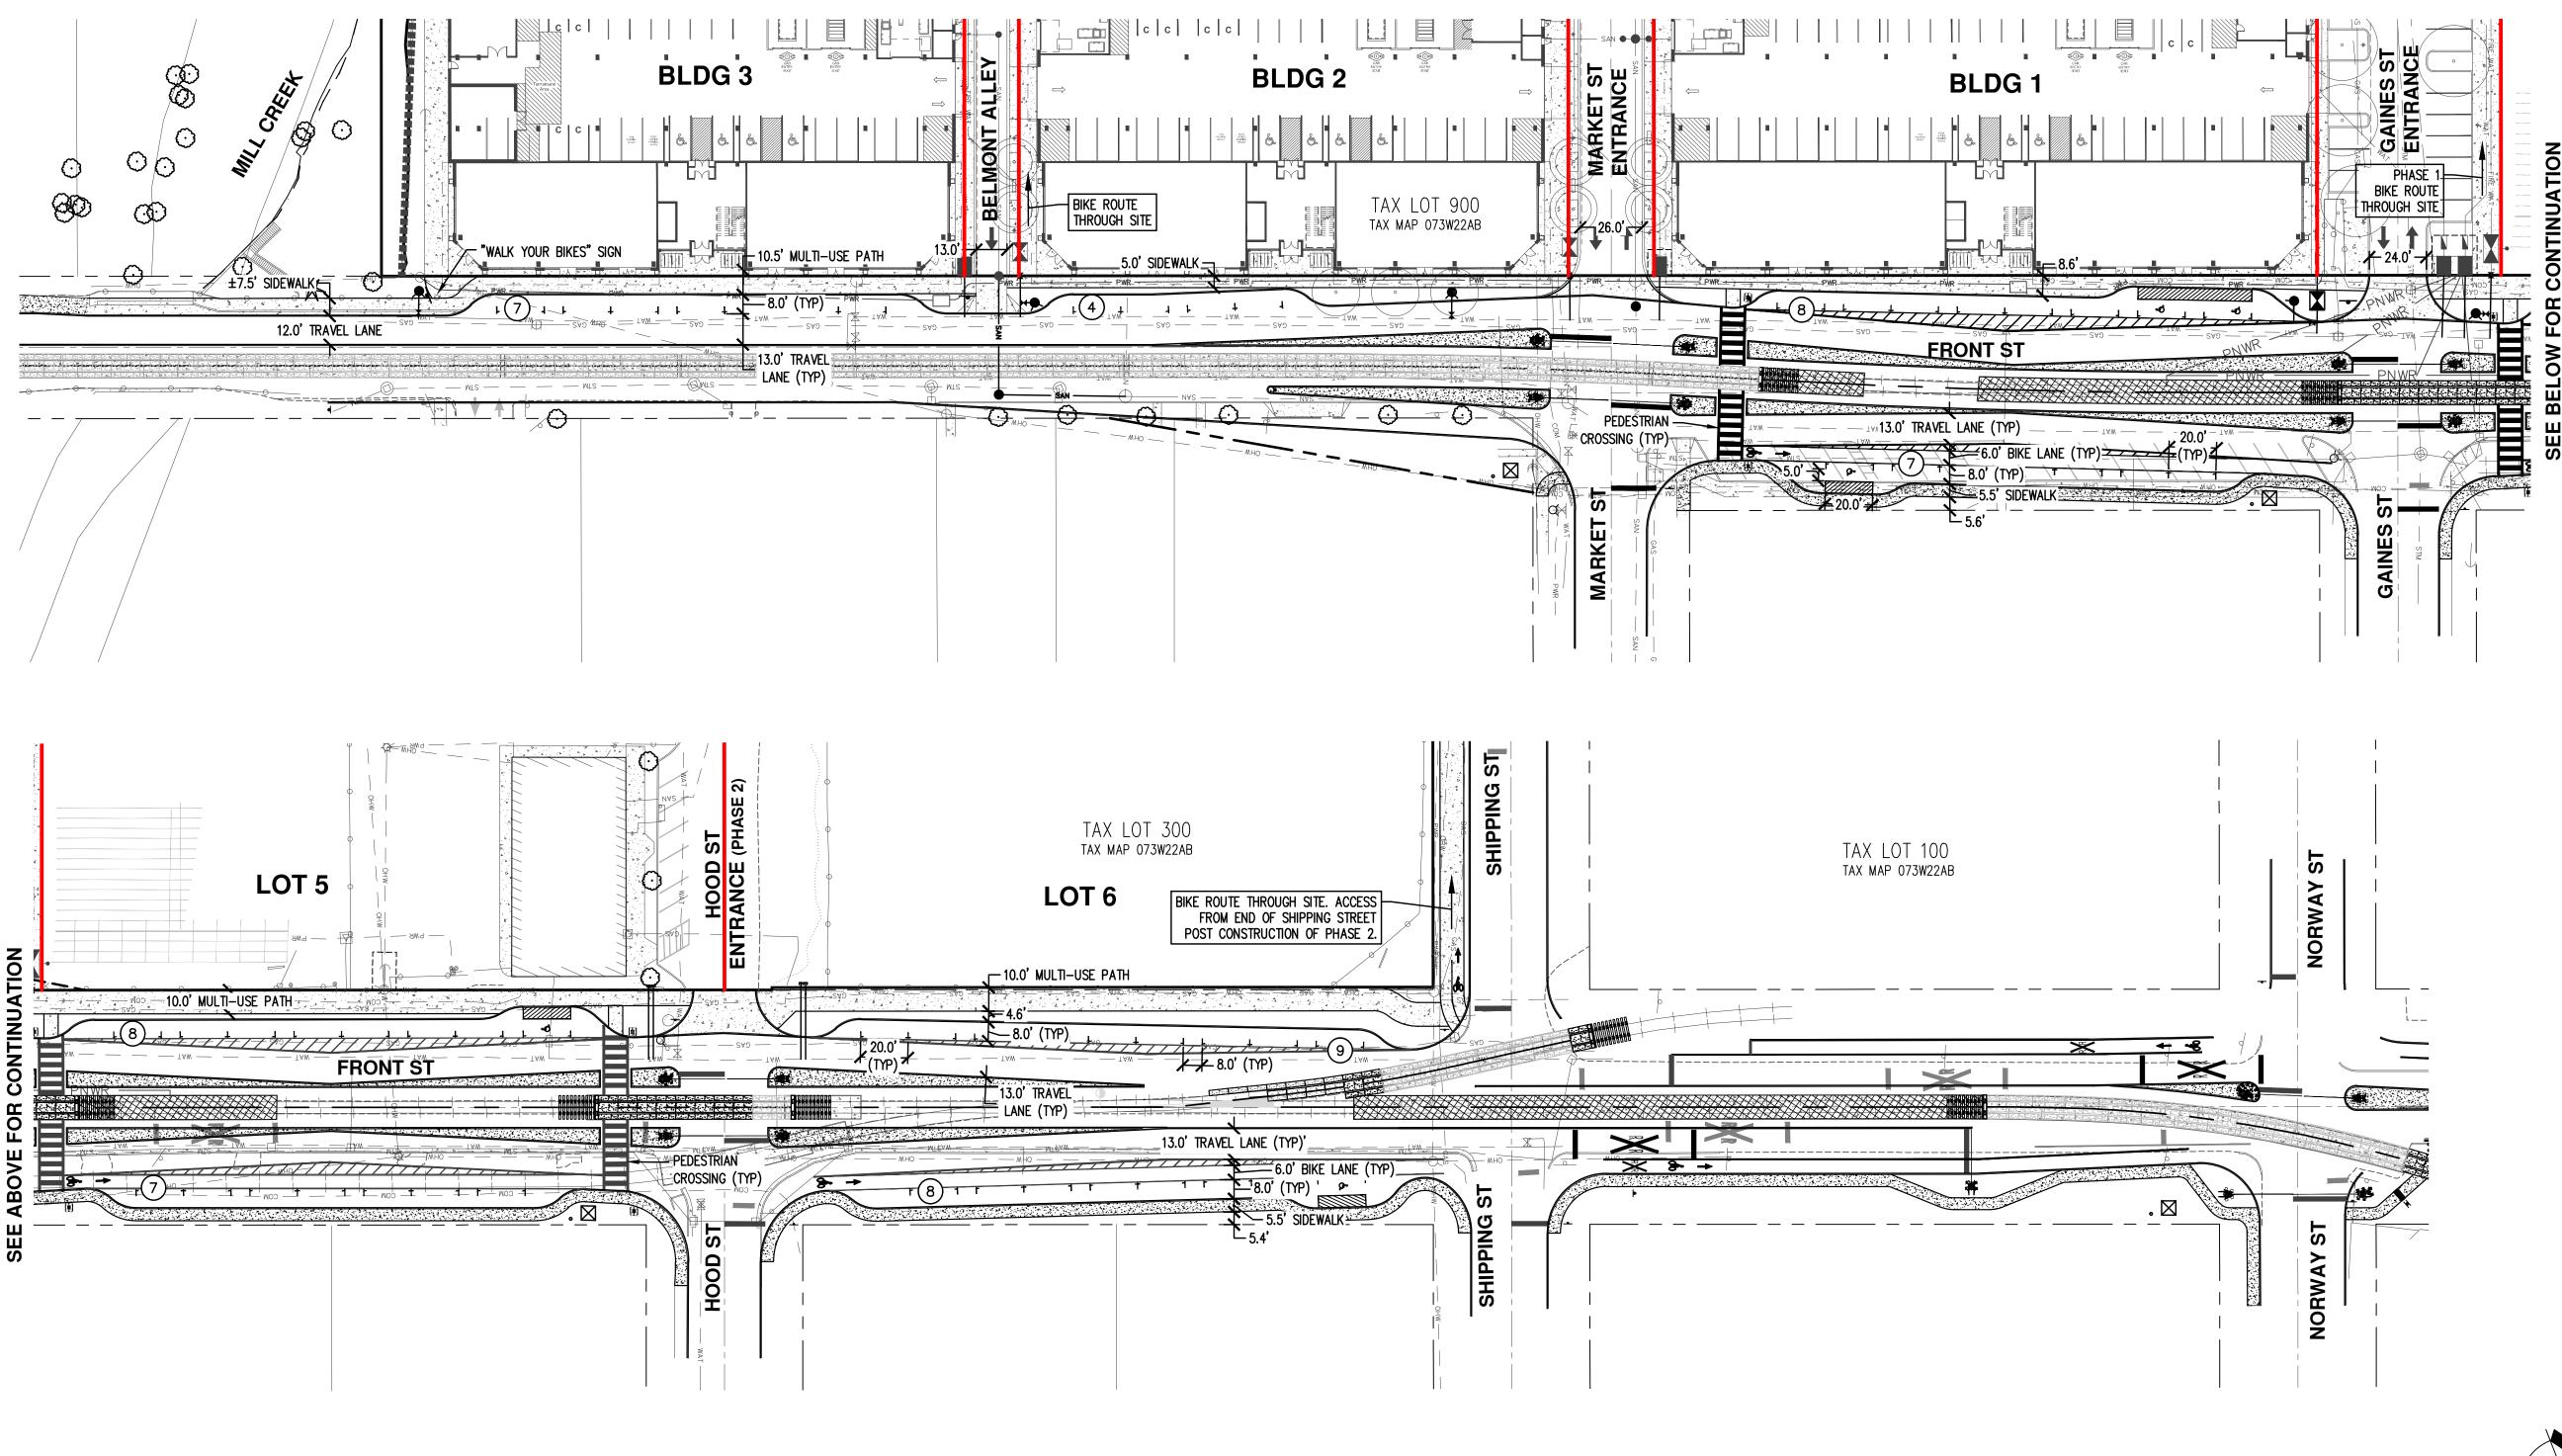

NUMBER OF PARKING STALLS IN ROW

GENERAL NOTE:
PROPOSED FRONT STREET IMPROVEMENTS ARE SUBJECT TO CHANGE BASED ON RAIL AND CITY FEEDBACK. INFORMATION SHOWN IS BASED ON LATEST COORDINATION EFFORTS WITH THE CITY OF SALEM AND RAILROAD ENGINEER.

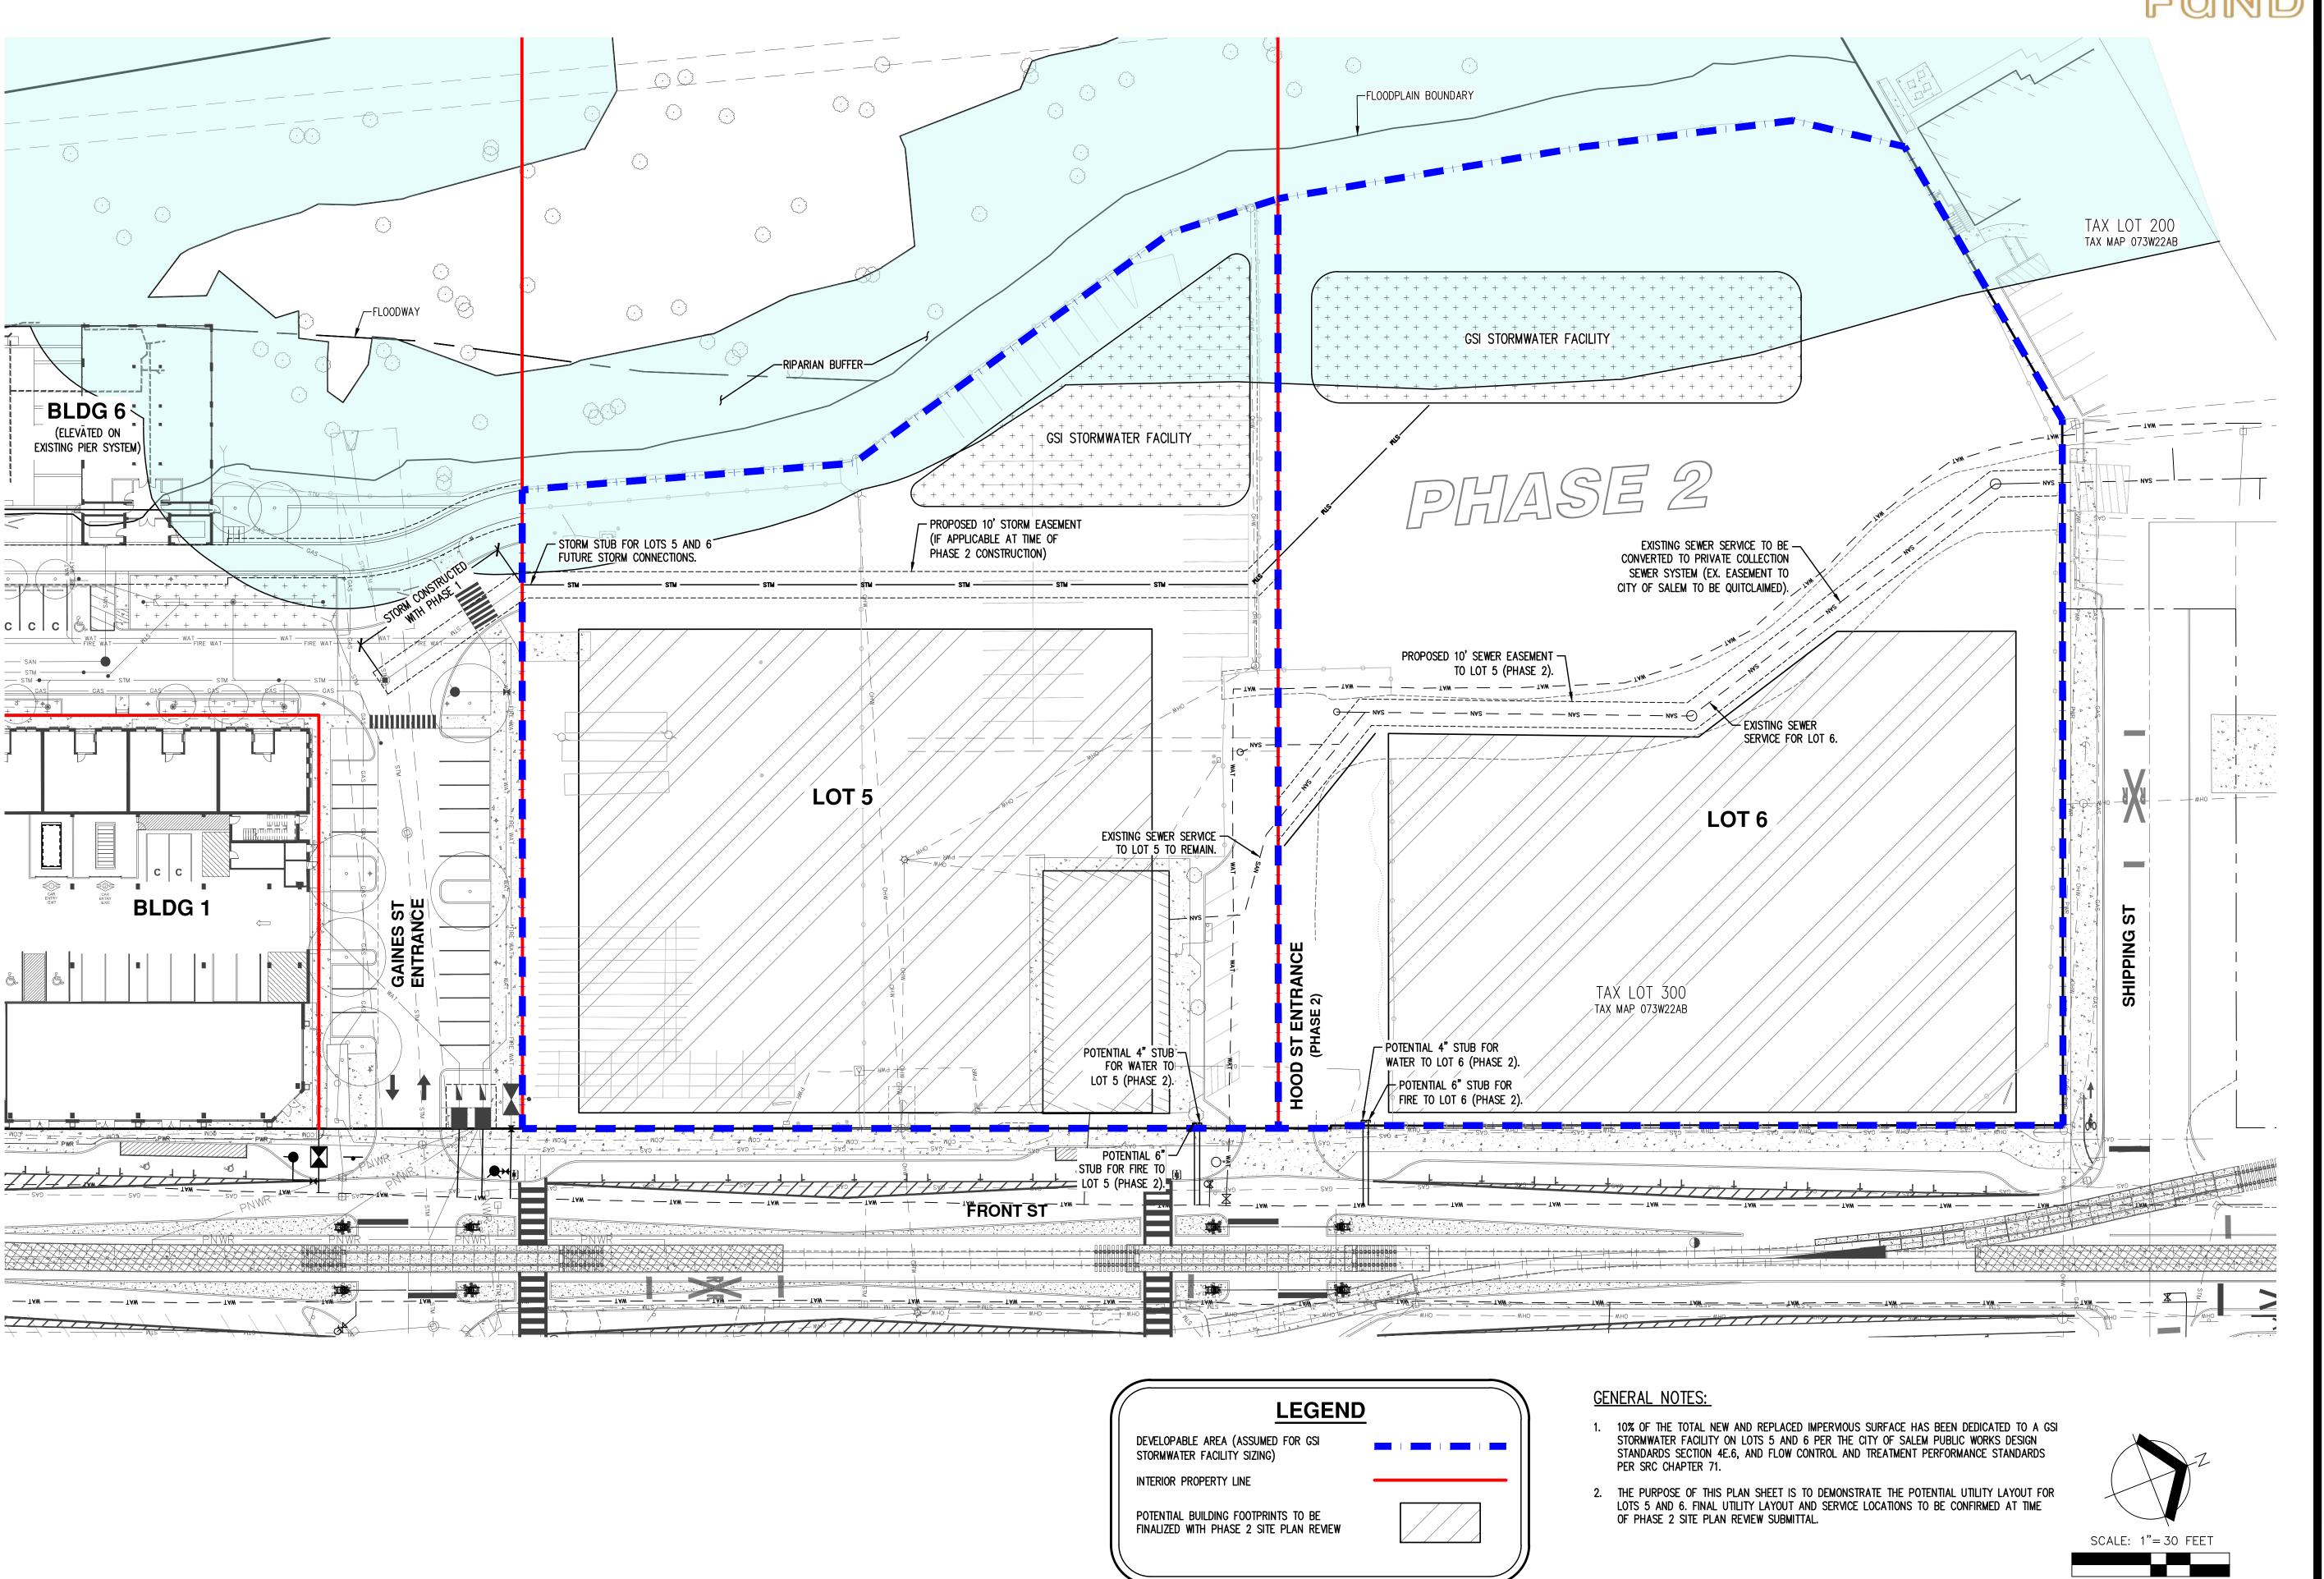

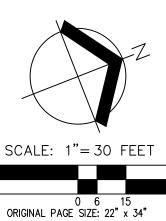

CONC JOB NUMBER:

5

ONCE

07/26/2024 DESIGNED BY: DRAWN BY: CHECKED BY:

Attachment D: Revised Preliminary Landscape Plans

REVISIONS

SCALE

DRAWN BY
DATE
PROJECT NO.

SHEET

I 1 \(1 \)

2024.03.15

2346-SAC



ILLUSTRATIVE PLAN OVERALL

Plan




REVISIONS

SCALE DRAWN BY

2024.03.15 2346-SAC PROJECT NO.

SHEET

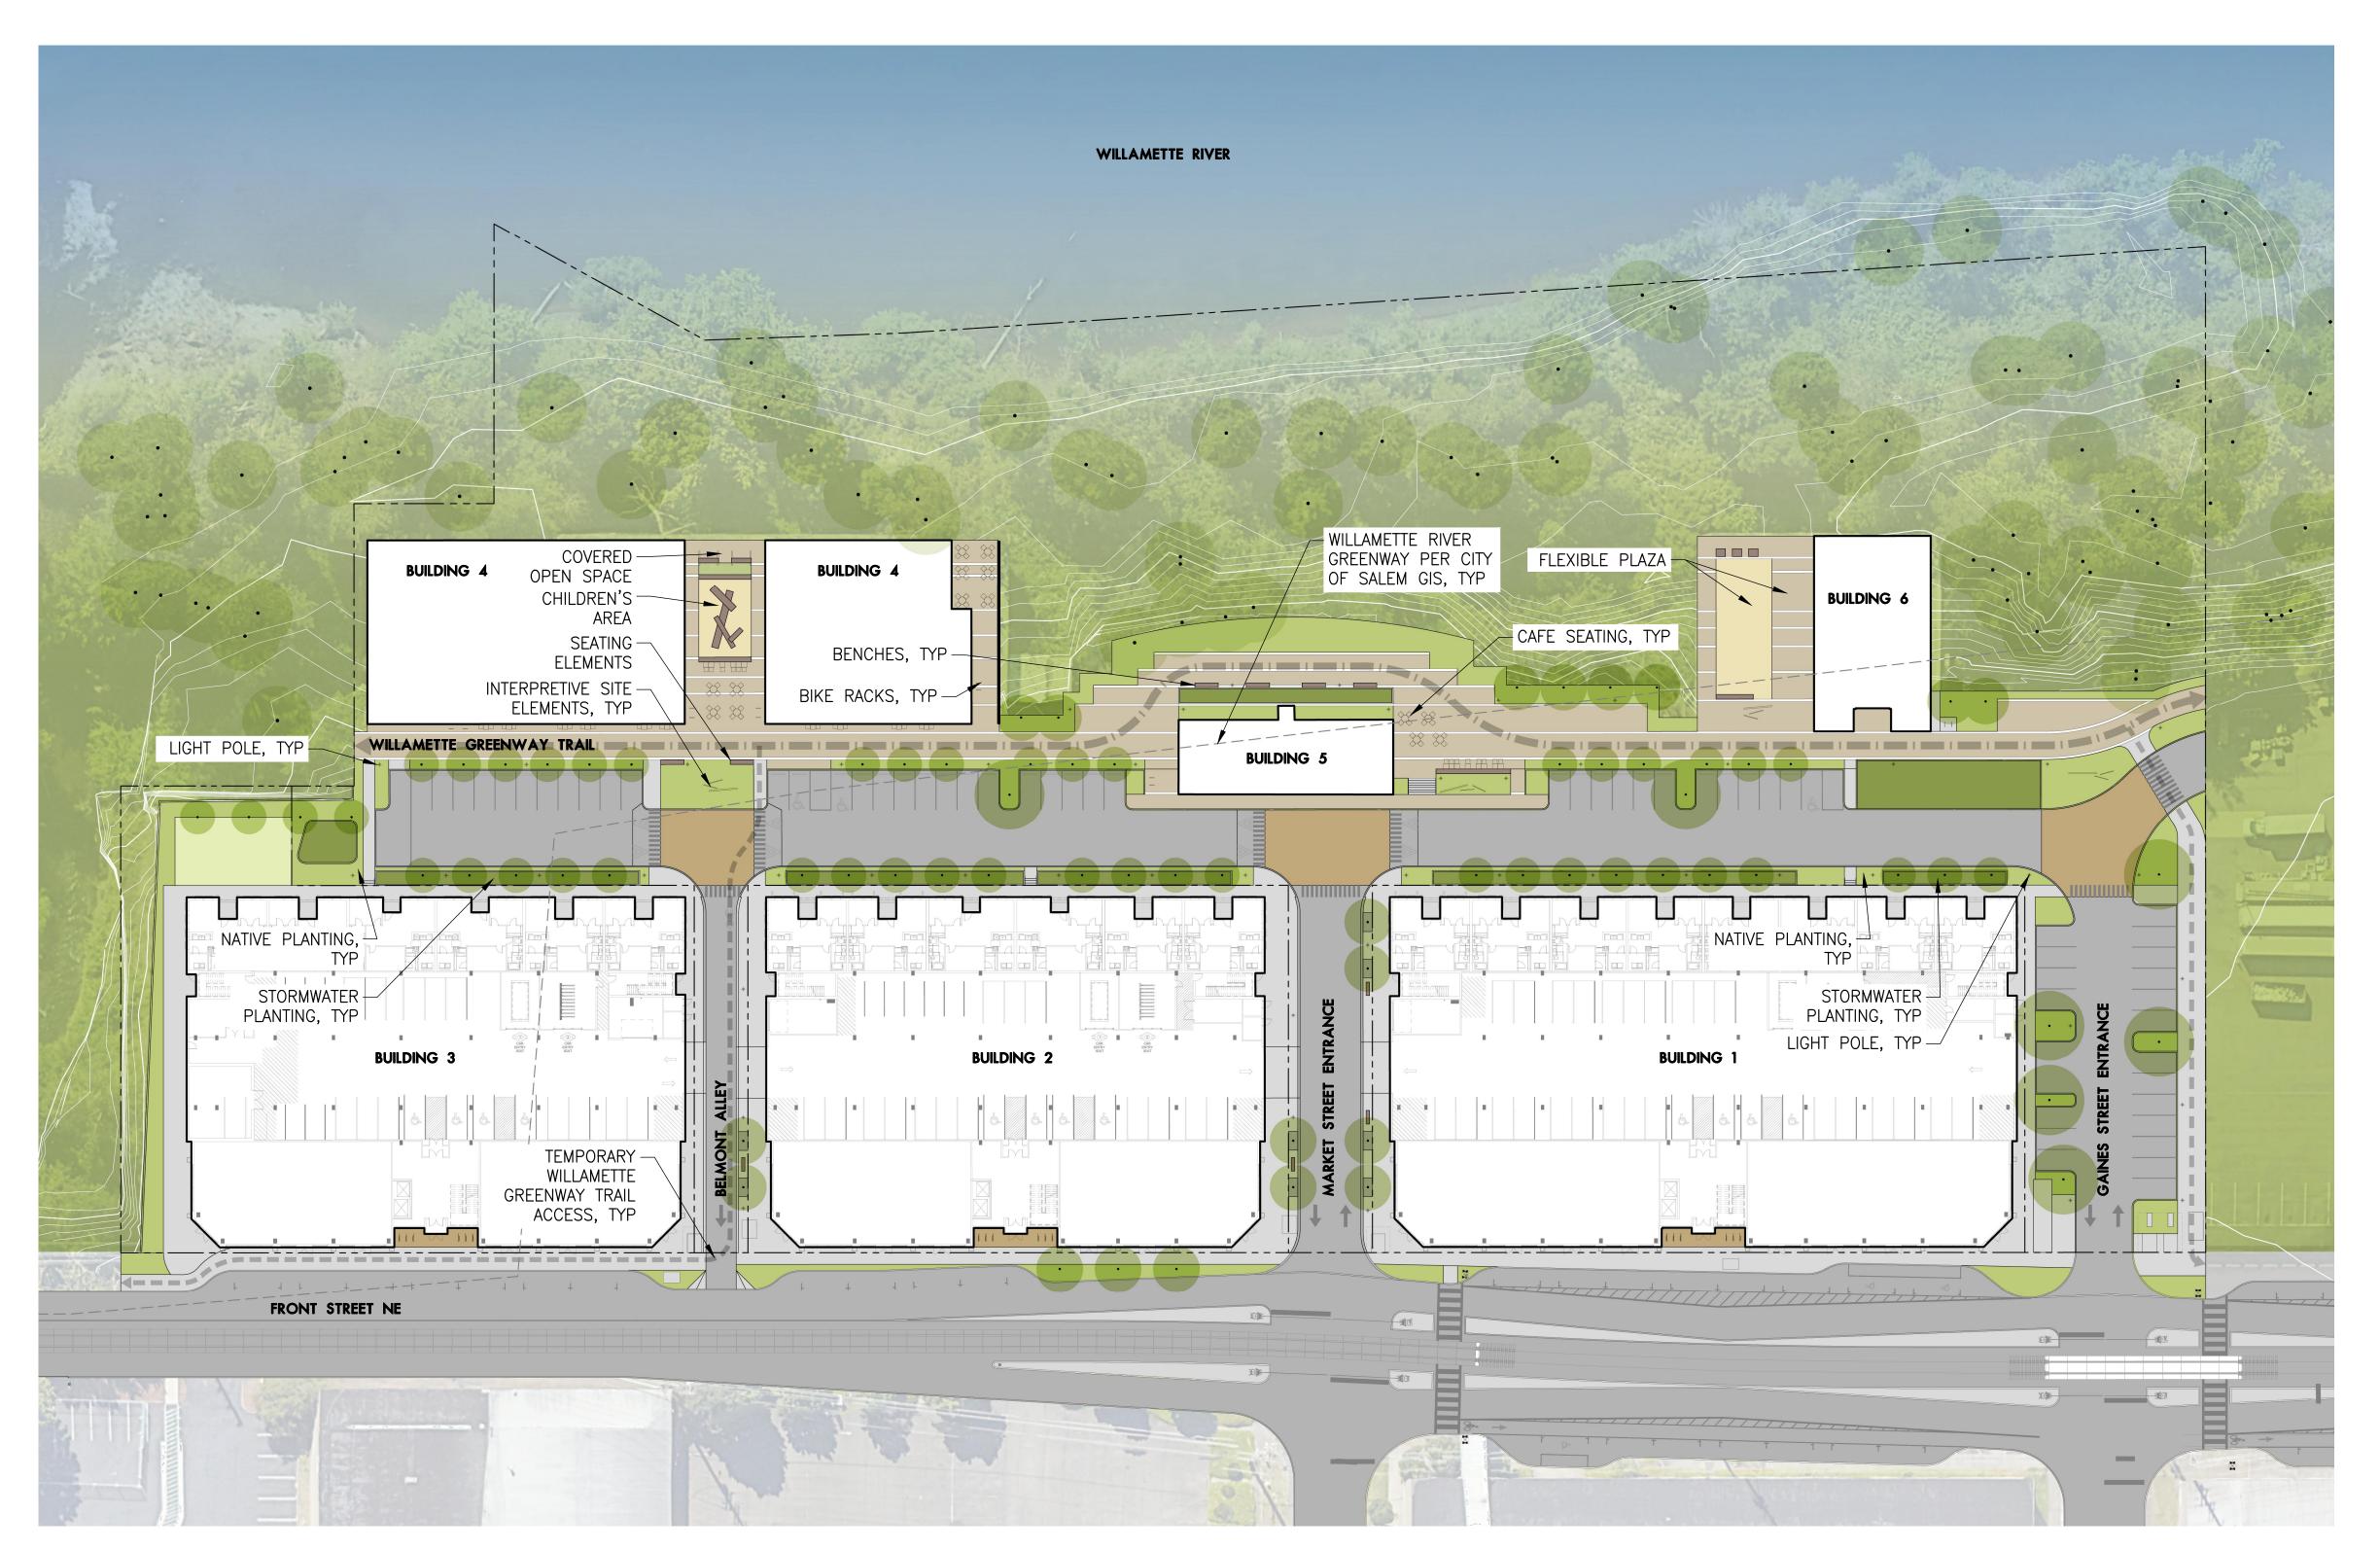

ILLUSTRATIVE PLAN LEVEL 1


REVISIONS

SCALE DRAWN BY

PROJECT NO. 2346-SAC

SHEET

2024.03.15

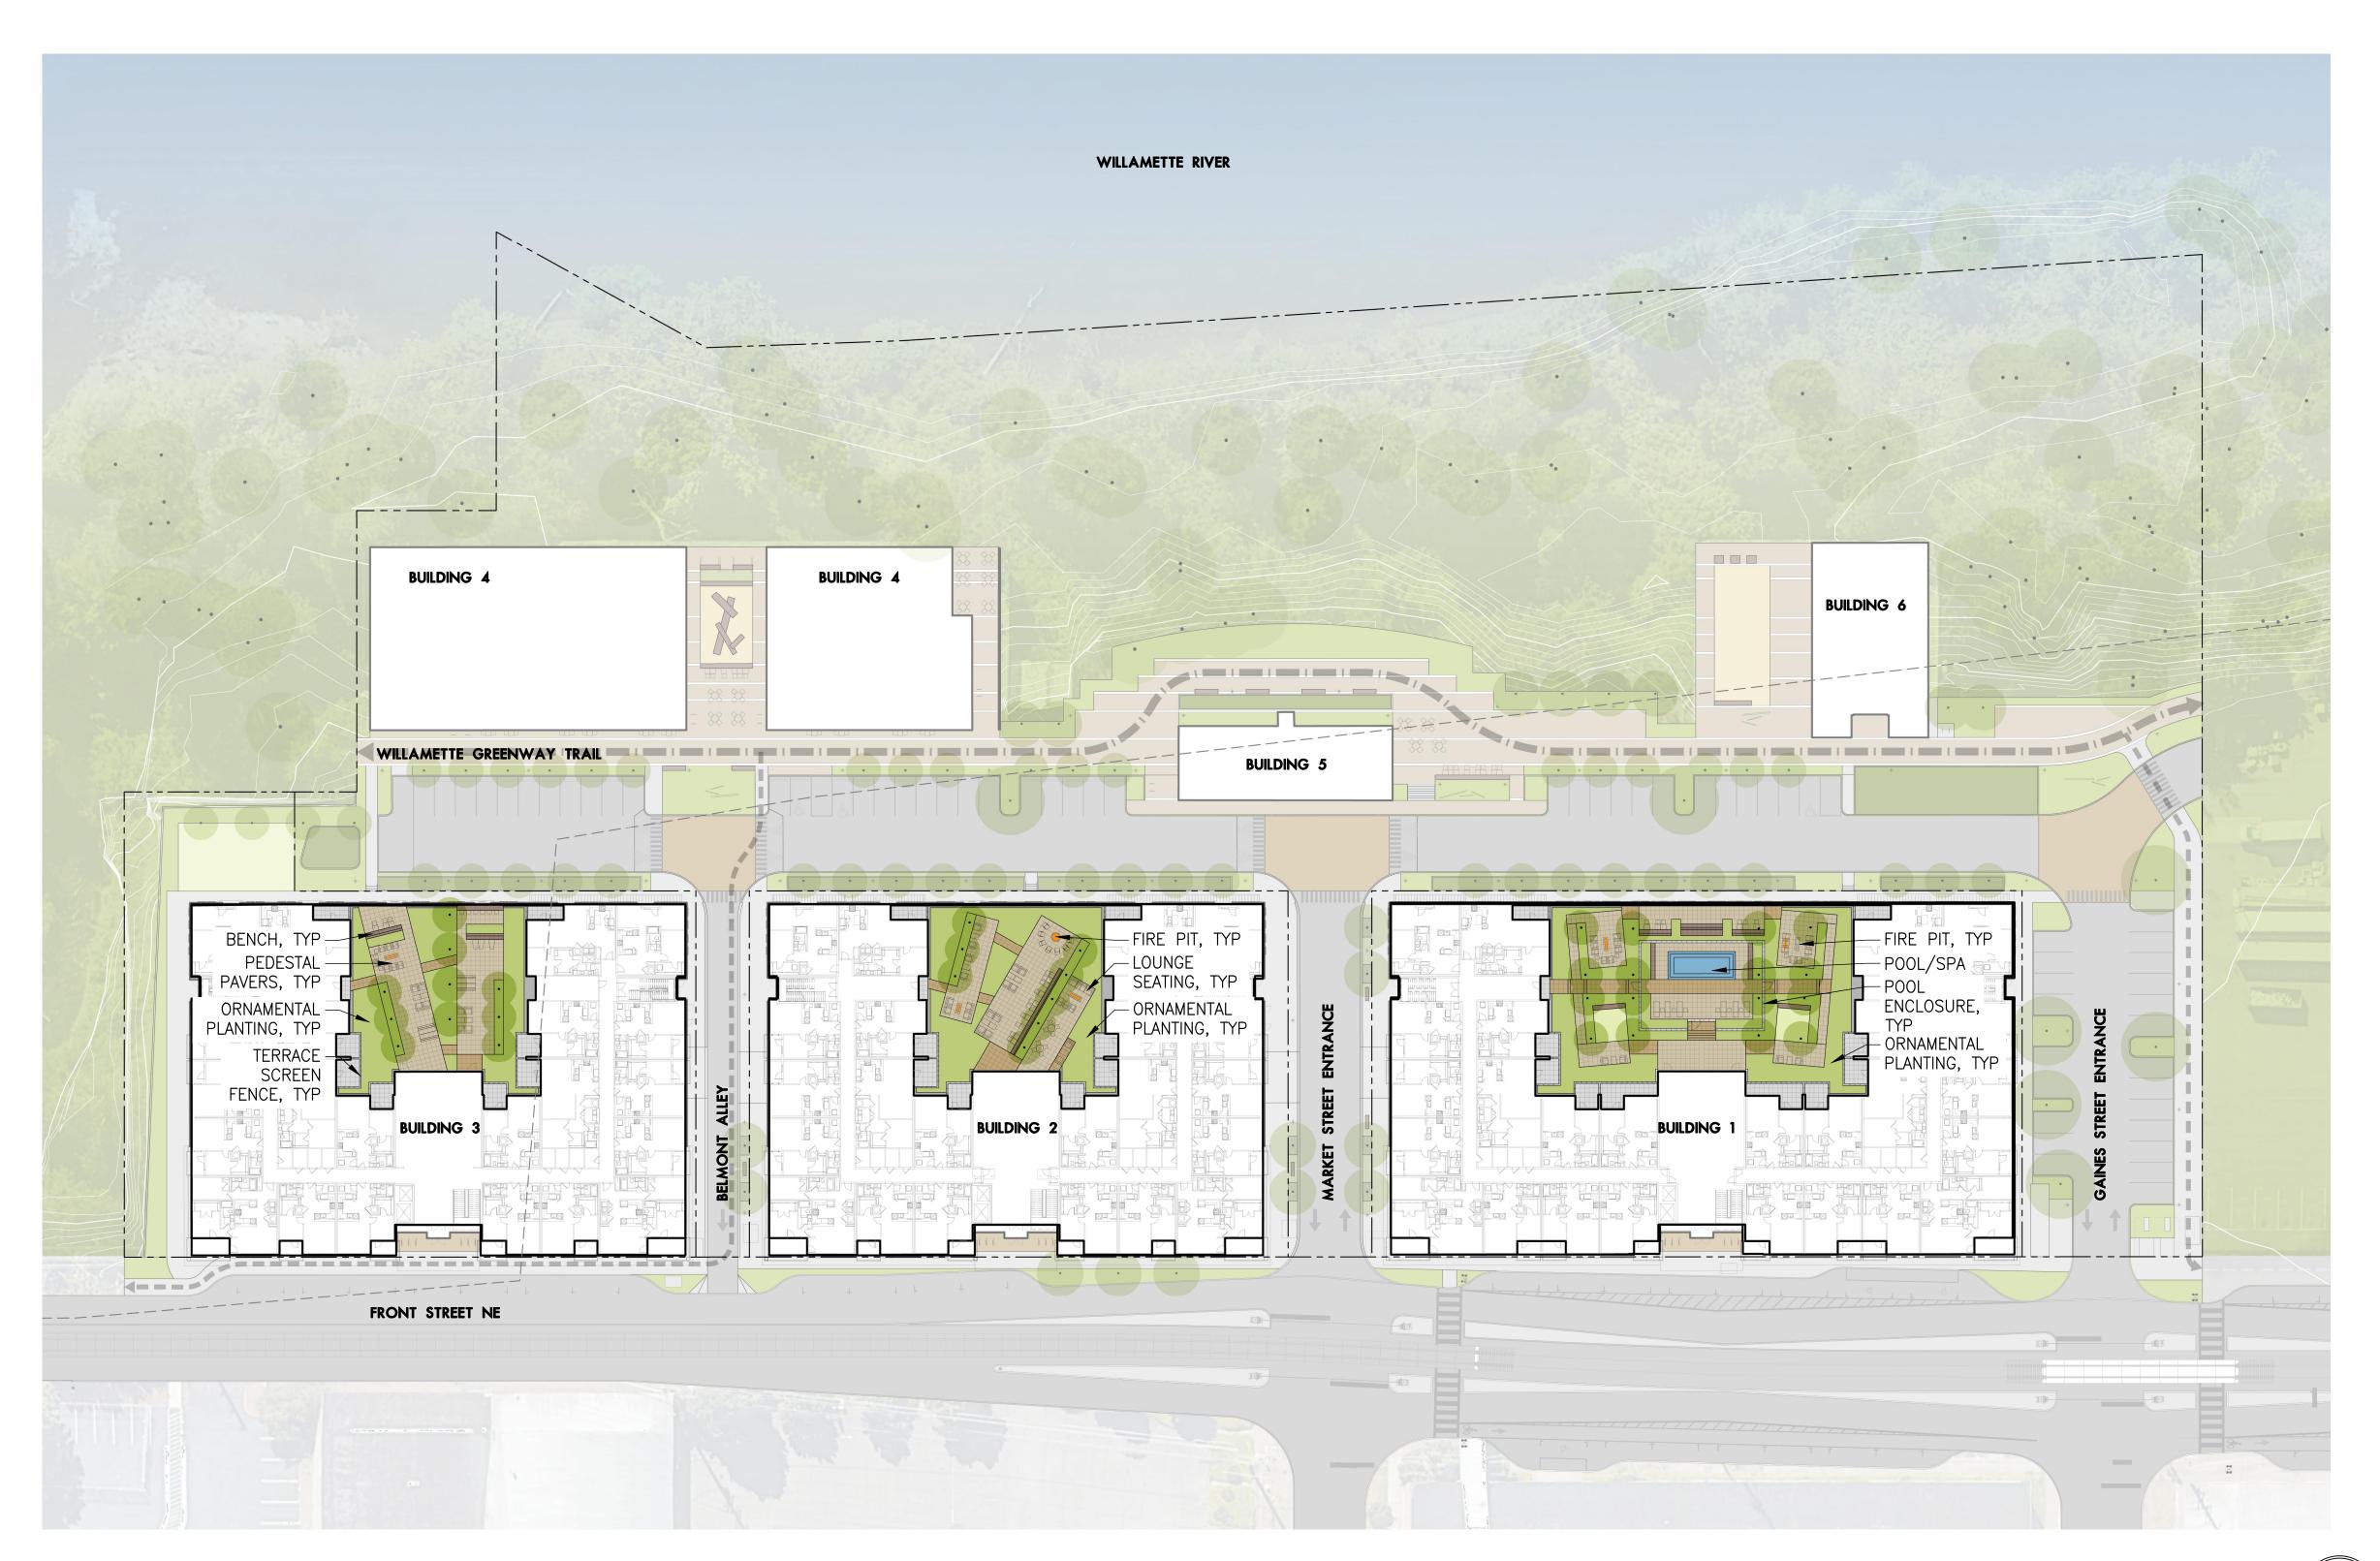

ILLUSTRATIVE PLAN LEVEL 2

LAND USE SUBMITTAL LANDSCAPE LAND USE DIAGRAM

REVISIONS


SCALE

DRAWN BY DATE PROJECT NO.

SHEET


2024.03.15

2346-SAC

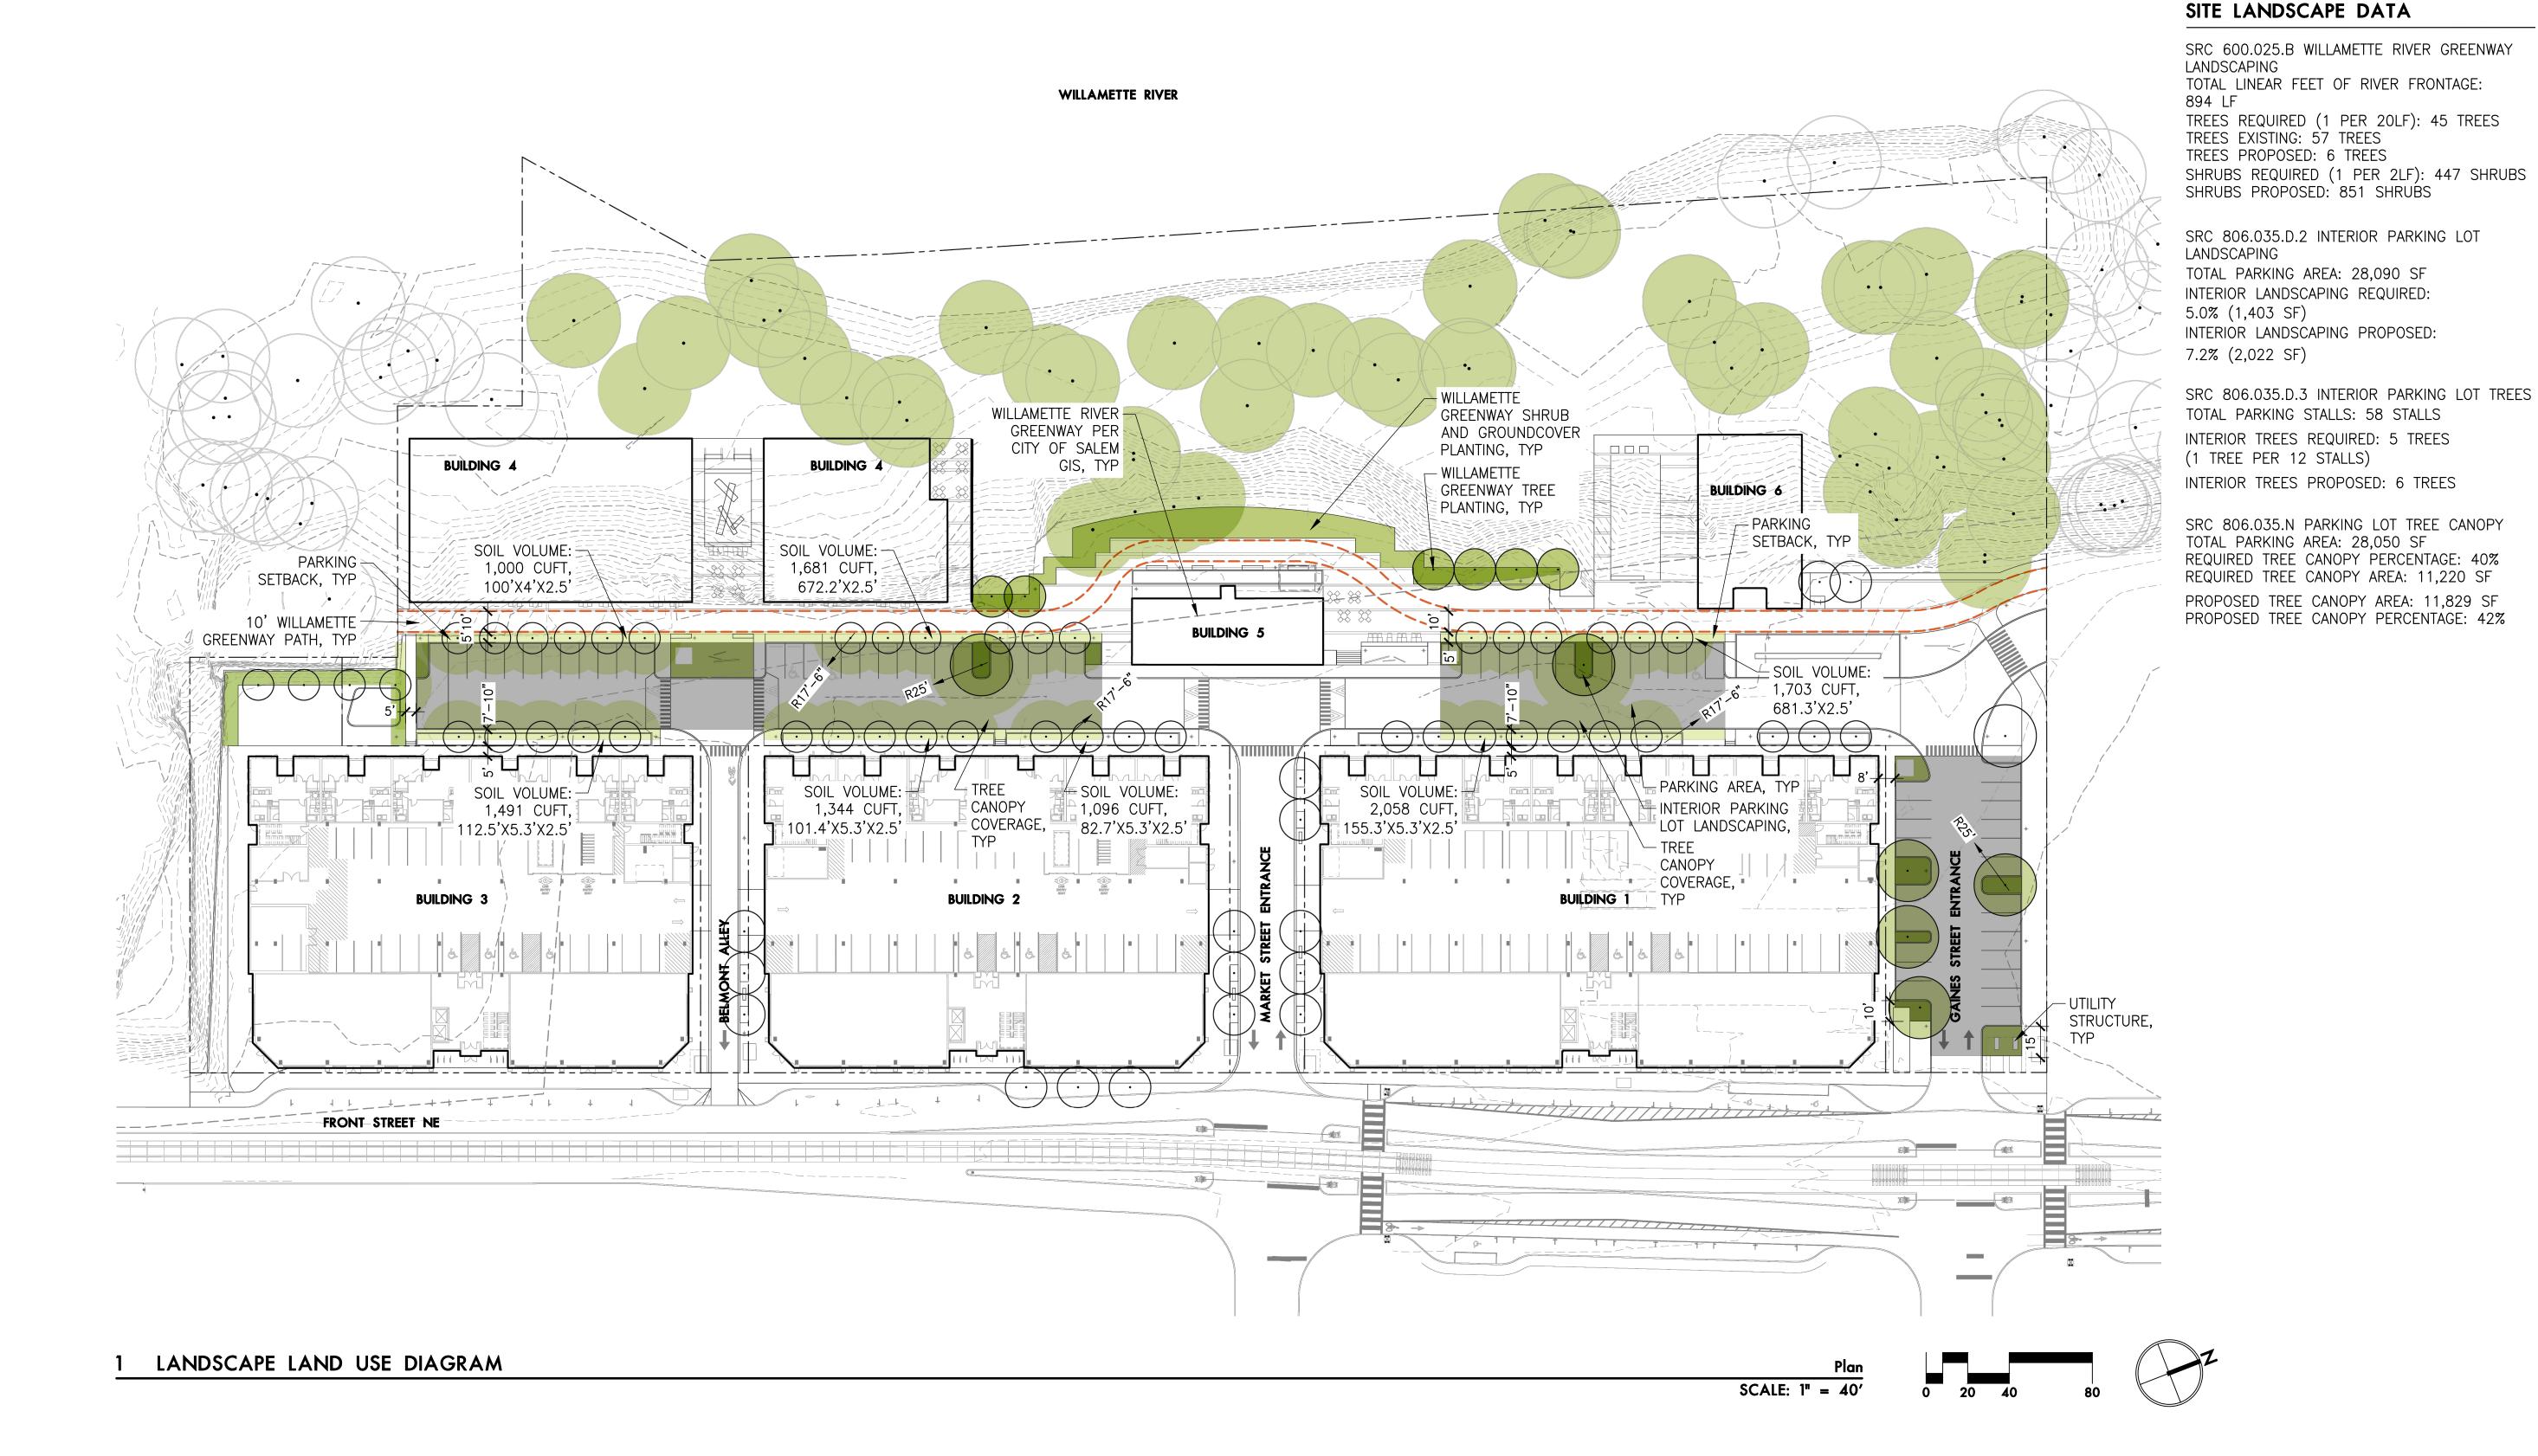





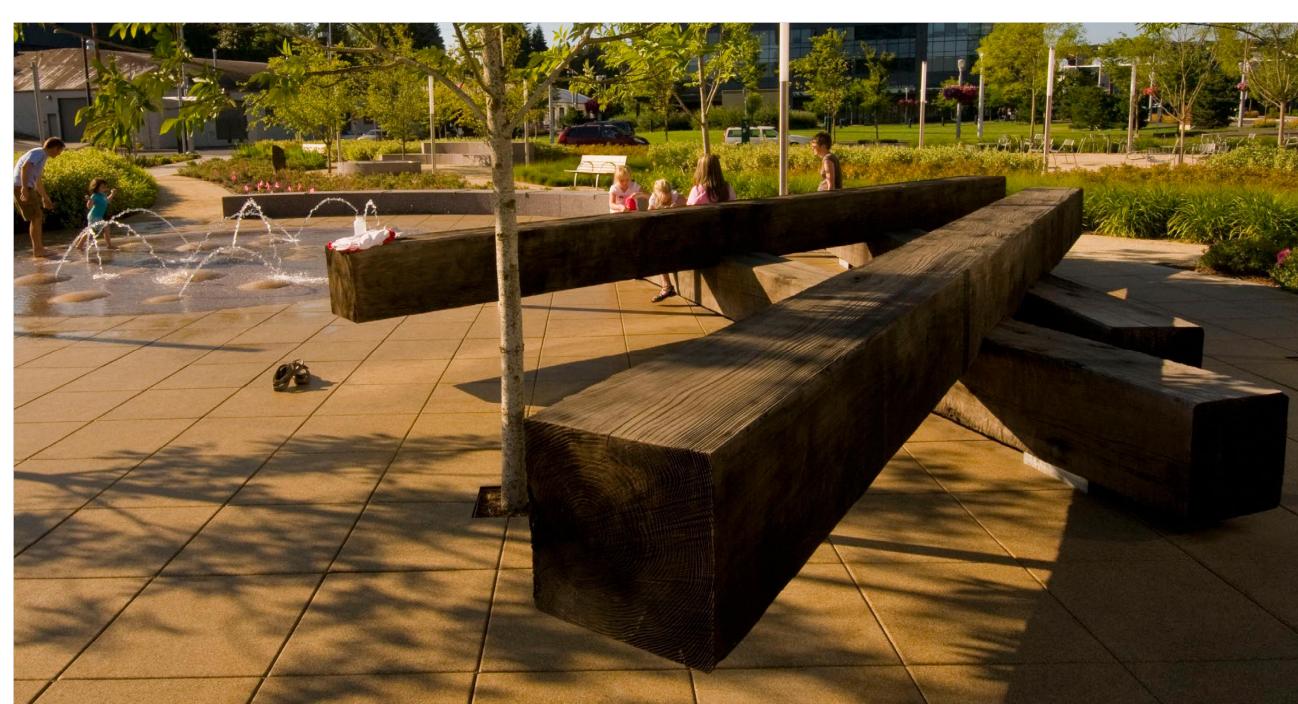





PRECEDENT IMAGES


LAND USE SUBMITTAL PRECEDENT IMAGES

REVISIONS

SCALE DRAWN BY DATE

2024.03.15 PROJECT NO. 2346-SAC

SHEET

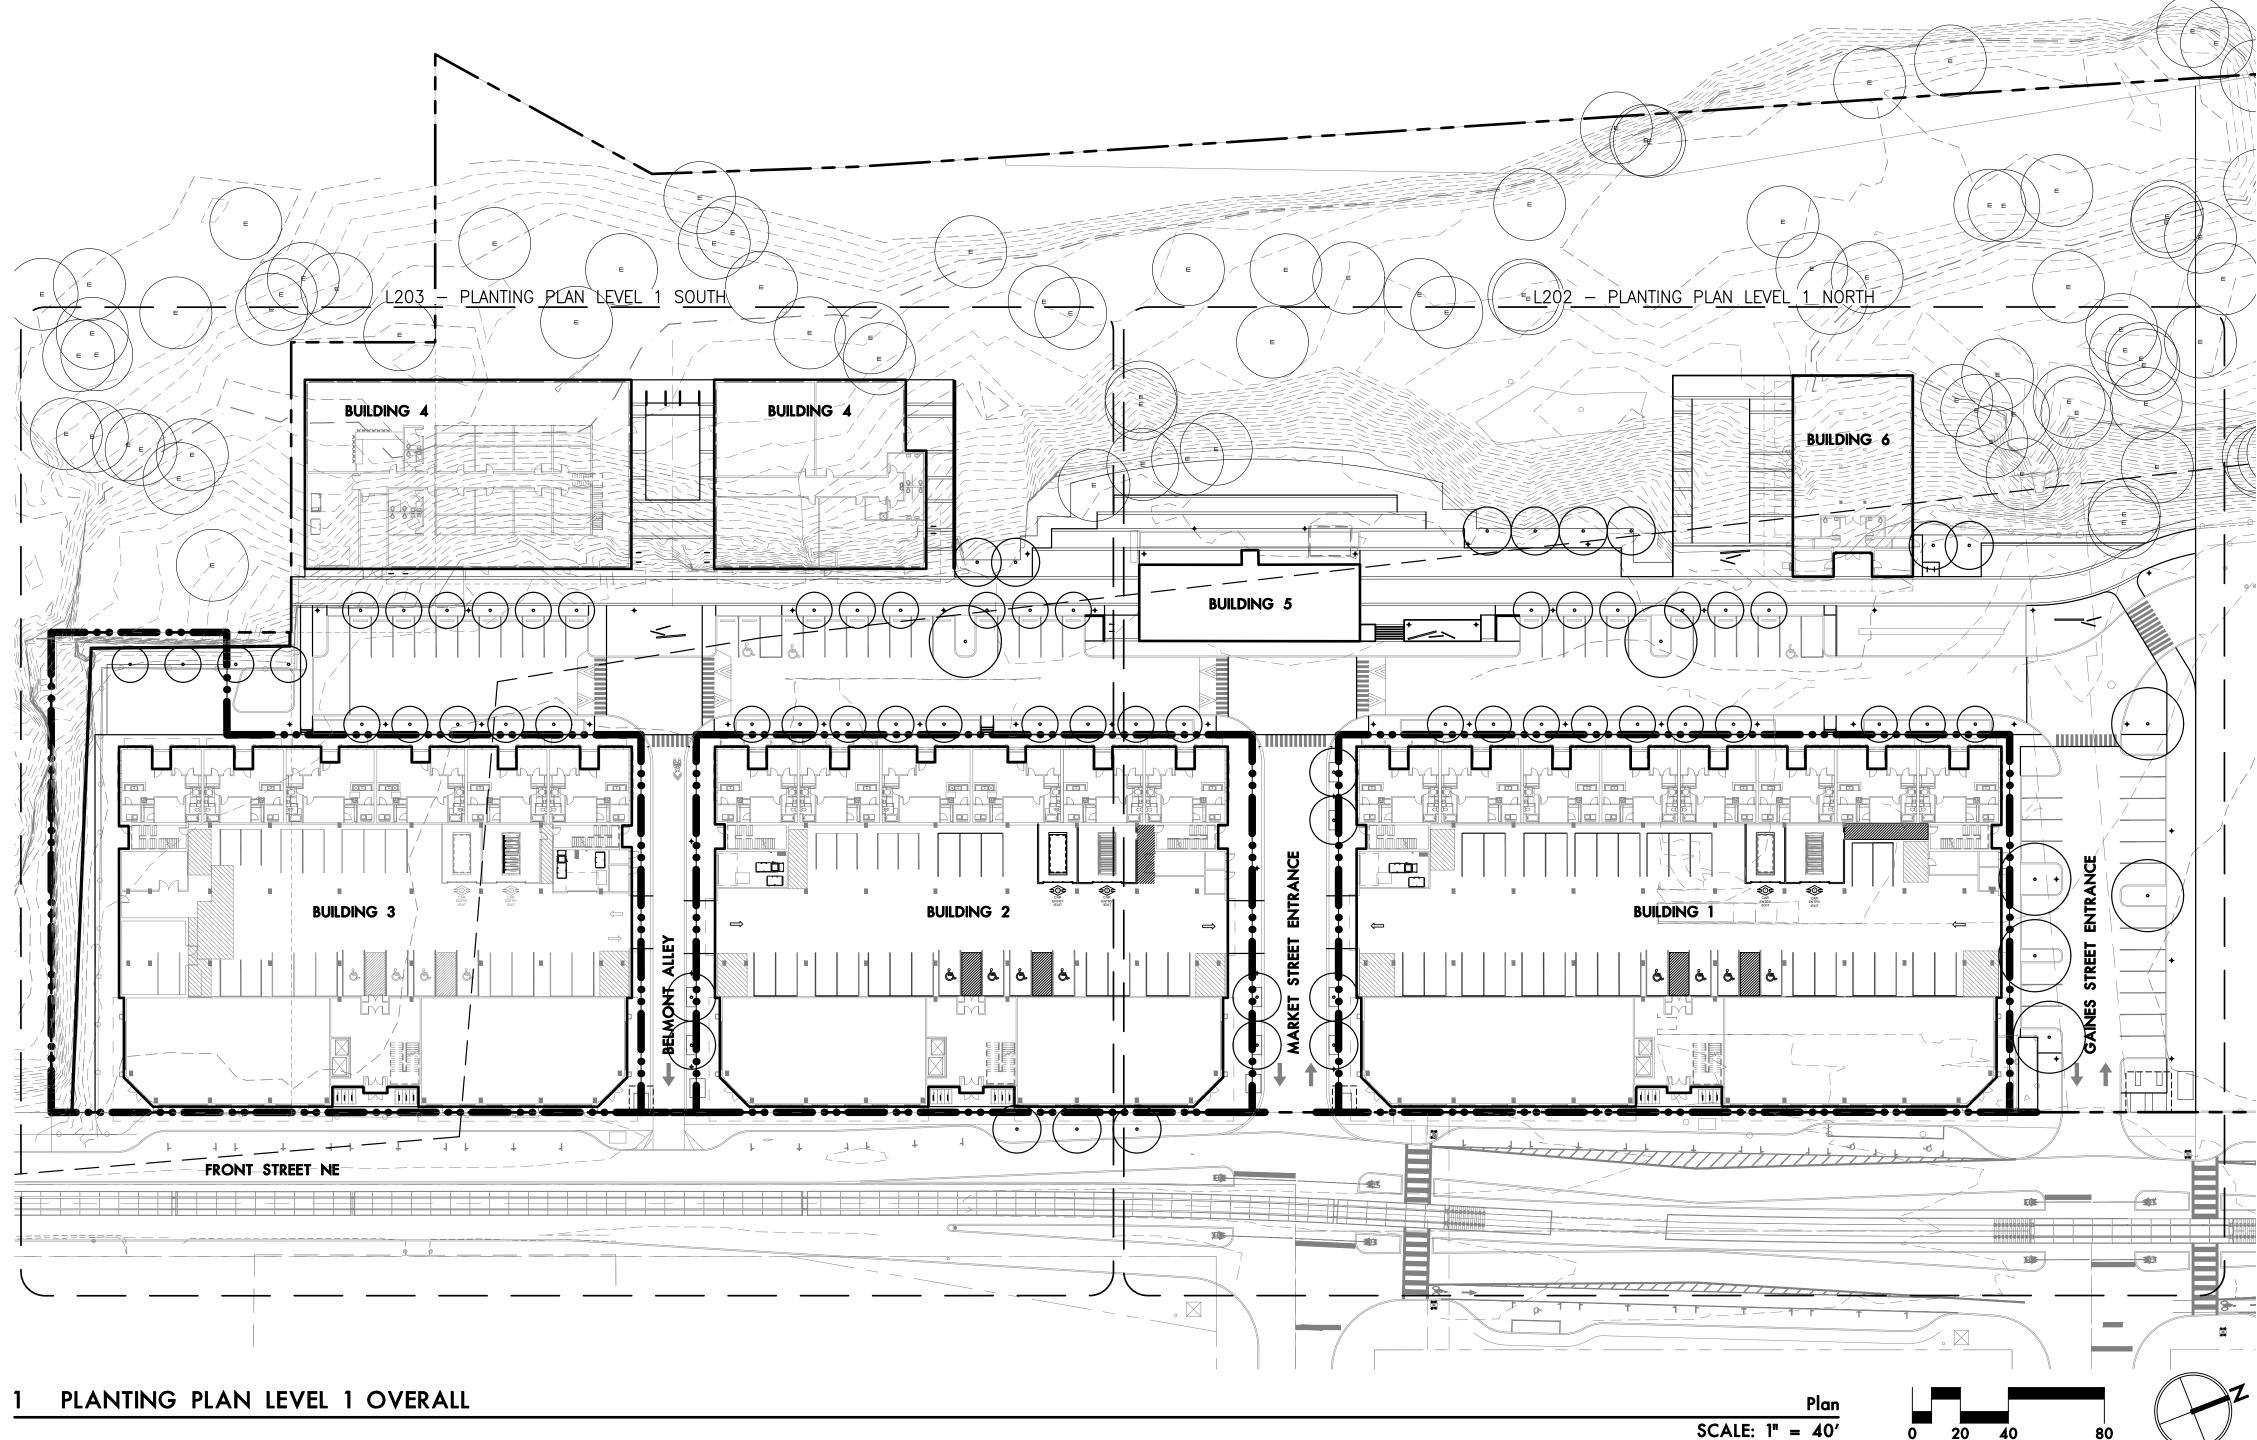

── ── WILLAMETTE RIVER GREENWAY
 ── ── PROPERTY LINE/RIGHT—OF—WAY
 ── INTERNAL PROPERTY LINE
 ── CONCRETE CURB
 ── BIKE RACK
 ♦ LIGHT POLE
 EXISTING TREE TO REMAIN

ABBREVIATIONS

CALIPER CONT CONTAINER DIAMETER DIAMETER AT BREAST HEIGHT EQUAL **HEIGHT** MINIMUM MAXIMUM NUMBER ON CENTER SIM SIMILAR SEEDED LAWN SPECS SPECIFICATIONS TYP TYPICAL CONTAINER SIZE

BALLED & BURLAPPED

PLANTING NOTES

- 1. THIS PLAN IS BASED ON A SURVEY BY AKS ENGINEERING AND FORESTRY DATED 2/17/2023. NOTIFY OWNER'S REPRESENTATIVE OF ANY DISCREPANCIES IDENTIFIED ON SITE RELATED TO SURVEY INFORMATION PRIOR TO INSTALLATION.
- 2. PROTECT EXISTING VEGETATION TO REMAIN.
- ALL PLANT MATERIAL SHALL BE NURSERY GROWN, WELL ROOTED, AND WELL BRANCHED. ALL TREES MUST BE FREE OF INSECTS, DISEASES, MECHANICAL INJURY, AND OTHER OBJECTIONABLE FEATURES WHEN PLANTED. ALL PLANT MATERIAL SHALL CONFORM TO "AMERICAN STOCK STANDARDS" LATEST EDITION.
- 4. ALL PLANT MATERIAL TO BE APPROVED BY LANDSCAPE ARCHITECT PRIOR TO INSTALLATION. SEE SPECIFICATIONS.
- 5. PLANT SPACING SHALL TAKE PRECEDENCE OVER VALVE BOX LOCATIONS. INSTALLED VALVE BOXES THAT CONFLICT WITH ACCEPTED PLANT LAYOUT SHALL BE MOVED TO POSITION BETWEEN PLANTS.
 - PLANT COUNTS FOR TREES AND SHRUBS ARE SUPPLIED FOR THE CONTRACTOR'S CONVENIENCE. CONTRACTOR RESPONSIBLE FOR INSTALLING ALL PLANTS IN LOCATIONS AND QUANTITIES SHOWN.
- CLEAR PLANT BEDS OF ALL GRAVEL AND DEBRIS PRIOR TO SOIL PREPARATION AND PLANTING, FOR APPROVAL BY LANDSCAPE ARCHITECT.
- 8. TREES TO BE RETAINED AND/OR PLANTED SHALL BE WATERED AS NECESSARY TO MINIMIZE STRESS TO THE TREE, PROMOTE ROOT GROWTH, AND ENSURE SURVIVAL, THROUGHOUT THE CONSTRUCTION PERIOD AND THE FIRST THREE GROWING SEASONS AFTER PLANTING. TREES SHALL BE MULCHED WITH COMPOST MULCH, SEE SPECIFICATIONS. PROTECTIVE BARRIERS SHALL STAY IN PLACE UNTIL PLANNING OFFICIAL AUTHORIZES THEIR REMOVAL OR A FINAL CERTIFICATE OF OCCUPANCY IS ISSUED, WHICHEVER OCCURS FIRST. STAKING & FERTILIZING SHALL BE REQUIRED WHERE DEEMED NECESSARY BY PLANNING OFFICIAL. SEE SECTION 015639 FOR ADDITIONAL REQUIREMENTS.
- 9. ALL LANDSCAPE AREAS THAT HAVE A SLOPE GREATER THAN 1 VERTICAL FOOT IN 3 HORIZONTAL FEET SHALL RECEIVE JUTE MATTING, SEE SPECIFICATIONS.
- 10. ALL PLANTING AREAS ARE TO BE IRRIGATED WITH A PERMANENT AUTOMATIC IRRIGATION SYSTEM EXCEPT RESEEDED DISTURBED AREAS, THOSE ARE ARE TO BE NON-IRRIGATED.
- 11. ALL PARKING LOT AND STREET TREES MUST HAVE 6' CLEAR HEIGHT TO LOWEST BRANCHES.
- 12. SEE L204 FOR PLANTING SCHEDULE.

ango.hansen

里

1105 FRONT ST NE,

LAND USE SUBMITTAL

PLANTING PLAN LEVEL 1 OVERALL

REVISIONS

SCALE

DRAWN BY
DATE
PROJECT NO.

SHEET

L201

2024.03.15

2346-SAC

WILLAMETTE RIVER GREENWAY
PROPERTY LINE/RIGHT-OF-WAY
INTERNAL PROPERTY LINE
CONCRETE CURB
BIKE RACK

♦ LIGHT POLE

EXISTING TREE TO REMAIN

STORMWATER FACILITY PLANTED TO CITY OF SALEM STANDARDS

PLANTING NOTES

- 1. SEE L201 FOR GENERAL NOTES AND ABBREVIATIONS.
- 2. SEE L204 FOR PLANTING SCHEDULE.

CANNERY

1105 FRONT ST N SALEM, OR 9730

PLANTING PLAN LEVEL 1
NORTH

REVISIONS

SCALE DRAWN BY

DATE 2024.03.15 PROJECT NO. 2346-SAC

SHEET

L202

── ── WILLAMETTE RIVER GREENWAY
── ── ── PROPERTY LINE/RIGHT—OF—WAY
── ── INTERNAL PROPERTY LINE
── ── CONCRETE CURB
── BIKE RACK
♦ LIGHT POLE

EXISTING TREE TO REMAIN

STORMWATER FACILITY PLANTED TO

STORMWATER FACILITY PLANT
CITY OF SALEM STANDARDS

PLANTING NOTES

- 1. SEE L201 FOR GENERAL NOTES AND ABBREVIATIONS.
- 2. SEE L204 FOR PLANTING SCHEDULE.

HE CANNERY

1105 FRON SALEM, O

PLANTING PLAN LEVEL 1
SOUTH

REVISIONS

SCALE DRAWN BY

DATE 2024.03.15
PROJECT NO. 2346-SAC

SHEET

L203

PLANT S	CHEDULE	- ONSITE TREES					
SYMBOL	ABBR	BOTANICAL NAME	COMMON NAME	NATIVE	SIZE/ CONDITION	SPACING	QUANTITY
	TREES						
+	АМ	Acer macrophyllum	Big Leaf Maple	YES	3" CAL B&B	AS SHOWN	8
+	FP	Frangula purshiana	Cascara	YES	3" CAL B&B (SMALL)	AS SHOWN	24
+	PY	Prunus x Yedoensis	Yoshino Cherry	NO	3" CAL B&B (SMALL)	AS SHOWN	30
+ +	QR	Quercus rubra	Red Oak	NO	3" CAL B&B (LARGE)	AS SHOWN	7

PLANT S	CHEDULE	- ONSITE PLANTINGS						
SYMBOL	ABBR	BOTANICAL NAME	COMMON NAME	NATIVE	SIZE/ CONDITION	SPACING	QUANTITY	
	SHRUB	5						
H	COSE	Cornus sericea 'Arctic Fire'	Arctic Fire Redosier Dogwood	YES	#5/CONT. 6'+HT (MATURE)	AS SHOWN	113	
(\star)	MARE	Mahonia repens	Creeping Oregon Grape	YES	#1/CONT.	AS SHOWN	462	
\bigotimes	GASH	Gaultheria shallon	Salal	YES	#1/CONT.	AS SHOWN	100	
0	VAOV	Vaccinium ovatum	Evergreen Huckleberry	YES	#5/CONT. 6+HT (MATURE)	AS SHOWN	609	
	GROUNDCOVER AND GRASSES							
	ARUV	Arctostaphylos uva—ursi	Kinnikinnick	YES	#1/CONT.	18" O.C.	1430	
\bigcirc	DECE	Deschampsia cespitosa	Tufted Hairgrass	YES	#3/CONT.	AS SHOWN	146	
	FRCH	Fragaria chiloensis	Coast Strawberry	YES	#1/CONT.	18" O.C.	2023	
	HEMI	Heuchera micrantha	Smallflowered Alumroot	YES	#1/CONT.	AS SHOWN	159	
	STORMWATER PLANTINGS - 5,233 SF							
	CADE	Carex densa	Dense Sedge	YES	#1/CONT.	12" O.C.		
	DECE	Deschampsia cespitosa	Tufted Hair Grass	YES	#1/CONT.	12" O.C.		
	JUPA	Juncus patens	Spreading Rush	YES	#1/CONT.	12" O.C.		

NNERY

105 FRONT ST NE,

PLANTING SCHEDULE LEVEL 1

REVISIONS

SCALE DRAWN

DRAWN BY DATE PROJECT NO.

SHEET

1 201

2024.03.15

2346-SAC

OVERALL

DRAWN BY PROJECT NO.

SHEET

2024.03.15


2346-SAC

LEGEND

---- LIMIT OF WORK -/--/-/- METAL EDGE RAISED PLANTER SCREEN FENCE

PLANTING NOTES

1. SEE L201 FOR GENERAL NOTES AND ABBREVIATIONS.

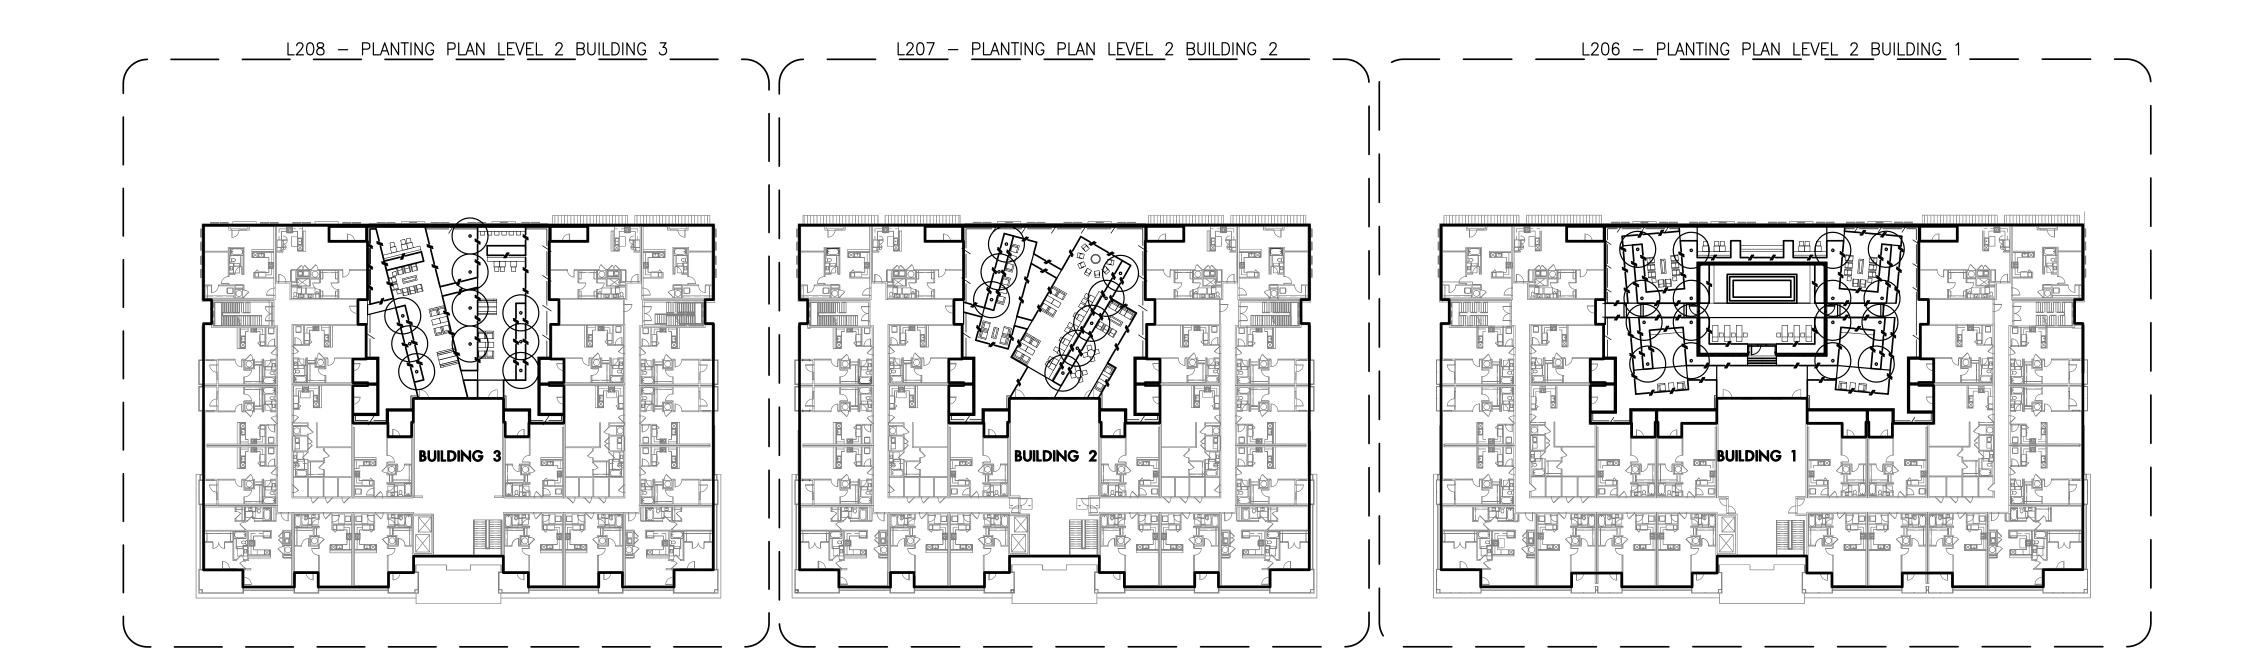

PLANTING PLAN LEVEL 2 OVERALL





---- LIMIT OF WORK

RAISED PLANTER

SCREEN FENCE

CANOPY TREE

NATIVE PLANTINGS

_/__/__/_ METAL EDGE

PLANTING NOTES

REVISIONS

SCALE


DRAWN BY
DATE
PROJECT NO.

PROJECT NO. 2346-SAC

SHEET

2024.03.15

1204

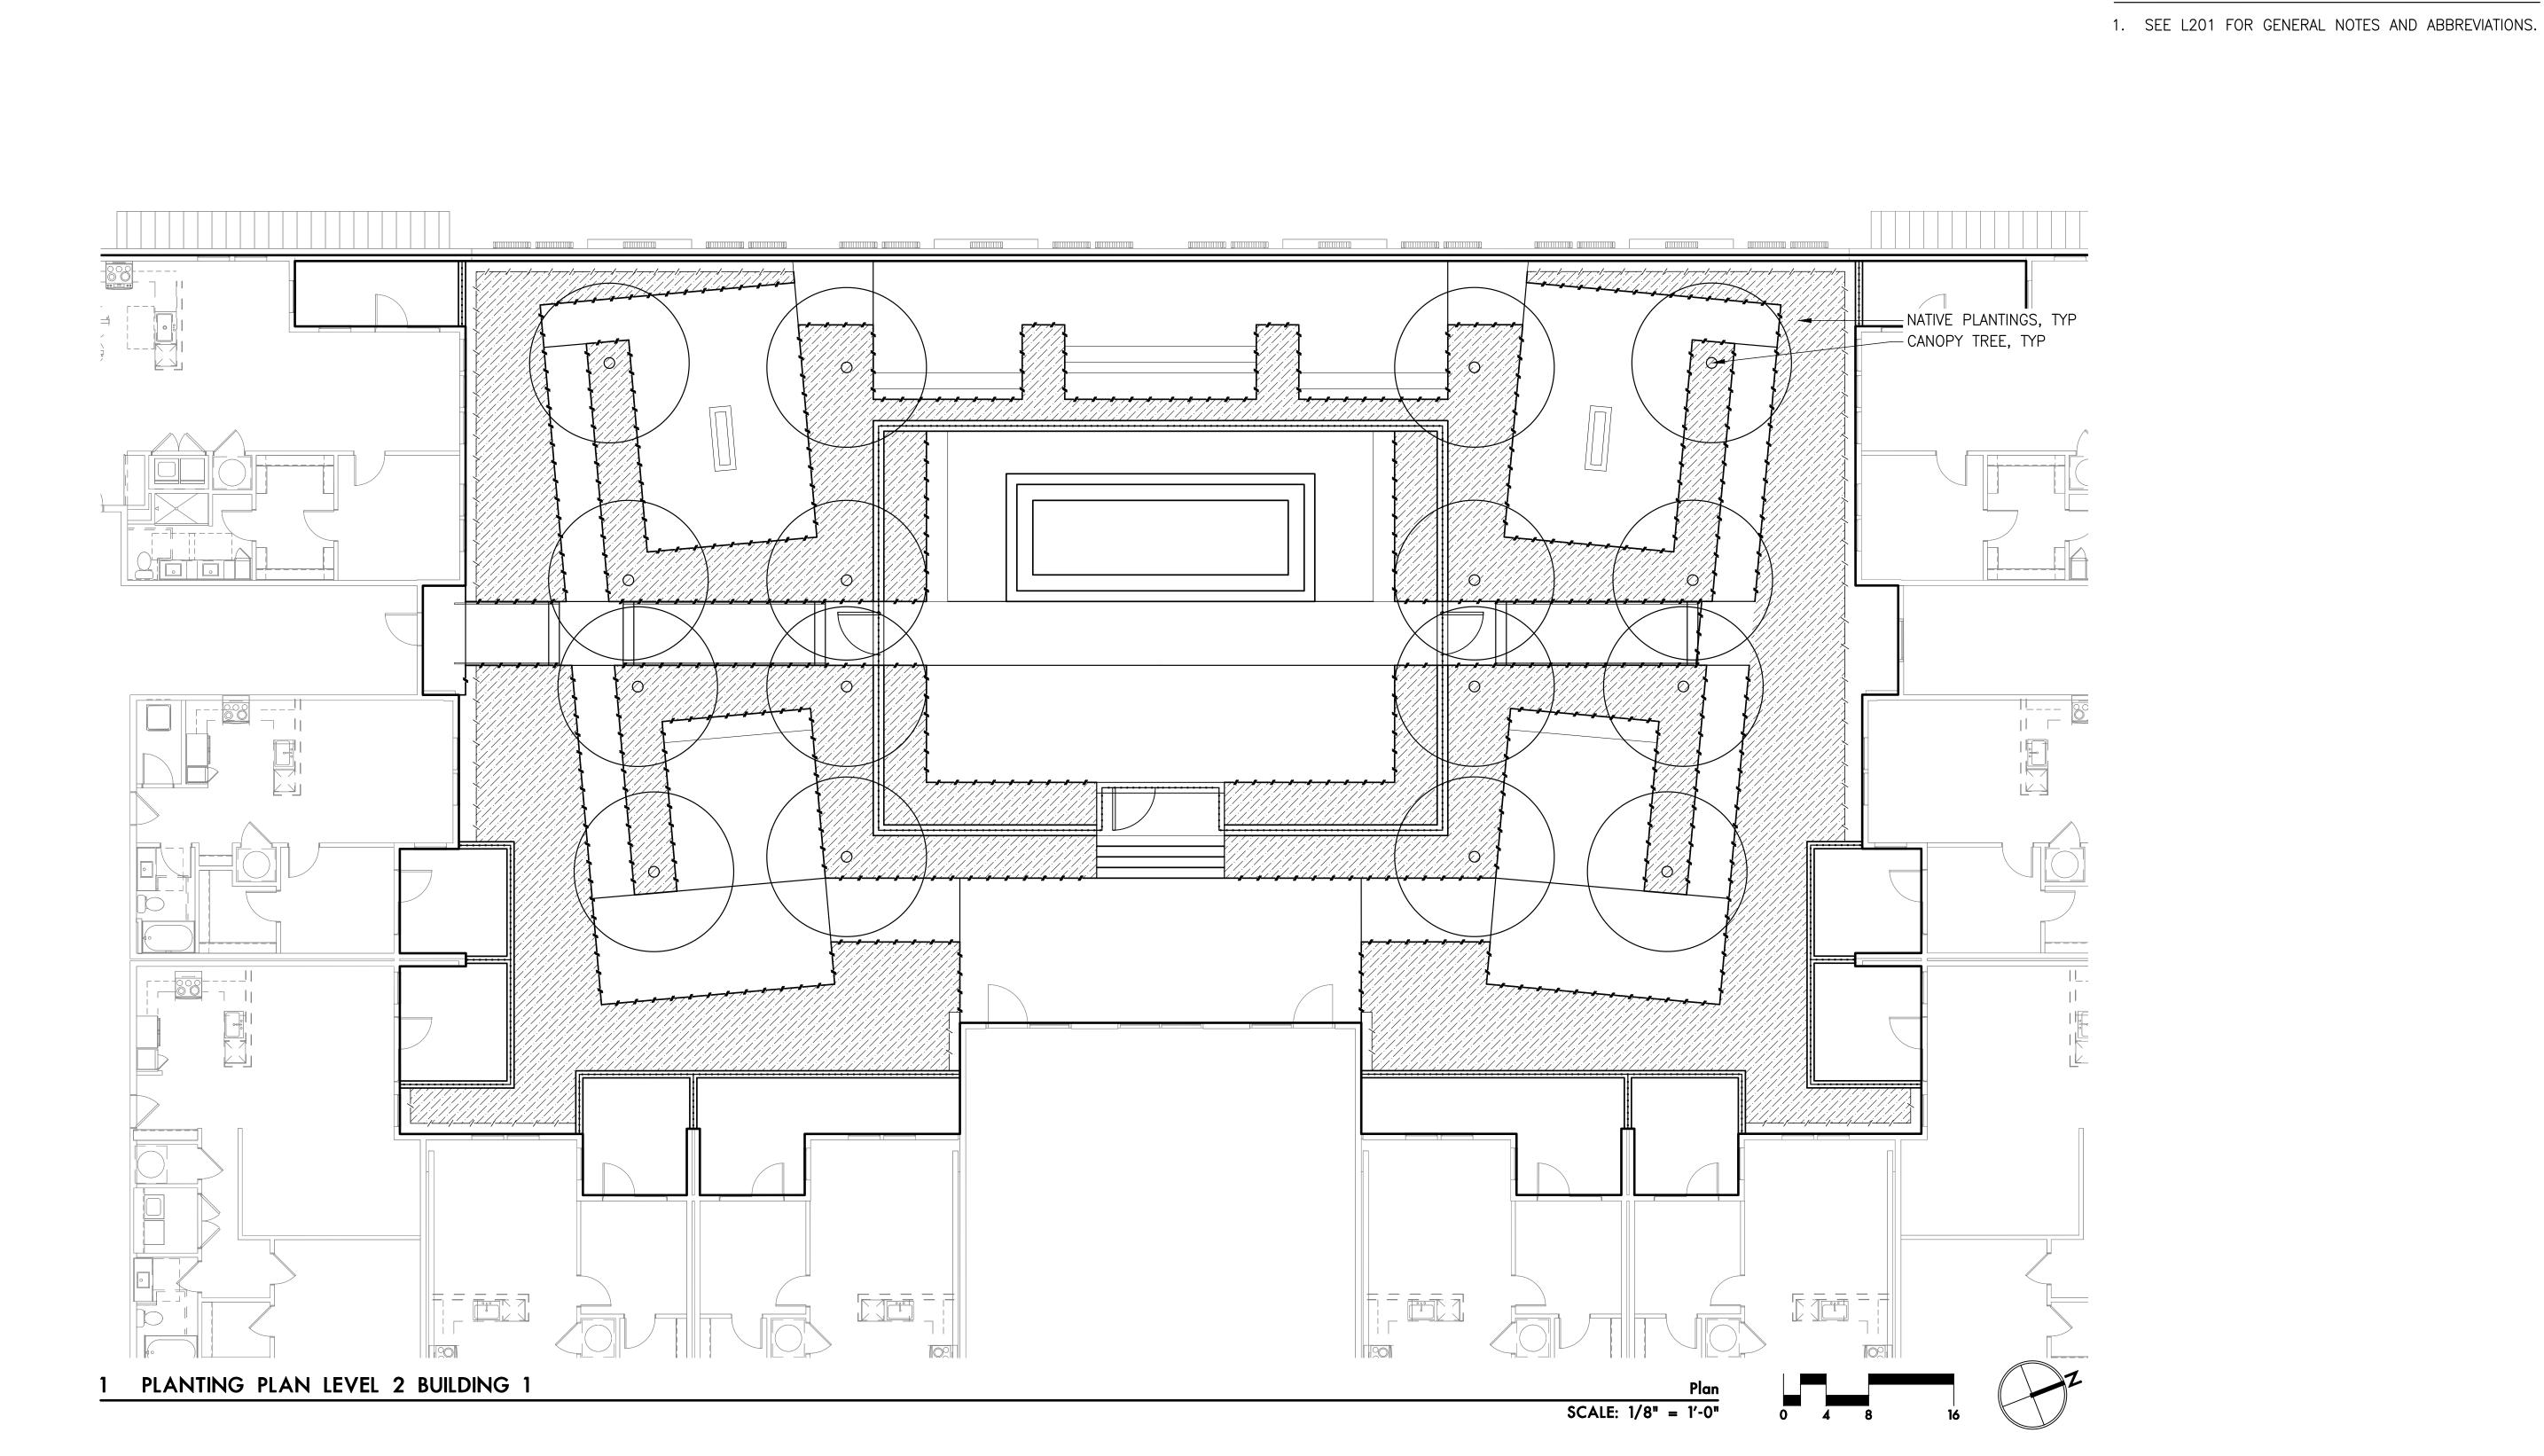

---- LIMIT OF WORK

------ RAISED PLANTER

SCREEN FENCE

CANOPY TREE

NATIVE PLANTINGS

//_/ METAL EDGE

LAND USE SUBMITTAL PLANTING PLAN LEVEL 2 BUILDING 2


REVISIONS

SCALE DRAWN BY

2024.03.15 2346-SAC PROJECT NO.

SHEET

L207

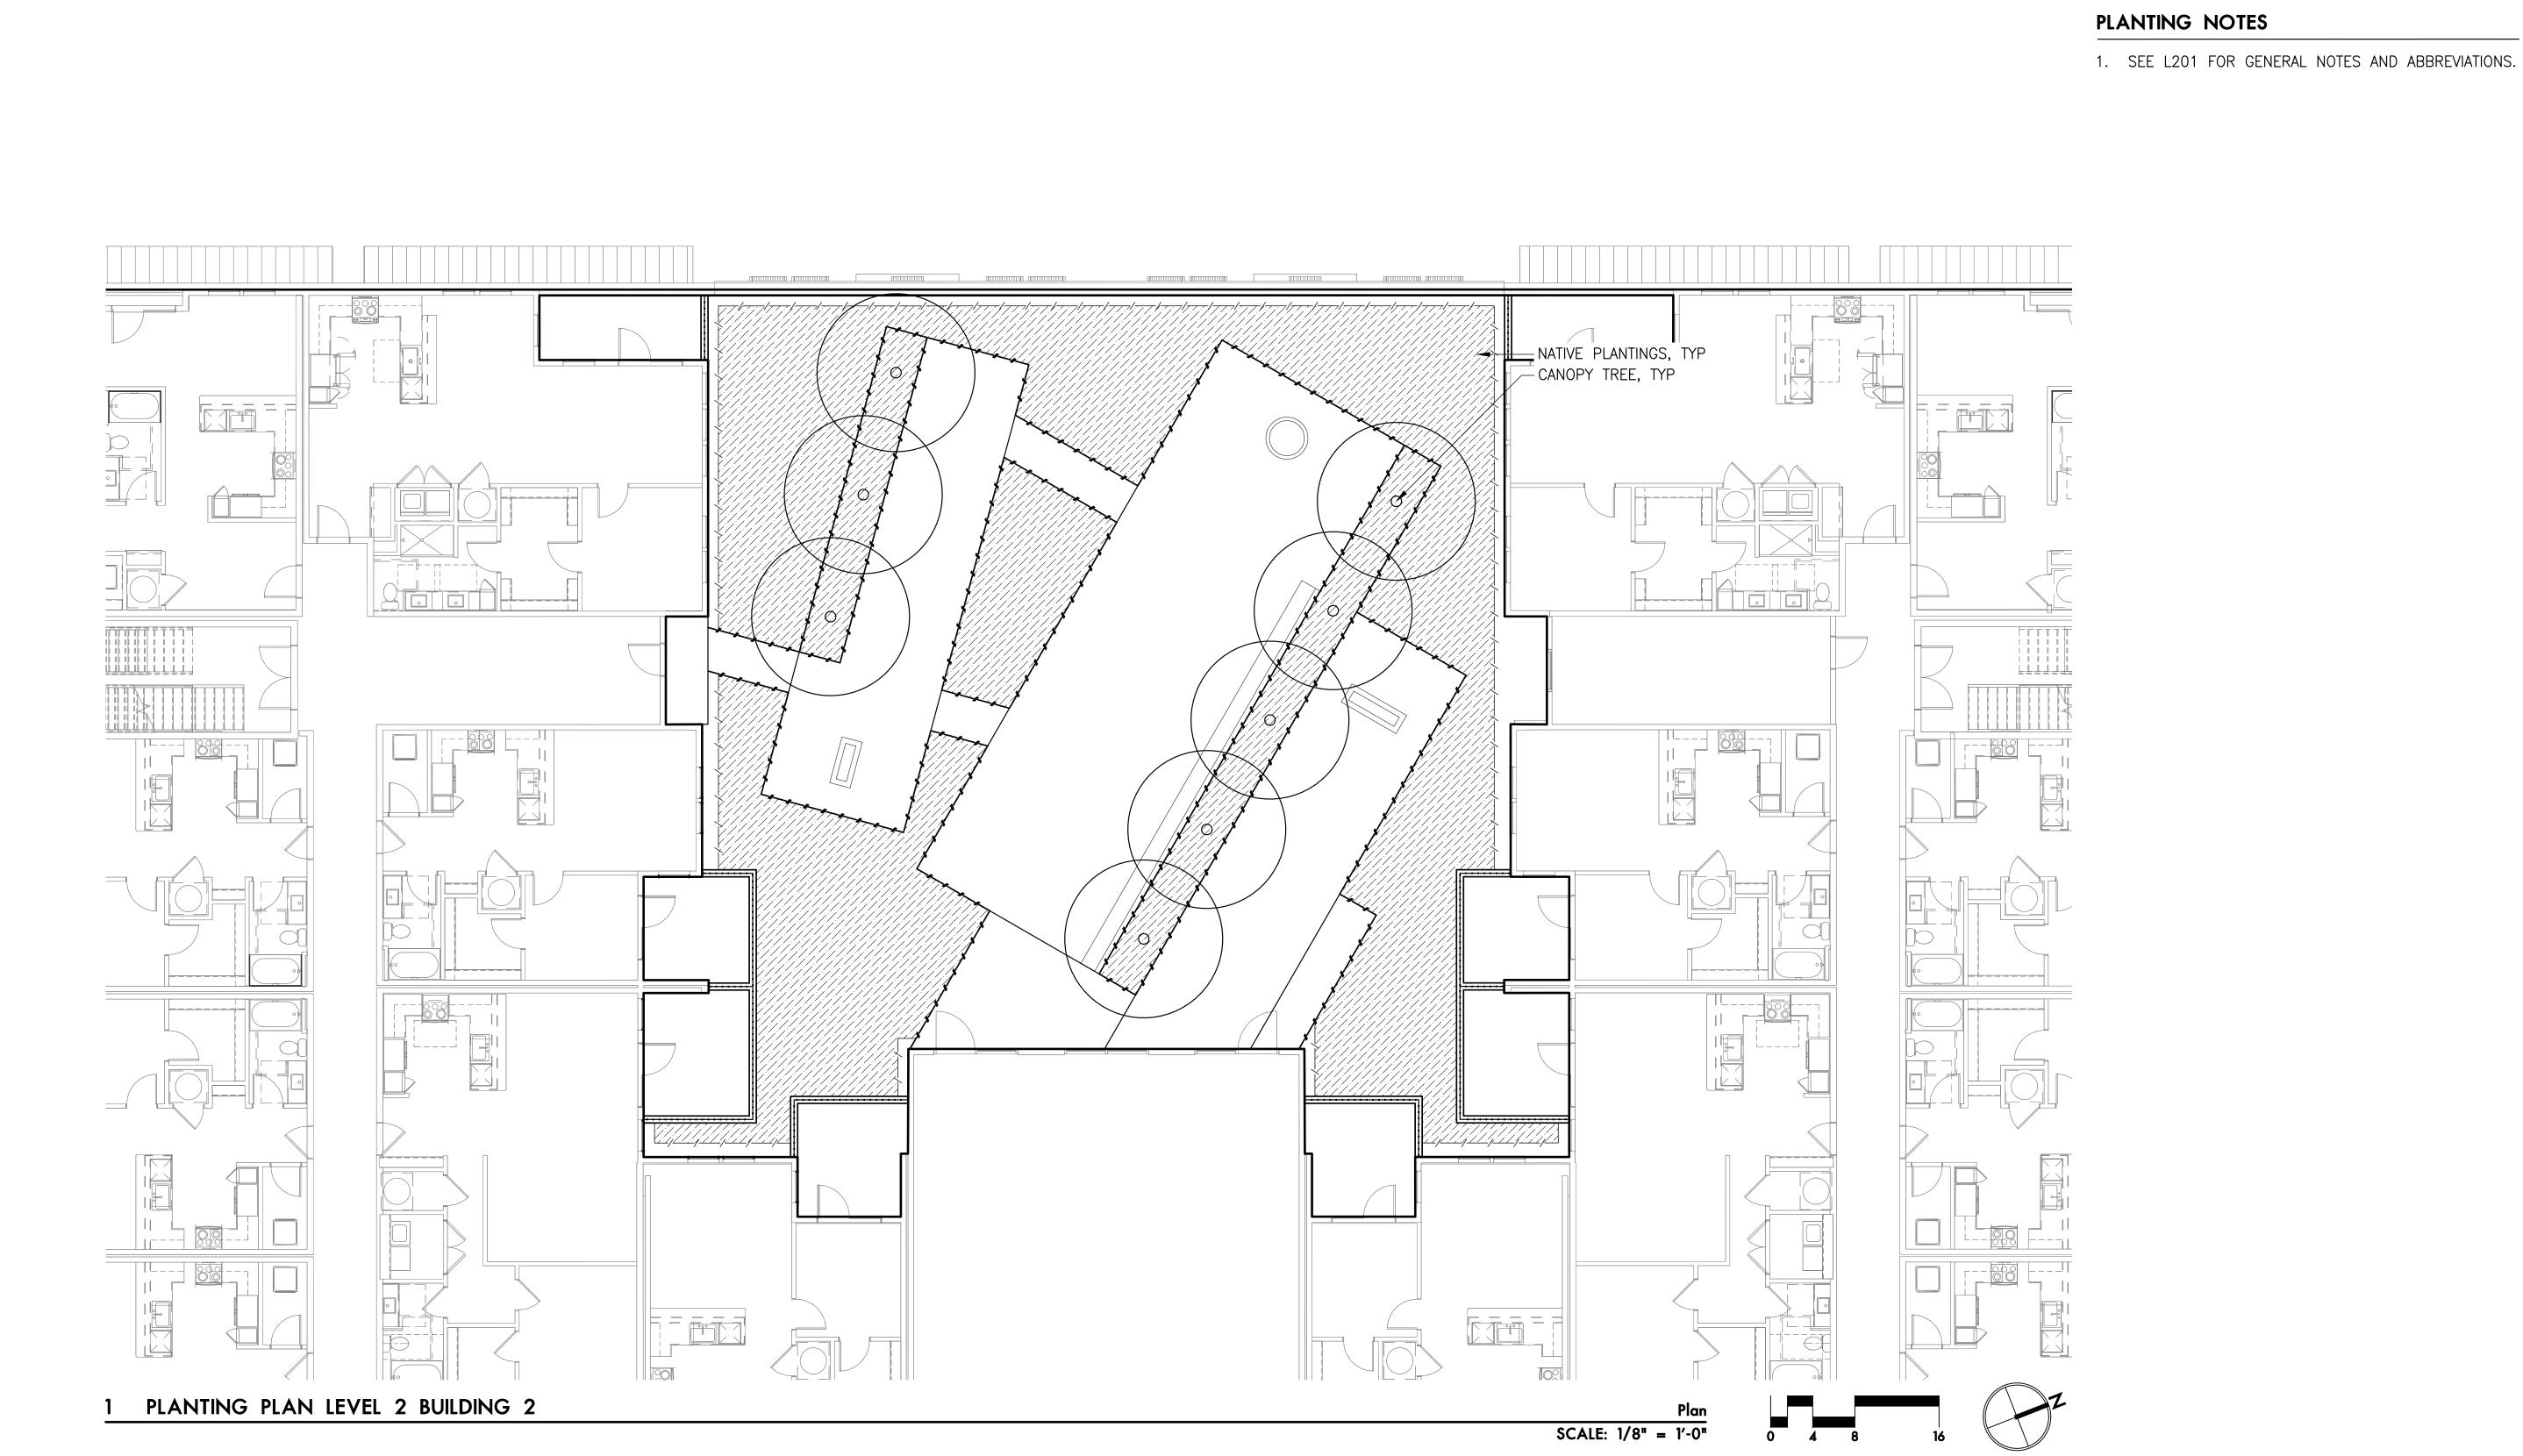

---- LIMIT OF WORK

------ RAISED PLANTER

SCREEN FENCE

NATIVE PLANTINGS

1. SEE L201 FOR GENERAL NOTES AND ABBREVIATIONS.

CANOPY TREE

//_/_ METAL EDGE

PLANTING NOTES


LAND USE SUBMITTAL PLANTING PLAN LEVEL 2 BUILDING 3

REVISIONS

SCALE DRAWN BY

2024.03.15 2346-SAC PROJECT NO.

SHEET

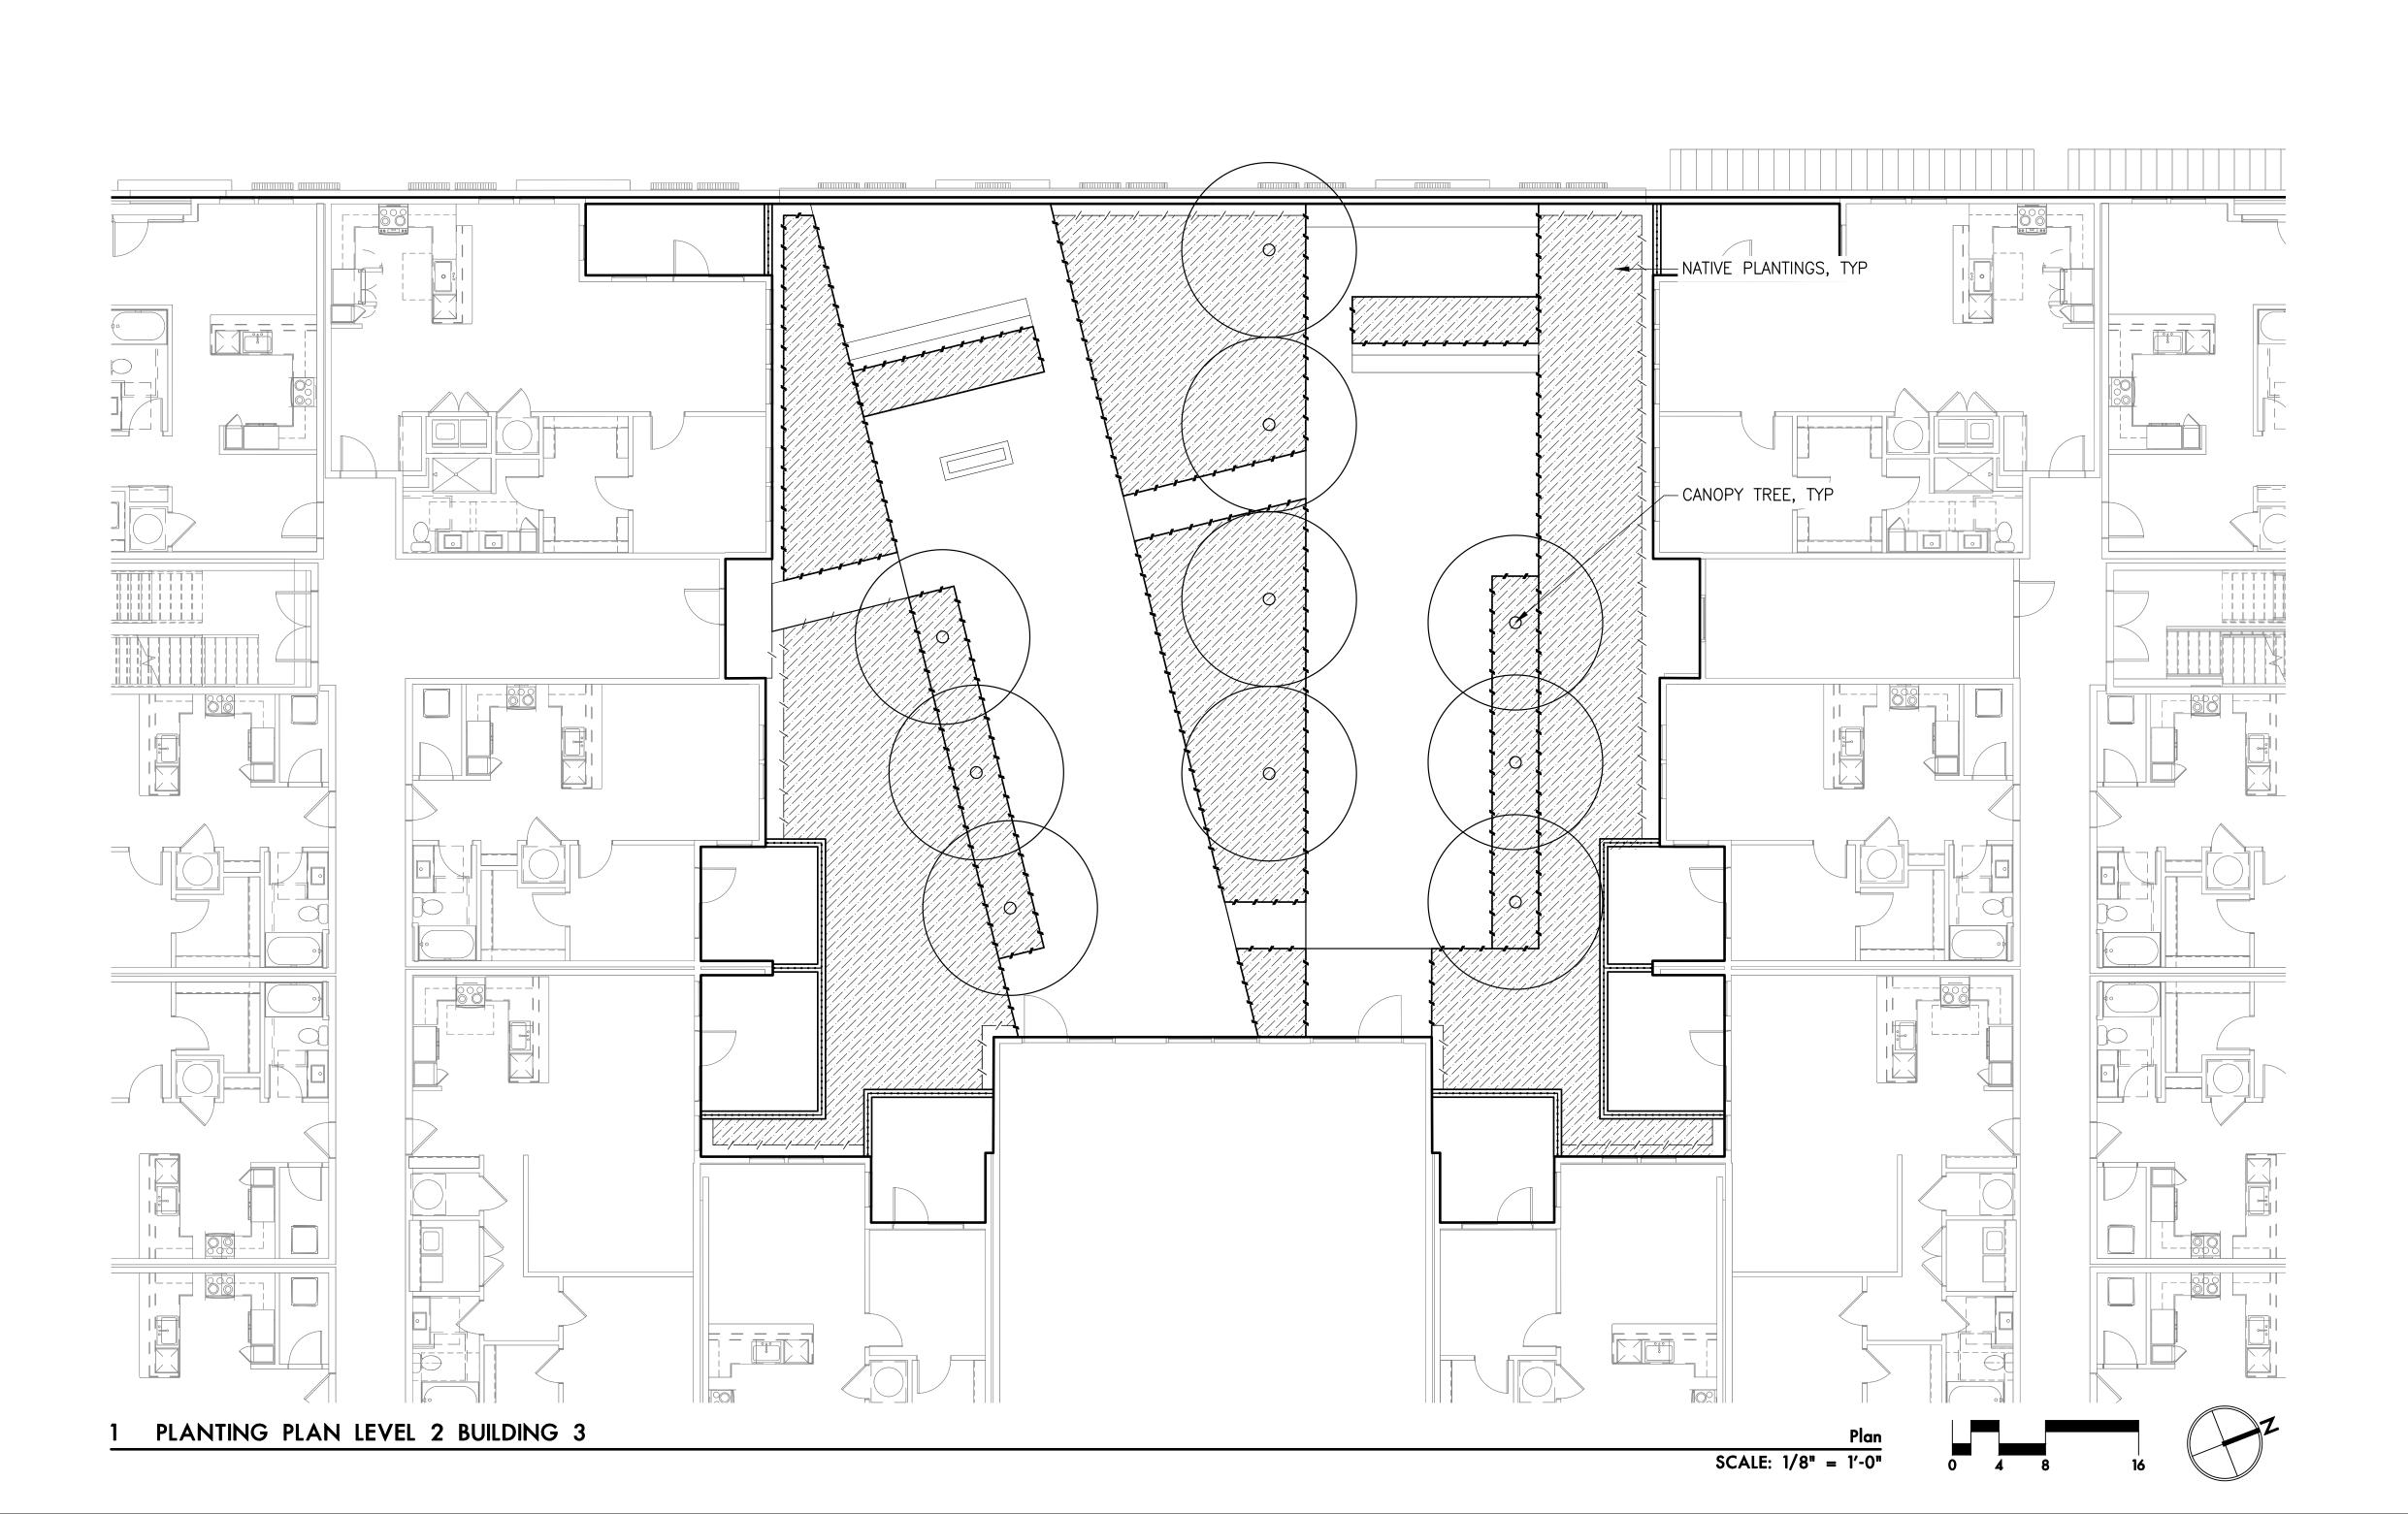


Attachment E: Revised Preliminary Building Elevations and Floor Plans



FLOOR	BLDG I	BLDG II	BLDG III
1ST	8	6	6
2ND	26	22	22
3RD	27	23	23
4TH	27	23	23
5TH	27	23	23
6TH	27	23	23
TOTAL	142	120	120

TOTAL NO. OF UNITS: 382

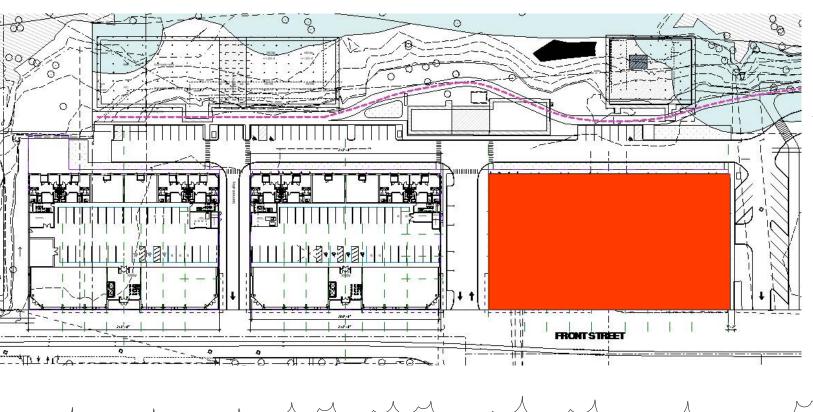





INSIGHT ARCHITECTS, PC The Cannery 1307 West Morehead Street
Suite 108
Charlotte, NC 28208

BLDG I
Salem Oregon
Building Elevations



REVISION 1 Revision 1

DATE 05/07/2024 81% GLAZING* 91% WEATHERPROTECTION

*Calculated per SRC 112.030 (b)

A 02



60% GLAZING*
56% WEATHERPROTECTION

*Calculated per SRC 112.030 (b)

June 19, 2024 The Cannery BLDG I - RIVER VIEW ELEVATION scale 1'=3/32"

DATE

06/19/2024

REVISION

2 Unit Changes




REVISION
2 Unit Changes

DATE 06/19/2024




REVISION
2 Unit Changes


DATE 06/19/2024

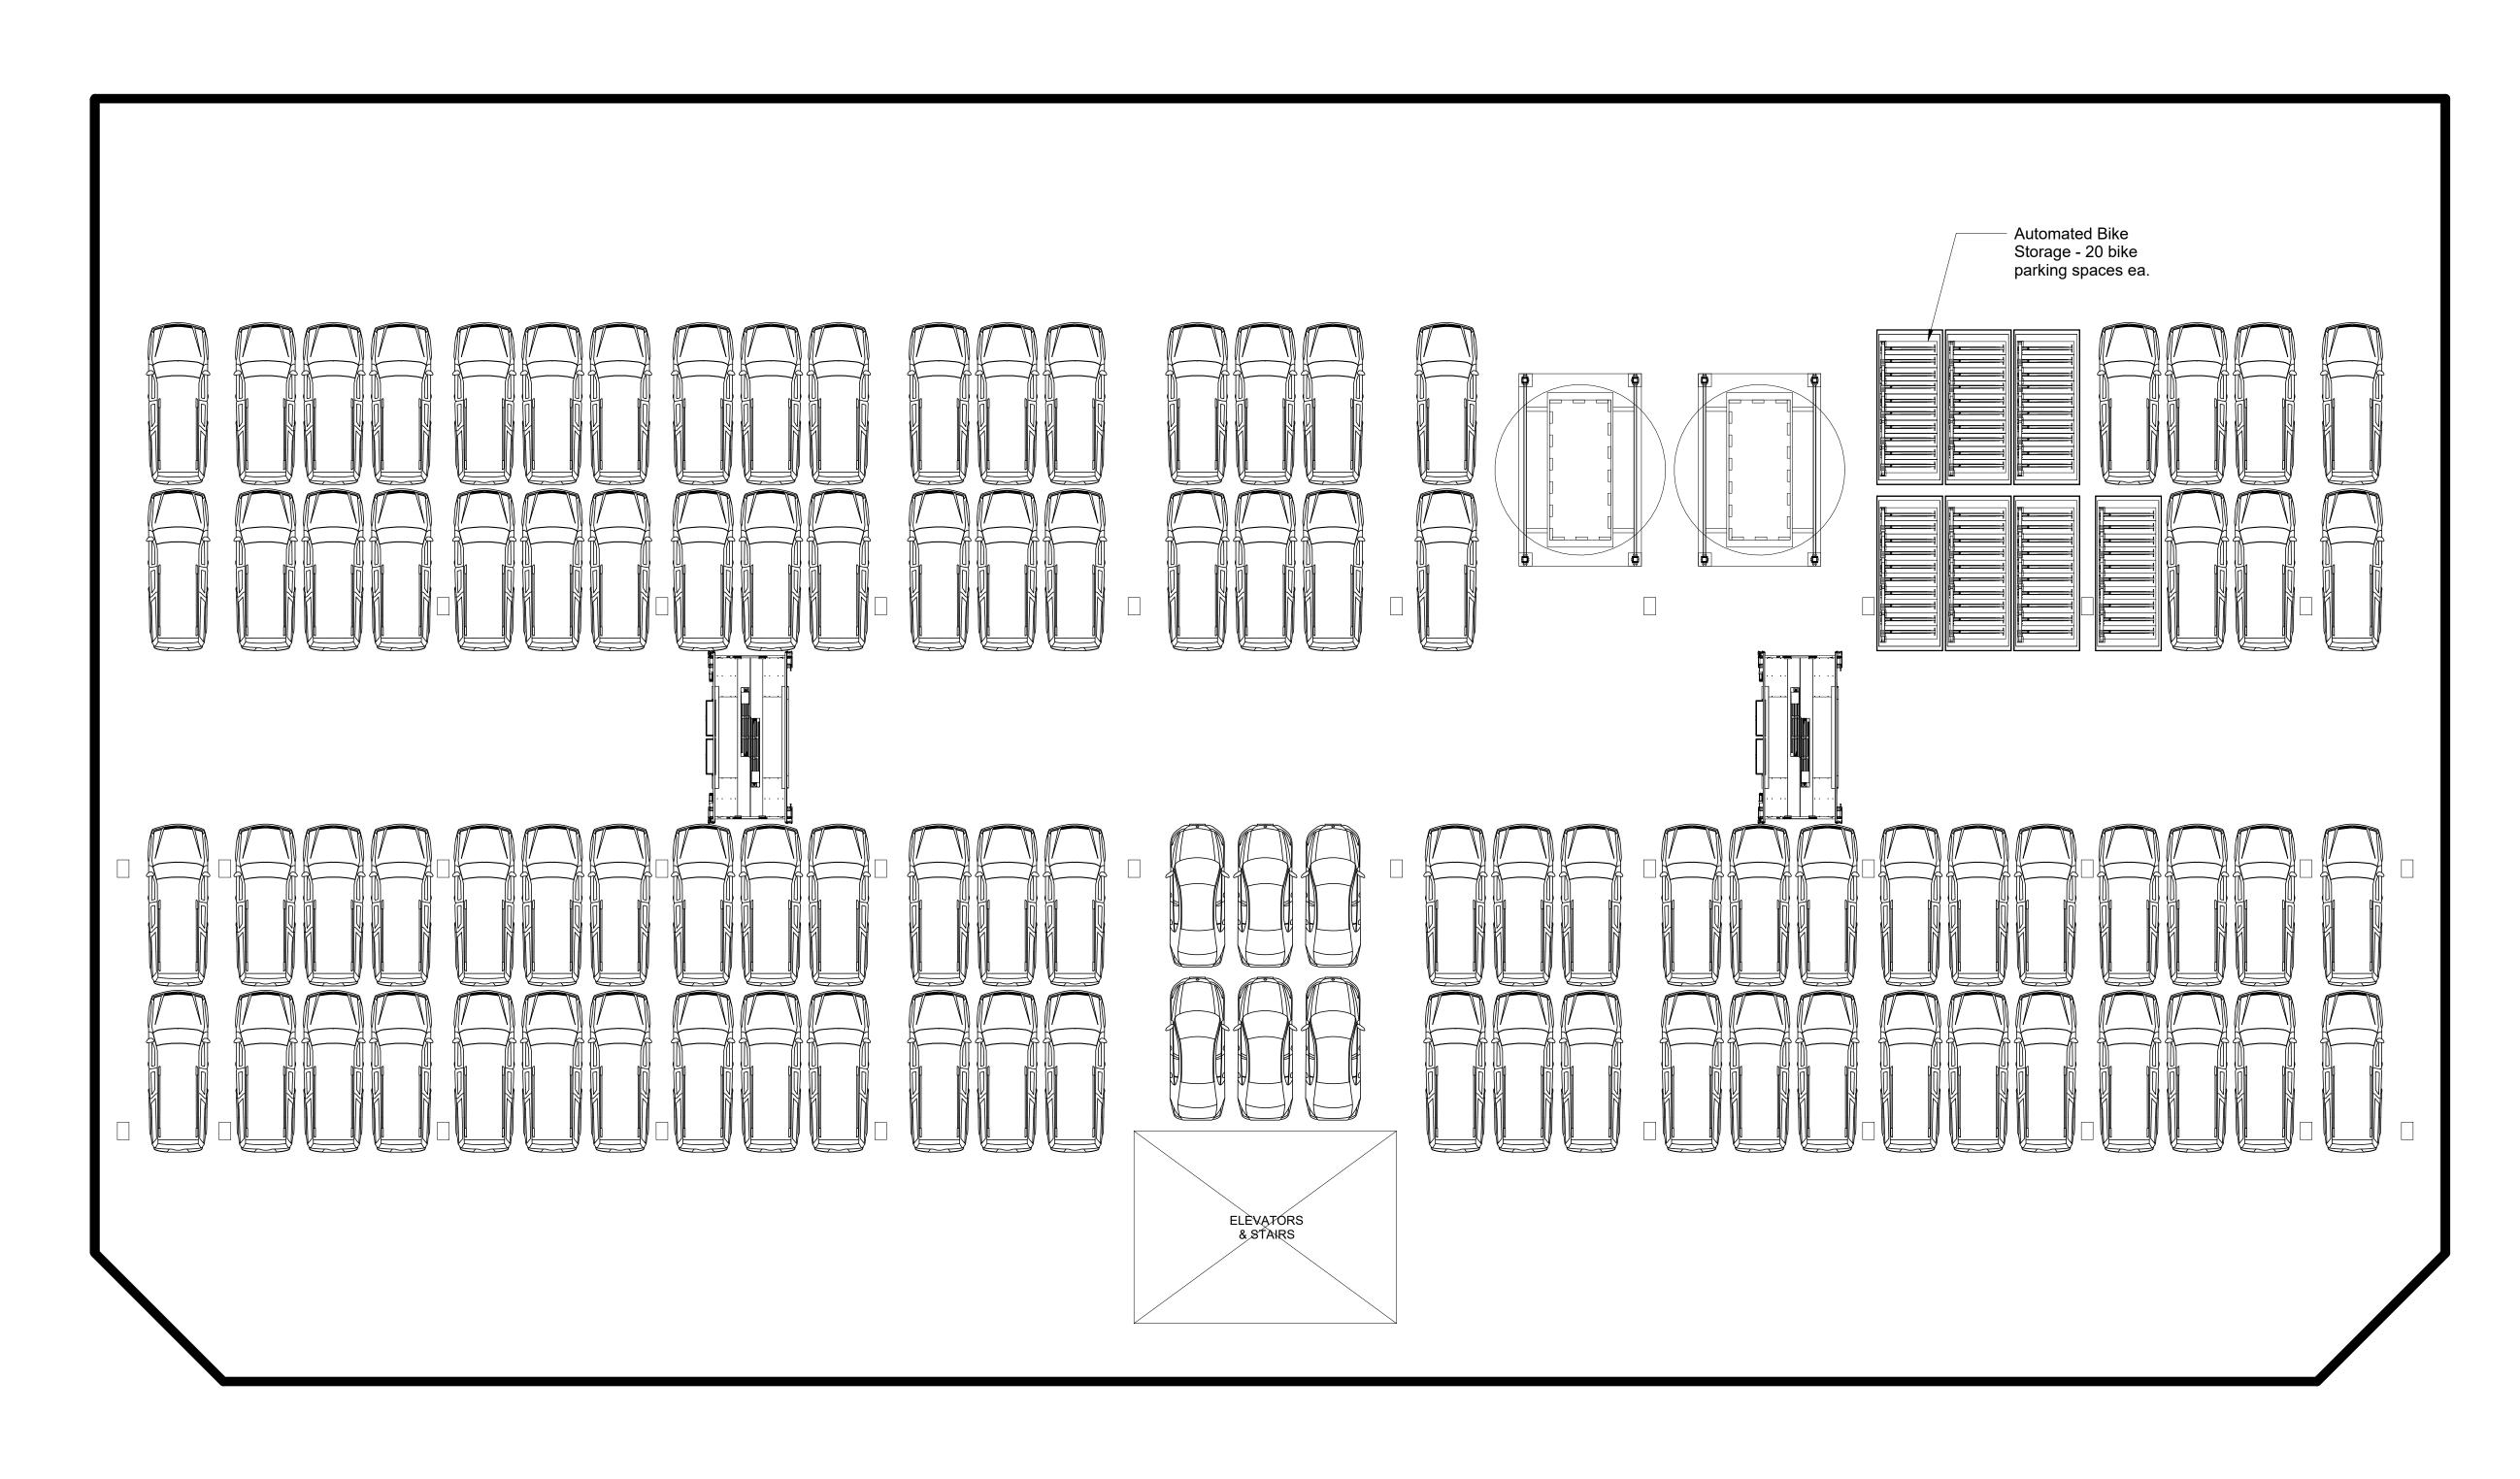

REVISION **NEW SHEET** 1 Revision 1


DATE 05/07/2024

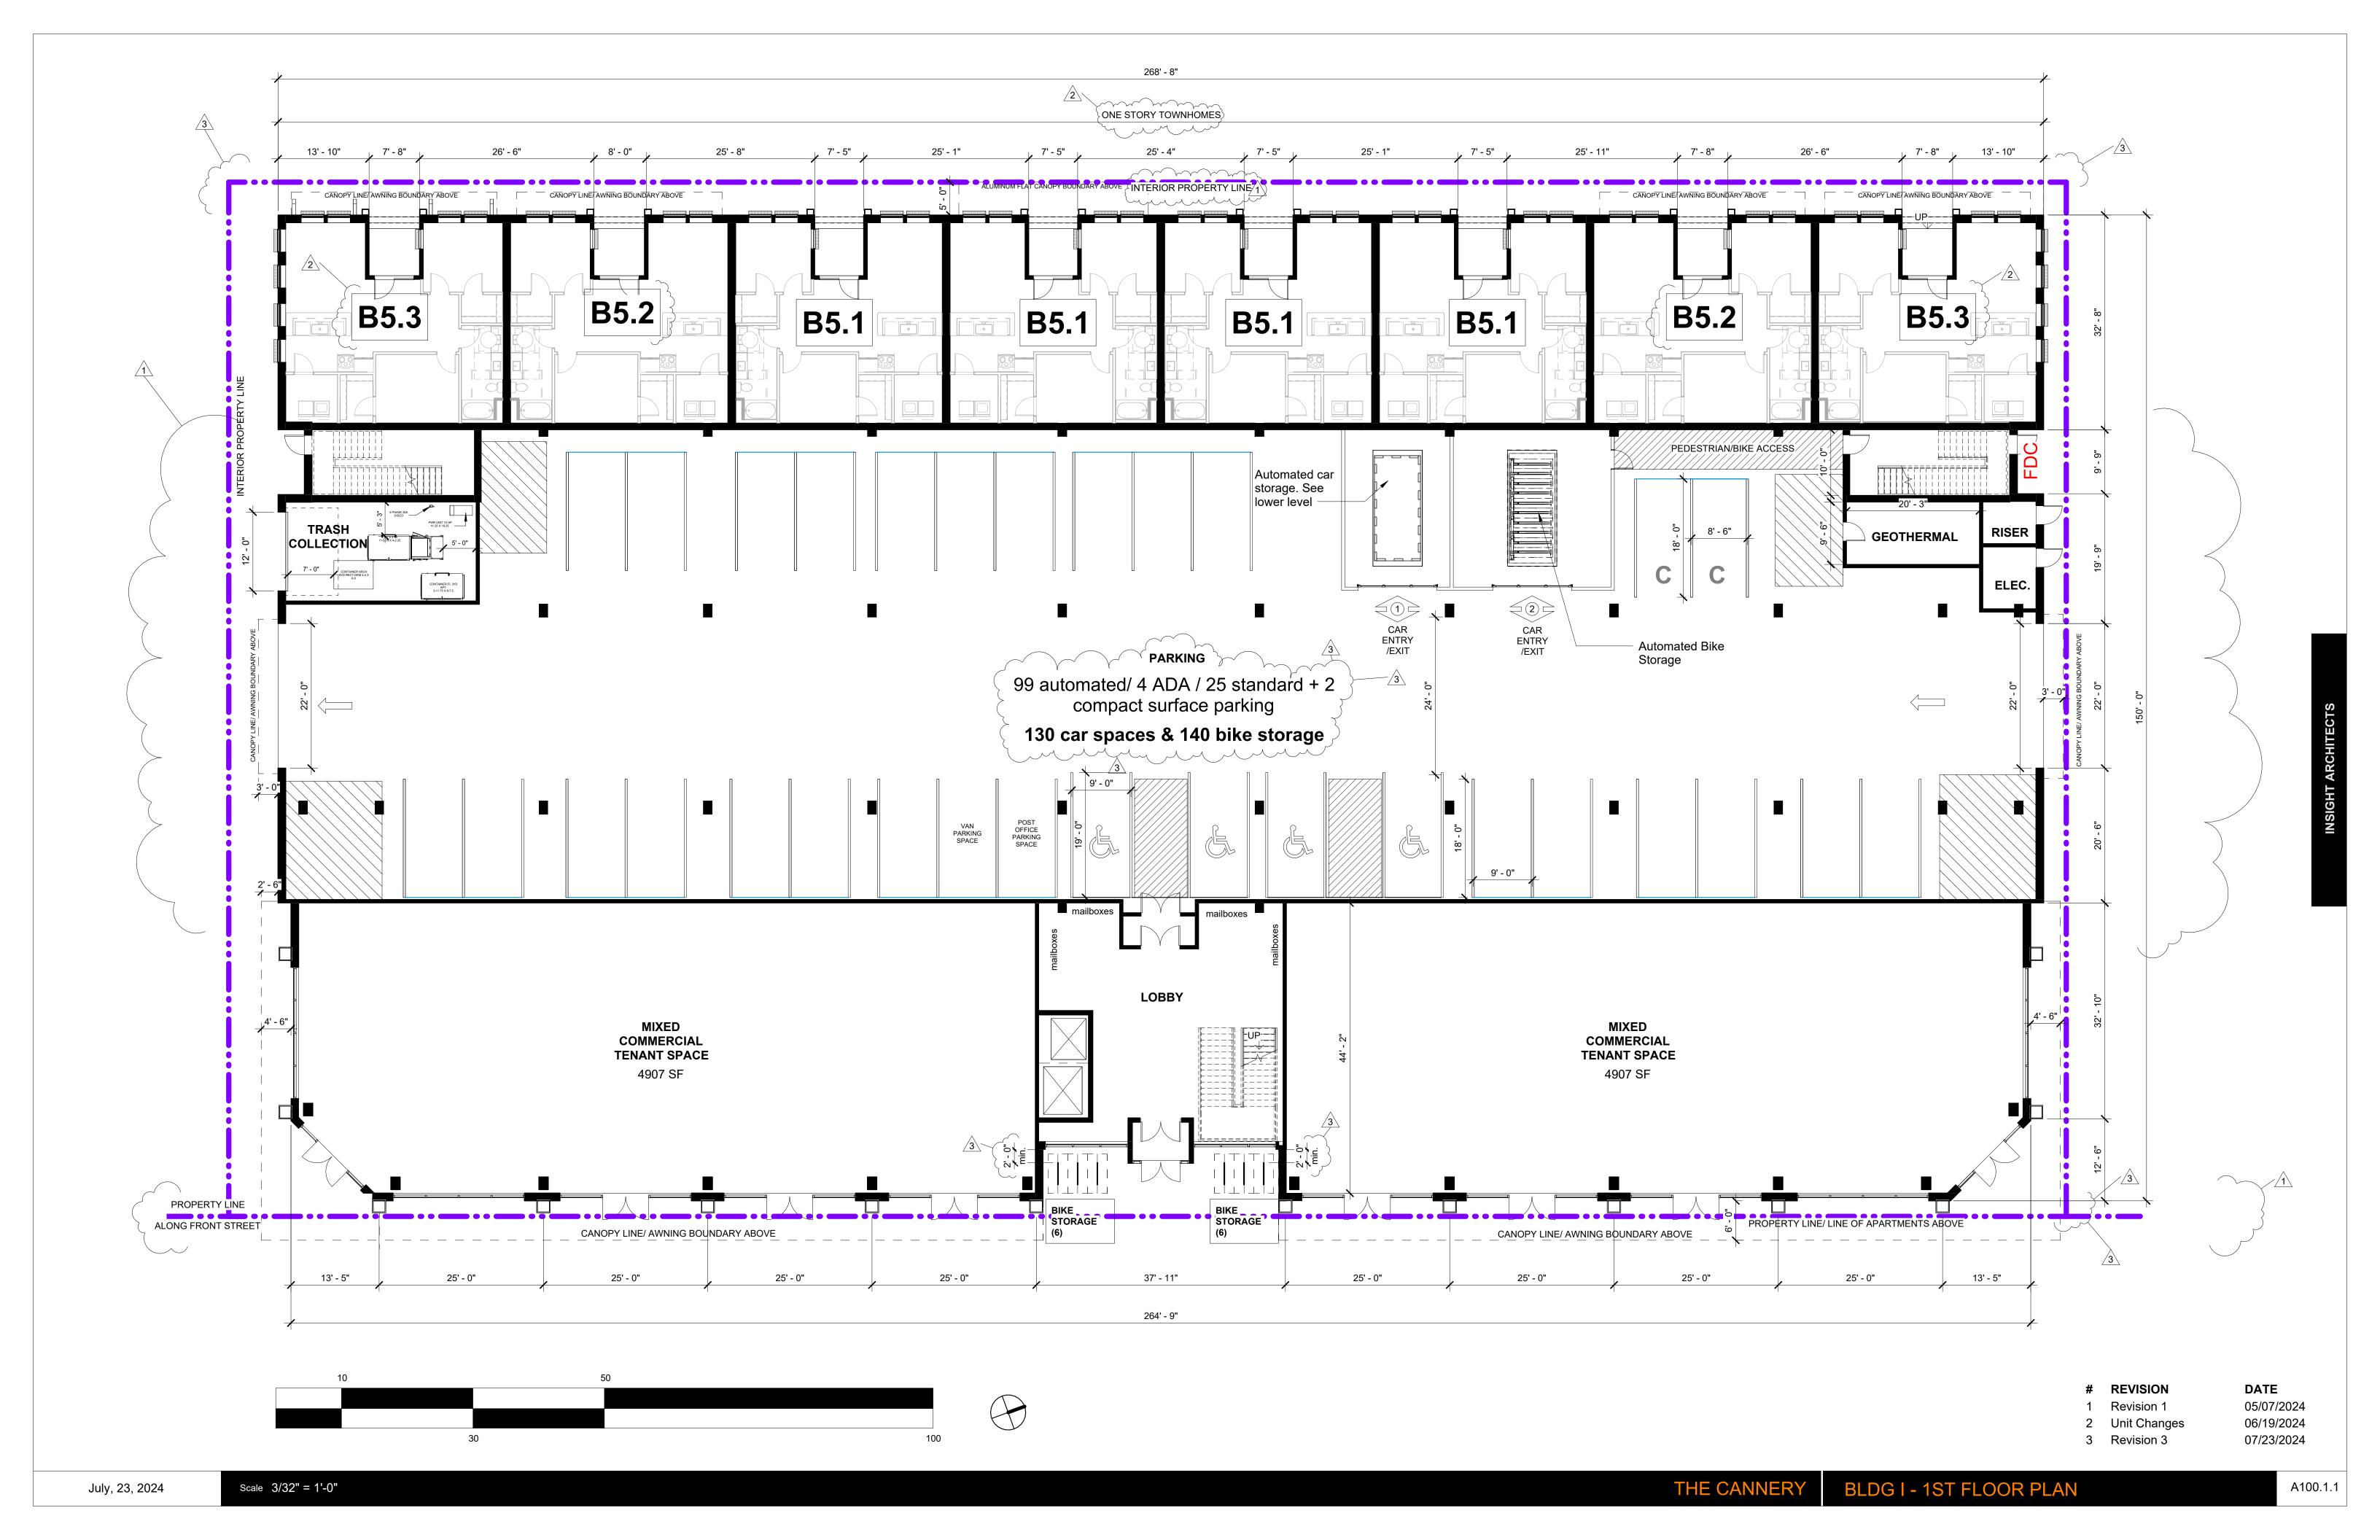

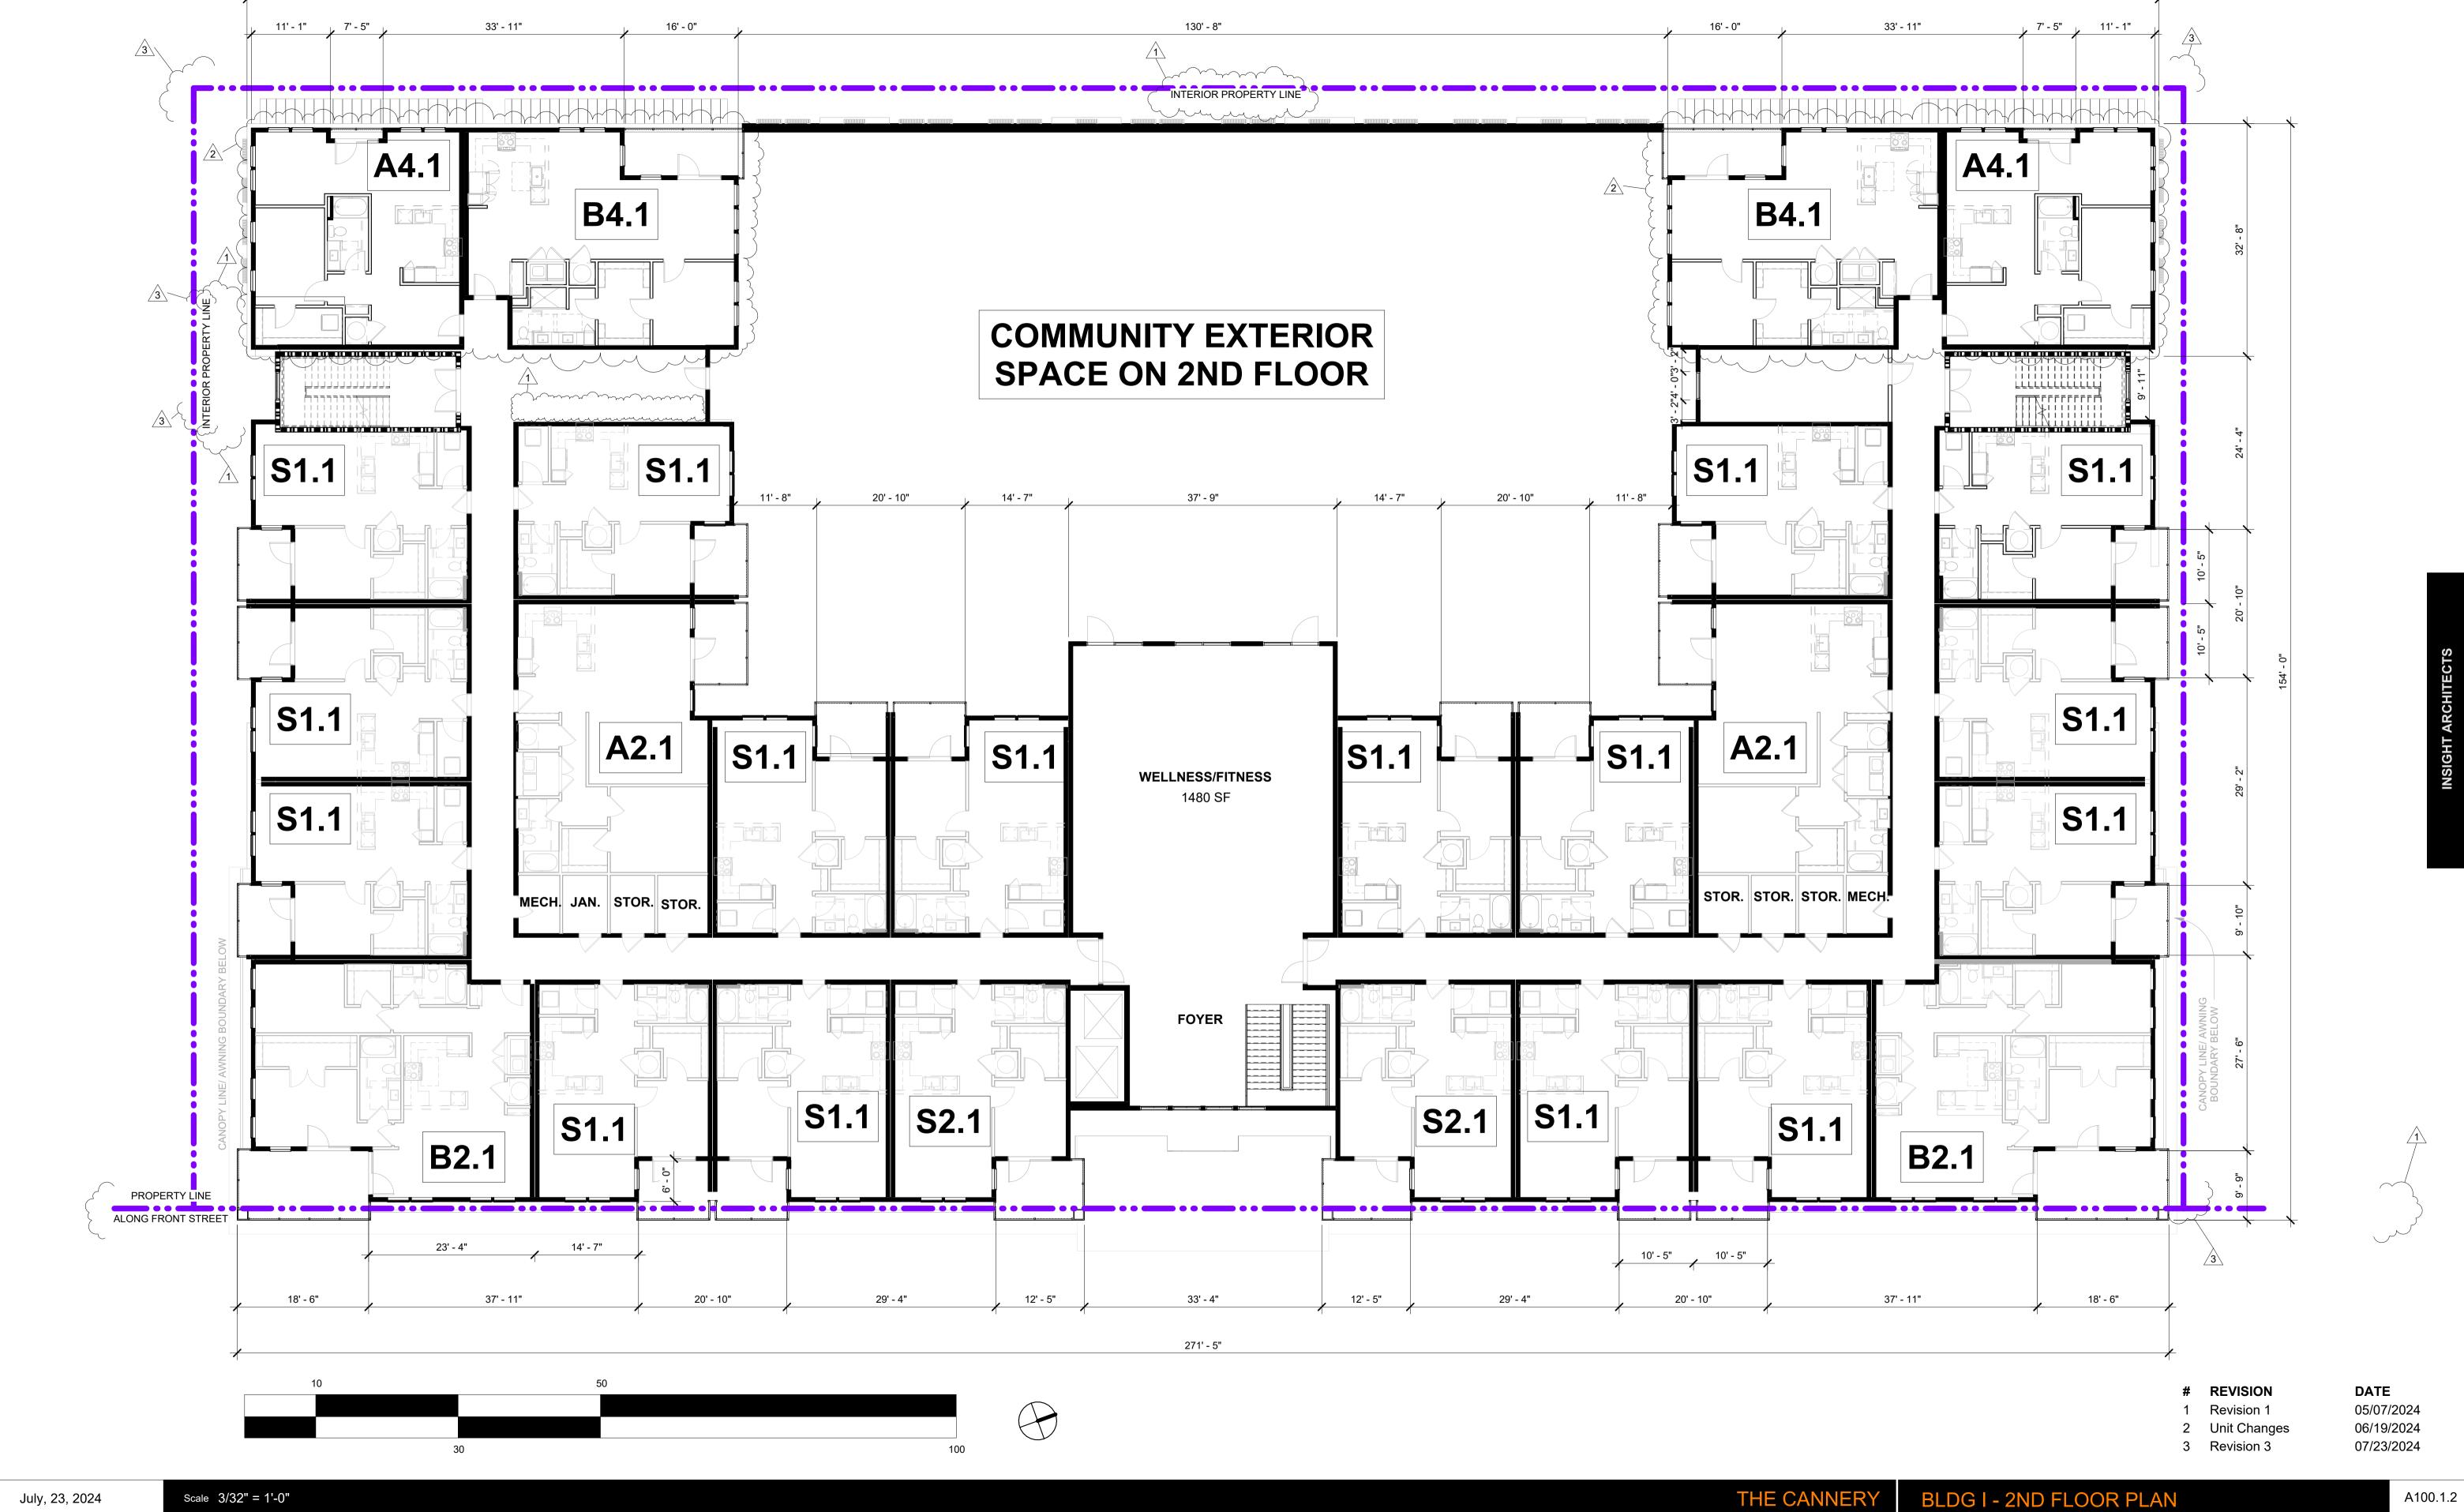

268' - 8"



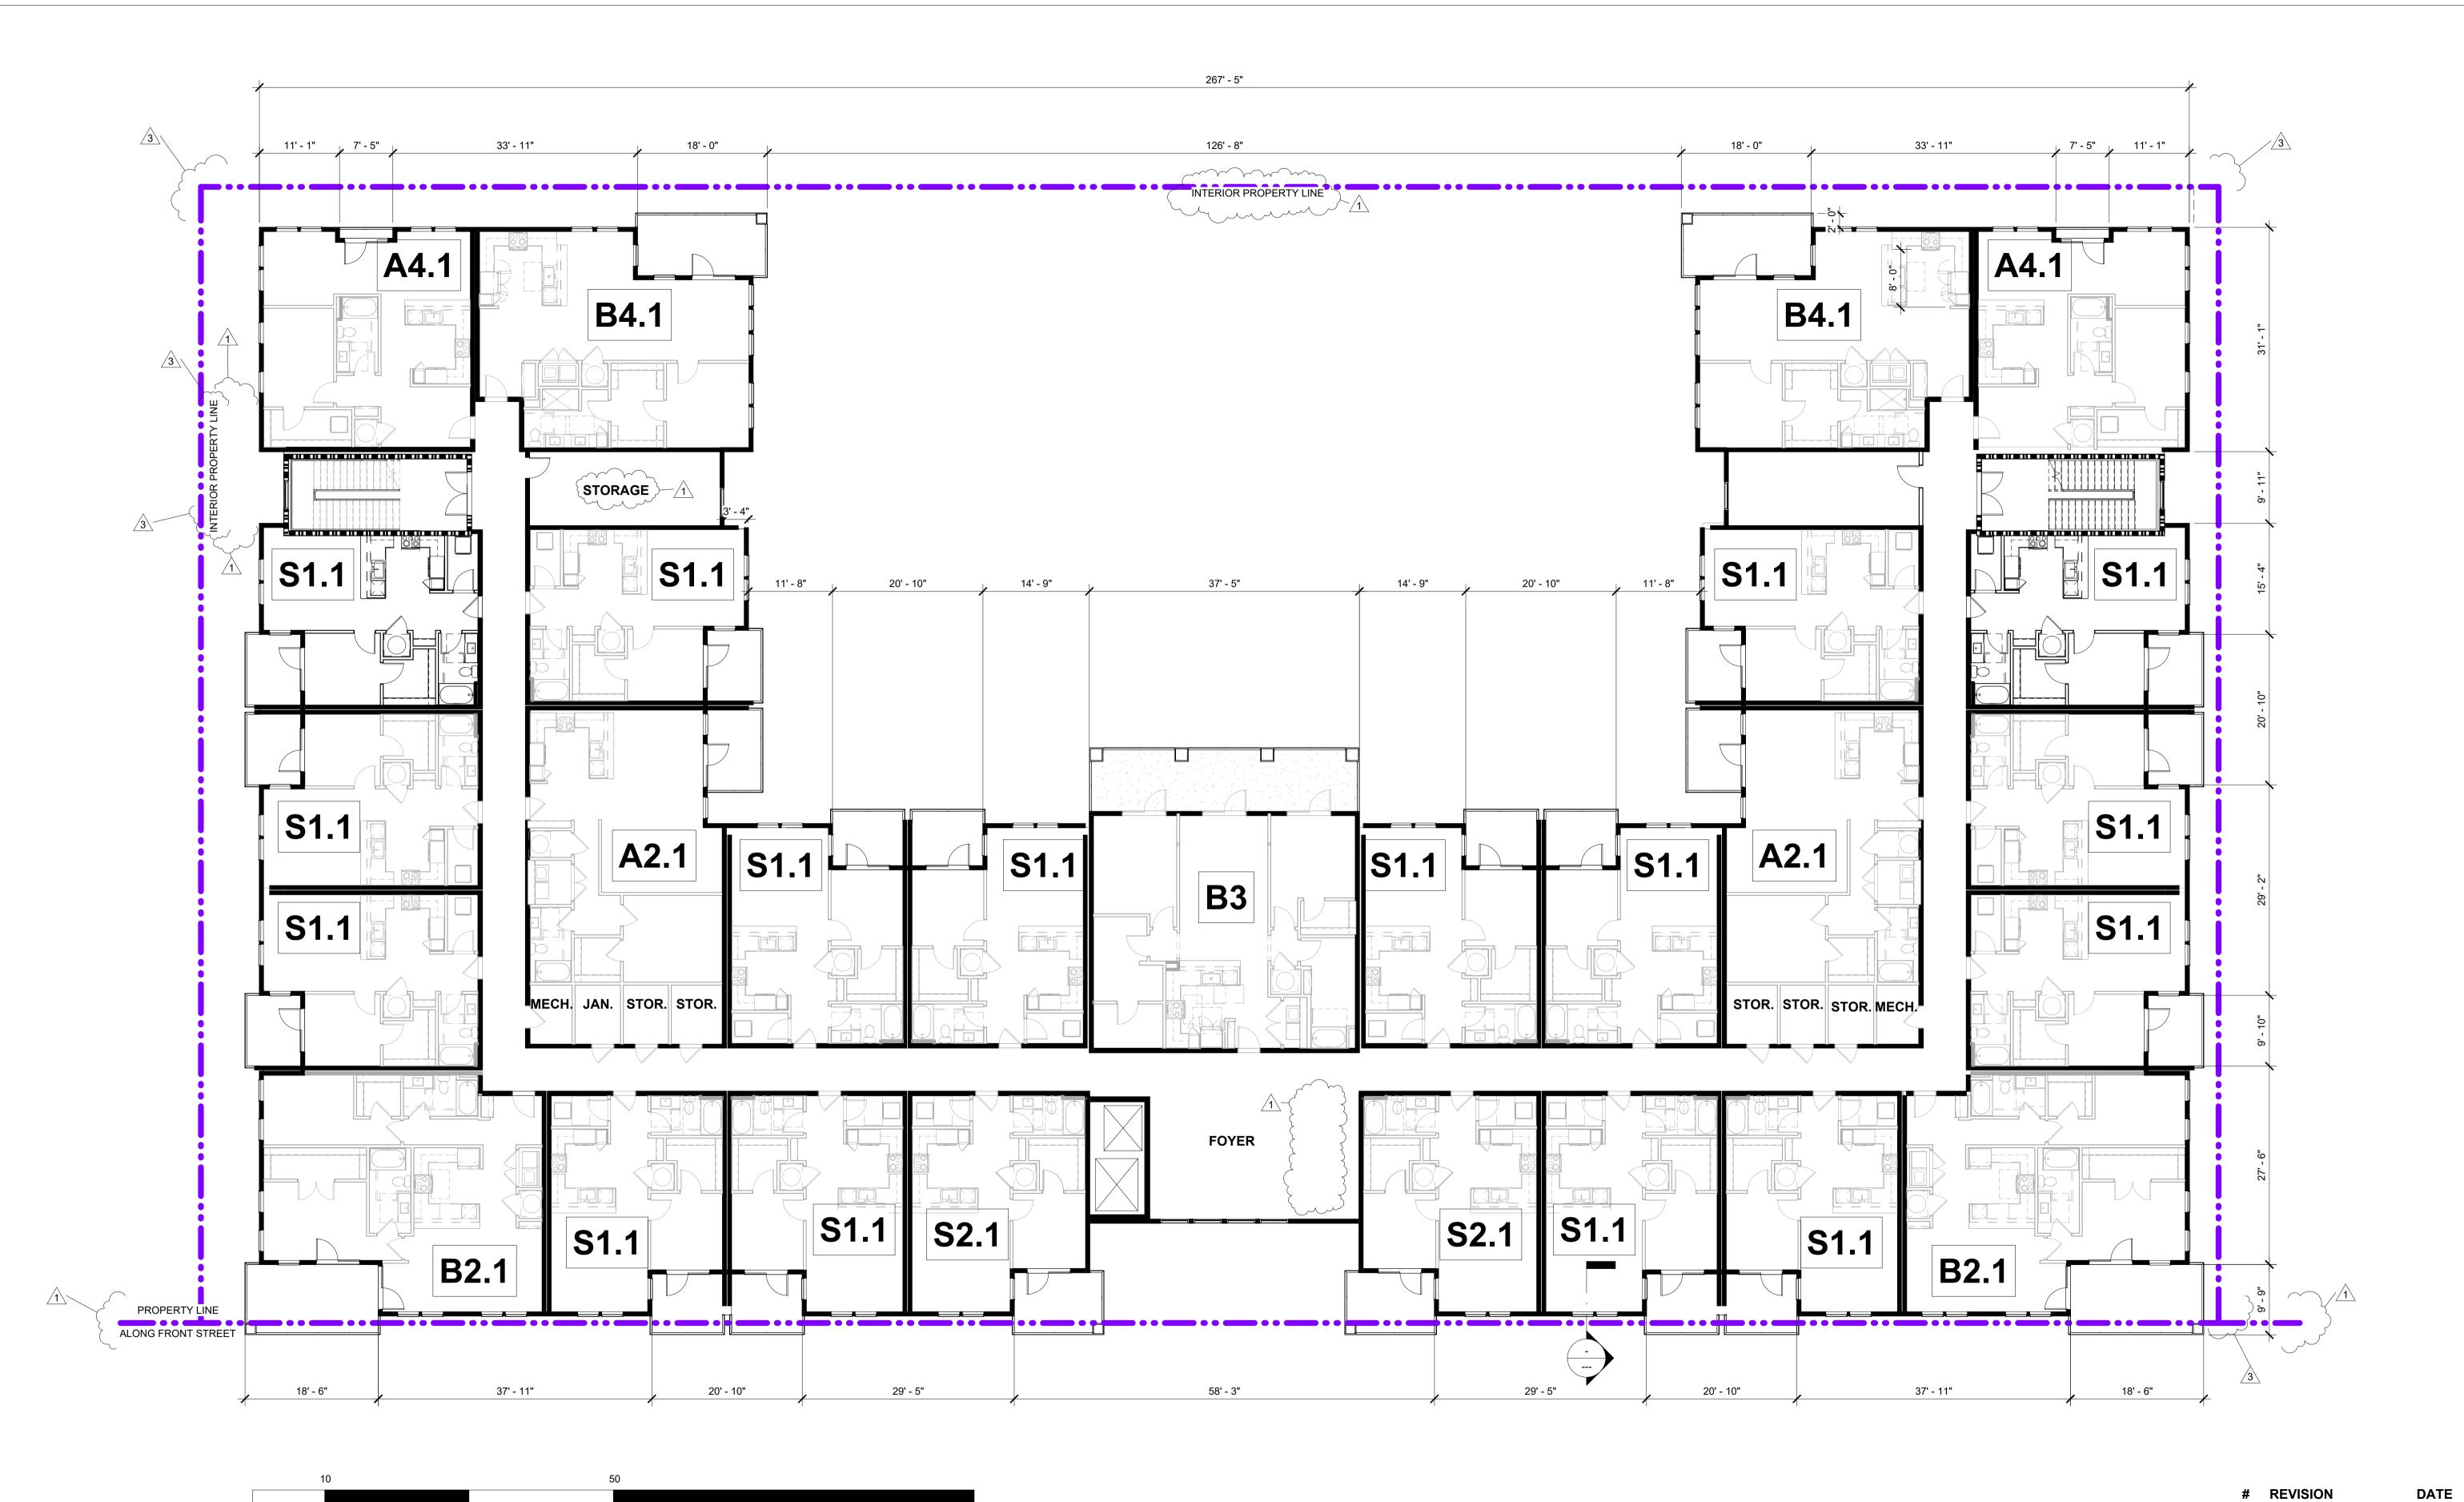


1 Revision 1 3 Revision 3 05/07/2024 07/23/2024




July, 23, 2024 Scale 3/32" = 1'-0"

THE CANNERY BLDG I - 6TH FLOOR PLAN

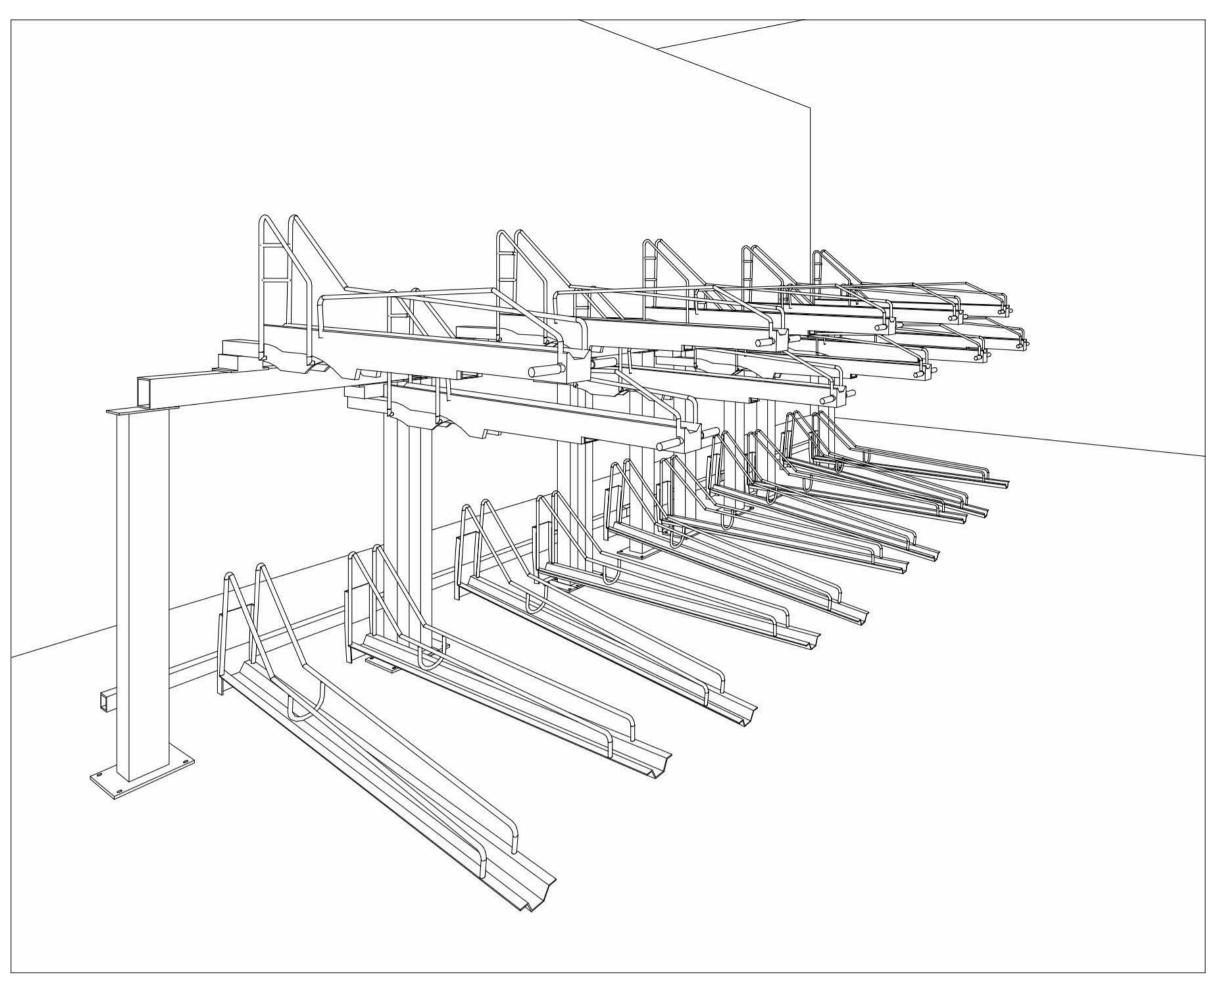


3D SKETCH OF BIKE STORAGE PLATFORM - 20 BIKES PER CAR SPACE.

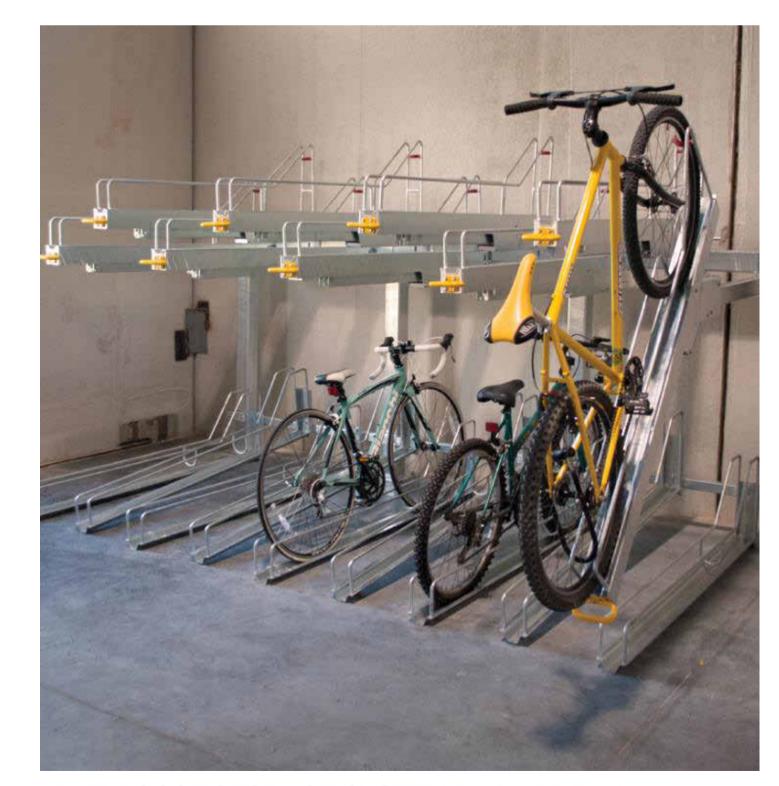


BIKE BOOST STORAGE SYSTEM BY MADDRAX



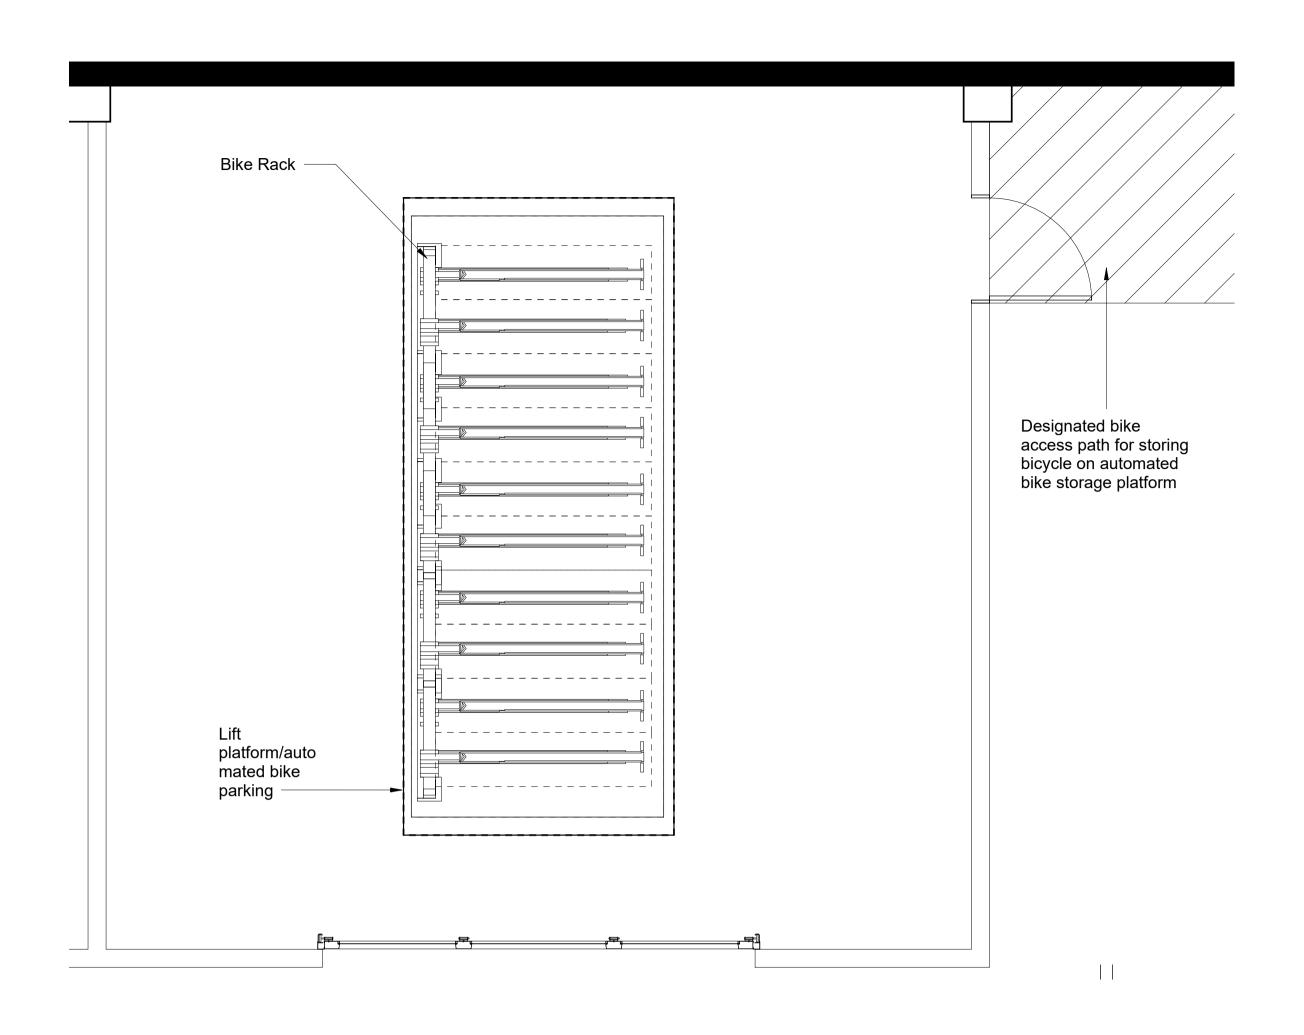

ENLARGED BIKE PLAN 3/8" = 1'-0"

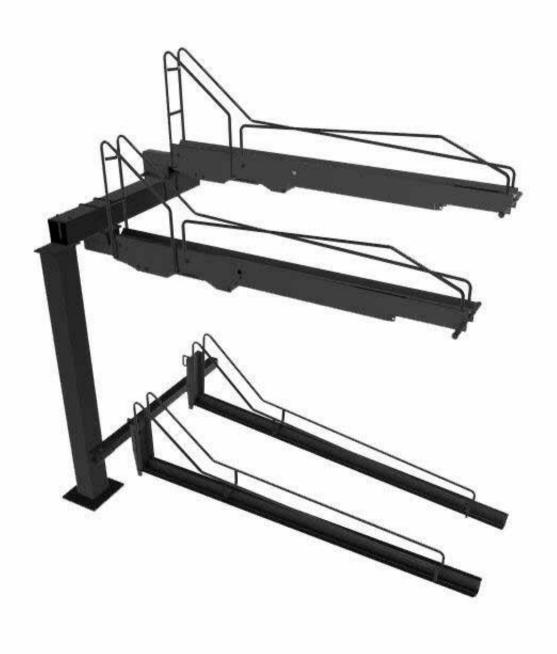

https://www.madrax.com/bike-boost-storage-bbs

NEW SHEET 1 Revision 1


DATE 05/07/2024

May, 07, 2024



FLOOR	BLDG I	BLDG II	BLDG III
1ST	8	6	6
2ND	26	22	22
3RD	27	23	23
4TH	27	23	23
5TH	27	23	23
6TH	27	23	23
TOTAL	142	120	120

TOTAL NO. OF UNITS: 382

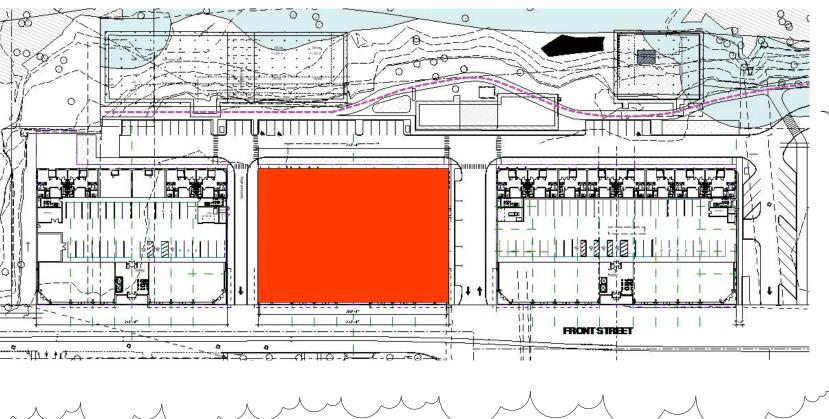





INSIGHT ARCHITECTS, PC

The Cannery 1307 West Morehead Street
Suite 108
Charlotte, NC 28208

BLDG II
Salem Oregon
Building Elevations



REVISION1 Revision 1

DATE 05/07/2024

83% GLAZING*
89% WEATHERPROTECTION

*Calculated per SRC 112.030 (b)

A 02



REVISION
2 Unit Changes

DATE 06/19/2024

56% GLAZING*
59% WEATHERPROTECTION


*Calculated per SRC 112.030 (b)



DATE 06/19/2024




DATE 06/19/2024

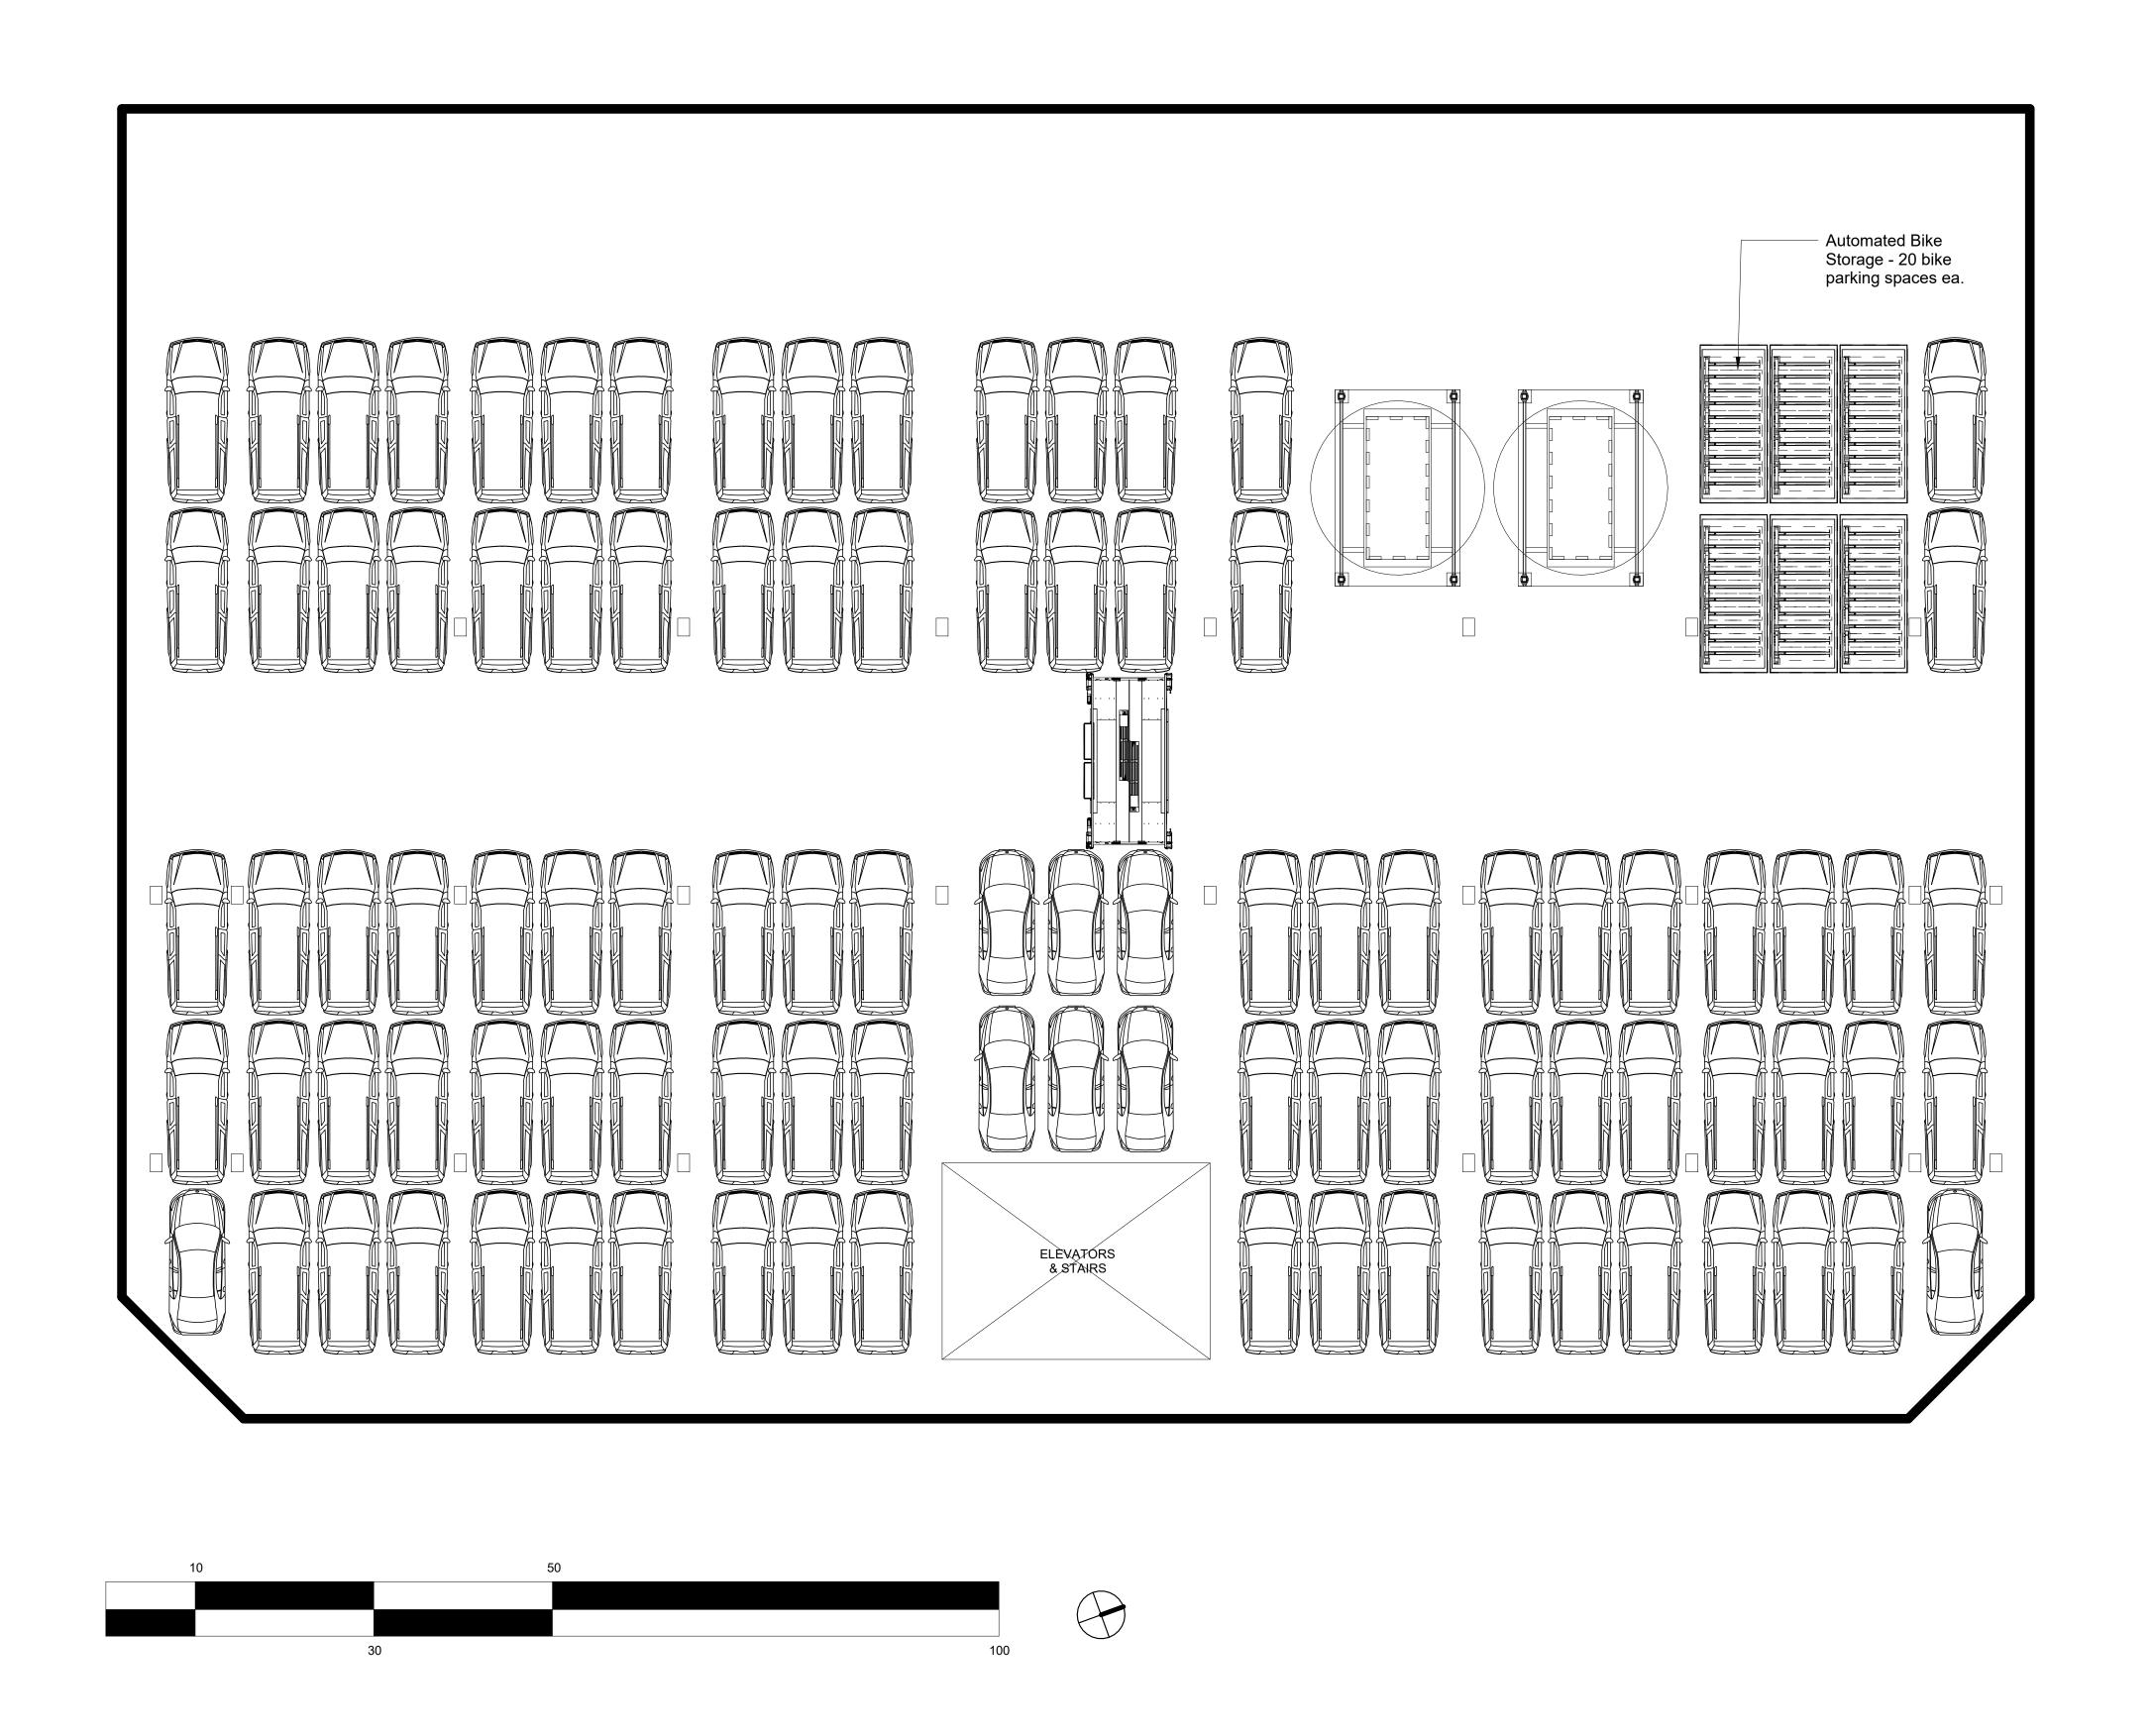

REVISION **NEW SHEET** 1 Revision 1

DATE 05/07/2024

May, 07, 2024

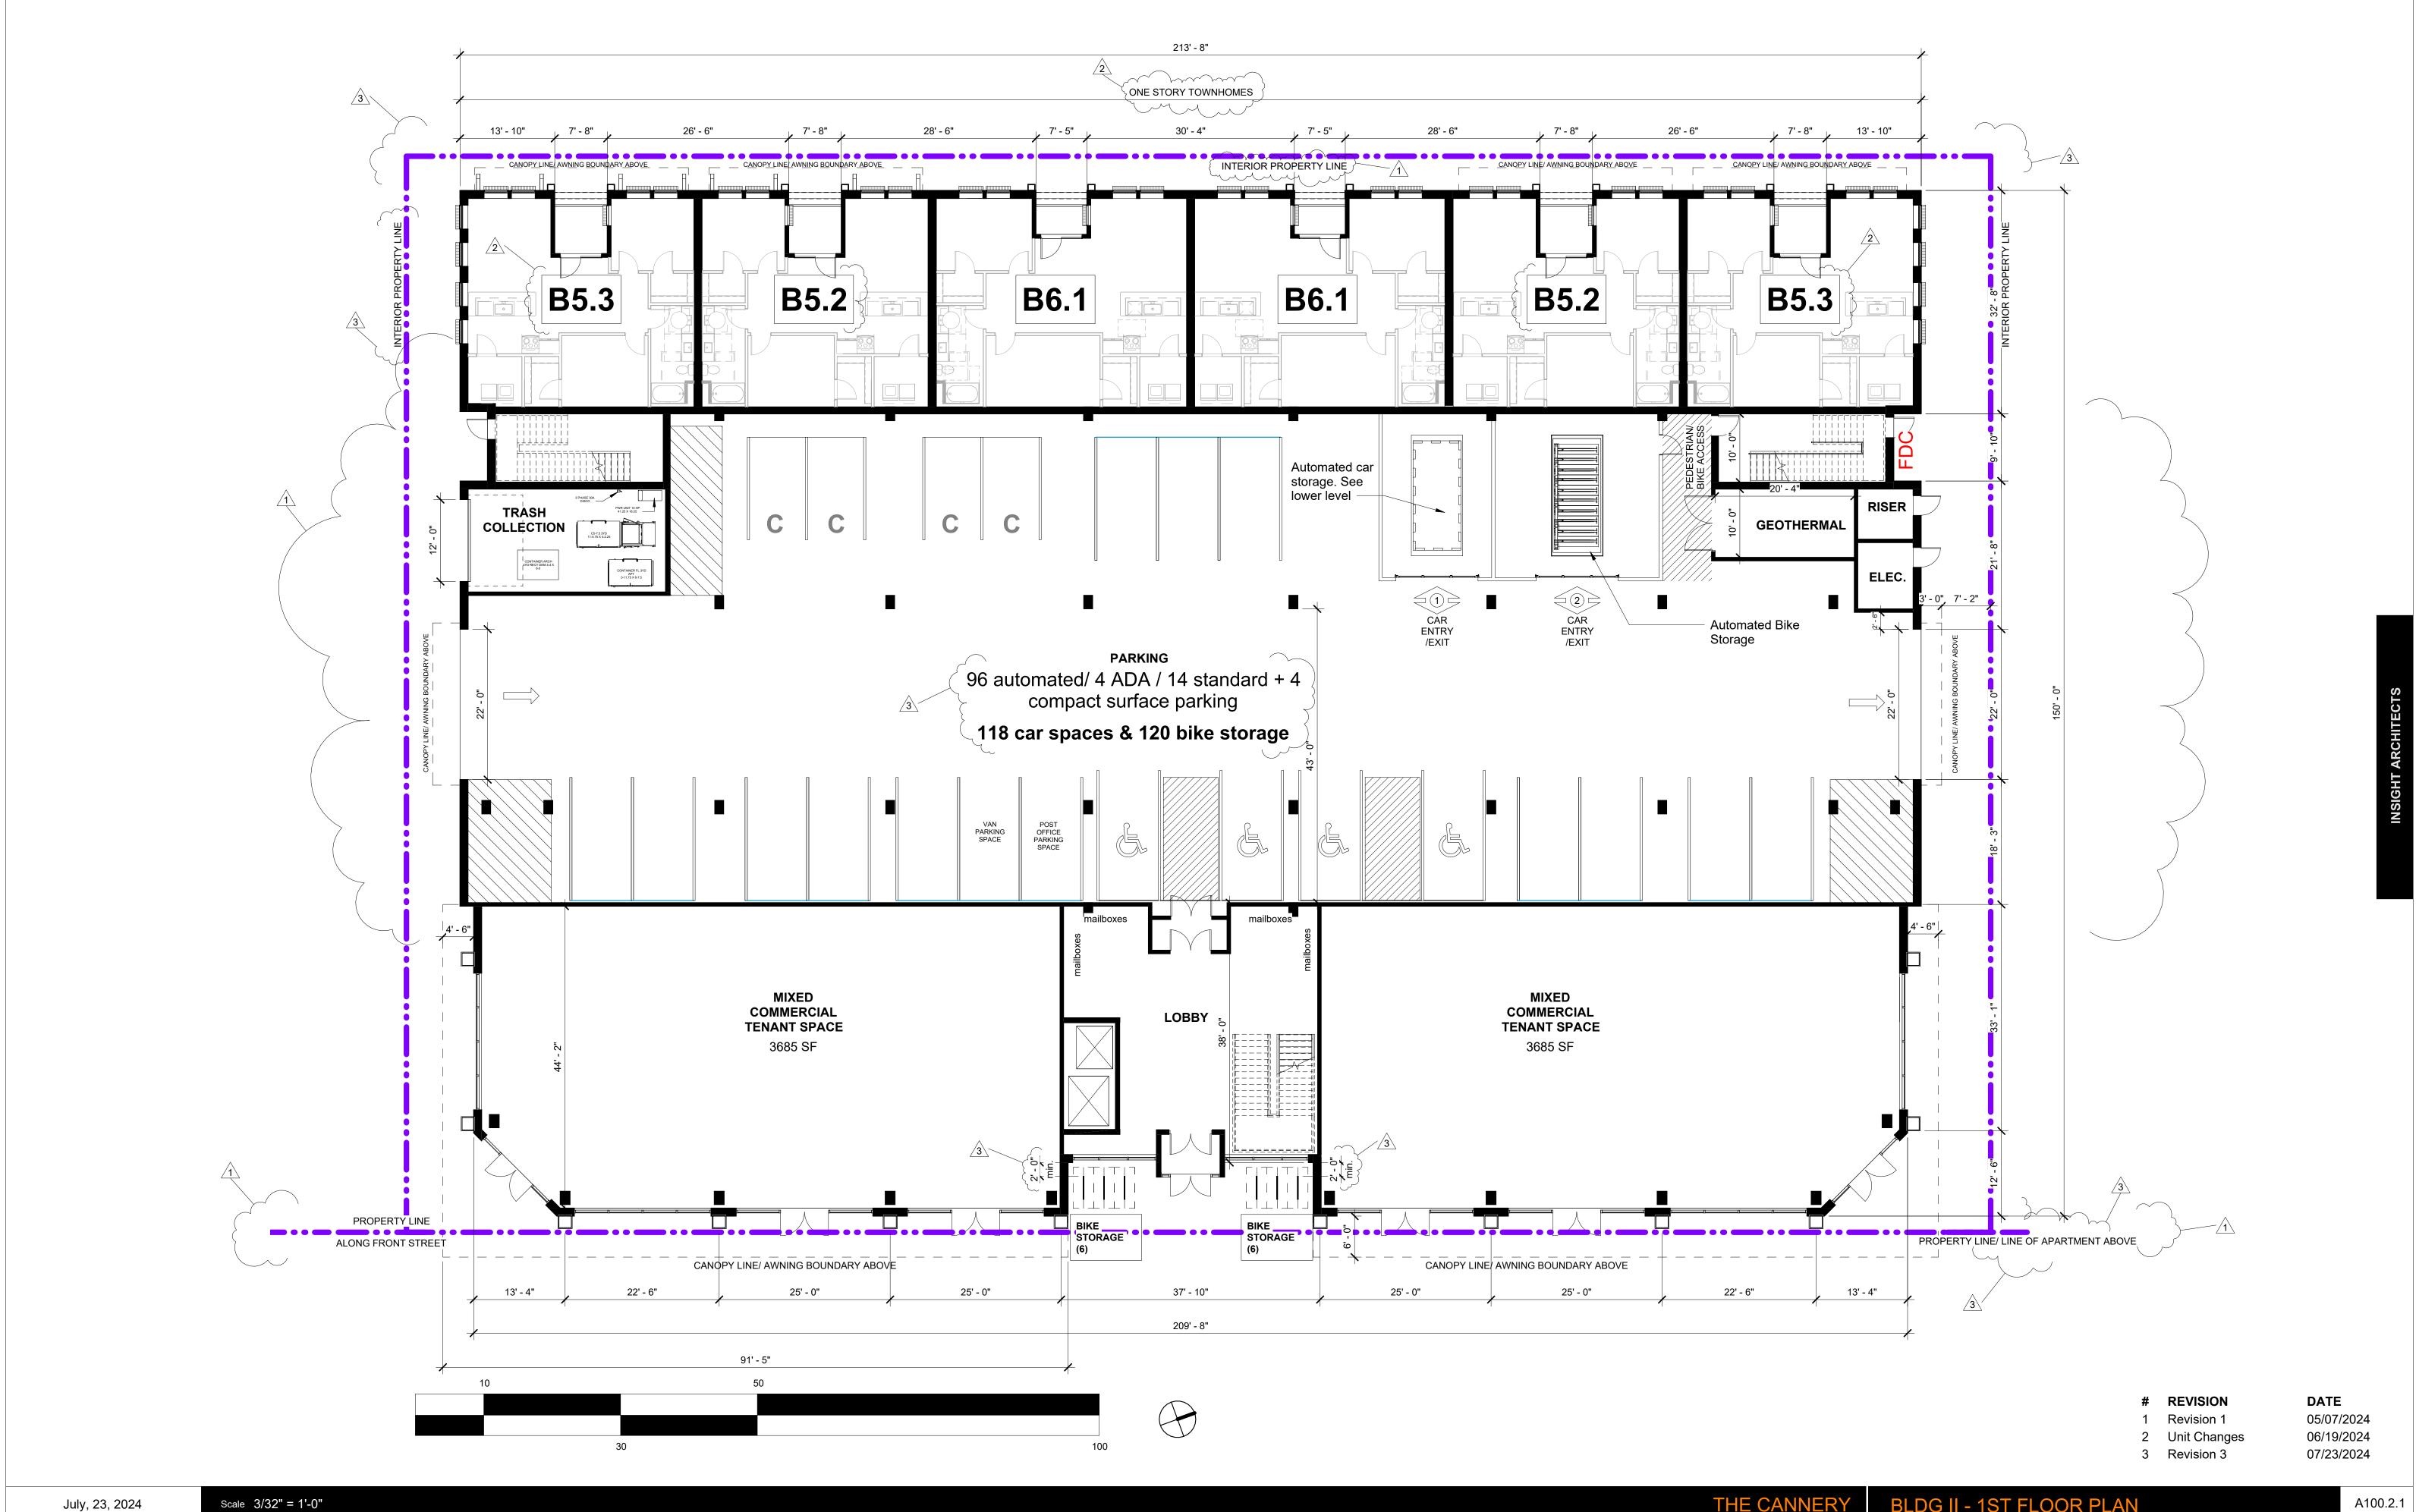



July, 23, 2024 Scale 3/32" = 1'-0"

THE CANNERY

A100.2.2

DATE

05/07/2024

06/19/2024

07/23/2024



Scale 3/32" = 1'-0"

THE CANNERY

A100.2.3-5

DATE 05/07/2024

07/23/2024




Scale 3/32" = 1'-0"

THE CANNERY

A100.2.6


DATE 05/07/2024

07/23/2024

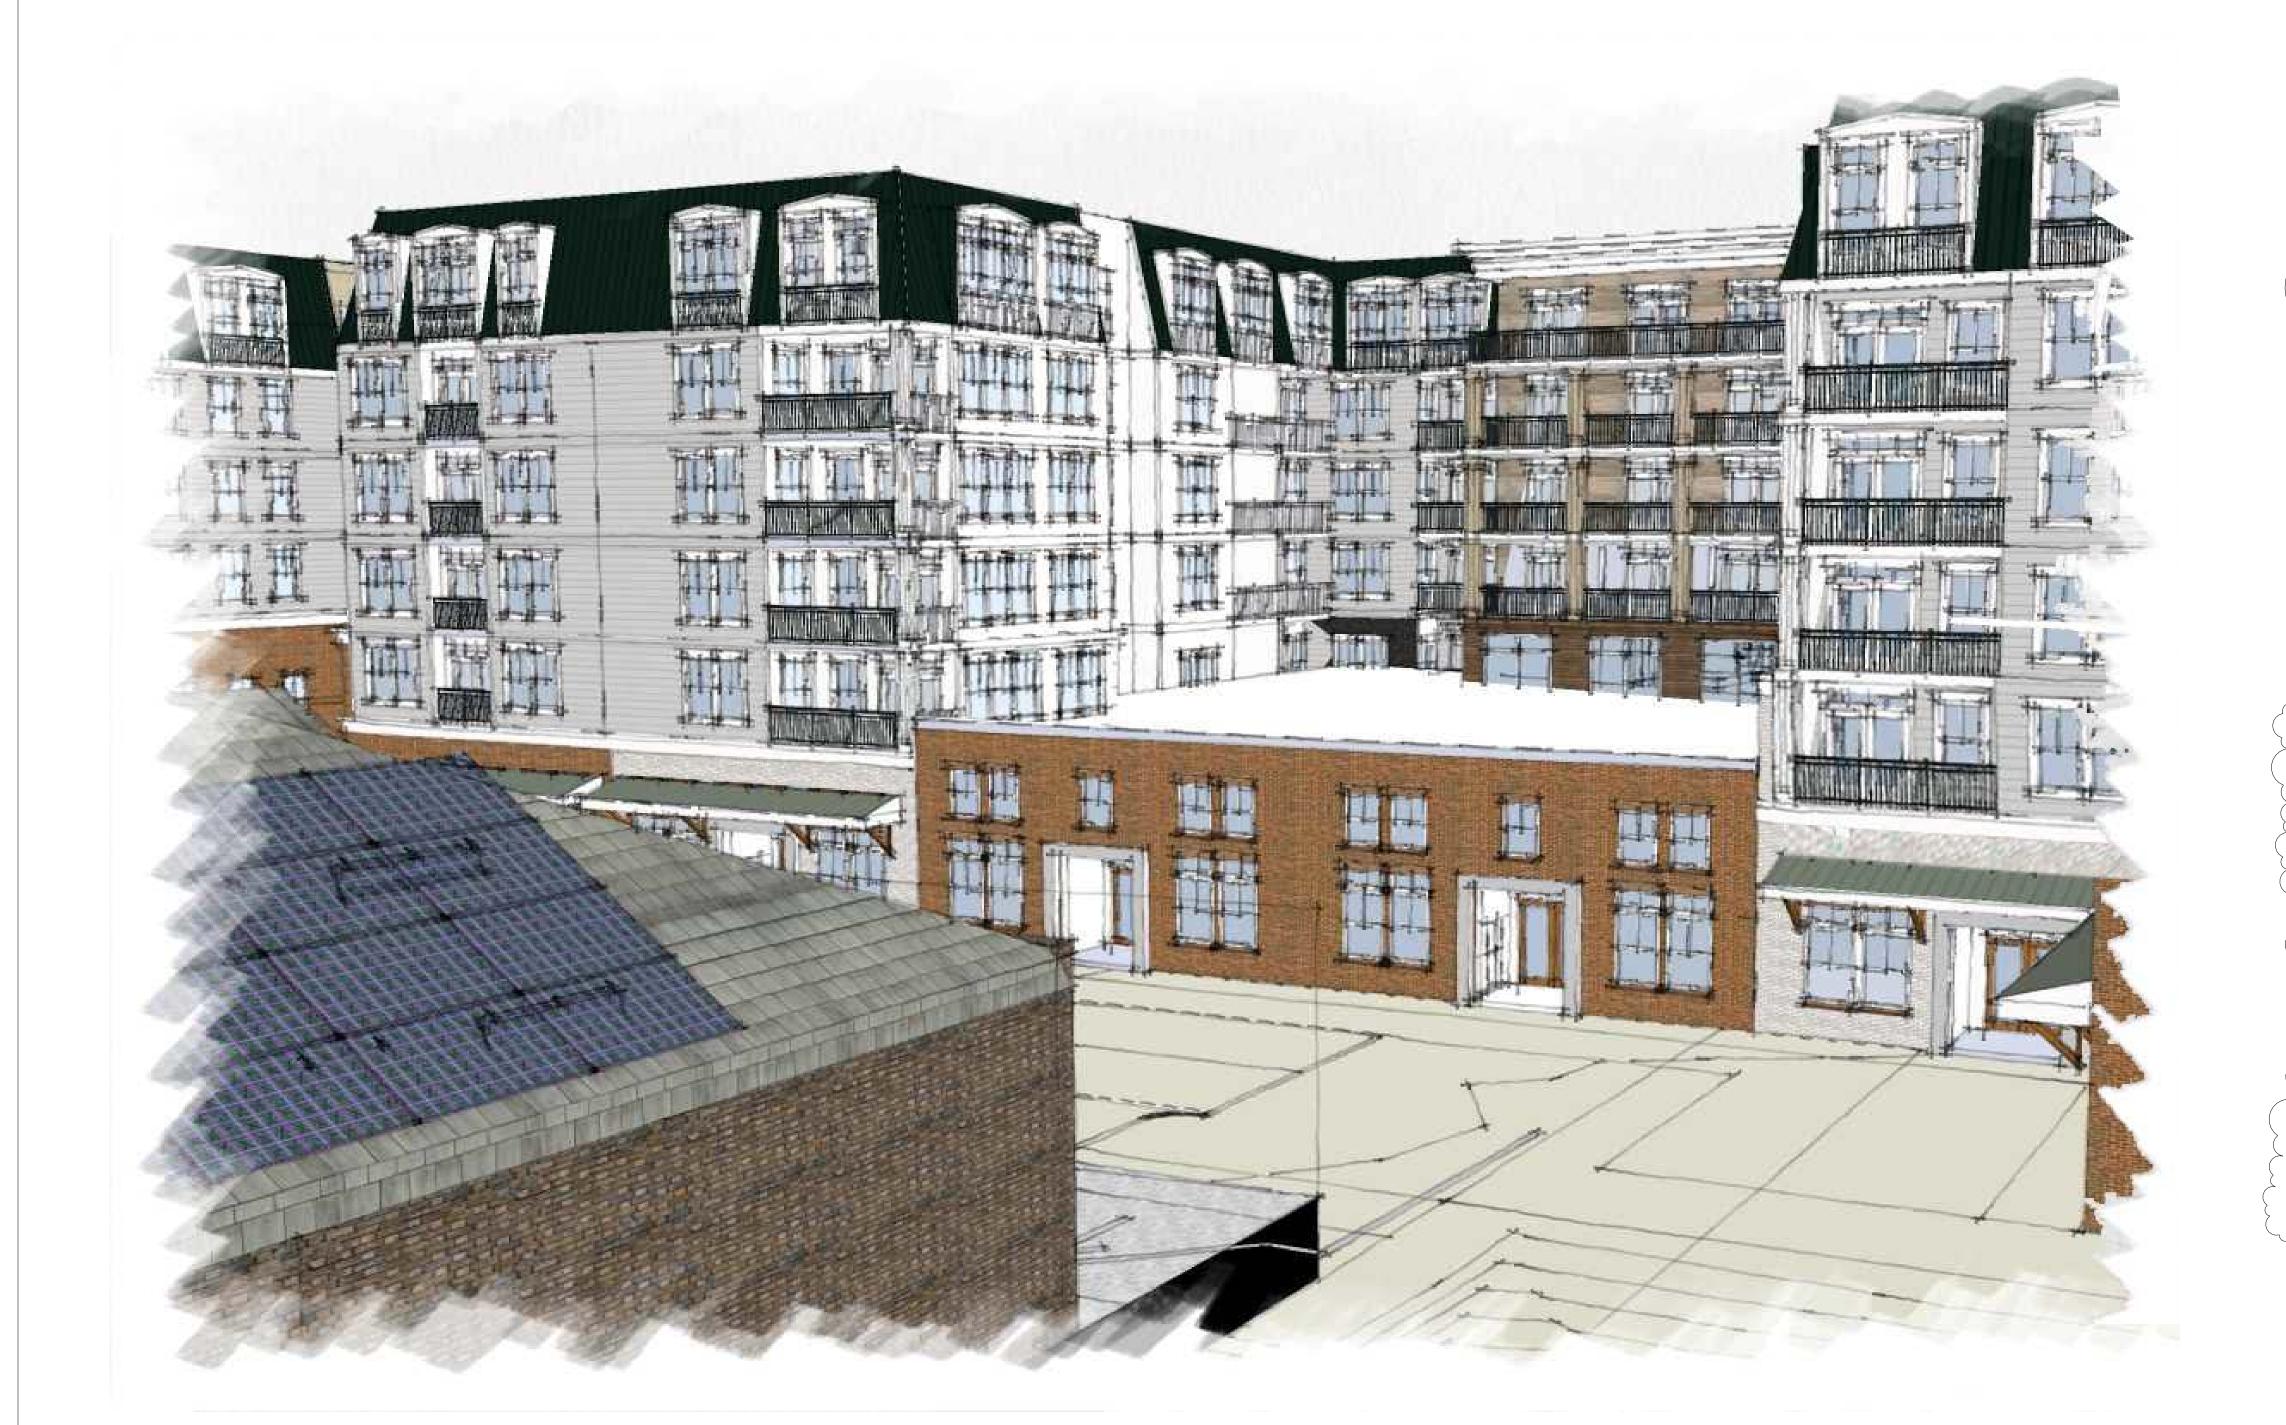

/ Y Y	γ , ,		
FLOOR	BLDG I	BLDG II	BLDG III
1ST	8	6	6
2ND	26	22	22
3RD	27	23	23
4TH	27	23	23
5TH	27	23	23
6TH	27	23	23
TOTAL	142	120	120

TOTAL NO. OF UNITS: 382

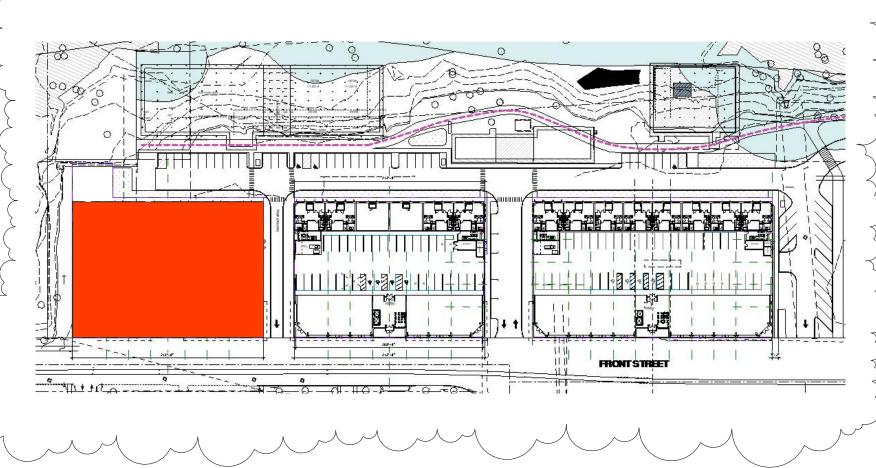









DATE 05/07/2024

83% GLAZING*
89% WEATHERPROTECTION


*Calculated per SRC 112.030 (b)



DATE 06/19/2024

52% GLAZING*
59% WEATHERPROTECTION


*Calculated per SRC 112.030 (b)

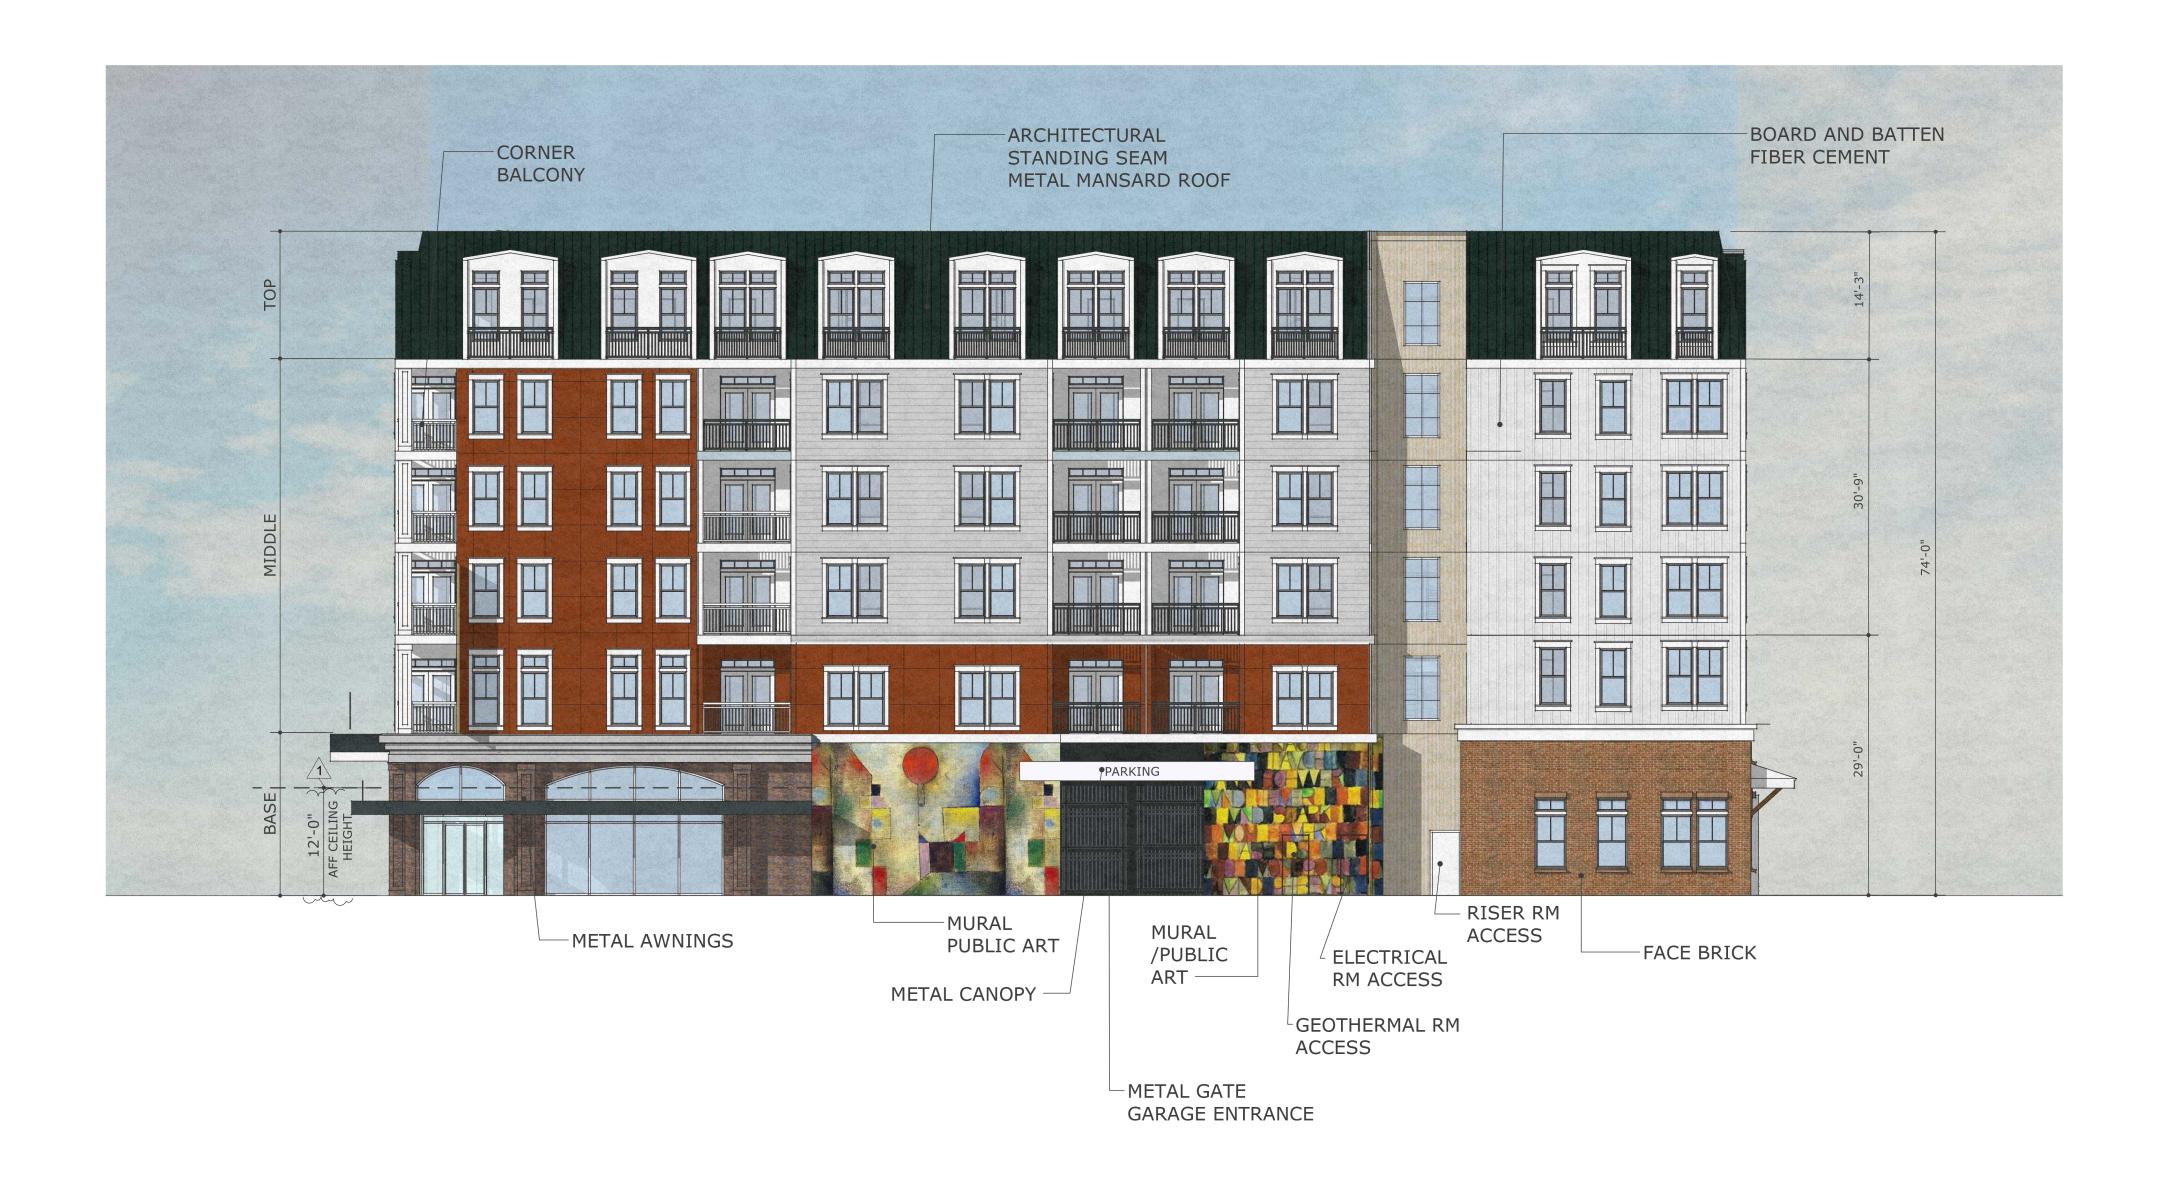

DATE 06/19/2024





DATE 06/19/2024

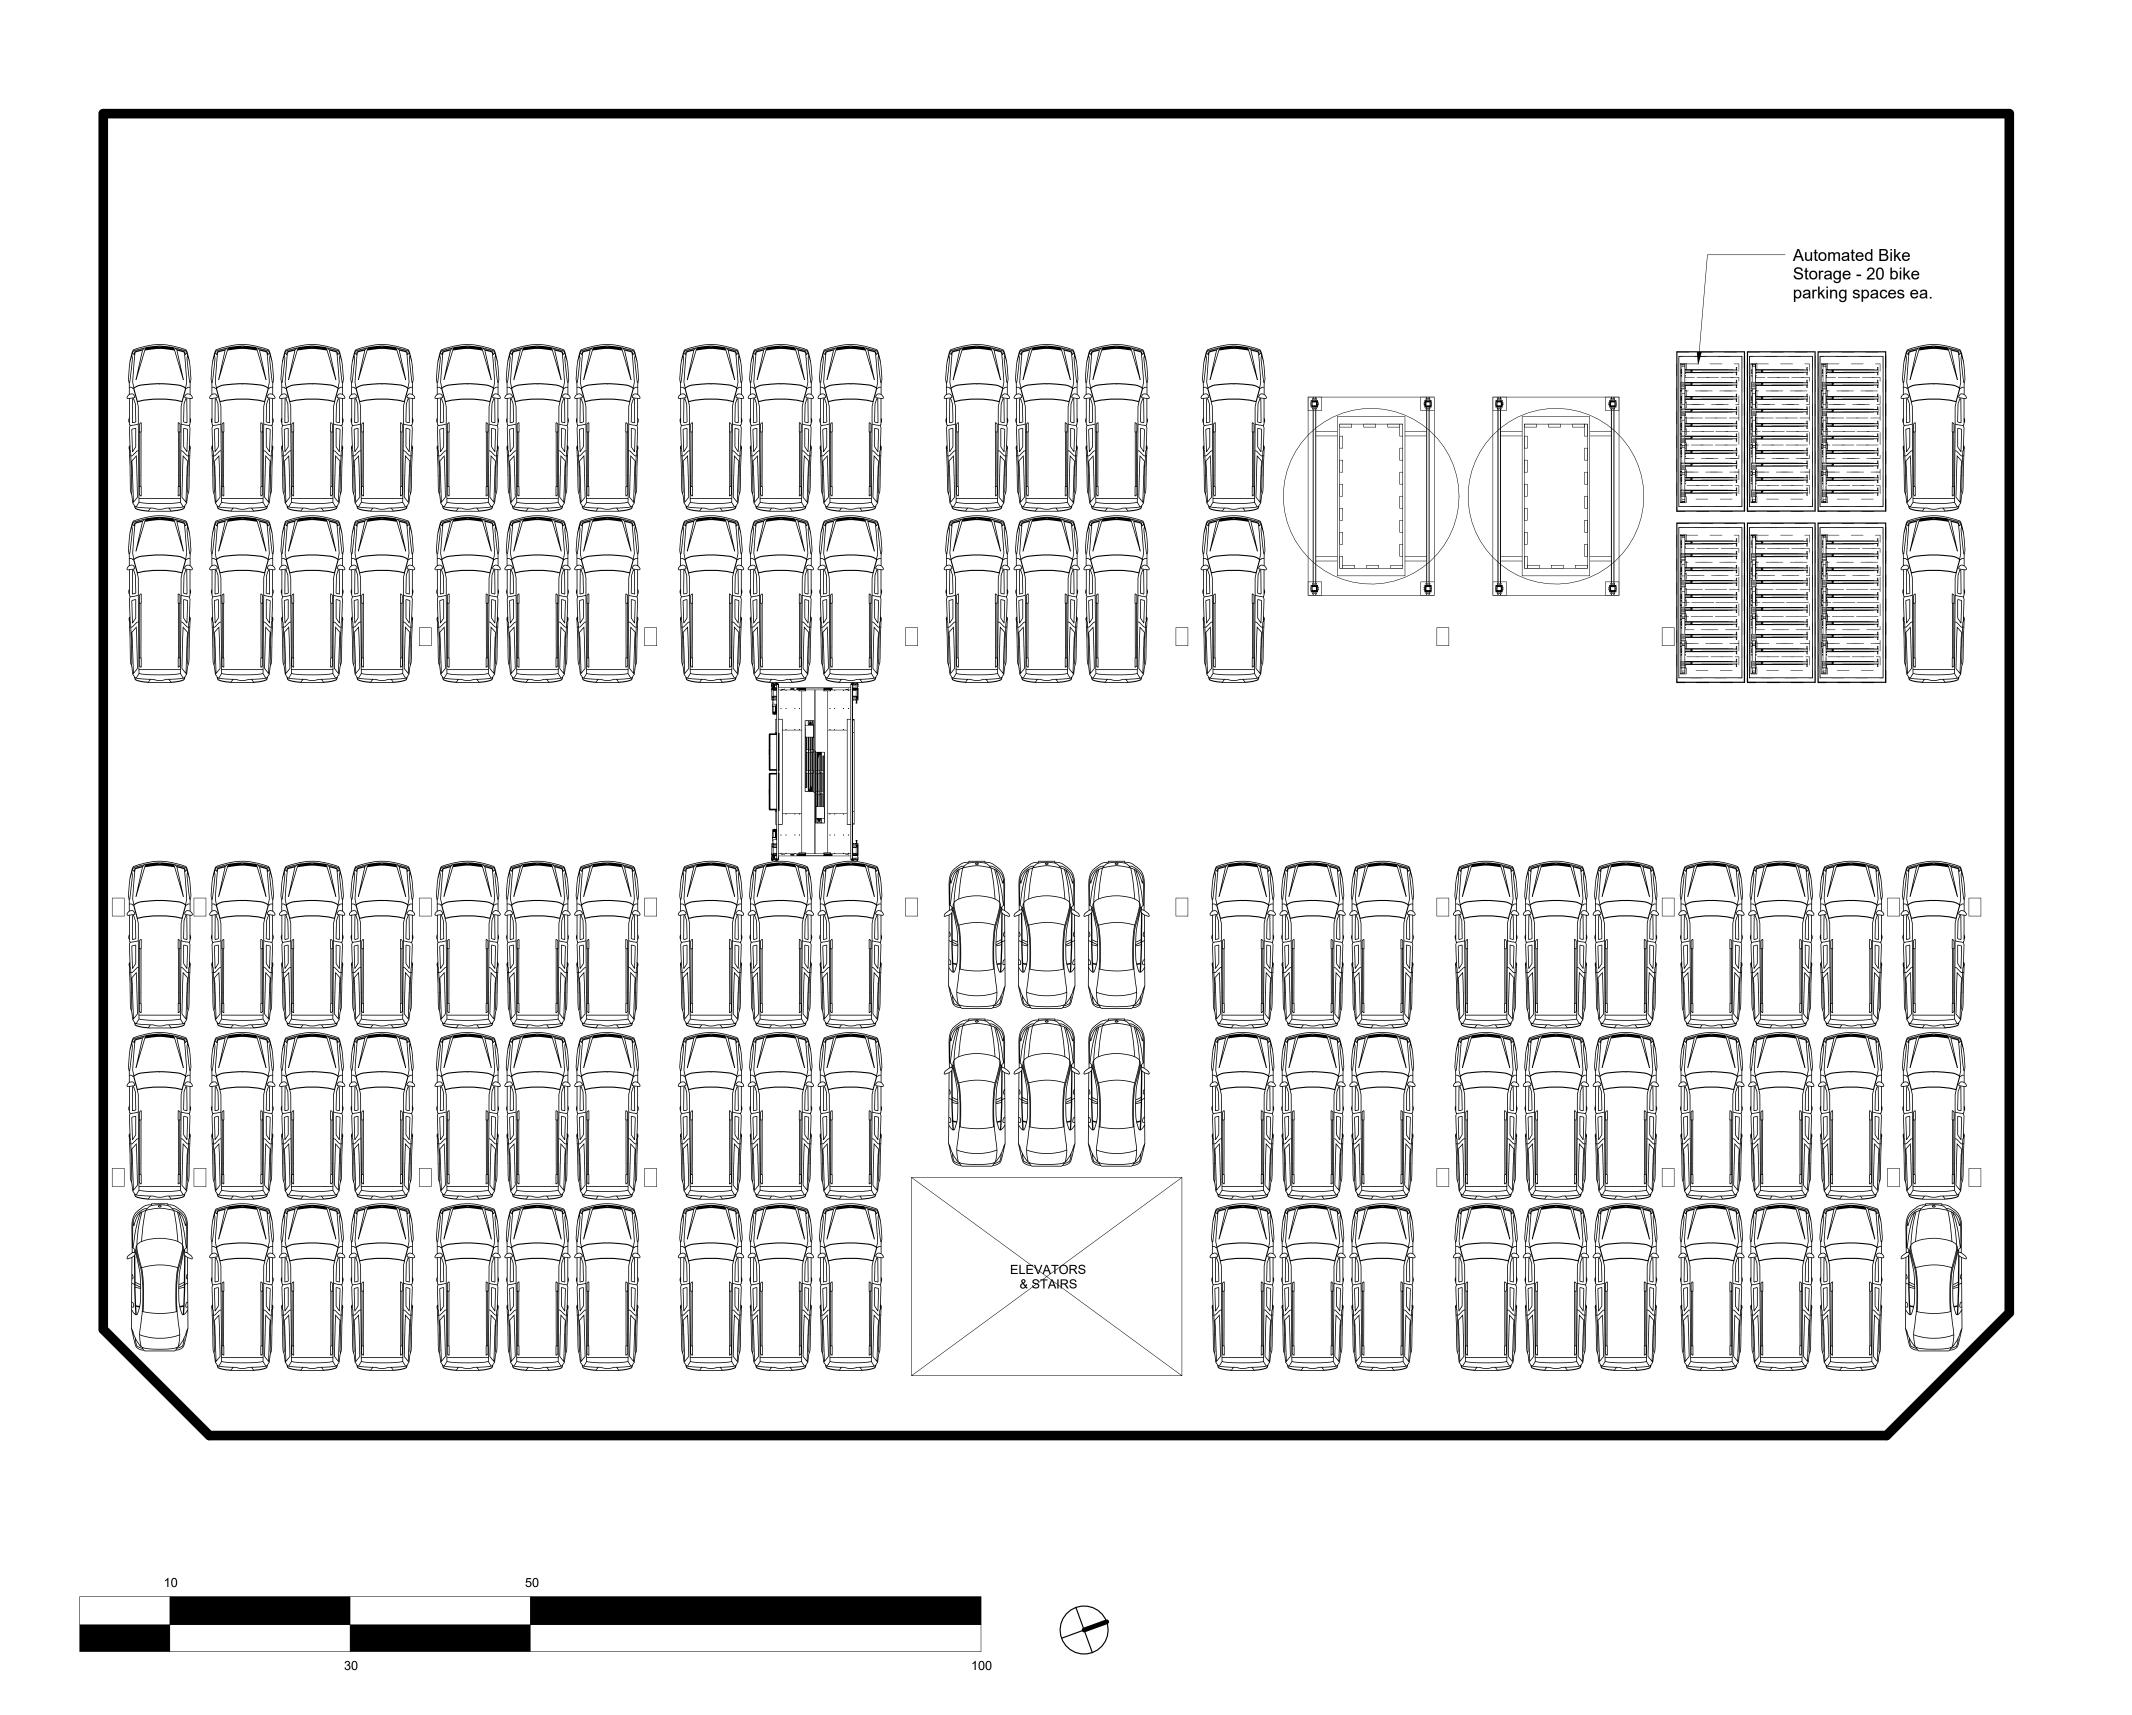

REVISION **NEW SHEET** 1 Revision 1


DATE 05/07/2024

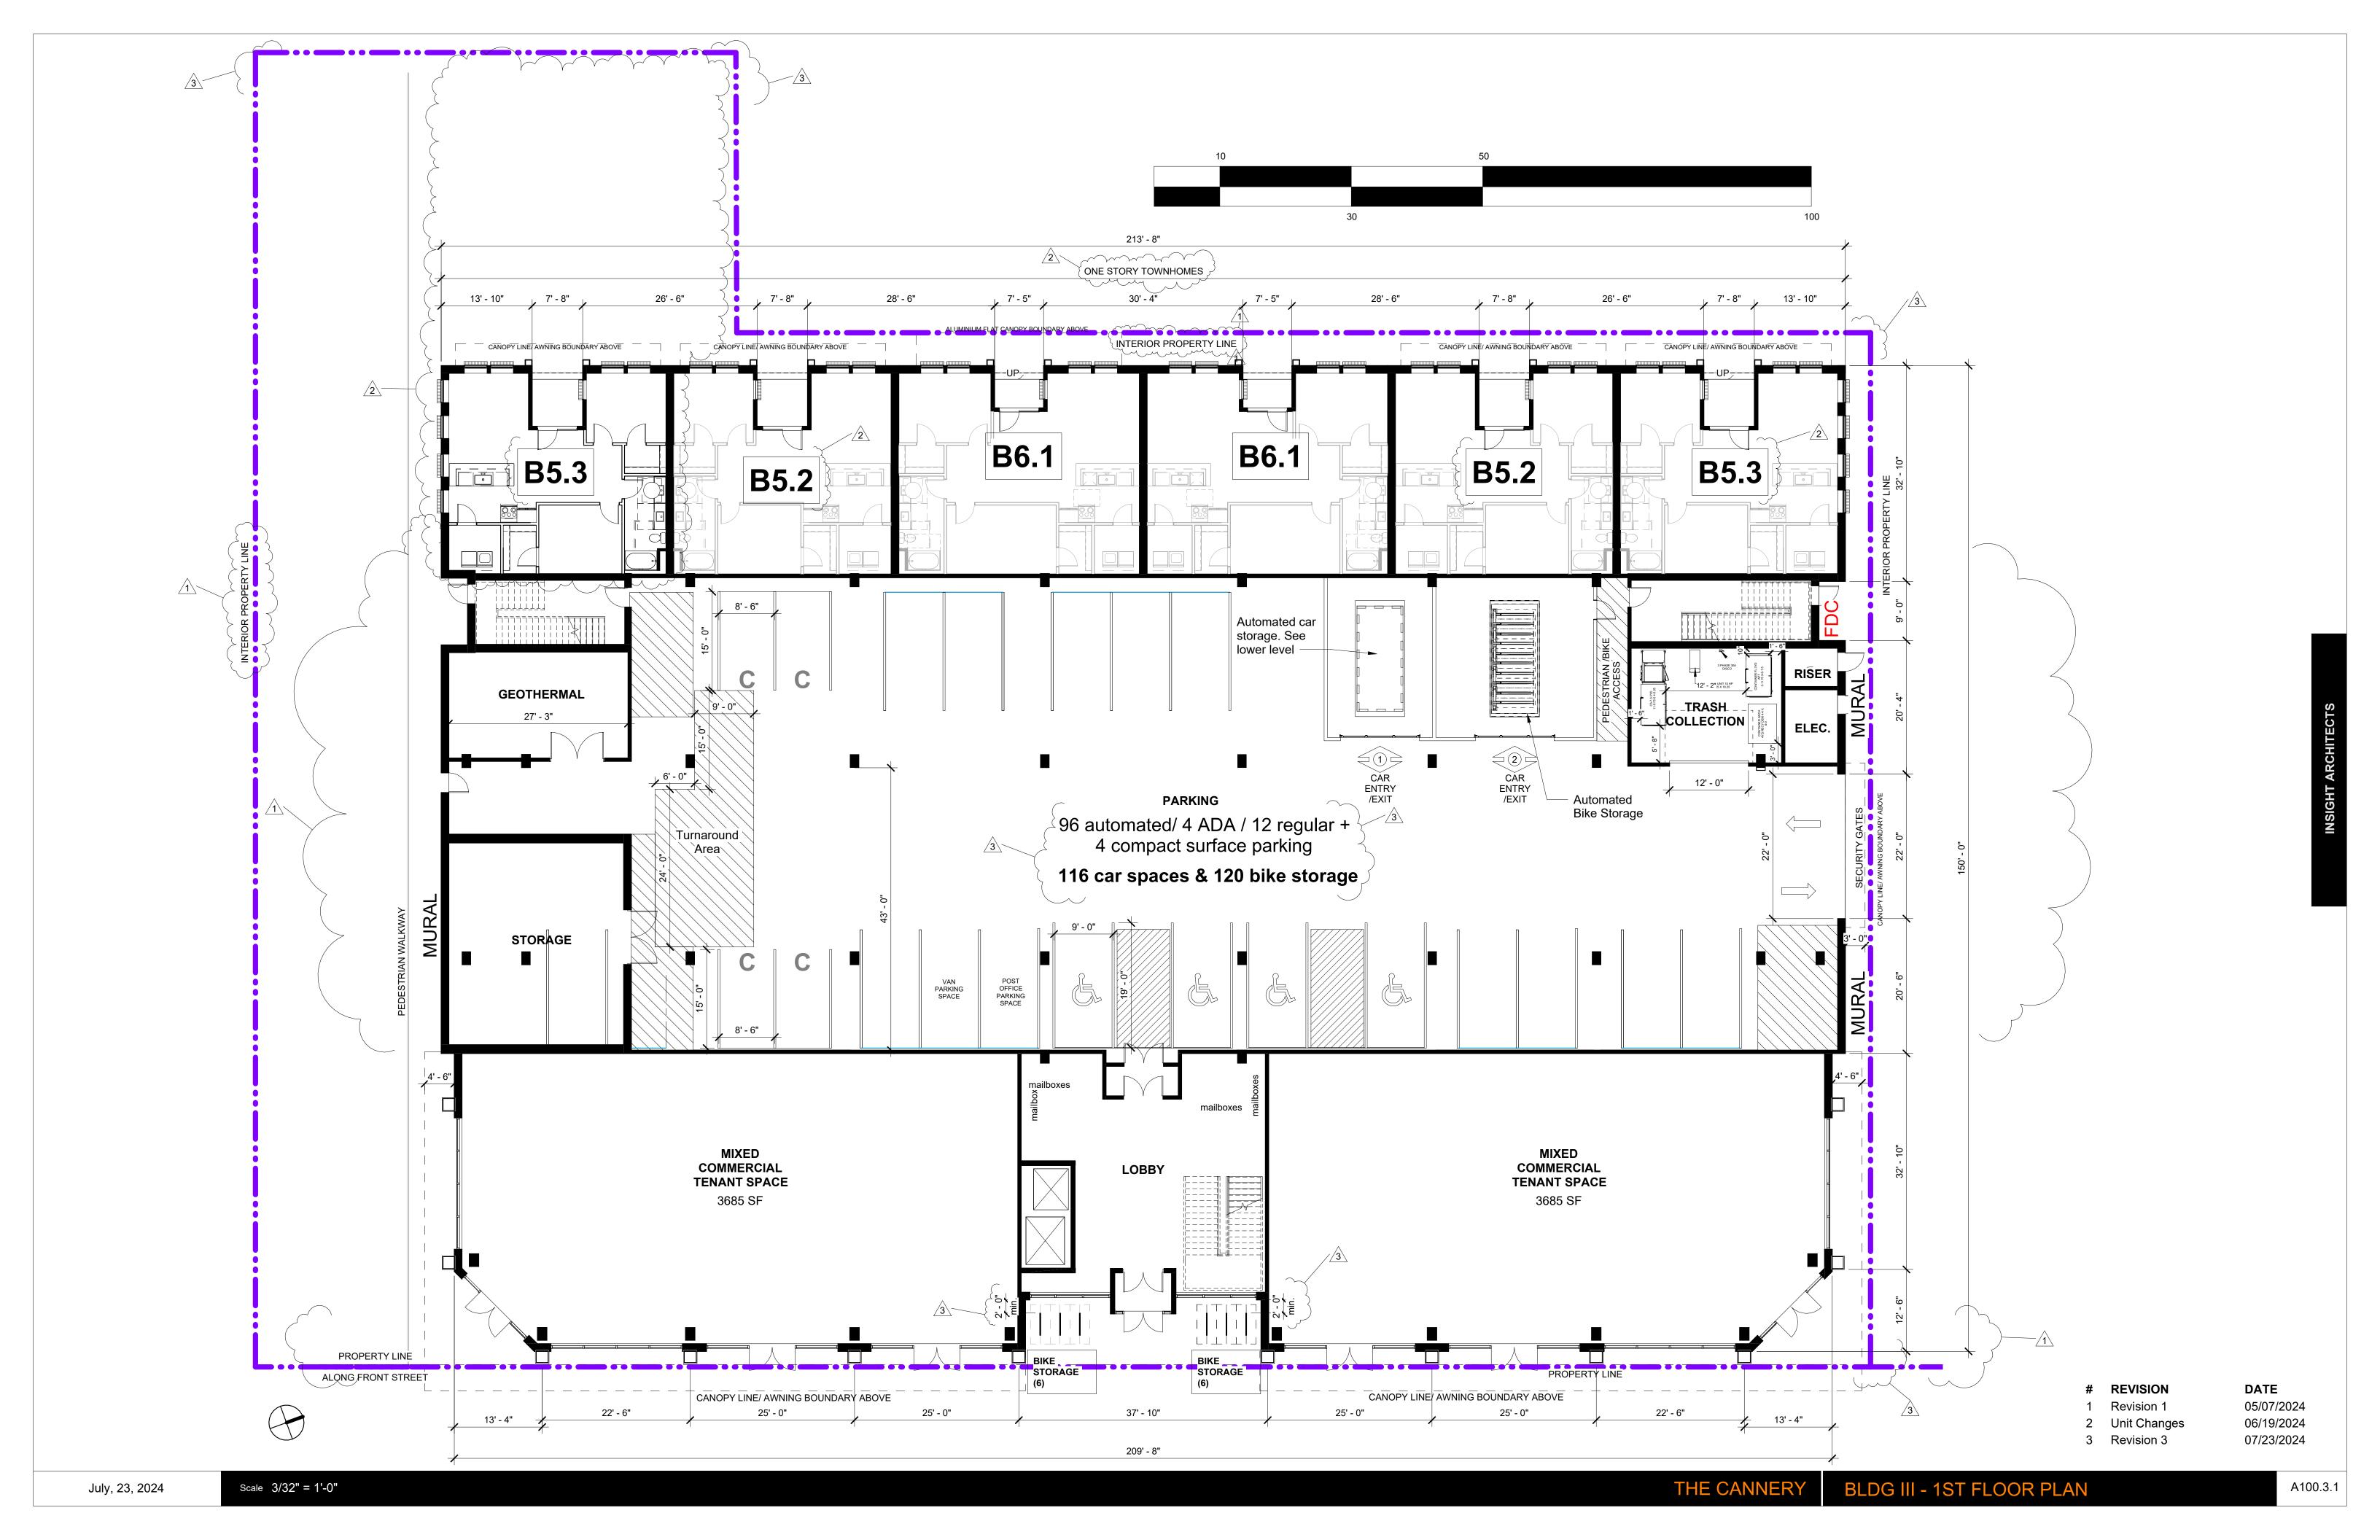

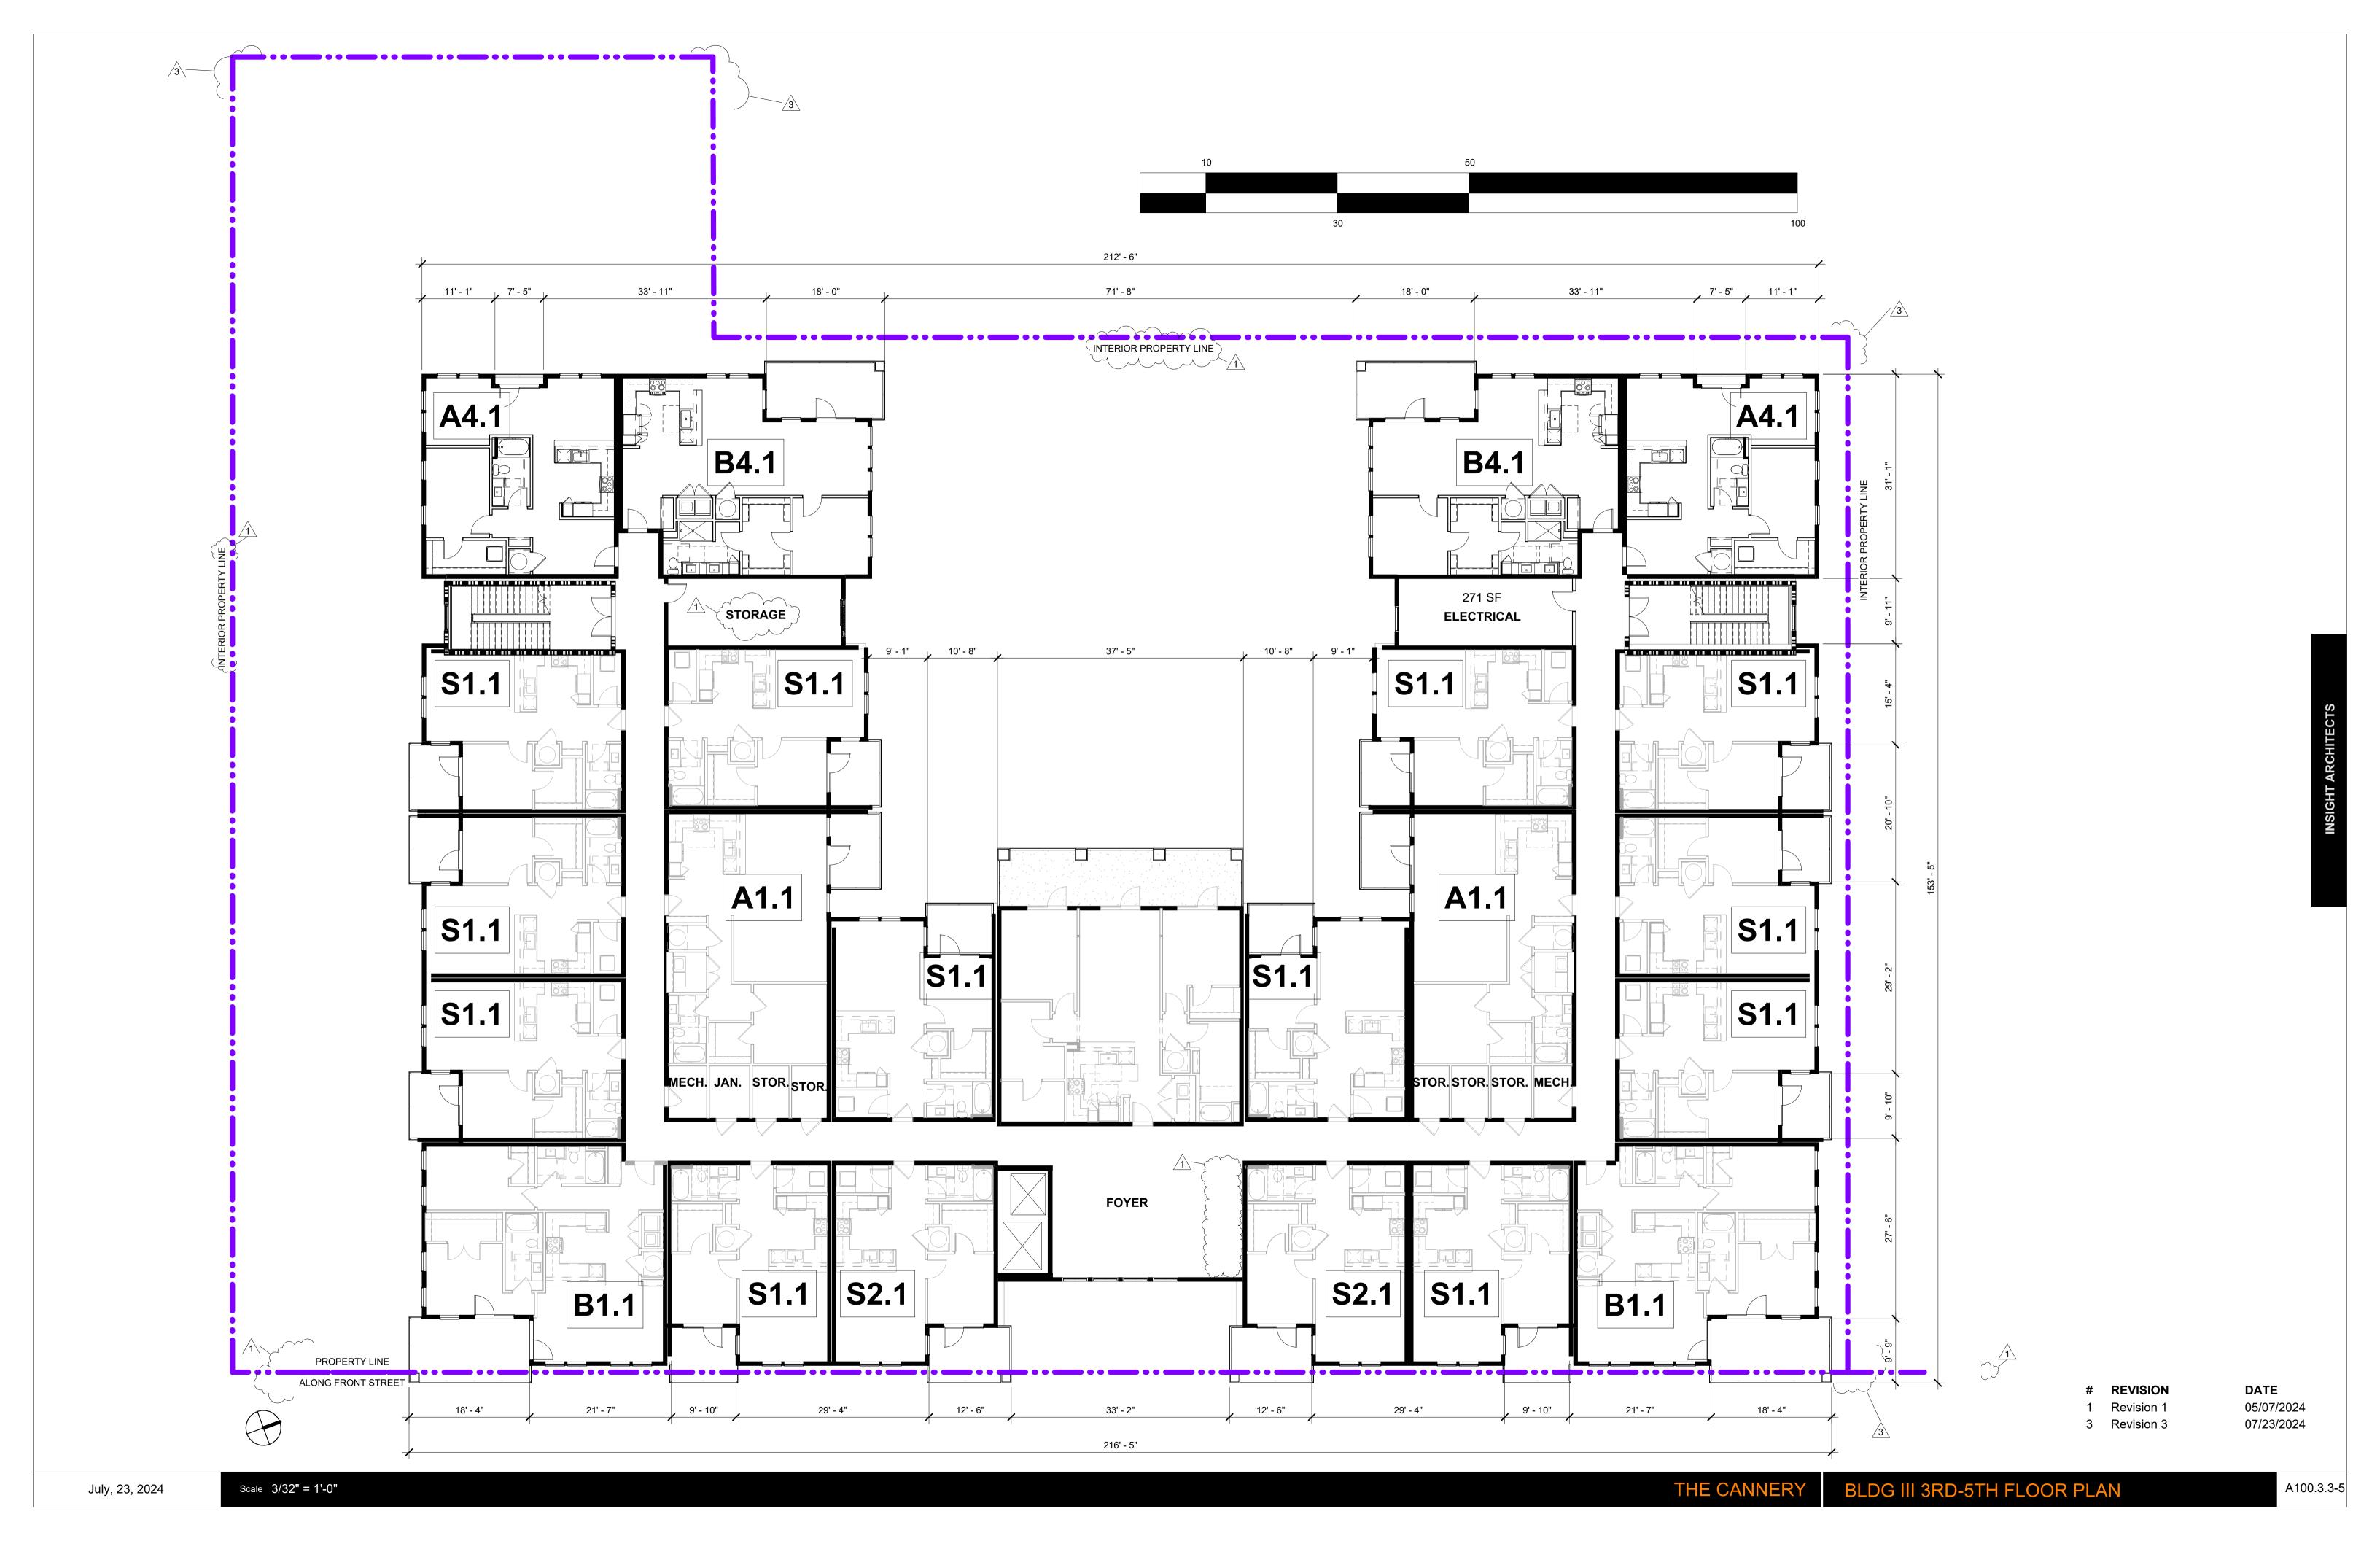





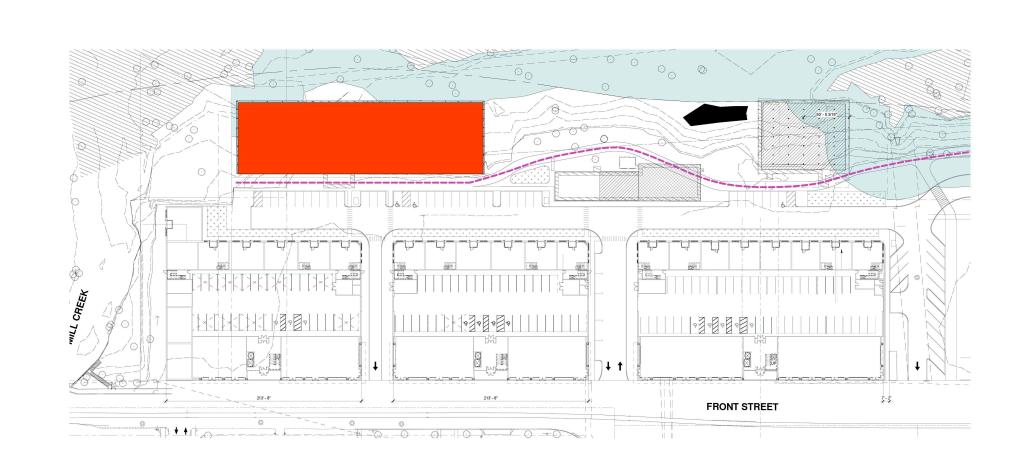








SOUTH SECTION

58% GLAZING*
82% WEATHERPOTECTION.
Pedestrian traffic between the two building sections.
*Calculated per SRC 112.030 (b)

NORTH SECTION

68% GLAZING*
91% WEATHERPOTECTION.
Pedestrian traffic between the two building sections.
*Calculated per SRC 112.030 (b)

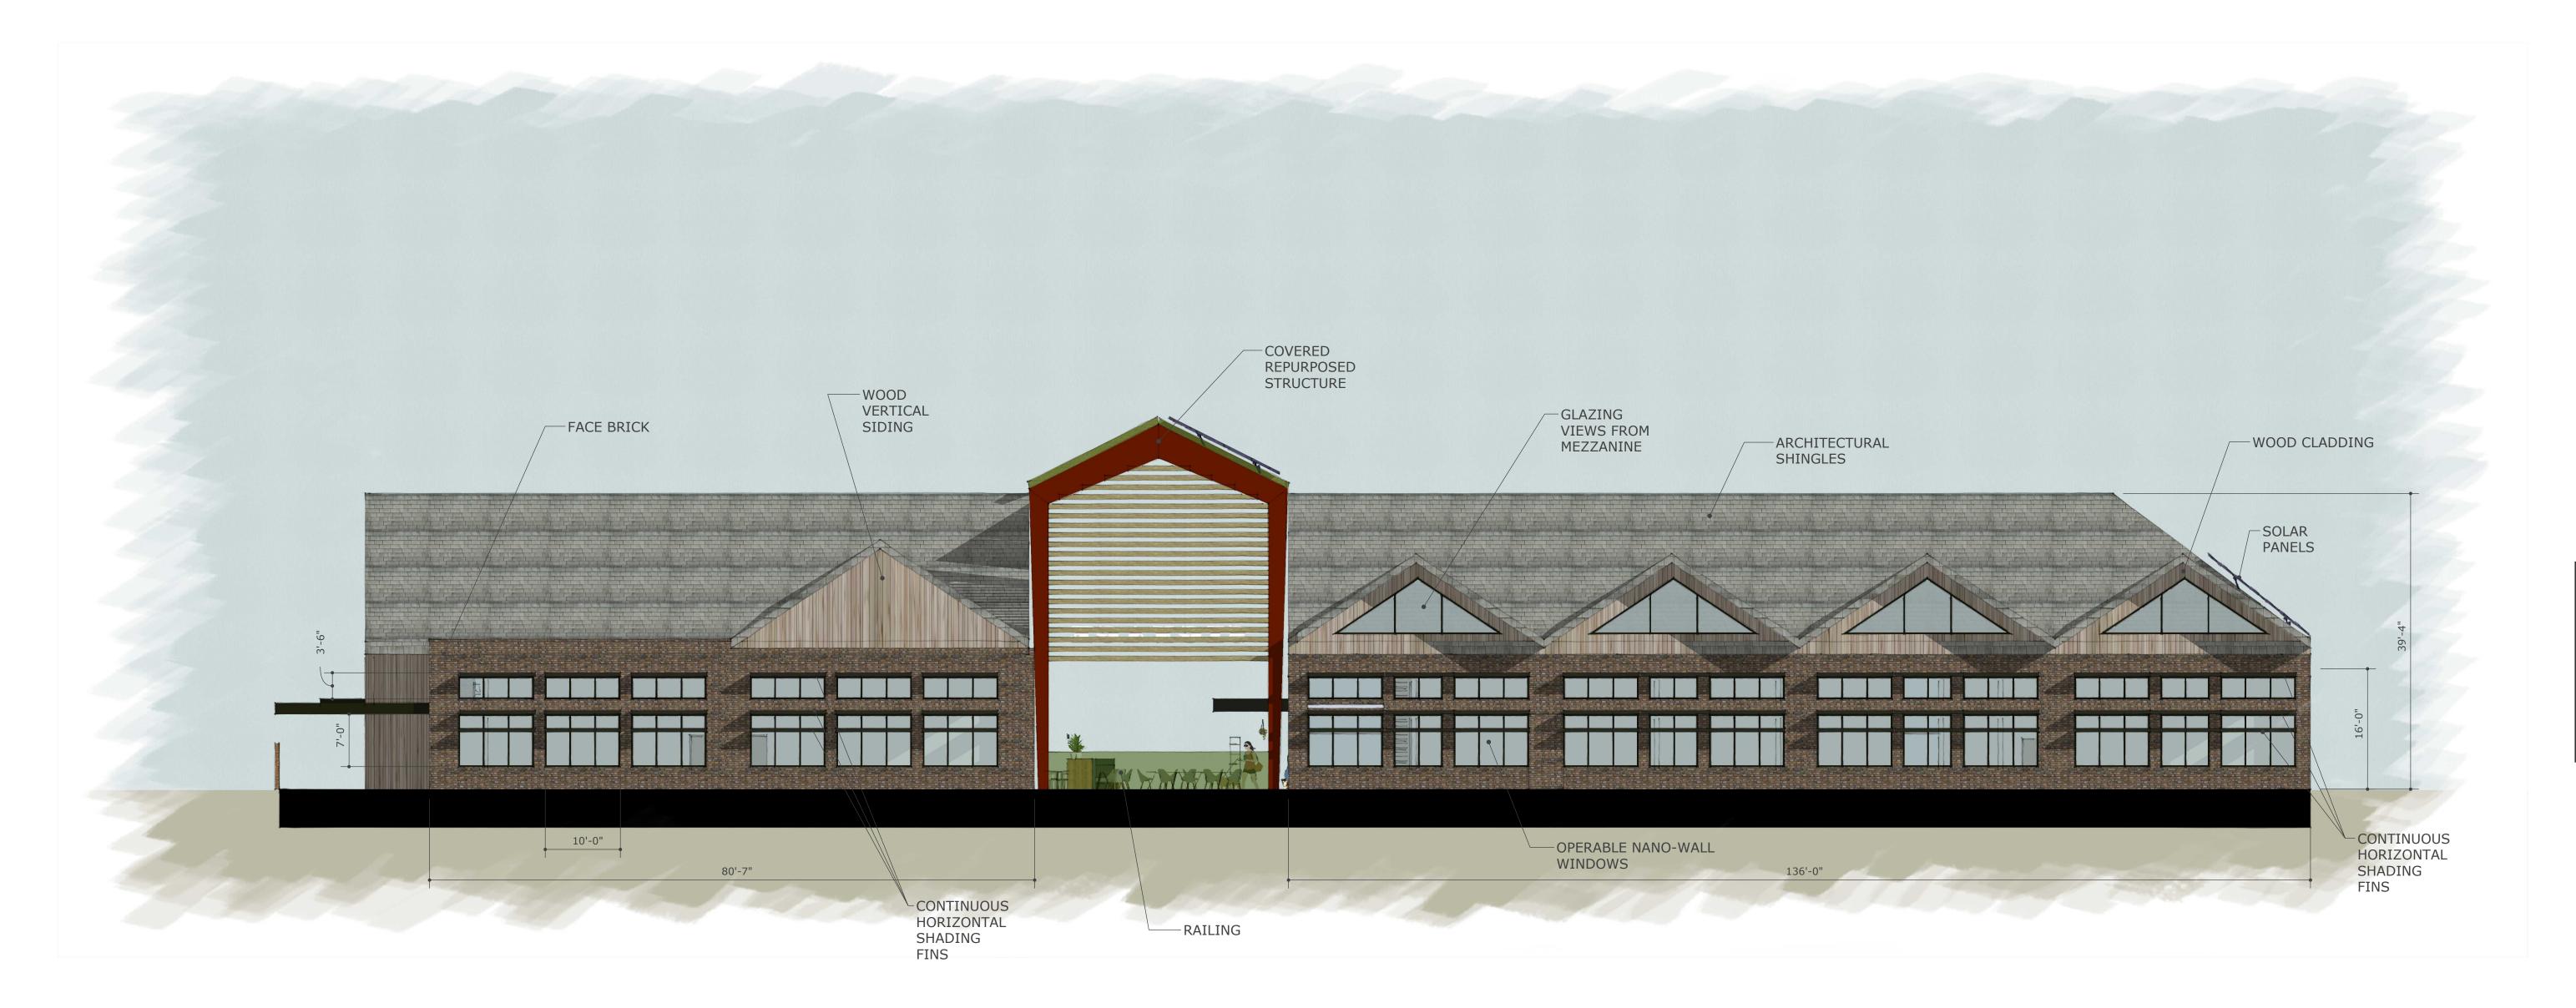

NORTH SECTION


75% GLAZING*
NO WEATHERPOTECTION.
Pedestrian traffic between the two building sections.
*Calculated per SRC 112.030 (b)

SOUTH SECTION

78% GLAZING*
NO WEATHERPOTECTION.
Pedestrian traffic between the two building sections.
*Calculated per SRC 112.030 (b)



NORTH ELEVATION SOUTH ELEVATION

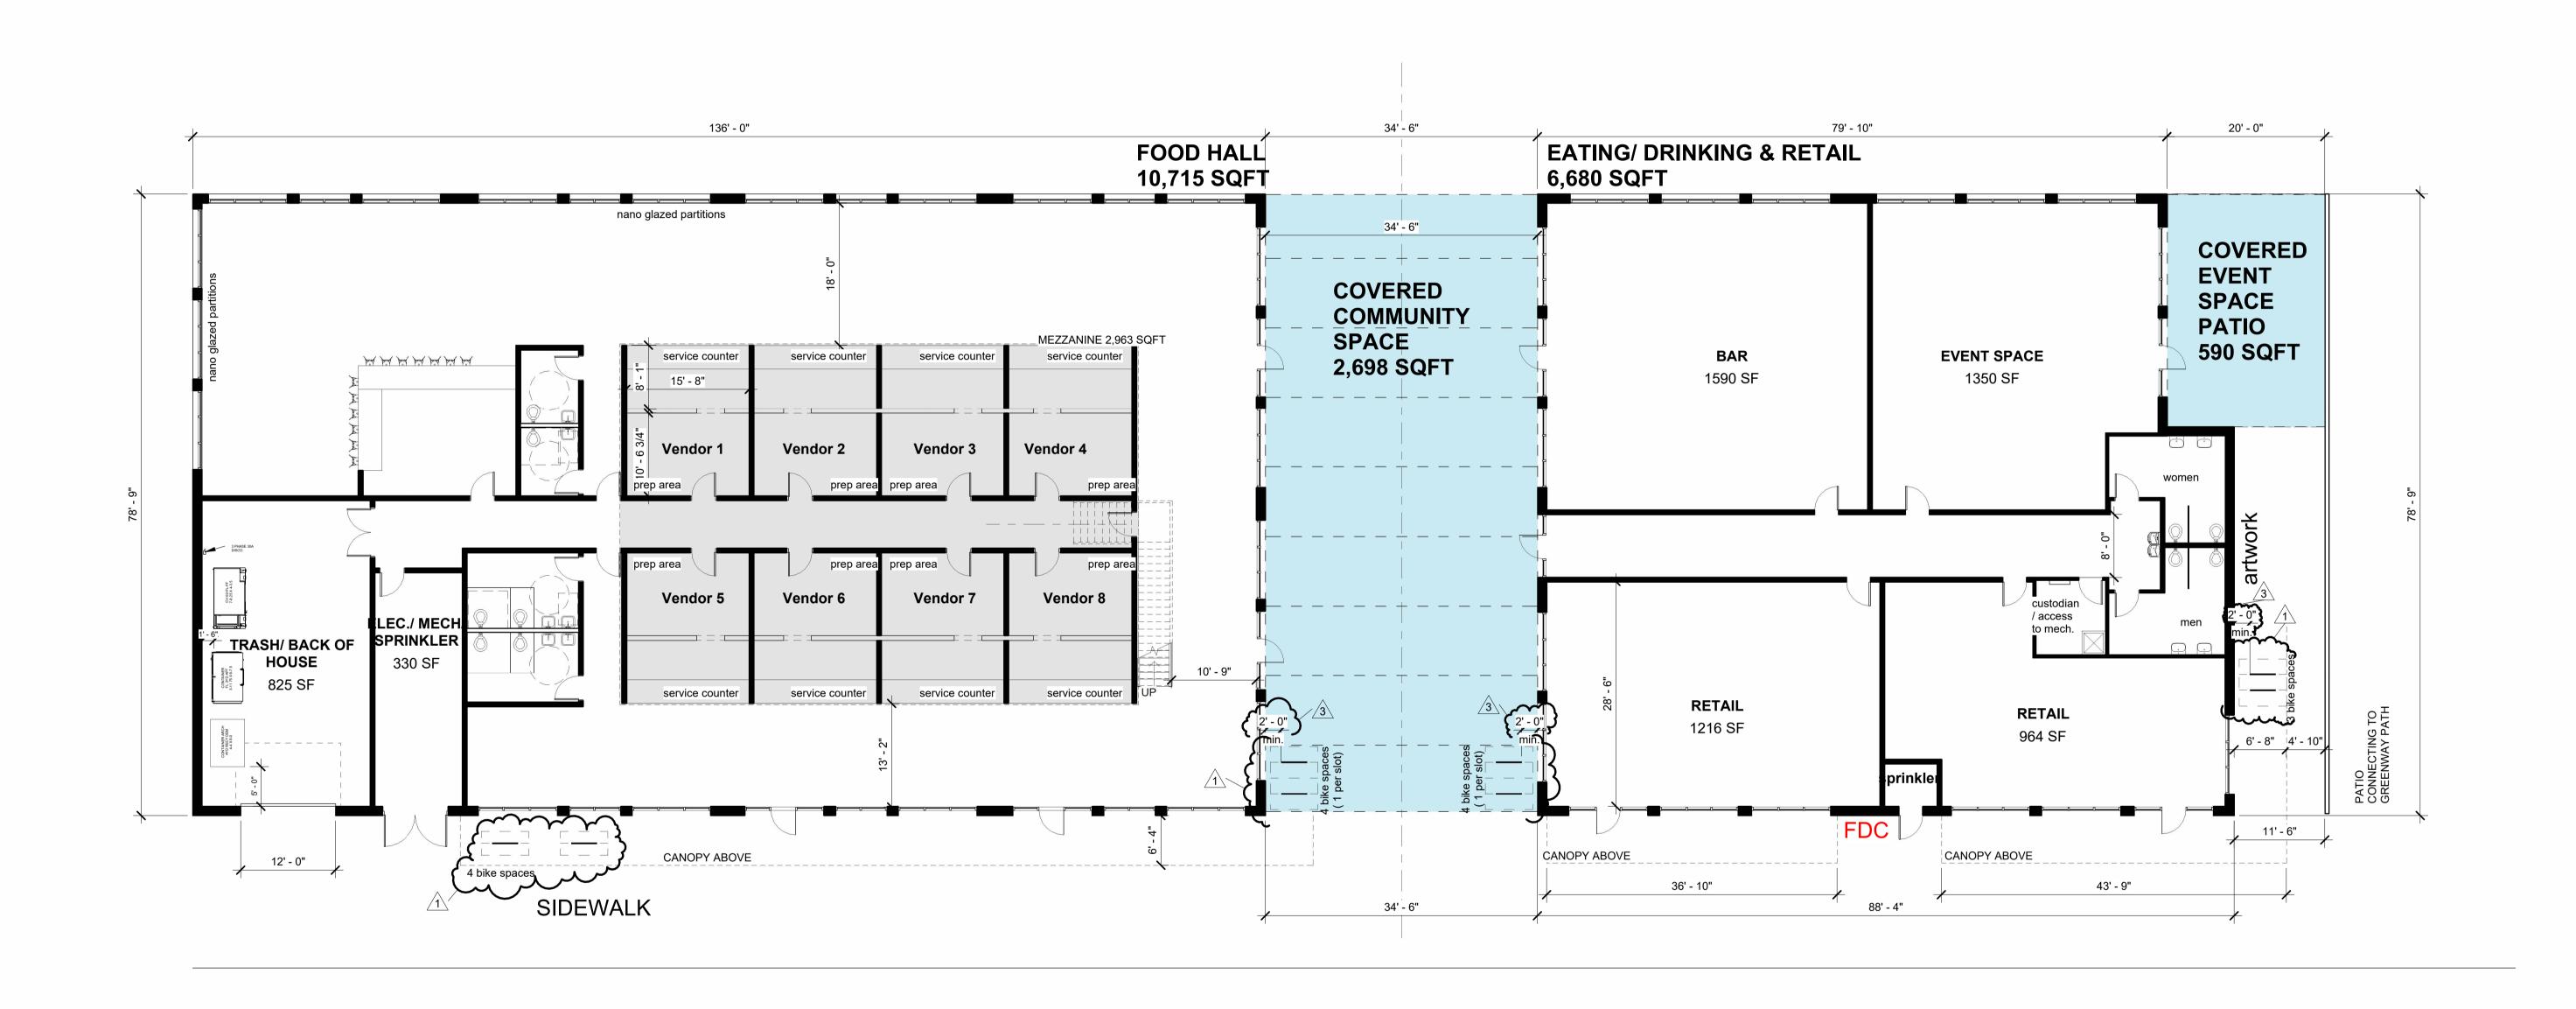

1 FOOD HALL

3/32" = 1'-0"

REVISION


1 Revision 1 05/07/2024 3 Revision 3 07/23/2024

3 Kevision 3

DATE





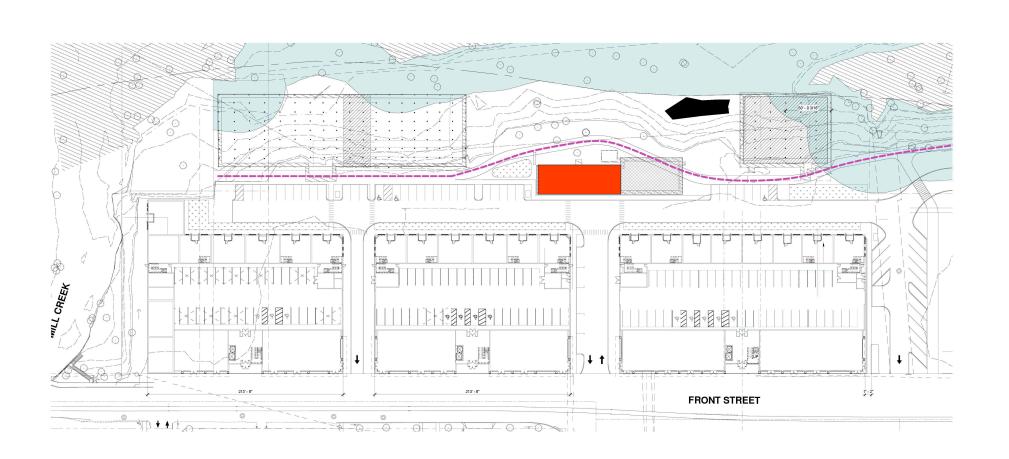








A 02






NOTE: CURRENTLY, THIS FACADE IS COVERED BY A PREVIOUS ADDITION, WHICH IS TO BE DEMOLISHED. ALTERED PORTION OF FACADE IS LESS THAN 10% OF THE OVERALL FACADE.

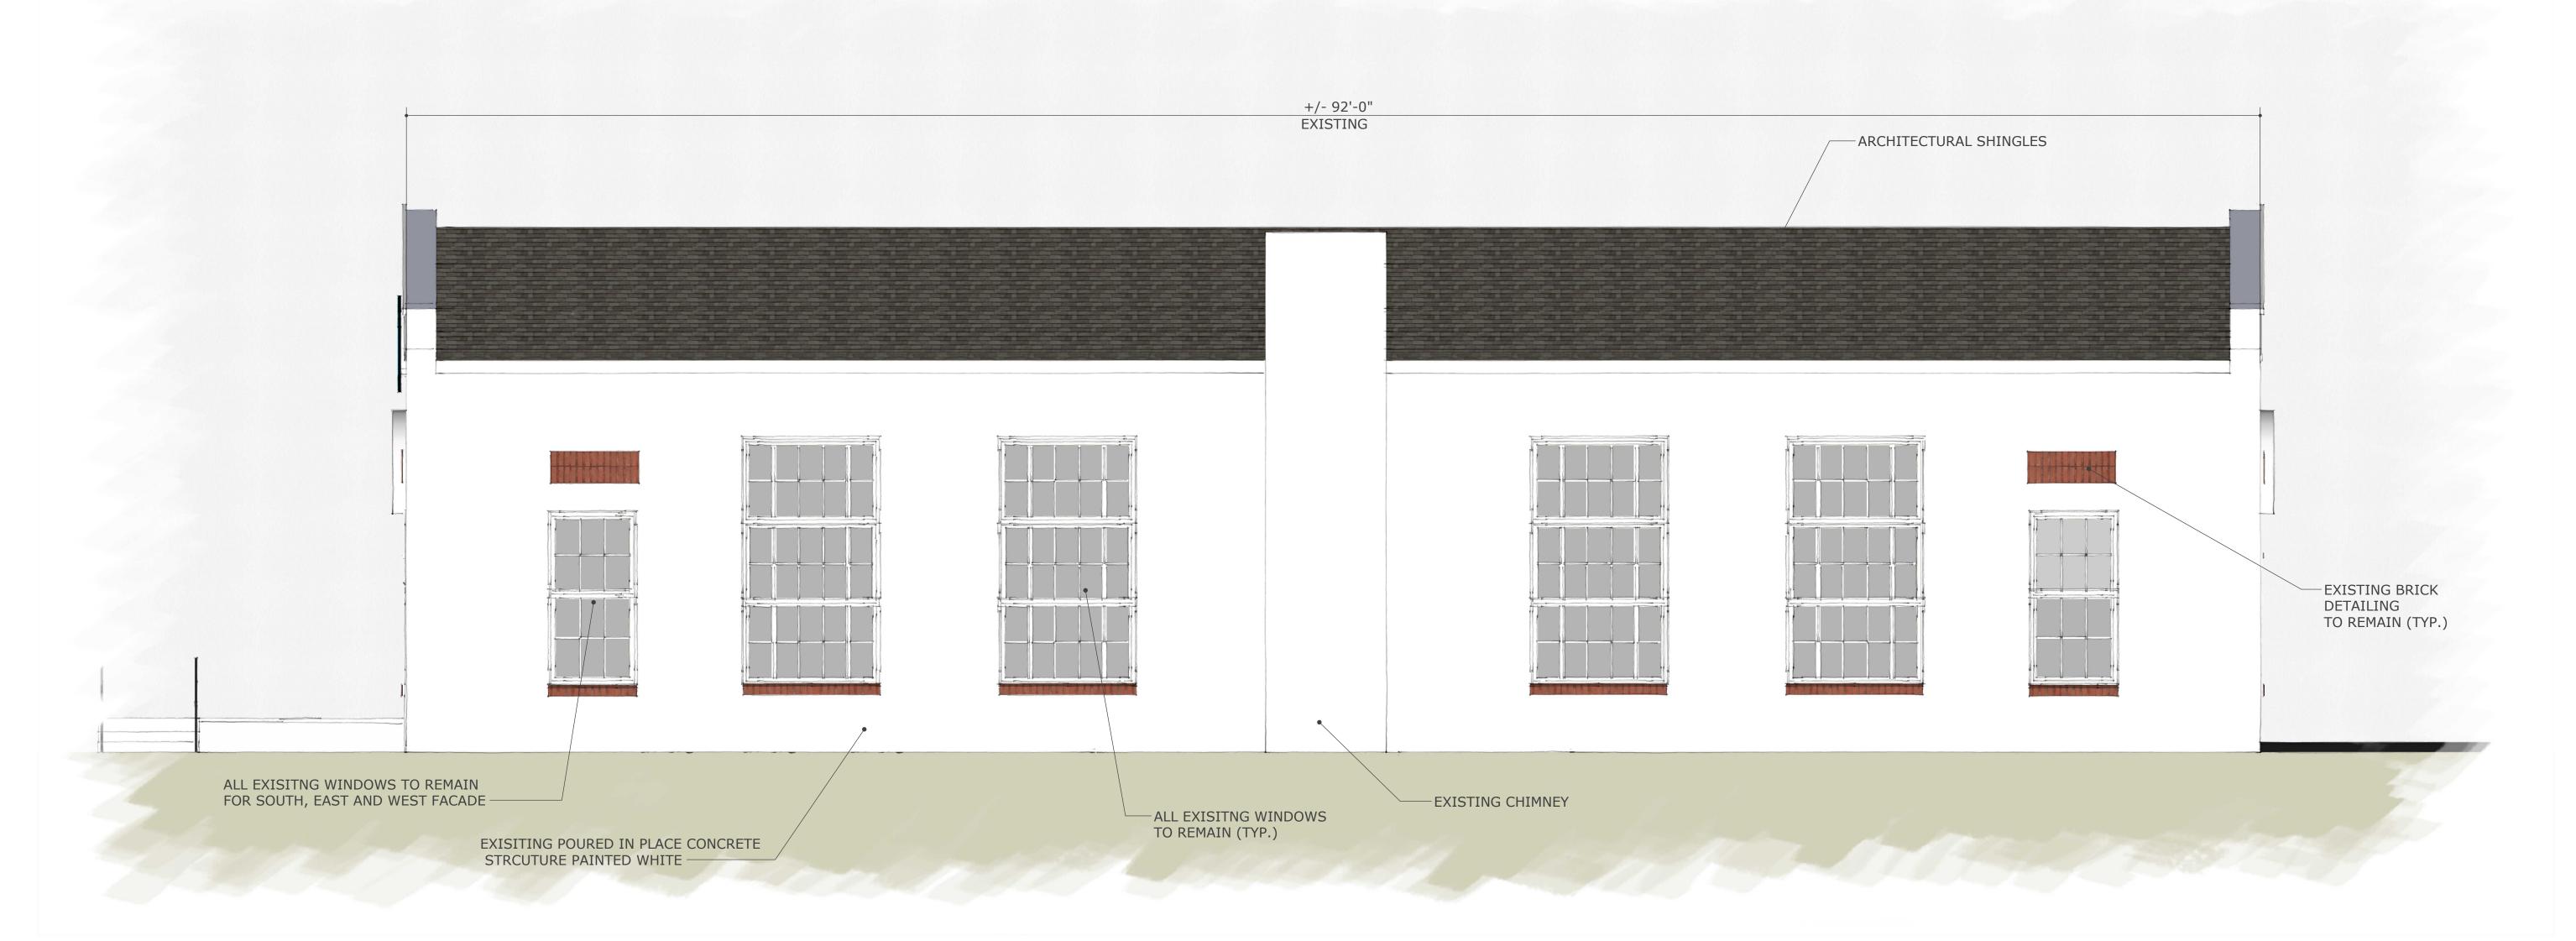





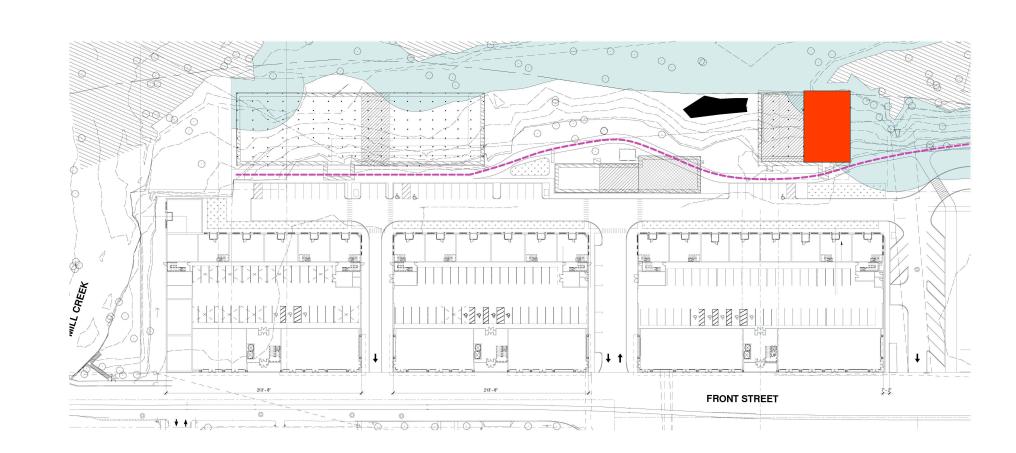






INSIGHT ARCHITECTS, PC The Cannery 1307 West Morehead Street
Suite 108
Charlotte, NC 28208

MARKET
Salem Oregon
Building Elevations

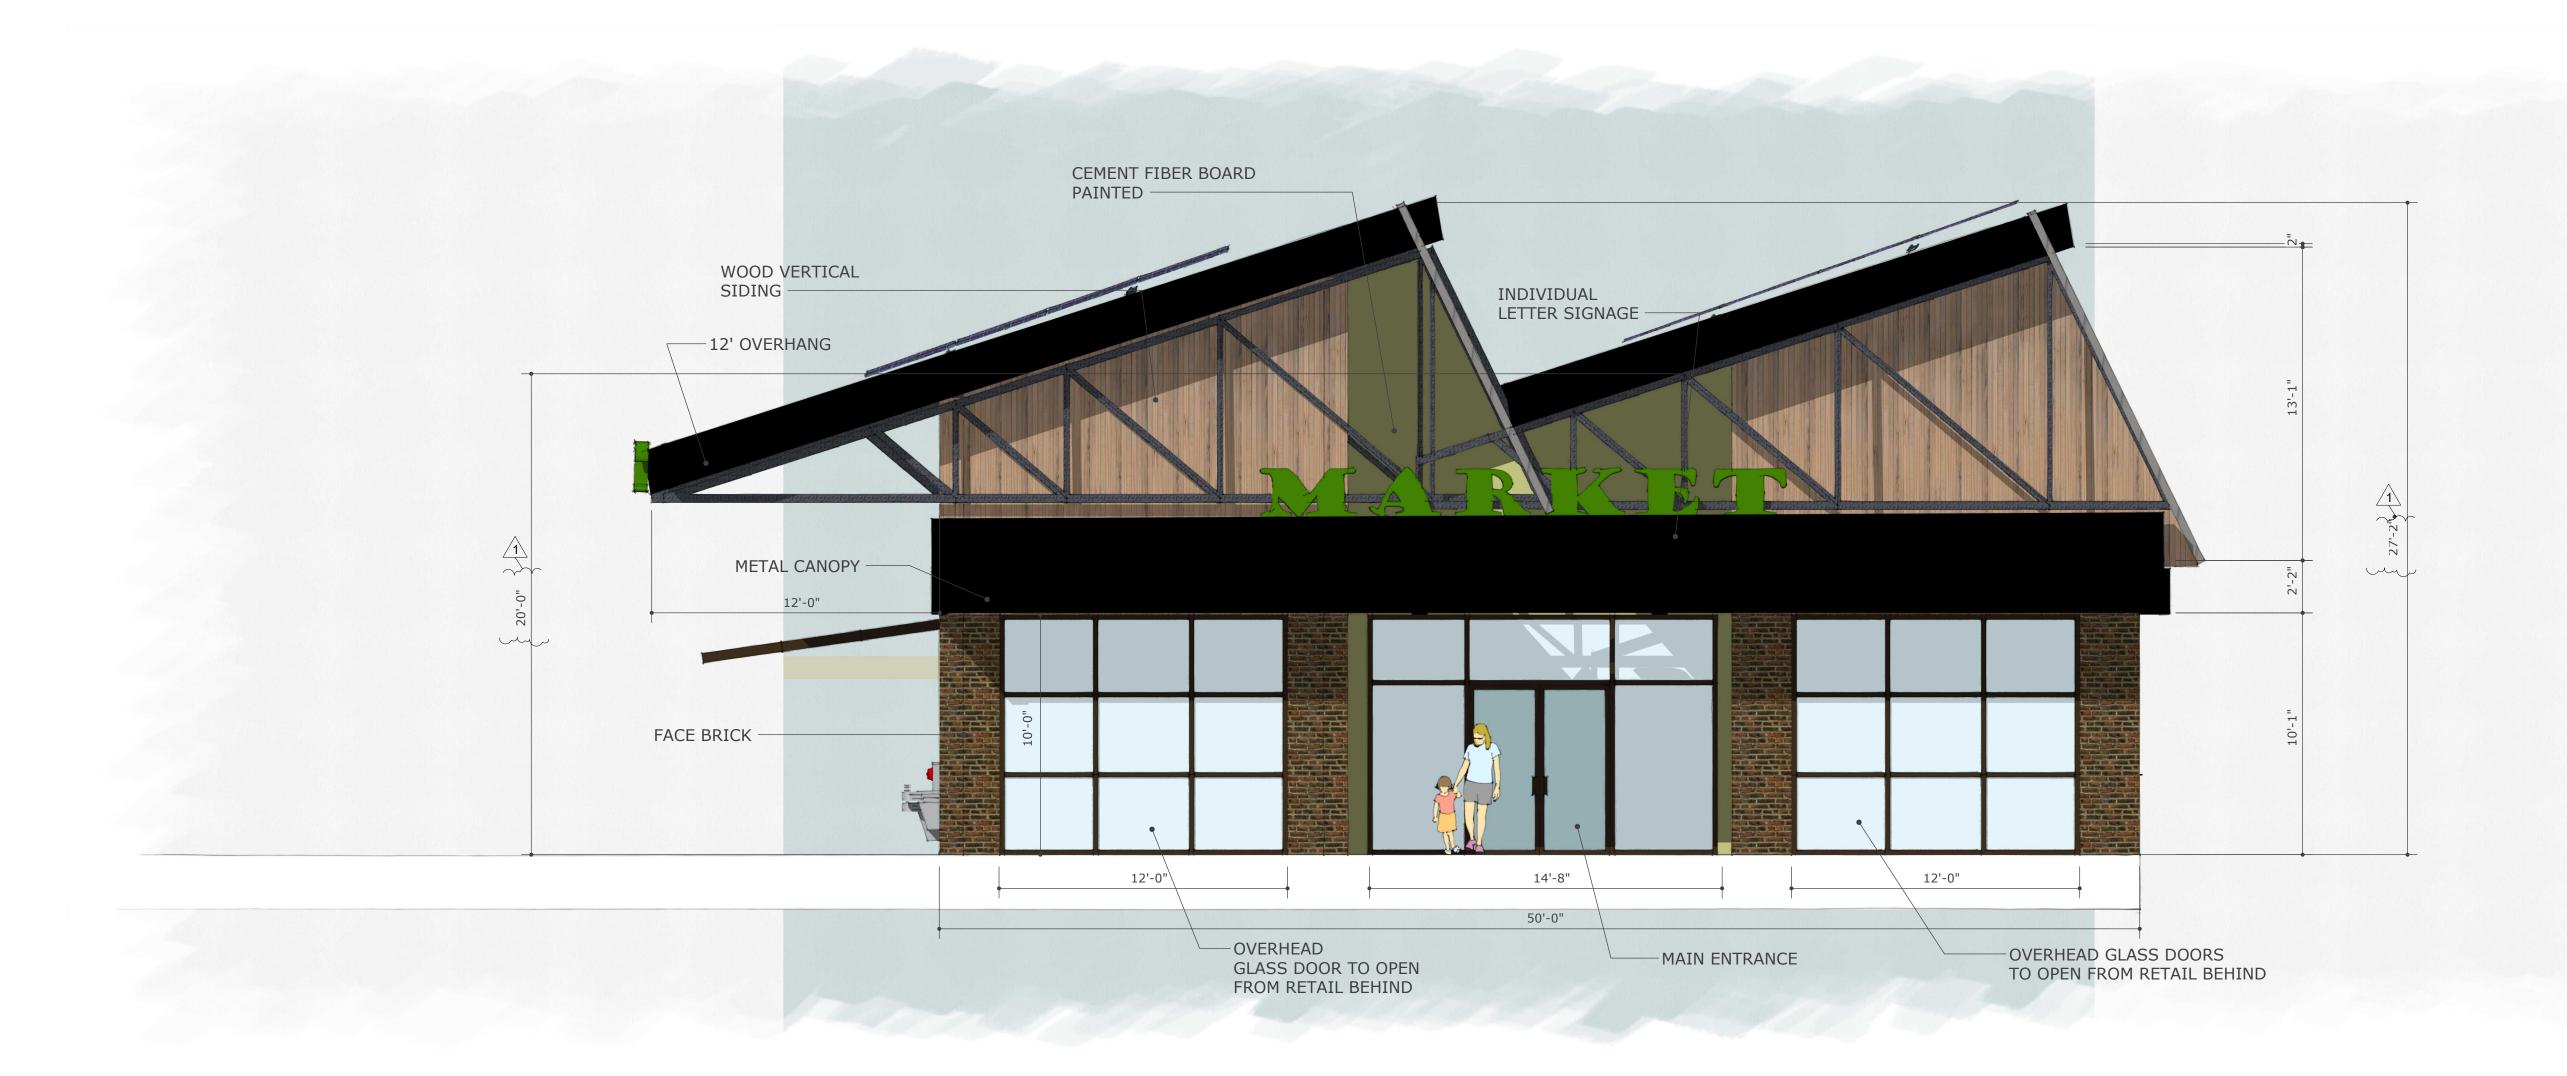

DATE 05/07/2024

77% GLAZING*
100% WEATHERPROTECTION

*Calculated per SRC 112.030 (b)




05

DATE 05/07/2024



DATE 05/07/2024

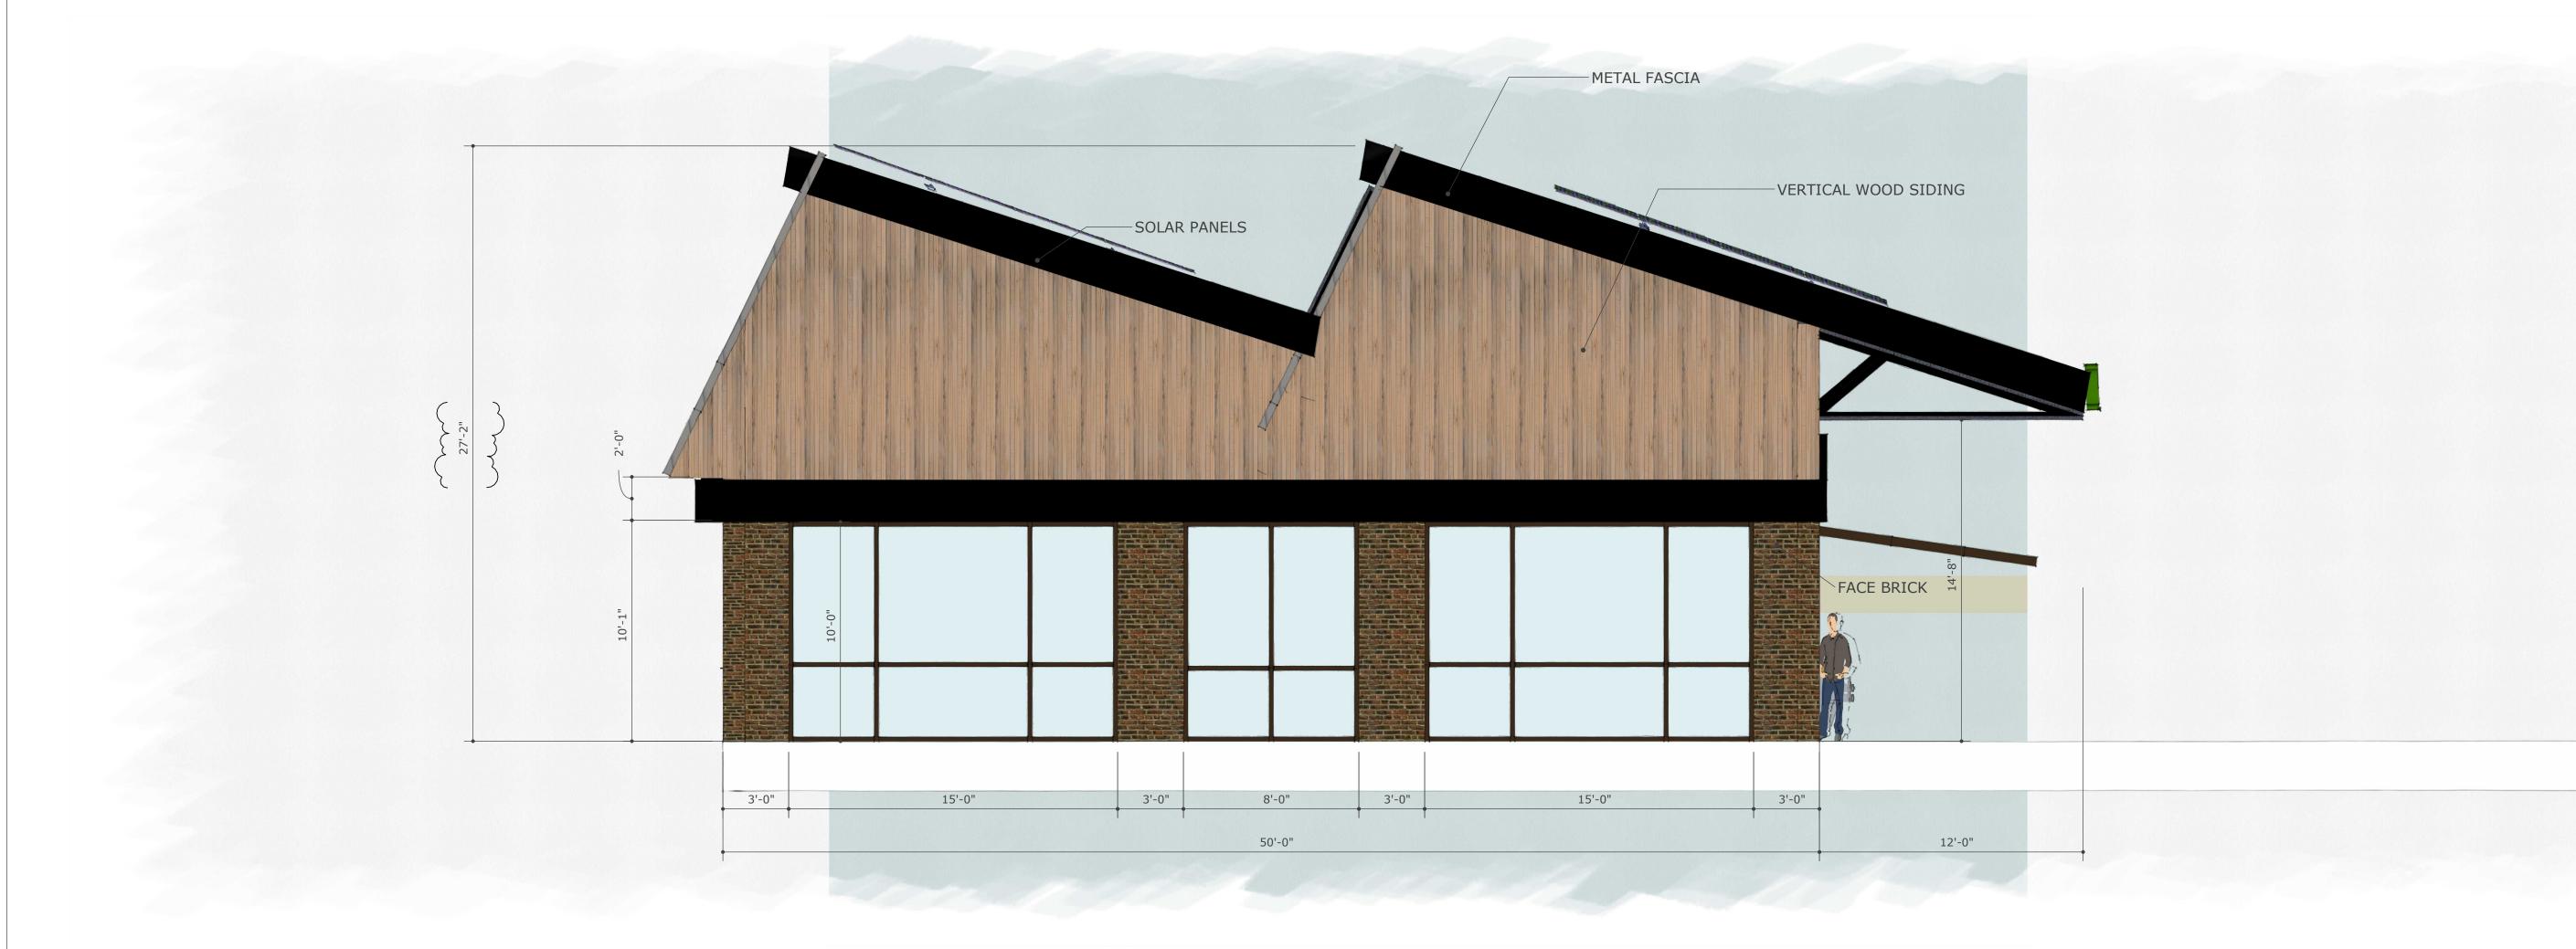


76% GLAZING*
NO WEATHERPROTECTION

*Calculated per SRC 112.030 (b)

REVISION1 Revision 1

DATE

05/07/2024

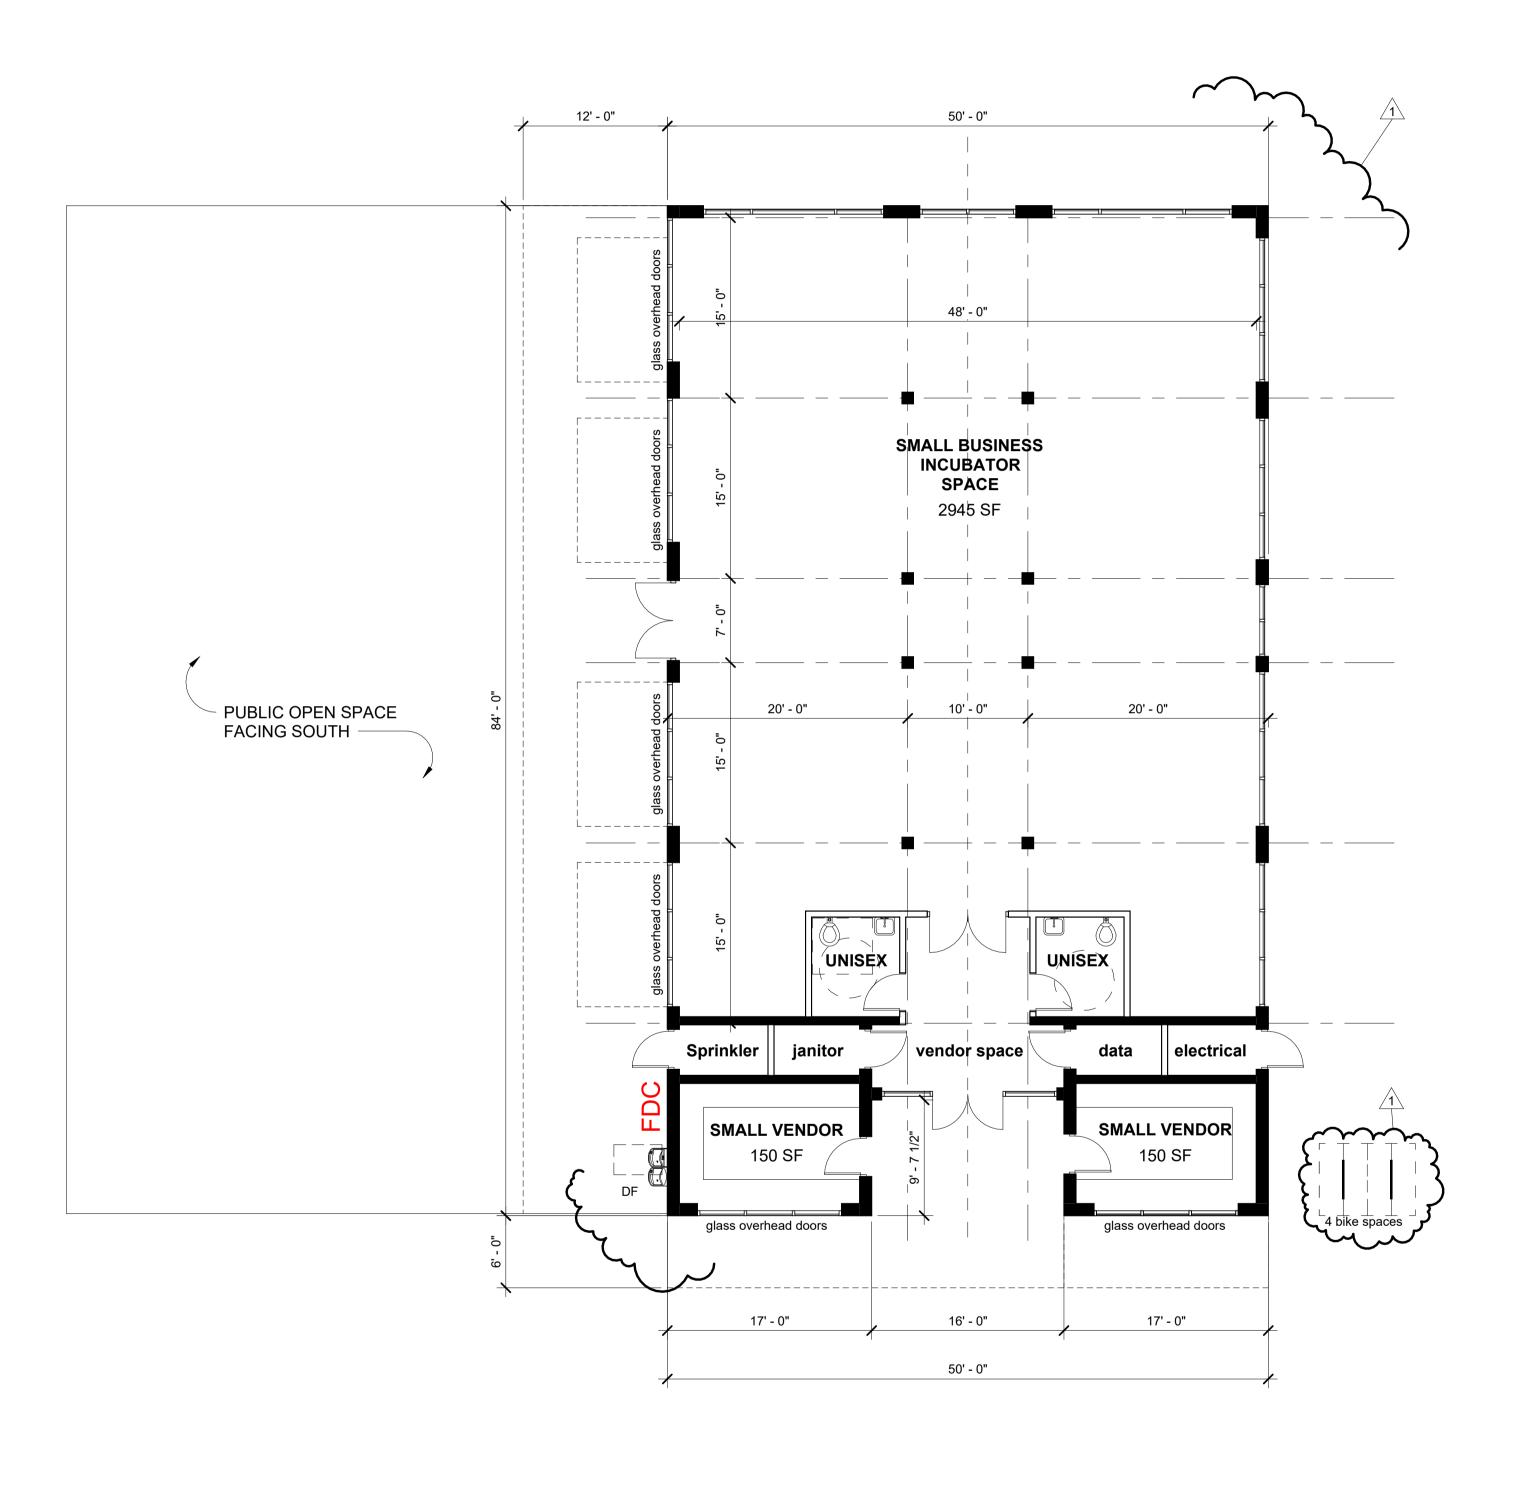

1 1st FLOOR PLAN

1/8" = 1'-0"

TOTAL BUILDING SQFT 4,200 sf <u>COVERED AREA SOUTH: 1,008 sf</u> TOTAL: 5,208 sf

REVISION1 Revision 1

DATE 05/07/2024

Attachment F: Geotechnical Engineering Services Memorandum





7662 SW Mohawk Street, Tualatin, Oregon 97062

www.centralgeotech.com

06/30/26

Digitally signed by Julio Vela

To:

Trent Michels, FUND (Future of Neighborhood Development, LLC)

Grace Wolff, AKS Engineering & Forestry, LLC

From:

Julio Vela, PhD, PE, GE

CGS Project Number:

FUND-1-01

Date:

July 19, 2024

Subject:

Geotechnical Engineering Services

EXPIRES: Response to City of Salem Second Review Comments (July 19, 2024)

Salem Cannery Project

Salem, Oregon

Central Geotechnical Services, LLC (CGS) has prepared this memorandum in response to a submittal requirements comment with respect to geotechnical requirements in City of Salem's, "Land Use Application Completeness Review, Second Review Comments", dated July 19, 2024. The comment references the geotechnical report for the project dated March 24, 2023 prepared under my direction as geotechnical engineer of record (GER). Julio Vela will remain GER for the project under contract with FUND through design and construction phases of the project.

The intent of geotechnical design and construction recommendations provided in the geotechnical report and continuing geotechnical engineering services being provided through the design phase are intended to meet the requirements of Chapter 18 of the International Building Code (IBC) as well as Salem Revised Code (SRC) Sec. 600.025 Subsection (a)(2). Geotechnical design and construction recommendations for proposed development are being provided in consideration of not adversely affecting the stability of land area.

Please let us know if we can provide additional information.



Attachment G: Flood Carrying Capacity Memorandum

July 23, 2024

AKS

Community Planning and Development Staff City of Salem 555 Liberty St SE, Room 305, Salem, OR 97301

RE: The Cannery Project – Flood Capacity Memo

Dear City Staff:

This letter is to address the impact to the flood capacity remark in the City of Salem's "Land Use Application Completeness Review, Second Review Comments", reference number 24-106451-PLN, dated July 19, 2024. The Cannery site is located along the mouth of Mill Creek and the Willamette River with a regulatory floodplain extending within the site on each waterfront. As proposed, the project would not have an impact on the flood carrying capacity of either watercourse with the proposed improvements being above or outside the regulatory floodplain of each watercourse.

A portion of the project is to develop a new building on existing pier systems for Buildings 4 and 6. As such, structural improvements to the pier system may be necessary (but this analysis and determination has yet to be completed). If structural improvements are in fact required to meet current building code requirements within the floodplain boundary and below the floodplain elevation, then a flood capacity review can be provided at the time of building permit when the extent of the improvements is known.

In response to SRC 600.015(d)(6), and based on discussions with City staff, a detailed flood study based on the current known project improvements is not required as no impact to the full flood carrying capacity is currently anticipated.

The attached Exhibit A is a visual representation of the proposed development and associated improvements relative to the floodplain elevations. We request the city accept this letter as documentation to address SRC 600.015(d)(6).

Sincerely,

AKS ENGINEERING & FORESTRY, LLC

Tyler D. Roth, P.E.

3700 River Rd N Suite 1 Keizer, OR, 97303

(503) 400-6028 | RothT@aks-eng.com


RENEWS: 12/31/24

OREGON

Attachments:

• Exhibit A: Floodplain Location Relative to Project Location

Exhibit B: FEMA LOMR-FW Case No. 24-10-0325A

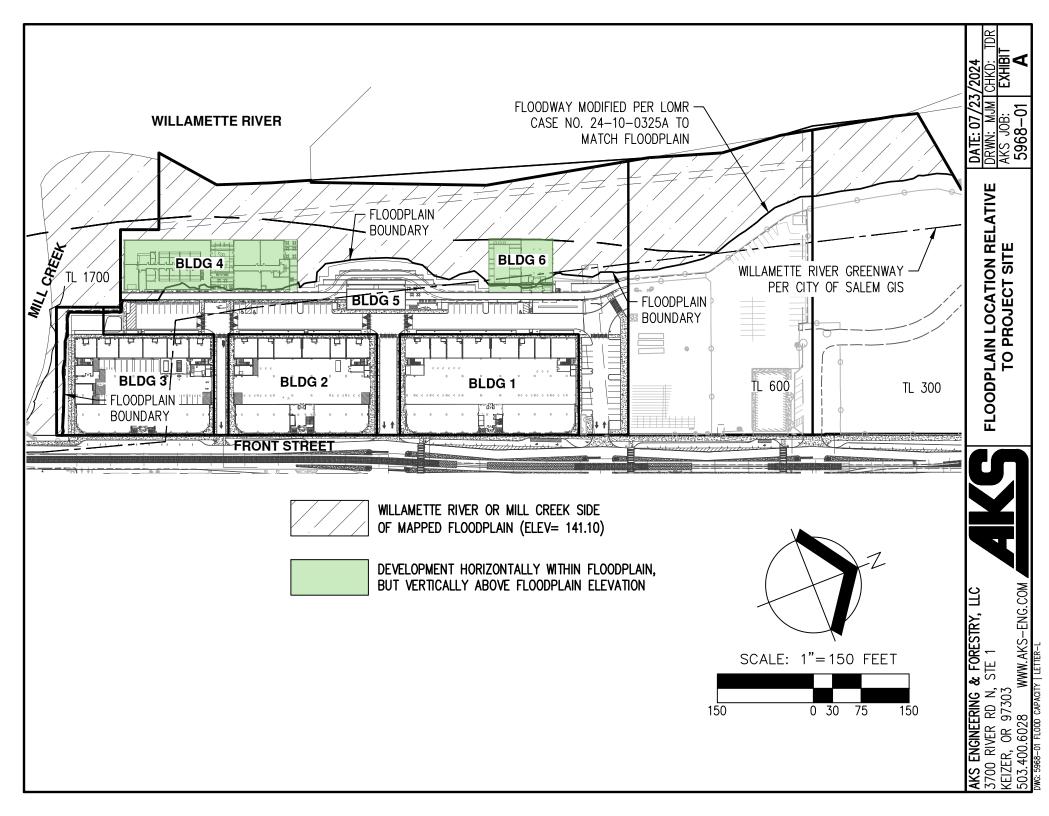



Federal Emergency Management Agency

Washington, D.C. 20472

LETTER OF MAP REVISION FLOODWAY DETERMINATION DOCUMENT (REMOVAL)

COMMUN	NITY AND MAP PANEL INFORMATION	LEGAL PROPERTY DESCRIPTION
COMMUNITY	CITY OF SALEM, MARION COUNTY, OREGON	Lots 1 and 2, Willamette Landing; Lots 1 through 8, Block 24, Lots 1 through 8, Block 25, North Salem; Lots 1 through 8, Block 1, Mill Addition; as shown on the Plats recorded in Book 35, Page 27, in Book 1, Page 34, and in Book 1, Page 90, all in the Office of the County Clerk, Marion County, Oregon
COMMUNITY NO.: 410167		The portion of property is more particularly described by the following metes and bounds:
AFFECTED NUMBER: 41047C0333H		Thetes and bounds.
MAI TAKEE	DATE: 1/2/2003	
FLOODING SOURCE: WILLAMETTE RIVER		APPROXIMATE LATITUDE & LONGITUDE OF PROPERTY:44.953284, -123.036610 SOURCE OF LAT & LONG: LOMA LOGIC DATUM: NAD 83

DETERMINATION

LOT	BLOCK/ SECTION	SUBDIVISION	STREET	OUTCOME WHAT IS REMOVED FROM THE SFHA	FLOOD ZONE	1% ANNUAL CHANCE FLOOD ELEVATION (NGVD 29)	LOWEST ADJACENT GRADE ELEVATION (NGVD 29)	LOWEST LOT ELEVATION (NGVD 29)
			0, 1375, 1105 Front Street NE	Portion of Property	X (shaded)			141.1 feet

Special Flood Hazard Area (SFHA) - The SFHA is an area that would be inundated by the flood having a 1-percent chance of being equaled or exceeded in any given year (base flood).

ADDITIONAL CONSIDERATIONS (Please refer to the appropriate section on Attachment 1 for the additional considerations listed below.)

LEGAL PROPERTY DESCRIPTION INADVERTENT INCLUSION FLOODWAY 1 PORTIONS REMAIN IN THE SFHA STATE LOCAL CONSIDERATIONS

This document provides the Federal Emergency Management Agency's determination regarding a request for a Letter of Map Revision for the property described above. Using the information submitted and the effective National Flood Insurance Program (NFIP) map, we have determined that the described portion(s) of the

property(ies) is/are not located in the NFIP regulatory floodway or the SFHA, an area inundated by the flood having a 1-percent chance of being equaled or exceeded in any given year (base flood). This document revises the effective NFIP map to remove the subject property from the NFIP regulatory floodway and the SFHA located on the effective NFIP map; therefore, the Federal mandatory flood insurance requirement does not apply. However, the lender has the option to continue the flood insurance requirement to protect its financial risk on the loan.

This determination is based on the flood data presently available. The enclosed documents provide additional information regarding this determination. If you have any questions about this document, please contact the FEMA Mapping and Insurance eXchange (FMIX) toll free at (877) 336-2627 (877-FEMA MAP) or by letter addressed to the Federal Emergency Management Agency, LOMC Clearinghouse, 3601 Eisenhower Avenue. Suite 500, Alexandria, VA 22304-6426.

Patrick "Rick" F. Sacbibit, P.E., Branch Chief

Engineering Services Branch

Federal Insurance and Mitigation Administration



Federal Emergency Management Agency

Washington, D.C. 20472

LETTER OF MAP REVISION FLOODWAY DETERMINATION DOCUMENT (REMOVAL)

ATTACHMENT 1 (ADDITIONAL CONSIDERATIONS)

LEGAL PROPERTY DESCRIPTION (CONTINUED)

Beginning at the Northeasterly corner of Lot 2 of the plat of "Willamette Landing", also being on the westerly extension of the northerly line of Lot 1 of said plat; thence along said westerly extension and continuing along said northerly line, South 68°39'53" East 268.50 feet, to the northeasterly corner thereof; thence along the easterly line thereof, South 21°22'07" West 278.73 feet; thence South 68°37'53" East 1.00 feet, to the northwesterly right-of-way line of Front Street NE (49.50 feet from the centerline); thence along said northwesterly line, (continuing along said northwesterly rightof- way line as the right-of-way width decreases to 30.00 feet from the centerline) South 21°22'07" West 1193.01 feet; thence leaving said northwesterly right-of-way line, North 45°59'45" West 6.11 feet; thence North 79°28'11" West 6.51 feet; thence North 64°49'00" West 26.55 feet; thence North 67°33'52" West 40.32 feet; thence North 73°53'11" West 18.75 feet; thence North 64°07'32" West 8.91 feet; thence North 57°56'56" West 12.32 feet; thence North 67°44'32" West 14.46 feet; thence North 68°32'32" West 5.14 feet; thence North 68°10'22" West 8.37 feet; thence North 51°21'39" West 6.05 feet; thence North 34°24'49" West 3.42 feet; thence North 69°00'29" West 5.28 feet; thence North 68°25'00" West 11.20 feet; thence North 71°07'13" West 11.56 feet; thence North 46°55'38" West 3.01 feet; thence North 56°38'29" West 1.72 feet; thence North 60°05'27" West 2.69 feet; thence North 13°44'52" West 3.50 feet; thence North 21°56'20" East 57.91 feet; thence North 14°36'22" East 6.40 feet; thence North 22°11'31" East 11.52 feet; thence North 52°45'48" East 1.04 feet; thence North 05°46'33" East 3.13 feet; thence North 64°32'11" West 17.88 feet; thence North 21°54'41" East 2.11 feet; thence South 68°57'53" East 51.80 feet; thence North 21°00'57" East 62.34 feet; thence North 69°24'18" West 49.95 feet; thence North 20°35'42" East 33.30 feet; thence North 21°17'23" East 35.62 feet; thence North 69°24'49" West 16.06 feet; thence North 21°23'26" East 142.39 feet; thence North 68°33'31" West 9.56 feet; thence North 20°50'40" East 30.64 feet; thence North 69°59'46" West 19.73 feet; thence North 22°00'31" West 12.78 feet; thence North 27°38'32" West 5.03 feet; thence North 13°19'21" East 29.35 feet; thence North 10°49'12" East 11.98 feet; thence North 14°51'39" East 2.90 feet; thence North 17°13'05" East 20.89 feet; thence North 15°20'01" East 1.55 feet; thence North 19°00'22" East 29.53 feet; thence North 24°59'49" East 27.58 feet; thence North 30°18'09" East 5.98 feet; thence North 56°22'26" East 9.07 feet; thence North 34°31'42" East 15.41 feet; thence North 63°44'34" East 24.91 feet; thence North 35°52'49" East 24.19 feet; thence North 05°03'52" West 19.47 feet; thence North 11°27'15" East 3.31 feet; thence North 08°08'38" East 18.81 feet; thence North 53°01'23" East 3.58 feet; thence North 61°18'50" East 17.57 feet; thence North 80°08'29" East 2.52 feet; thence North 71°13'49" East 6.66 feet; South 68°35'42" East 11.81 feet; thence North 21°25'06" East 10.09 feet; thence South 68°34'54" East 4.98 feet; thence North 21°45'58" East 7.90 feet; thence North 67°50'29" West 6.06 feet; thence North 21°26'08" East 48.02 feet; thence South 69°08'44" East 14.00 feet; thence North 21°29'59" East 13.25 feet; thence North 68°46'11" West 8.01 feet; thence North 20°57'30" East 5.25 feet; thence North 68°36'13" West 5.11 feet; thence North 21°23'47" East 17.13 feet; thence North 68°26'47" West 25.22 feet; thence North 21°31'51" West 3.35 feet; thence North 09°27'57" East 5.88 feet; thence North 21°50'03" East 2.52 feet; thence North 40°51'49" East 2.35 feet; thence North 80°45'47" East 1.23 feet; thence North 26°43'02" East 46.91 feet; thence North 15°36'24" East 0.82 feet; thence North 06°19'00" West 10.85 feet; thence North 17°44'15" West 0.87 feet; thence North 26°58'45" West 2.53 feet; thence North 19°18'30" East 16.40 feet; thence North 30°34'42" East 9.25 feet; thence North 15°18'09" East 38.26 feet; thence North 19°03'55" East 25.93 feet; thence North 07°10'36" East 11.80 feet; thence North 11°01'57" East 28.33 feet; thence North 06°18'05" East 33.13 feet; thence North 05°22'57" West 27.12 feet; thence North 18°54'31" West 20.37 feet; thence North 14°26'53" West 21.42 feet; thence North 11°25'08" West 10.67 feet; thence North 15°30'05" West 22.62 feet; thence North 22°44'17" West 9.13 feet; thence North 15°43'20" West 27.20 feet; thence North 00°28'03" West 25.39 feet; thence North 03°38'22" West 17.56 feet; thence North 19°02'28" East 24.07 feet; thence North 10°42'53" East 20.68 feet; thence North 09°50'25" East 18.73 feet; thence North 14°34'04" East 14.68 feet; thence North 13°44'24" East 16.28 feet; thence North 07°16'13" East 19.42 feet; thence North 06°10'42" East 12.08 feet; thence North 10°42'11" East 16.67 feet; thence North 16°48'49" East

This attachment provides additional information regarding this request. If you have any questions about this attachment, please contact the FEMA Mapping and Insurance eXchange (FMIX) toll free at (877) 336-2627 (877-FEMA MAP) or by letter addressed to the Federal Emergency Management Agency, LOMC Clearinghouse, 3601 Eisenhower Avenue, Suite 500, Alexandria, VA 22304-6426.

Patrick "Rick" F. Sacbibit, P.E., Branch Chief Engineering Services Branch Federal Insurance and Mitigation Administration



Federal Emergency Management Agency

Washington, D.C. 20472

LETTER OF MAP REVISION FLOODWAY DETERMINATION DOCUMENT (REMOVAL)

ATTACHMENT 1 (ADDITIONAL CONSIDERATIONS)

20.68 feet; thence North 09°42'22" East 16.12 feet; thence North 09°58'16" West 9.36 feet; thence North 24°02'01" East 7.55 feet; thence North 12°28'05" East 21.55 feet; thence North 24°28'48" East 14.47 feet; thence North 31°39'21" East 11.25 to the northerly line of said Lot 2; thence along said northerly line, North 81°22'07" East 156.85 feet to the Point of Beginning

INADVERTENT INCLUSION IN THE FLOODWAY 1 (PORTIONS OF THE PROPERTY REMAIN IN THE FLOODWAY) (This Additional Consideration applies to the preceding 1 Property.)

A portion of this property is located within the National Flood Insurance Program (NFIP) regulatory floodway for the flooding source indicated on the Determination Document, while the subject of this determination is not. The NFIP regulatory floodway is the area that must remain unobstructed in order to prevent unacceptable increases in base flood elevations. Therefore, no construction may take place in an NFIP regulatory floodway that may cause an increase in the base flood elevation, and any future construction or substantial improvement on the property remains subject to Federal, State/Commonwealth, and local regulations for floodplain management. The NFIP regulatory floodway is provided to the community as a tool to regulate floodplain development. Therefore, the NFIP regulatory floodway modification described in the Determination Document, while acceptable to the Federal Emergency Management Agency (FEMA), must also be acceptable to the community and adopted by appropriate community action, as specified in Paragraph 60.3(d) of the NFIP regulations. Any proposed revision to the NFIP regulatory floodway must be submitted to FEMA by community officials. The community should contact either the Regional Director (for those communities in Regions I-IV, and VI-X), or the Regional Engineer (for those communities in Region V) for guidance on the data which must be submitted for a revision to the NFIP regulatory floodway. Contact information for each regional office can be obtained by calling the FEMA Mapping and Insurance eXchange toll free at (877) 336-2627 (877-FEMA MAP) or from our web site at http://www.fema.gov/about/regoff.htm.

PORTIONS OF THE PROPERTY REMAIN IN THE SFHA (This Additional Consideration applies to the preceding 1 Property.)

Portions of this property, but not the subject of the Determination/Comment document, may remain in the Special Flood Hazard Area. Therefore, any future construction or substantial improvement on the property remains subject to Federal, State/Commonwealth, and local regulations for floodplain management.

STATE AND LOCAL CONSIDERATIONS (This Additional Consideration applies to all properties in the LOMR-FW DETERMINATION DOCUMENT (REMOVAL))

Please note that this document does not override or supersede any State or local procedural or substantive provisions which may apply to floodplain management requirements associated with amendments to State or local floodplain zoning ordinances, maps, or State or local procedures adopted under the National Flood Insurance Program.

This attachment provides additional information regarding this request. If you have any questions about this attachment, please contact the FEMA Mapping and Insurance eXchange (FMIX) toll free at (877) 336-2627 (877-FEMA MAP) or by letter addressed to the Federal Emergency Management Agency, LOMC Clearinghouse, 3601 Eisenhower Avenue, Suite 500, Alexandria, VA 22304-6426.

Patrick "Rick" F. Sacbibit, P.E., Branch Chief Engineering Services Branch

Federal Insurance and Mitigation Administration

Attachment H: Traffic Impact Analysis Memorandum



1130 SW Morrison St., Suite 318 Portland, OR 97205 503.248.0313 lancastermobley.com

Memorandum

To:

City of Salem

Copy:

Trent Michels, FUND

AKS Engineering & Forestry, LLC

From:

Jennifer Danziger, PE

Date:

July 24, 2024

Subject: The Cannery Transportation Impact Analysis – Addendum 1

Trip Generation Update

Digitally Signed **OREGON**

RENEWS: 12/31/2025

Introduction

A Transportation Impact Analysis (TIA)¹ was prepared for The Cannery, a proposed mixed-use development located at 1105 Front Street NE in Salem, Oregon. The project consists of three new 6-story residential buildings with ground floor retail and three repurposed buildings. Since the TIA was finalized, some minor changes to the plans have increased the multifamily housing proposed on the site from 371 units to 382 units; the proposal for the three repurposed buildings on the site will remain unchanged.

This memorandum presents an update of the trip generation calculations and concludes that the change in the number of proposed apartments will not affect the conclusions of the TIA.

Trip Generation

Under the current proposal, 382 apartments are proposed in three new 6-story buildings with ground floor commercial space. The three repurposed buildings will house a mix of commercial uses that include a food hall, eating/drinking establishments, event space, a winery, and small business incubator and vendor spaces. These buildings will also include covered outdoor spaces and a flexible plaza space.

The trip generation estimates have been updated using the same assumptions and procedures described in the TIA. The updated estimates are summarized in Table 1; detailed calculations are attached to this memorandum. Note that because of the greater number residential trips, the potential for internal trips between residential and commercial development on the site will go up, which results in some small change to the number of external trips for other site uses as well.

¹ Lancaster Mobley, The Cannery Transportation Impact Analysis, June 3, 2024.

Table 1: Trip Generation Summary – Proposed Development

ITE Code	Intoncity	Morning Peak Hour		Evening Peak Hour			Daily	
ITE Code	Intensity	ln	Out	Total	ln	Out	Total	Trips
221 - Multifamily	382 DU	32	109	141	91	58	149	1,734
Housing (Mid-Rise)	Internal Trips	-3	-16	-19	-25	-18	-43	-368
712 - Small Office	5.885 KSF	8	2	10	4	9	13	84
Building	Internal Trips	-1	-1	-2	-4	-2	-6	-28
	12.160 KSF	17	12	29	40	40	80	662
822 - Strip Retail Plaza (<40k)	Internal Trips	-2	-3	-5	-26	-23	-49	-260
1 1020 (1 1010)	Pass-by Trips	-1	-1	-2	-3	-3	-6	-60
	8 Carts	5	5	10	25	24	49	492
926 - Food Cart Pods	Internal Trips	-1	-1	-2	-5	-8	-13	-109
r ous	Pass-by Trips	0	0	0	-4	-4	-8	-76
932 - High-	12.926 KSF	68	56	124	71	46	117	1,386
Turnover (Sit-Down)	Internal Trips	-17	-3	-20	-13	-20	-33	-307
Restaurant	Pass-by Trips	-5	-5	-10	-8	-8	-16	-162
970 - Wine Tasting	2.925 KSF	4	2	6	11	10	21	134
Room	Internal Trips	0	0	0	0	0	0	0
OZE Dainking Dlags	4.309 KSF	0	0	0	32	17	49	490
975 - Drinking Place	Internal Trips	0	0	0	-6	-8	-14	-108
Total T	rips	134	186	320	274	204	478	4,982
Internal	Trips	-24	-24	-48	-79	-79	-158	-1,180
Total Exter	Total External Trips		162	272	195	125	320	3,802
Pass-by/Dive	erted Trips	-6	-6	-12	-15	-15	-30	-298
Total Prima	ary Trips	104	156	260	180	110	290	3,504

Notes:

For the updated proposal, total external trip generation was estimated at 272 morning peak hour, 320 evening peak hour, and 3,802 daily trips. After deducting pass-by traffic, the proposed development is anticipated to generate 260 primary trips during the morning peak hour, 290 primary trips during the evening peak hour, and 3,504 primary trips each weekday.

Table 2 compares the updated trip generation estimates with the estimates presented in Table 5 of the TIA.



^{1.} Internal trips calculated following the procedures in NCHRP 684.

^{2.} Pass-by rates of 10% for morning, 20% for evening, and 15% for daily were applied only to external trips

DU = dwelling units, KSF = 1,000 square feet of floor area

Table 2: Trip Generation Comparison

T. C C T. T.	Mori	Morning Peak Hour		Evening Peak Hour			D 11 T:
Trip Generation Scenario/Trip Type	ln	Out	Total	ln	Out	Total	Daily Trips
TIA	Trip Gene	ration wit	h 371 Apar	tments			
Total Trips	134	182	316	271	203	474	4,932
Internal Trips	-24	-24	-48	-78	-78	-156	-1,168
Total External Trips	110	158	268	193	125	318	3,764
Pass-by/Diverted Trips	-6	-6	-12	-15	-15	-30	-298
Total Primary Trips	104	152	256	178	110	288	3,466
Updated Trip Generation with 382 Apartments							
Total Trips	134	186	320	274	204	478	4,982
Internal Trips	-24	-24	-48	-79	-79	-158	-1,180
Total External Trips	110	162	272	195	125	320	3,802
Pass-by/Diverted Trips	-6	-6	-12	-15	-15	-30	-298
Total Primary Trips	104	156	260	180	110	290	3,504
	ا	Net Differe	ence				
Total Trips	0	4	4	3	1	4	50
Internal Trips	0	0	0	-1	-1	-2	-12
Total External Trips	0	4	4	2	0	2	38
Pass-by/Diverted Trips	0	0	0	0	0	0	0
Total Primary Trips	0	4	4	2	0	2	38

After accounting for internal trips and pass-by trips, the increase from 371 to 382 apartments is estimated to increase the primary trip generation for the proposed development by 4 morning peak hour trips, 2 evening peak hour trips, and 38 daily trips.

Operational Impacts

Table 9 of the TIA showed that all study intersections are projected to operate within standards under all analysis scenarios, except for Market Street NE/Center Access & Front Street NE. Operations on the westbound approach of Market Street NE are anticipated to exceed LOS E during the evening peak hour under 2029 buildout conditions although the approach is not expected to be over capacity.

The additional 11 apartments will have no measurable impact on the TIA conclusions. With an estimated increase of 4 morning peak hour trips, all intersections will continue to operate within standards. With a net increase of only 2 trips during the evening peak hour, no change in operations is anticipated.



Conclusions

The increase from 371 to 382 apartments will result in a nominal change in overall trip generation and will have no measurable impact on the conclusions presented in the TIA.

Attachments: Trip Generation Estimates Internal Trip Calculations





Source: Trip Generation Manual, 11th Edition

Land Use: Multifamily Housing (Mid-Rise)

Land Use Code: 221

Land Use Subcategory: Not Close to Rail Transit

Setting/Location General Urban/Suburban

Variable: Dwelling Units

Trip Type: Vehicle *Formula Type:* Rate

Variable Quantity: 382

AM PEAK HOUR

PM PEAK HOUR

Trip Rate: 0.37

Enter Exit To

	Enter	Exit	Total
Directional Split	23%	77%	
Trip Ends	32	109	141

	Enter	Exit	Total
Directional Split	61%	39%	
Trip Ends	91	58	149

WEEKDAY

SATURDAY

Trip Rate: 4.54

Trip Rate: 4.57

Trip Rate: 0.39

	Enter	Exit	Total
Directional Split	50%	50%	
Trip Ends	867	867	1,734

	Enter	Exit	Total
Directional Split	50%	50%	
Trip Ends	873	873	1,746

Source: Trip Generation Manual, 11th Edition



Source: Trip Generation Manual, 11th Edition

Land Use: Small Office Building

Land Use Code: 712

Land Use Subcategory: All Sites

Setting/Location General Urban/Suburban

Variable: 1000 SF GFA

Trip Type: Vehicle

Formula Type: Rate

Variable Quantity: 5.885

AM PEAK HOUR

Trip Rate: 1.67

	Enter	Exit	Total
Directional Split	82%	18%	
Trip Ends	8	2	10

PM PEAK HOUR

Trip Rate: 2.16

	Enter	Exit	Total
Directional Split	34%	66%	
Trip Ends	4	9	13

WEEKDAY

Trip Rate: 14.39

	Enter	Exit	Total
Directional Split	50%	50%	
Trin Ends	42	42	84

SATURDAY

Trip Rate: 0

	Enter	Exit	Total
Directional Split	50%	50%	
Trip Ends	NA	NA	NA



Source: Trip Generation Manual, 11th Edition

Land Use: Strip Retail Plaza (<40k)

Land Use Code: 822

Land Use Subcategory: All Sites

Setting/Location General Urban/Suburban

Variable: 1000 SF GFA

Trip Type: Vehicle

Formula Type: Rate

Variable Quantity: 12.160

AM PEAK HOUR

Trip Rate: 2.36

	Enter	Exit	Total
Directional Split	60%	40%	
Trip Ends	17	12	29

PM PEAK HOUR

Trip Rate: 6.59

	Enter	Exit	Total
Directional Split	50%	50%	
Trip Ends	40	40	80

WEEKDAY

Trip Rate: 54.45

	Enter	Exit	Total
Directional Split	50%	50%	
Trip Ends	331	331	662

SATURDAY

Trip Rate: 0

	Enter	Exit	Total
Directional Split	50%	50%	
Trip Ends	NA	NA	NA



TRIP GENERATION CALCULATIONS Source: Trip Generation Manual, 11th Edition

Land Use: Food Cart Pods

Land Use Code: 926

Land Use Subcategory: All Sites

Setting/Location General Urban/Suburban

Variable: Food Carts Trip Type: Vehicle

Formula Type: Rate

Variable Quantity: 8

AM PEAK HOUR

Trip Rate: 1.232

	Enter	Exit	Total
Directional Split	50%	50%	
Trip Ends	5	5	10

^{*} Assumes AM is 20% of PM.

WEEKDAY

Trip Rate: 61.6

	Enter	Exit	Total
Directional Split	50%	50%	
Trip Ends	246	246	492

^{*} Assumes Daily is 10 x PM.

PM PEAK HOUR

Trip Rate: 6.16

	Enter	Exit	Total
Directional Split	50%	50%	
Trip Ends	25	24	49

SATURDAY

Trip Rate: 0

	Enter	Exit	Total
Directional Split	50%	50%	
Trip Ends	NA	NA	NA



Source: Trip Generation Manual, 11th Edition

Land Use: High-Turnover (Sit-Down) Restaurant

Land Use Code: 932

Land Use Subcategory: All Sites

Setting/Location General Urban/Suburban

Variable: 1000 SF GFA

Trip Type: Vehicle

Formula Type: Rate

Variable Quantity: 12.926

AM PEAK HOUR

Trip Rate: 9.57

	Enter	Exit	Total
Directional Split	55%	45%	
Trip Ends	68	56	124

PM PEAK HOUR

Trip Rate: 9.05

	Enter	Exit	Total
Directional Split	61%	39%	
Trip Ends	71	46	117

WEEKDAY

Trip Rate: 107.2

	Enter	Exit	Total
Directional Split	50%	50%	
Trip Ends	693	693	1,386

SATURDAY

Trip Rate: 122.4

	Enter	Exit	Total
Directional Split	50%	50%	
Trip Ends	791	791	1,582



Source: Trip Generation Manual, 11th Edition

Land Use: Wine Tasting Room

Land Use Code: 970

Land Use Subcategory: All Sites

Setting/Location General Urban/Suburban

Variable: 1000 SF GFA

Trip Type: Vehicle

Formula Type: Rate

Variable Quantity: 2.925

AM PEAK HOUR

Trip Rate: 2.07

	Enter	Exit	Total
Directional Split	70%	30%	
Trip Ends	4	2	6

PM PEAK HOUR

Trip Rate: 7.31

	Enter	Exit	Total
Directional Split	50%	50%	
Trip Ends	11	10	21

WEEKDAY

Trip Rate: 45.96

	Enter	Exit	Total
Directional Split	50%	50%	
Trip Ends	67	67	134

SATURDAY

Trip Rate: 203.48

	Enter	Exit	Total
Directional Split	50%	50%	
Trip Ends	298	298	596



TRIP GENERATION CALCULATIONS Source: Trip Generation Manual, 11th Edition

Land Use: Drinking Place

Land Use Code: 975

Land Use Subcategory: All Sites

Setting/Location General Urban/Suburban

Variable: 1000 SF GFA

Trip Type: Vehicle

Formula Type: Rate Variable Quantity: 4.309

AM PEAK HOUR

Trip Rate: 0

	Enter	Exit	Total
Directional Split	0%	0%	
Trip Ends	0	0	0

PM PEAK HOUR

Trip Rate: 11.36

_	Enter	Exit	Total
Directional Split	66%	34%	
Trip Ends	32	17	49

SATURDAY

Trip Rate: 0

WEEKDAY

Trip Rate: 113.6

	Enter	Exit	Total
Directional Split	50%	50%	
Trip Ends	245	245	490

EnterExitTotalDirectional Split50%50%Trip EndsNANANA

^{*} Assumes Daily is 10 x PM.

	NCHRP 8-51 Internal Trip Capture Estimation Tool							
Project Name:	Lancaster Mobley							
Project Location:	Salem, OR		Performed By:	JED				
Scenario Description:			Date:					
Analysis Year:			Checked By:					
Analysis Period:	AM Street Peak Hour		Date:					

	Table 1-	A: Base Vehicle	-Trip Generation	Estima	tes (Single-Use	Site Estimate)	
	Developme	ent Data (<i>For Info</i>	ormation Only)		Estimated Vehicle-Trips		
Land Use	ITE LUCs ¹	Quantity	Units		Total	Entering	Exiting
Office					10	8	2
Retail					29	17	12
Restaurant					134	73	61
Cinema/Entertainment					0		
Residential					141	32	109
Hotel					0		
All Other Land Uses ²					0		
Total					314	130	184

Table 2-A: Mode Split and Vehicle Occupancy Estimates								
Landilla		Entering Tri	ps			Exiting Trips		
Land Use	Veh. Occ.	% Transit	% Non-Motorized		Veh. Occ.	% Transit	% Non-Motorized	
Office	1.00	0%	0%		1.00	0%	0%	
Retail	1.00	0%	0%		1.00	0%	0%	
Restaurant	1.00	0%	0%		1.00	0%	0%	
Cinema/Entertainment	1.00	0%	0%		1.00	0%	0%	
Residential	1.00	0%	0%		1.00	0%	0%	
Hotel	1.00	0%	0%		1.00	0%	0%	
All Other Land Uses ²								

Table 3-A: Average Land Use Interchange Distances (Feet Walking Distance)							
0 : : (5)				Destination (To)			
Origin (From)	Office Retail Restaurant Cinema/Entertainment Residential						
Office							
Retail							
Restaurant							
Cinema/Entertainment							
Residential							
Hotel							

Table 4-A: Internal Person-Trip Origin-Destination Matrix*								
Origin (Fram)				Destination (To)				
Origin (From)	Office	Retail	Restaurant	Cinema/Entertainment	Residential	Hotel		
Office		0	1	0	0	0		
Retail	0		2	0	1	0		
Restaurant	1	1		0	2	0		
Cinema/Entertainment	0	0	0		0	0		
Residential	0	1	15	0		0		
Hotel	0	0	0	0	0			

Table 5-A: Computations Summary										
Total Entering Exiting										
All Person-Trips	314	130	184							
Internal Capture Percentage	15%	18%	13%							
External Vehicle-Trips ³	266	106	160							
External Transit-Trips ⁴	0	0	0							
External Non-Motorized Trips ⁴	0	0	0							

Table 6-A: Interna	Table 6-A: Internal Trip Capture Percentages by Land Use										
Land Use	Entering Trips	Exiting Trips									
Office	13%	50%									
Retail	12%	25%									
Restaurant	25%	7%									
Cinema/Entertainment	N/A	N/A									
Residential	9%	15%									
Hotel	N/A	N/A									

¹Land Use Codes (LUCs) from *Trip Generation Informational Report*, published by the Institute of Transportation Engineers.

²Total estimate for all other land uses at mixed-use development site-not subject to internal trip capture computations in this estimator

Wehicle-trips computed using the mode split and vehicle occupancy values provided in Table 2-A

⁴Person-Trips

*Indicates computation that has been rounded to the nearest whole number.

Estimation Tool Developed by the Texas Transportation Institute

Project Name:	The Cannery
Analysis Period:	AM Street Peak Hour

Table 7-A: Conversion of Vehicle-Trip Ends to Person-Trip Ends											
Landllan	Tab	ole 7-A (D): Enter	ing Trips			Table 7-A (O): Exiting Trips	3				
Land Use	Veh. Occ.	Vehicle-Trips	Person-Trips*		Veh. Occ.	Vehicle-Trips	Person-Trips*				
Office	1.00	8	8		1.00	2	2				
Retail	1.00	17	17		1.00	12	12				
Restaurant	1.00	73	73		1.00	61	61				
Cinema/Entertainment	1.00	0	0		1.00	0	0				
Residential	1.00	32	32		1.00	109	109				
Hotel	1.00	0	0		1.00	0	0				

Table 8-A (O): Internal Person-Trip Origin-Destination Matrix (Computed at Origin)												
Origin (From)		Destination (To)										
Origin (From)	Office Retail Restaurant C		Cinema/Entertainment	Residential	Hotel							
Office		1	1	0	0	0						
Retail	3		2	0	2	0						
Restaurant	19	9		0	2	2						
Cinema/Entertainment	0	0	0		0	0						
Residential	2	1	22	0		0						
Hotel	0	0	0	0	0							

Table 8-A (D): Internal Person-Trip Origin-Destination Matrix (Computed at Destination)												
Origin (From)		Destination (To)										
Origin (From)	Office Retail Restaurant (Cinema/Entertainment	Residential	Hotel							
Office		5	17	0	0	0						
Retail	0		37	0	1	0						
Restaurant	1	1		0	2	0						
Cinema/Entertainment	0	0	0		0	0						
Residential	0	3	15	0		0						
Hotel	0	1	4	0	0							

	Table 9-A (D): Internal and External Trips Summary (Entering Trips)											
Destination Land Use		Person-Trip Esti	imates			External Trips by Mode*						
Destination Land Use	Internal	External	Total		Vehicles ¹	Transit ²	Non-Motorized ²					
Office	1	7	8		7	0	0					
Retail	2	15	17		15	0	0					
Restaurant	18	55	73		55	0	0					
Cinema/Entertainment	0	0	0		0	0	0					
Residential	3	29	32		29	0	0					
Hotel	0	0	0		0	0	0					
All Other Land Uses ³	0	0	0		0	0	0					

	Table 9-A (O): Internal and External Trips Summary (Exiting Trips)											
Origin Land Llan	Person-Trip Estimates					External Trips by Mode*						
Origin Land Use	Internal	External	Total		Vehicles ¹	Transit ²	Non-Motorized ²					
Office	1	1	2		1	0	0					
Retail	3	9	12		9	0	0					
Restaurant	4	57	61		57	0	0					
Cinema/Entertainment	0	0	0		0	0	0					
Residential	16	93	109		93	0	0					
Hotel	0	0	0		0	0	0					
All Other Land Uses ³	0	0	0		0	0	0					

¹Vehicle-trips computed using the mode split and vehicle occupancy values provided in Table 2-A

²Person-Trips

³Total estimate for all other land uses at mixed-use development site-not subject to internal trip capture computations in this estimator *Indicates computation that has been rounded to the nearest whole number.

	NCHRP 8-51 Internal Trip Capture Estimation Tool											
Project Name:	Project Name: The Cannery Organization: Lancaster Mobley											
Project Location:	Salem, OR		Performed By:	JED								
Scenario Description:			Date:									
Analysis Year:	Analysis Year: Checked By:											
Analysis Period:	PM Street Peak Hour											

	Table 1-P: Base Vehicle-Trip Generation Estimates (Single-Use Site Estimate)										
Londilloo	Developme	ent Data (<i>For Info</i>	ormation Only)			Estimated Vehicle-Trips					
Land Use	ITE LUCs ¹	Quantity	Units		Total	Entering	Exiting				
Office					13	4	9				
Retail					80	40	40				
Restaurant					215	128	87				
Cinema/Entertainment					0	0	0				
Residential					149	91	58				
Hotel					0	0	0				
All Other Land Uses ²					0	0	0				
Total					457	263	194				

	Table 2-P: Mode Split and Vehicle Occupancy Estimates										
Londillon		Entering Tri	ps			Exiting Trips					
Land Use	Veh. Occ.	% Transit	% Non-Motorized		Veh. Occ.	% Transit	% Non-Motorized				
Office	1.00	0%	0%		1.00	0%	0%				
Retail	1.00	0%	0%		1.00	0%	0%				
Restaurant	1.00	0%	0%		1.00	0%	0%				
Cinema/Entertainment	1.00	0%	0%		1.00	0%	0%				
Residential	1.00	0%	0%		1.00	0%	0%				
Hotel	1.00	0%	0%		1.00	0%	0%				
All Other Land Uses ²											

Table 3-P: Average Land Use Interchange Distances (Feet Walking Distance)											
Origin (From)				Destination (To)							
Origin (From)	Office	Retail	Restaurant	Cinema/Entertainment	Residential	Hotel					
Office											
Retail											
Restaurant											
Cinema/Entertainment											
Residential											
Hotel											

Table 4-P: Internal Person-Trip Origin-Destination Matrix*										
Origin (Fram)		Destination (To)								
Origin (From)	Office	Retail	Restaurant	Cinema/Entertainment	Residential	Hotel				
Office		2	0	0	0	0				
Retail	1		12	0	10	0				
Restaurant	1	20		0	15	0				
Cinema/Entertainment	0	0	0		0	0				
Residential	2	4	12	0		0				
Hotel	0	0	0	0	0					

Table 5-P: Computations Summary									
	Total	Entering	Exiting						
All Person-Trips	457	263	194						
Internal Capture Percentage	35%	30%	41%						
External Vehicle-Trips ³	299	184	115						
External Transit-Trips ⁴	0	0	0						
External Non-Motorized Trips ⁴	0	0	0						

Table 6-P: Internal Trip Capture Percentages by Land Use								
Land Use	Exiting Trips							
Office	100%	22%						
Retail	65%	58%						
Restaurant	19%	41%						
Cinema/Entertainment	N/A	N/A						
Residential	27%	31%						
Hotel	N/A	N/A						

¹Land Use Codes (LUCs) from *Trip Generation Informational Report*, published by the Institute of Transportation Engineers.

²Total estimate for all other land uses at mixed-use development site-not subject to internal trip capture computations in this estimator

Wehicle-trips computed using the mode split and vehicle occupancy values provided in Table 2-P

⁴Person-Trips

*Indicates computation that has been rounded to the nearest whole number.

Estimation Tool Developed by the Texas Transportation Institute

Project Name:	The Cannery
Analysis Period:	PM Street Peak Hour

Table 7-P: Conversion of Vehicle-Trip Ends to Person-Trip Ends									
Land Use	Table	Table 7-P (D): Entering Trips				Table 7-P (O): Exiting Trips			
	Veh. Occ.	Vehicle-Trips	Person-Trips*		Veh. Occ.	Vehicle-Trips	Person-Trips*		
Office	1.00	4	4		1.00	9	9		
Retail	1.00	40	40		1.00	40	40		
Restaurant	1.00	128	128		1.00	87	87		
Cinema/Entertainment	1.00	0	0		1.00	0	0		
Residential	1.00	91	91		1.00	58	58		
Hotel	1.00	0	0		1.00	0	0		

Table 8-P (O): Internal Person-Trip Origin-Destination Matrix (Computed at Origin)									
Origin (From)		Destination (To)							
Origin (From)	Office	Retail	Restaurant	Cinema/Entertainment	Residential	Hotel			
Office		2	0	0	0	0			
Retail	1		12	2	10	2			
Restaurant	3	36		7	16	6			
Cinema/Entertainment	0	0	0		0	0			
Residential	2	24	12	0 2					
Hotel	0	0	0	0	0				

Table 8-P (D): Internal Person-Trip Origin-Destination Matrix (Computed at Destination)								
Origin (From)	Destination (To)							
Origin (From)	Office Retail Restaur		Restaurant	Cinema/Entertainment	Residential	Hotel		
Office		3	3	0	4	0		
Retail	1		37	0	42	0		
Restaurant	1	20		0	15	0		
Cinema/Entertainment	0	2	4		4	0		
Residential	2	4	18	0		0		
Hotel	0	1	6	0	0			

Table 9-P (D): Internal and External Trips Summary (Entering Trips)								
Destination Land Hea	Person-Trip Estimates				External Trips by Mode*			
Destination Land Use	Internal	External	Total		Vehicles ¹	Transit ²	Non-Motorized ²	
Office	4	0	4		0	0	0	
Retail	26	14	40		14	0	0	
Restaurant	24	104	128		104	0	0	
Cinema/Entertainment	0	0	0		0	0	0	
Residential	25	66	91		66	0	0	
Hotel	0	0	0		0	0	0	
All Other Land Uses ³	0	0	0		0	0	0	

Table 9-P (O): Internal and External Trips Summary (Exiting Trips)								
	Person-Trip Estimates				External Trips by Mode*			
Origin Land Use	Internal	External	Total		Vehicles ¹	Transit ²	Non-Motorized ²	
Office	2	7	9		7	0	0	
Retail	23	17	40		17	0	0	
Restaurant	36	51	87		51	0	0	
Cinema/Entertainment	0	0	0		0	0	0	
Residential	18	40	58		40	0	0	
Hotel	0	0	0		0	0	0	
All Other Land Uses ³	0	0	0		0	0	0	

¹Vehicle-trips computed using the mode split and vehicle occupancy values provided in Table 2-P

²Person-Trips

³Total estimate for all other land uses at mixed-use development site-not subject to internal trip capture computations in this estimator

*Indicates computation that has been rounded to the nearest whole number.