Pages from DS Comments_Civil Plans_1105 Front Street NE_24-106451-PLN.pdf Markup Summary

Callout (17)



Subject: Callout

Page Label: [12] P12 PRELIMINARY COMPOSITE UTILITY

PLAN

Author: Kyle Cochran Date: 3/26/2024 6:16:05 AM

Status: Accepted set by LChristian on 4/19/2024 at 10:10:03

ΑM Color: Layer: Space:

Notes 5 and 6 are switched.

AKS: PLANS UPDATED ACCORDINGLY



Subject: Callout

Page Label: [12] P12 PRELIMINARY COMPOSITE UTILITY

PLAN

Author: Kyle Cochran

Date: 4/12/2024 10:03:28 AM

Status: Accepted set by LChristian on 4/19/2024 at 10:10:06

AM Color: Layer: Space:

Fire service is 8", is this supposed to be 8" also to match rather than being 6"?

AKS: PLANS UPDATED ACCORDINGLY



Subject: Callout

Page Label: [12] P12 PRELIMINARY COMPOSITE UTILITY

PLAN

Author: Kyle Cochran Date: 3/26/2024 6:22:59 AM

Status: Accepted set by LChristian on 4/19/2024 at 10:10:10

AMColor: Layer: Space:

Water meters are required to be in ROW (typical all locations)

AKS: PLANS UPDATED BASED ON FOLLOW UP MEETINGS WITH CITY STAFF. EASEMENT **IDENTIFIED FOR METERS THAT** CANNOT FIT WITHIN ROW.



Subject: Callout

Page Label: [12] P12 PRELIMINARY COMPOSITE UTILITY

PLAN

Author: Kyle Cochran Date: 4/12/2024 10:08:23 AM

Status: Accepted set by LChristian on 4/19/2024 at 10:10:15

AM Color: Layer: Space:

A common private sewer line is an option rather than multiple long services to each building. This would require an HOA type agreement for private maintenance of this private line.

AKS: PLANS UPDATED ACCORDINGLY



Subject: Callout

Page Label: [8] P8 PRELIMINARY SITE PLAN

Author: khottmann

Date: 4/19/2024 10:11:35 AM

Status: Accepted set by LChristian on 4/19/2024 at 10:11:37

Color: Layer: Space:

driveways needs to be a standard plan 302

AKS: THIS DRIVEWAY IS IN CITY STANDARDS AND FITS BEST WITH THE ANTICIPATED USE OF THESE **ACCESS POINTS. PLAN 302** UTILIZED FOR BELLMONT ALLEY.



Subject: Callout

Page Label: [13] P13 PRELIMINARY FRONT ST

IMPROVEMENTS Author: khottmann

Date: 3/28/2024 4:32:50 PM

Status: Accepted set by LChristian on 4/19/2024 at 10:11:59

Color: Layer: Space:

Will need ADA ramp for parking space access

AKS: TO BE ADDRESSED WITH FINAL FRONT STREET **DESIGN. COORDINATION** WITH RAILROAD, WISER RAIL, CITY, ETC. NEEDED.



Subject: Callout

Page Label: [10] P10 PRELIMINARY ONSITE GRADING

AND DRAINAGE PLAN

Author: roseh

Date: 4/5/2024 10:49:29 AM

Status: Accepted set by LChristian on 4/19/2024 at 10:12:20

Color: Layer: Space:

RIM and IE different from that reported on P11. Confirm all facility elevations consistent between plan and sections.

AKS: PLANS UPDATED ACCORDINGLY

Subject: Callout

Page Label: [11] P11 PRELIMINARY GRADING AND

DRAINAGE SECTIONS

Author: roseh

Date: 4/5/2024 10:25:34 AM

Status: Accepted set by LChristian on 4/19/2024 at 10:12:25

Color: Layer: Space:

Structural evaluation of these tall facility walls will be necessary.

AKS: STRUCTURAL IS AWARE AND PLANS TO **PROVIDE DETAILS** WITH FINAL DESIGN.



ANTER CROSS-SECTION

Subject: Callout

Page Label: [11] P11 PRELIMINARY GRADING AND

DRAINAGE SECTIONS

Author: roseh

Date: 4/5/2024 10:33:01 AM

Status: Accepted set by LChristian on 4/19/2024 at 10:12:37

AM Color: Layer: Space:

Exceeds depth per detail No. 216

AKS: DESIGN STANDARDS DONT EXPLICITLY LIST 18" MAX PONDING DEPTH. FACILITY IS PRIVATELY OWNED / MAINTAINED. WE RESPECTFULLY REQUEST APPROVAL OF PONDING DEPTHS SHOWN. FALL

PROTECTION IS PROPOSED WHERE

BUILDING CODE WOULD TRIGGER THE NEED

FOR HANDRAILS.



Subject: Callout

Page Label: [11] P11 PRELIMINARY GRADING AND

DRAINAGE SECTIONS

Author: roseh

Date: 4/5/2024 10:33:24 AM

Status: Accepted set by LChristian on 4/19/2024 at 10:12:37

AM Color: Layer: Space:

Exceeds depth per detail No. 216

AKS: DESIGN STANDARDS DONT EXPLICITLY LIST 18" MAX PONDING DEPTH. FACILITY IS PRIVATELY OWNED / MAINTAINED. WE RESPECTFULLY REQUEST APPROVAL OF PONDING DEPTHS SHOWN. FALL PROTECTION IS PROPOSED WHERE **BUILDING CODE WOULD TRIGGER THE NEED**

FOR HANDRAILS.



Subject: Callout

Page Label: [9] P9 PRELIMINARY ONSITE GRADING AND

DRAINAGE PLAN Author: roseh

Date: 4/5/2024 10:36:59 AM

Status: Accepted set by LChristian on 4/19/2024 at 10:12:37

Color: Layer: Space:

Why not slope path to allow for runoff capture and management?

AKS: PLANS REVISED ACCORDINGLY.



Subject: Callout

Page Label: [10] P10 PRELIMINARY ONSITE GRADING

AND DRAINAGE PLAN

Author: roseh

Date: 4/5/2024 10:45:29 AM

Status: Accepted set by LChristian on 4/19/2024 at 10:12:37

Color: Layer: Space:

Clarify pipe size. Outfall shown as 24" pipe

AKS: PLANS REVISED ACCORDINGLY.

SMI, HONOZ CORNE GRUES TO VERY CAST LOANS, A

Subject: Callout

Page Label: [10] P10 PRELIMINARY ONSITE GRADING

AND DRAINAGE PLAN

Author: roseh

Date: 4/5/2024 10:47:43 AM

Status: Accepted set by LChristian on 4/19/2024 at 10:12:37

Color: Layer: Space:

Confirm adequate structure size for connecting pipes.

AKS: CAN BE ADDRESSED WITH FINAL DESIGN

Subject: Callout

Page Label: [8] P8 PRELIMINARY SITE PLAN

Author: tmartin

Date: 4/11/2024 11:59:14 AM

Status: Accepted set by LChristian on 4/19/2024 at 10:13:02

AM Color: Layer: Space: Where to the ends of the multi-use path reconnect to Front Street?

Where are the easements?

AKS: CAN BE ADDRESSED WITH FINAL DESIGN



Subject: Callout

Page Label: [8] P8 PRELIMINARY SITE PLAN

Author: tmartin

Date: 4/19/2024 10:13:20 AM

Status: Accepted set by LChristian on 4/19/2024 at 10:13:23

AM Color: Layer: Space:

Need double arrows for width adjustment. Stop Bar? No entrance signs?

AKS: THIS WILL BE A **PRIMARY PHASE 2 ENTRANCE SO UPDATED** ACCORDINGLY NOW.



Subject: Callout

Page Label: [1] P1 COVER SHEET

Author: LChristian

Color: Layer: Space:


Where does this go? When will it be constructed? Are access easements needed on the plat?

Status: Accepted set by LChristian on 4/19/2024 at 10:14:00 PHASE 2 AND CONNECTED TO CHIESE HASE 2 AND CONNECTED TO SHIPPING STREET WHERE BIKERS WILL BE ABLE TO **GET BACK TO FRONT STREET. INTERMEDIATE CONNETION IS OUT GAINS**

STREET ENTRANCE NORTH OF BUILDING 1.


THE CANNERY

PRELIMINARY LAND USE PLANS

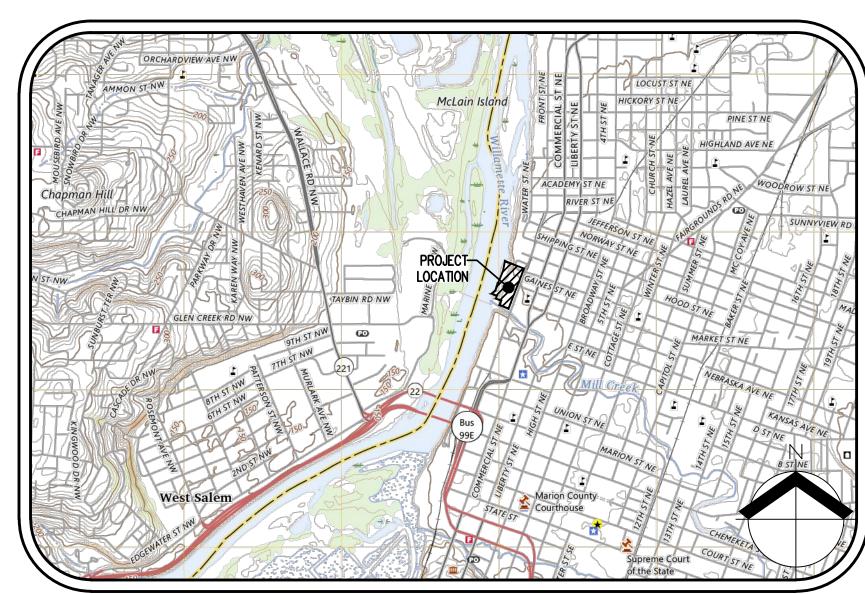

VICINITY MAP NOT TO SCALE

LEGEND <u>PROPOSED</u> **PROPOSED** DECIDUOUS TREE STORM DRAIN CLEAN OUT CONIFEROUS TREE STORM DRAIN MANHOLE FIRE HYDRANT WATER BLOWOFF WATER METER GAS VALVE WATER VALVE DOUBLE CHECK VALVE P AIR RELEASE VALVE SANITARY SEWER CLEAN OUT O POWER PEDESTAL COMMUNICATIONS RISER **EXISTING** <u>PROPOSED</u> RIGHT-OF-WAY LINE **BOUNDARY LINE** PROPERTY LINE CENTERLINE EDGE OF PAVEMENT EASEMENT FENCE LINE GRAVEL EDGE POWER LINE OVERHEAD WIRE COMMUNICATIONS LIN FIBER OPTIC LINE STORM DRAIN LINE SANITARY SEWER LINE WATER LINE RECLAIMED WATER LINE

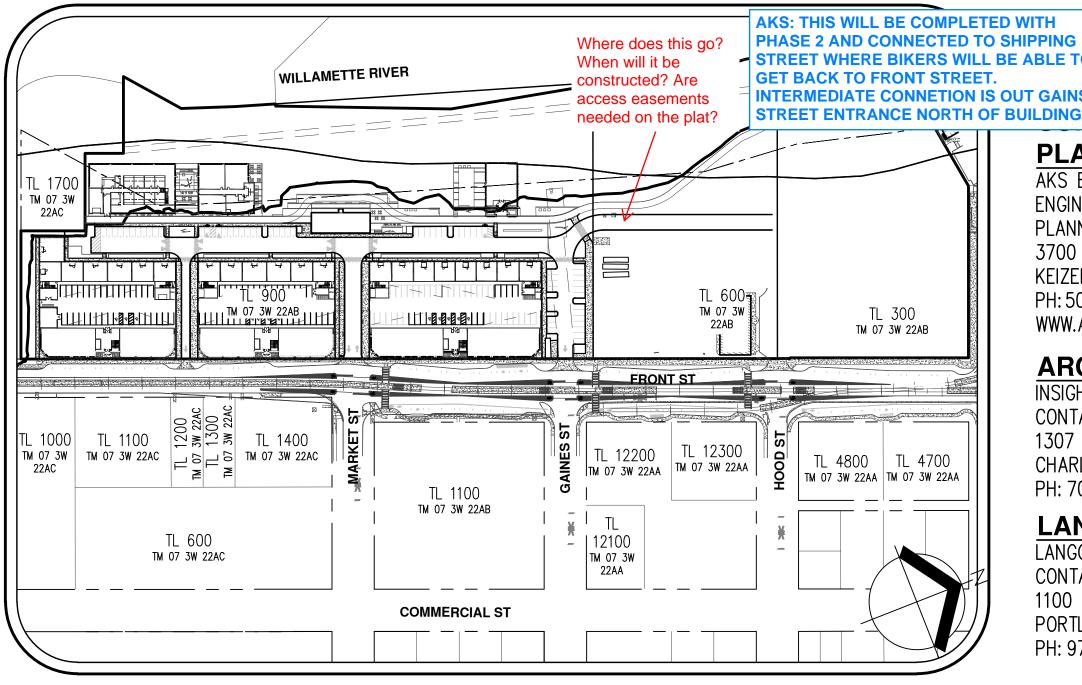

SITE MAP

1" = 150'

PROPERTY DESCRIPTION:

MARION COUNTY TAX MAP 07 3W 22AB, TAX LOTS 300, 600, & 900 CITY OF SALEM, OREGON

PROPERTY LOCATION:

1105 FRONT ST NE,

SALEM, OREGON 97301

VERTICAL DATUM

ELEVATIONS ARE BASED ON CITY OF SALEM BENCHMARK NO. 1151, LOCATED AT THE SE CORNER OF SUMMER AND MARION ST. ELEVATION = 161.617 FEET (NGVD 29).

ENGINEERING/ 'EYING/LAND USE

PLANNING FIRM

AKS ENGINEERING & FORESTRY, LLC
ENGINEERING CONTACT: TYLER ROTH, PE
PLANNING CONTACT: GRACE WOLFF
3700 RIVER RD N, STE 1
KEIZER, OR 97303
PH: 503.400.6028
WWW.AKS-ENG.COM

ARCHITECT

CONTACT: KRISTINA HELD, AIA, LEED AP BD+C, CPHC 1307 WEST MOREHEAD ST, STE 108 CHARLOTTE, NC 28208 PH: 704.344.0445

LANDSCAPE ARCHITECT

LANGO HANSEN LANDSCAPE ARCHITECT CONTACT: KYLE TRULEN, PLA, LEED AP 1100 NW GLISAN #3A, PORTLAND, OR 97209 PH: 971.380.3580

CONTRACT PURCHASER/APPLICANT

Fund CONTACT: TRENT MICHELS 15017 THOMAS RD, CHARLOTTE, NC 28278

GEOTECHNICAL FIRM

CENTRAL GEOTECHNICAL SERVICES, LLC CONTACT: JULIO C. VELA, PHD, PE, GE 10240 SW NIMBUS AVE, STE L6 PORTLAND, OR 97223 PH: 503.994.0755

SHEET INDEX

P1 COVER SHEET

C002 EXISTING CONDITIONS PLAN
C003 EXISTING CONDITIONS PLAN

US EXISTING CONDITIONS

P4 TENTATIVE PLAT

P5 PRELIMINARY ONSITE DEMOLITION PLAN

P6 PRELIMINARY TREE PRESERVATION AND REMOVAL PLAN

7 PRELIMINARY TREE TABLE

8 PRELIMINARY SITE PLAN

P9 PRELIMINARY ONSITE GRADING AND DRAINAGE PLAN


P10 PRELIMINARY ONSITE GRADING AND DRAINAGE PLAN

P11 PRELIMINARY GRADING AND DRAINAGE SECTIONS

P12 PRELIMINARY COMPOSITE UTILITY PLAN

P13 PRELIMINARY FRONT ST IMPROVEMENTS

COVER SHEET
THE CANNERY
Fund
SALEM, OREGON

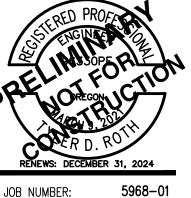


 JOB NUMBER:
 5968-01

 DATE:
 03/15/2024

 DESIGNED BY:
 TDR

 DRAWN BY:
 MJM

 CHECKED BY:
 TDR

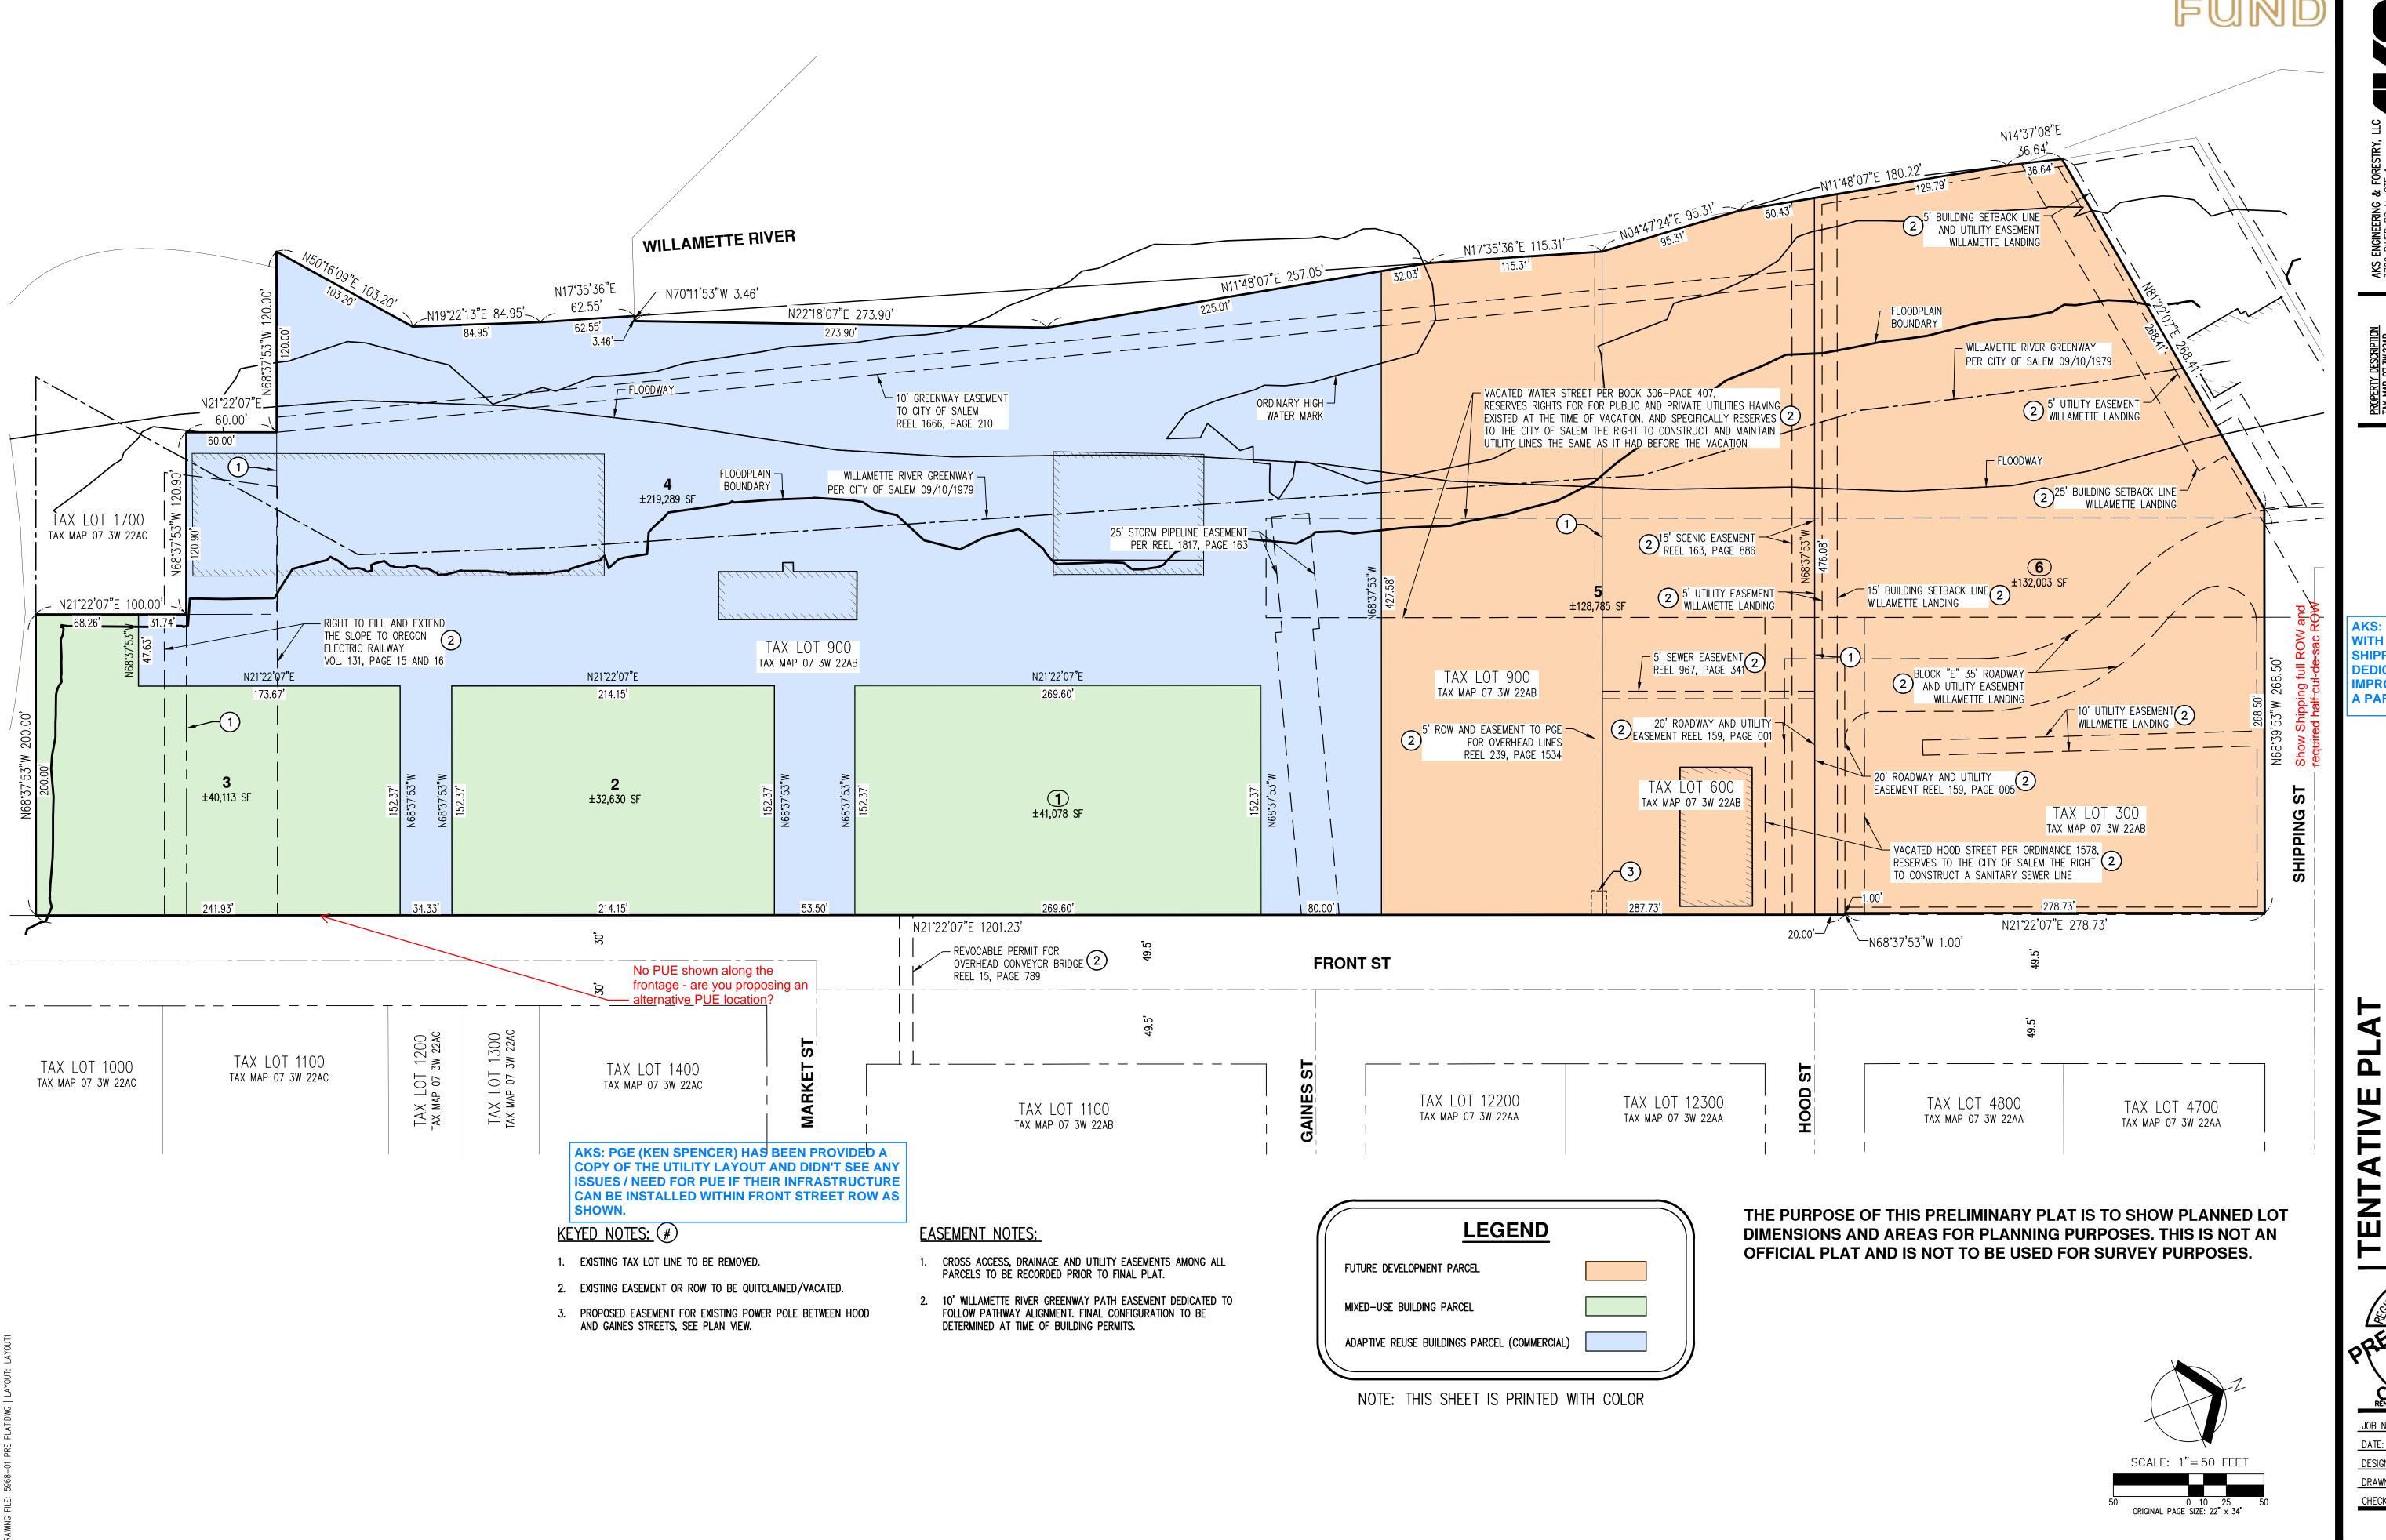

ENGINEERING & FORESTRY, LLC

ER, OR 97303
400.6028


AKS-ENG.COM
AINEERING · SURVEYING · NATURAL RESOURCES

S 300, 600, 900 KEIZE T PURCHASER: 503.4 WWW...

AKS: PER DISCUSSIONS

WITH CITY STAFF
SHIPPING STREET ROW
DEDICATION AND
IMPROVEMENTS TO BE
A PART OF PHASE 2.

TENTATIVE PLAT
THE CANNERY
Fund
SALEM, OREGON

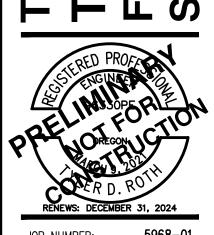


 JOB NUMBER:
 5968-01

 DATE:
 03/15/2024

 DESIGNED BY:
 TDR

 DRAWN BY:
 MJM


 CHECKED BY:
 TDR

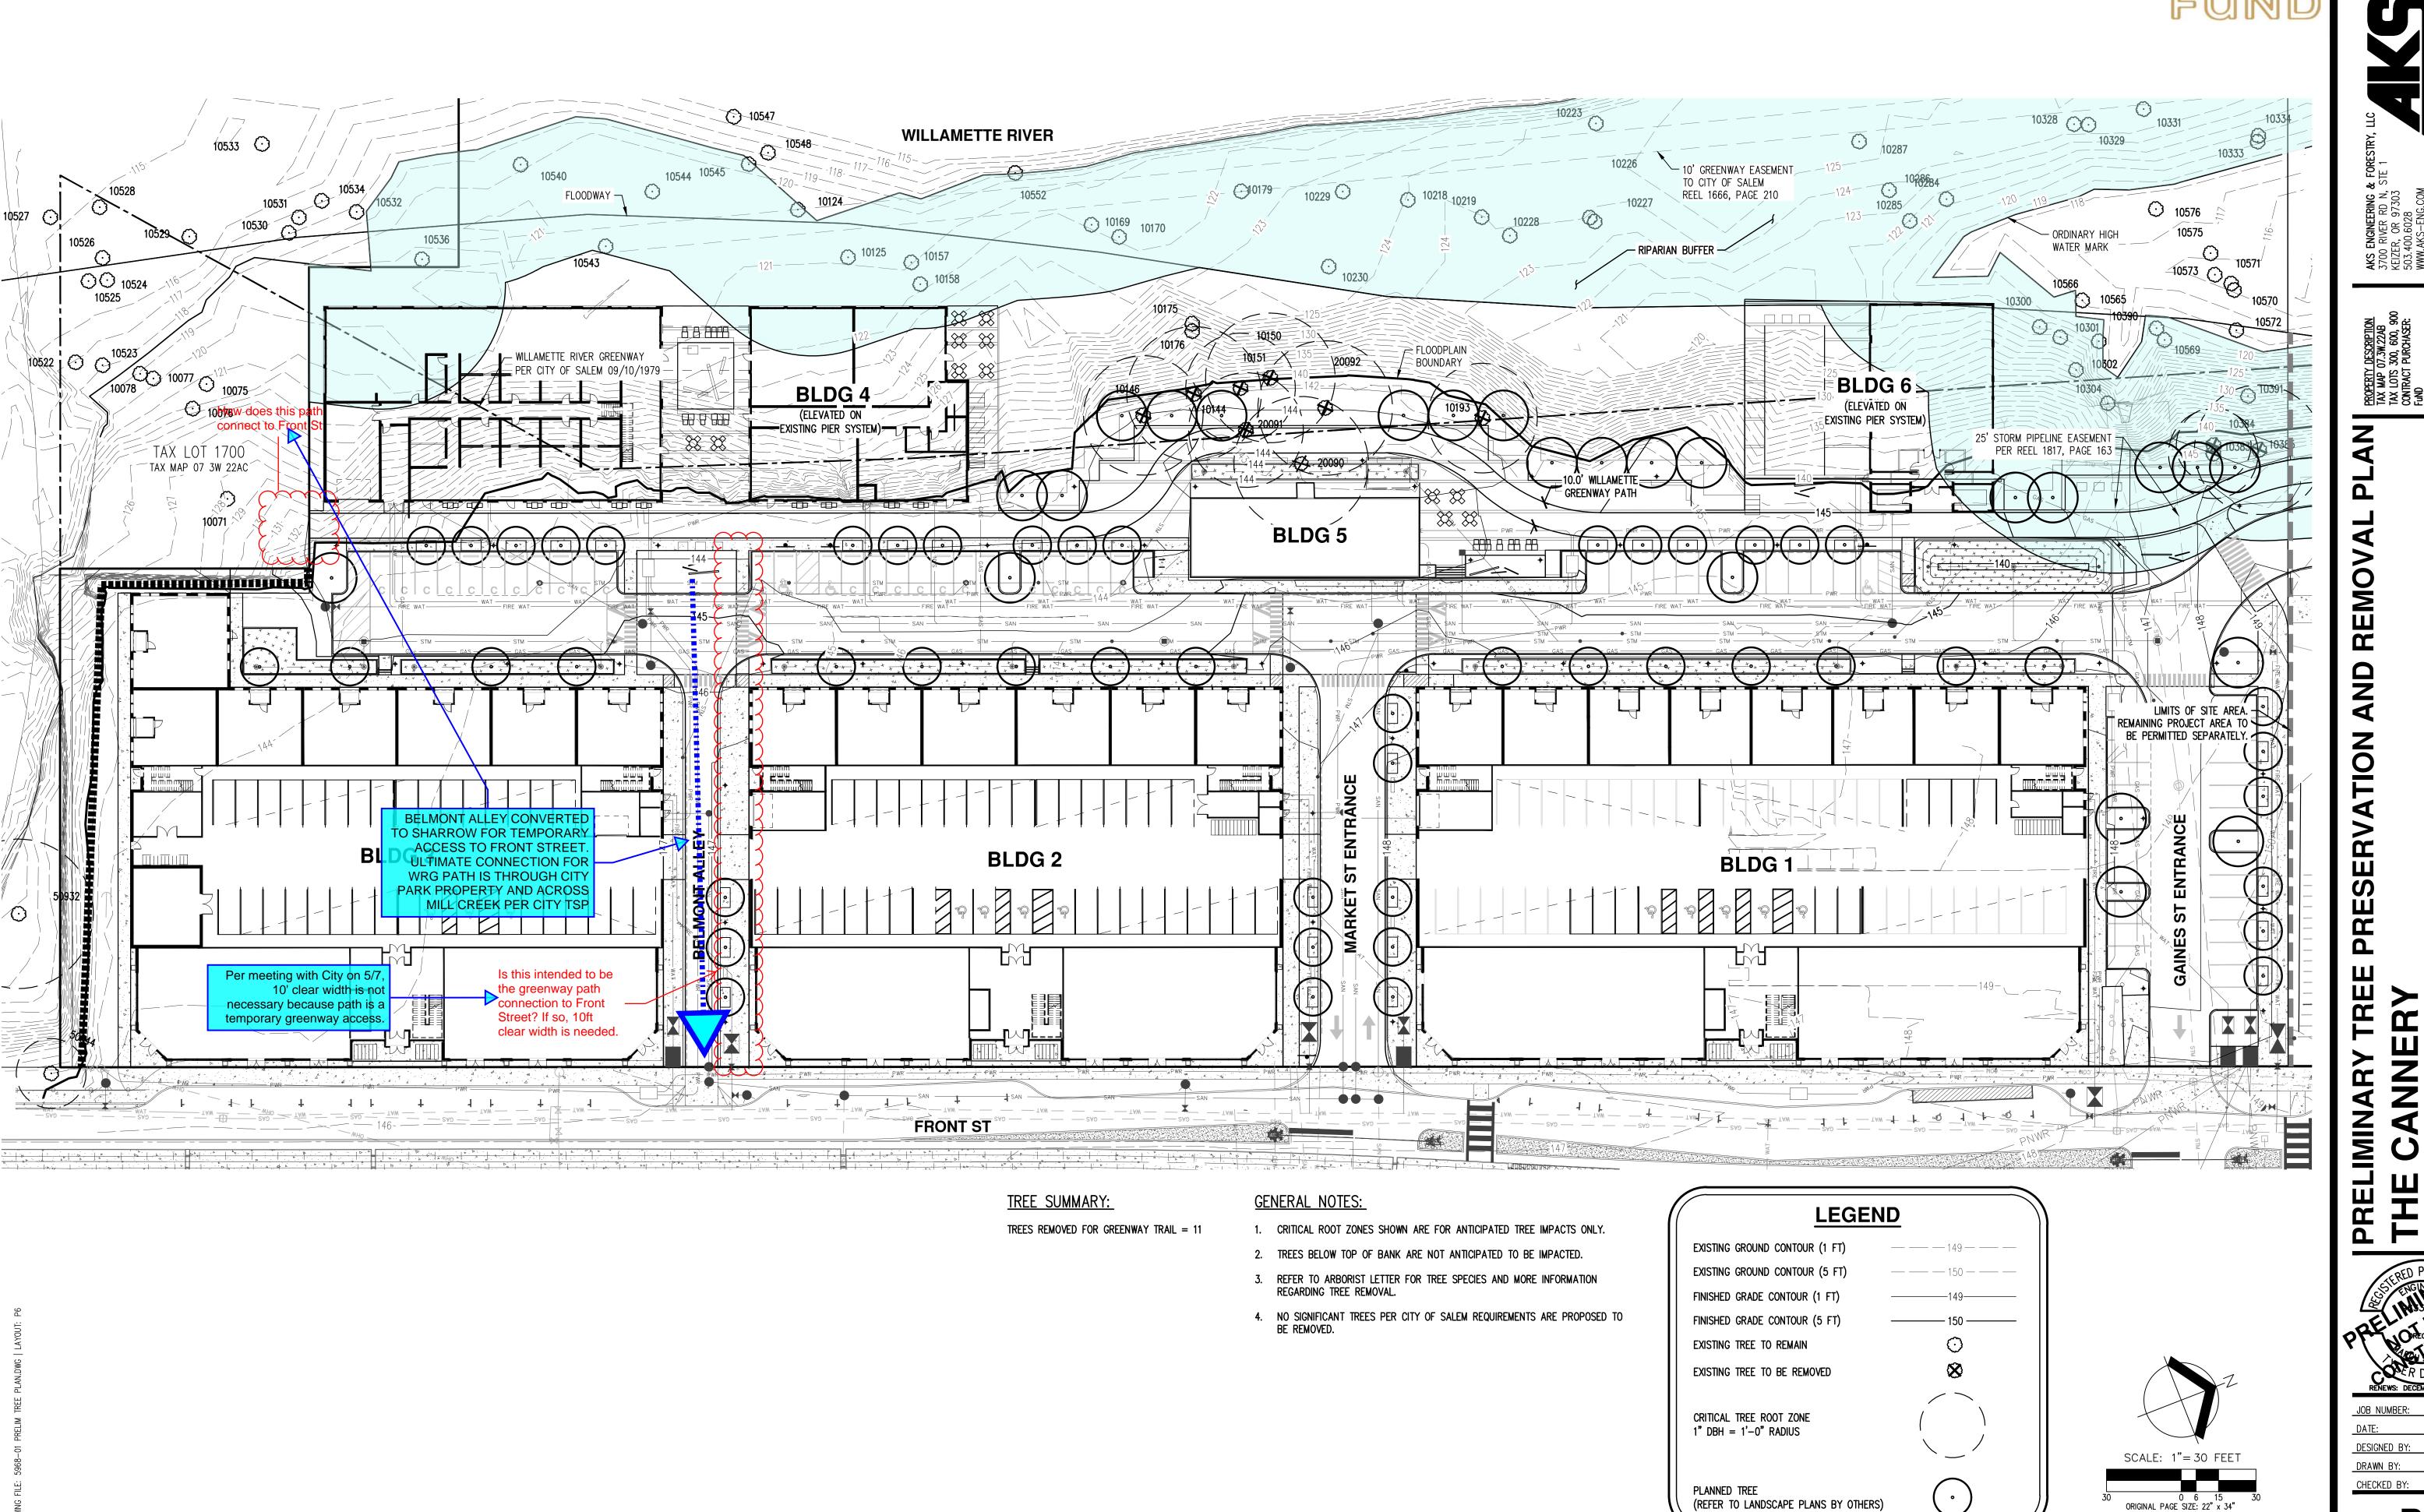


PROPERTY DESCRIPTION
TAX MAP 07.3W.22AB
TAX LOTS 300, 600, 900
CONTRACT PURCHASER:
Fund
15017 THOMAS RD,
CHARLOTTE, NC 28278

PRES TREE ANNERY **PRELIMIN**

JOB NUMBER: 03/15/2024 DESIGNED BY: DRAWN BY:

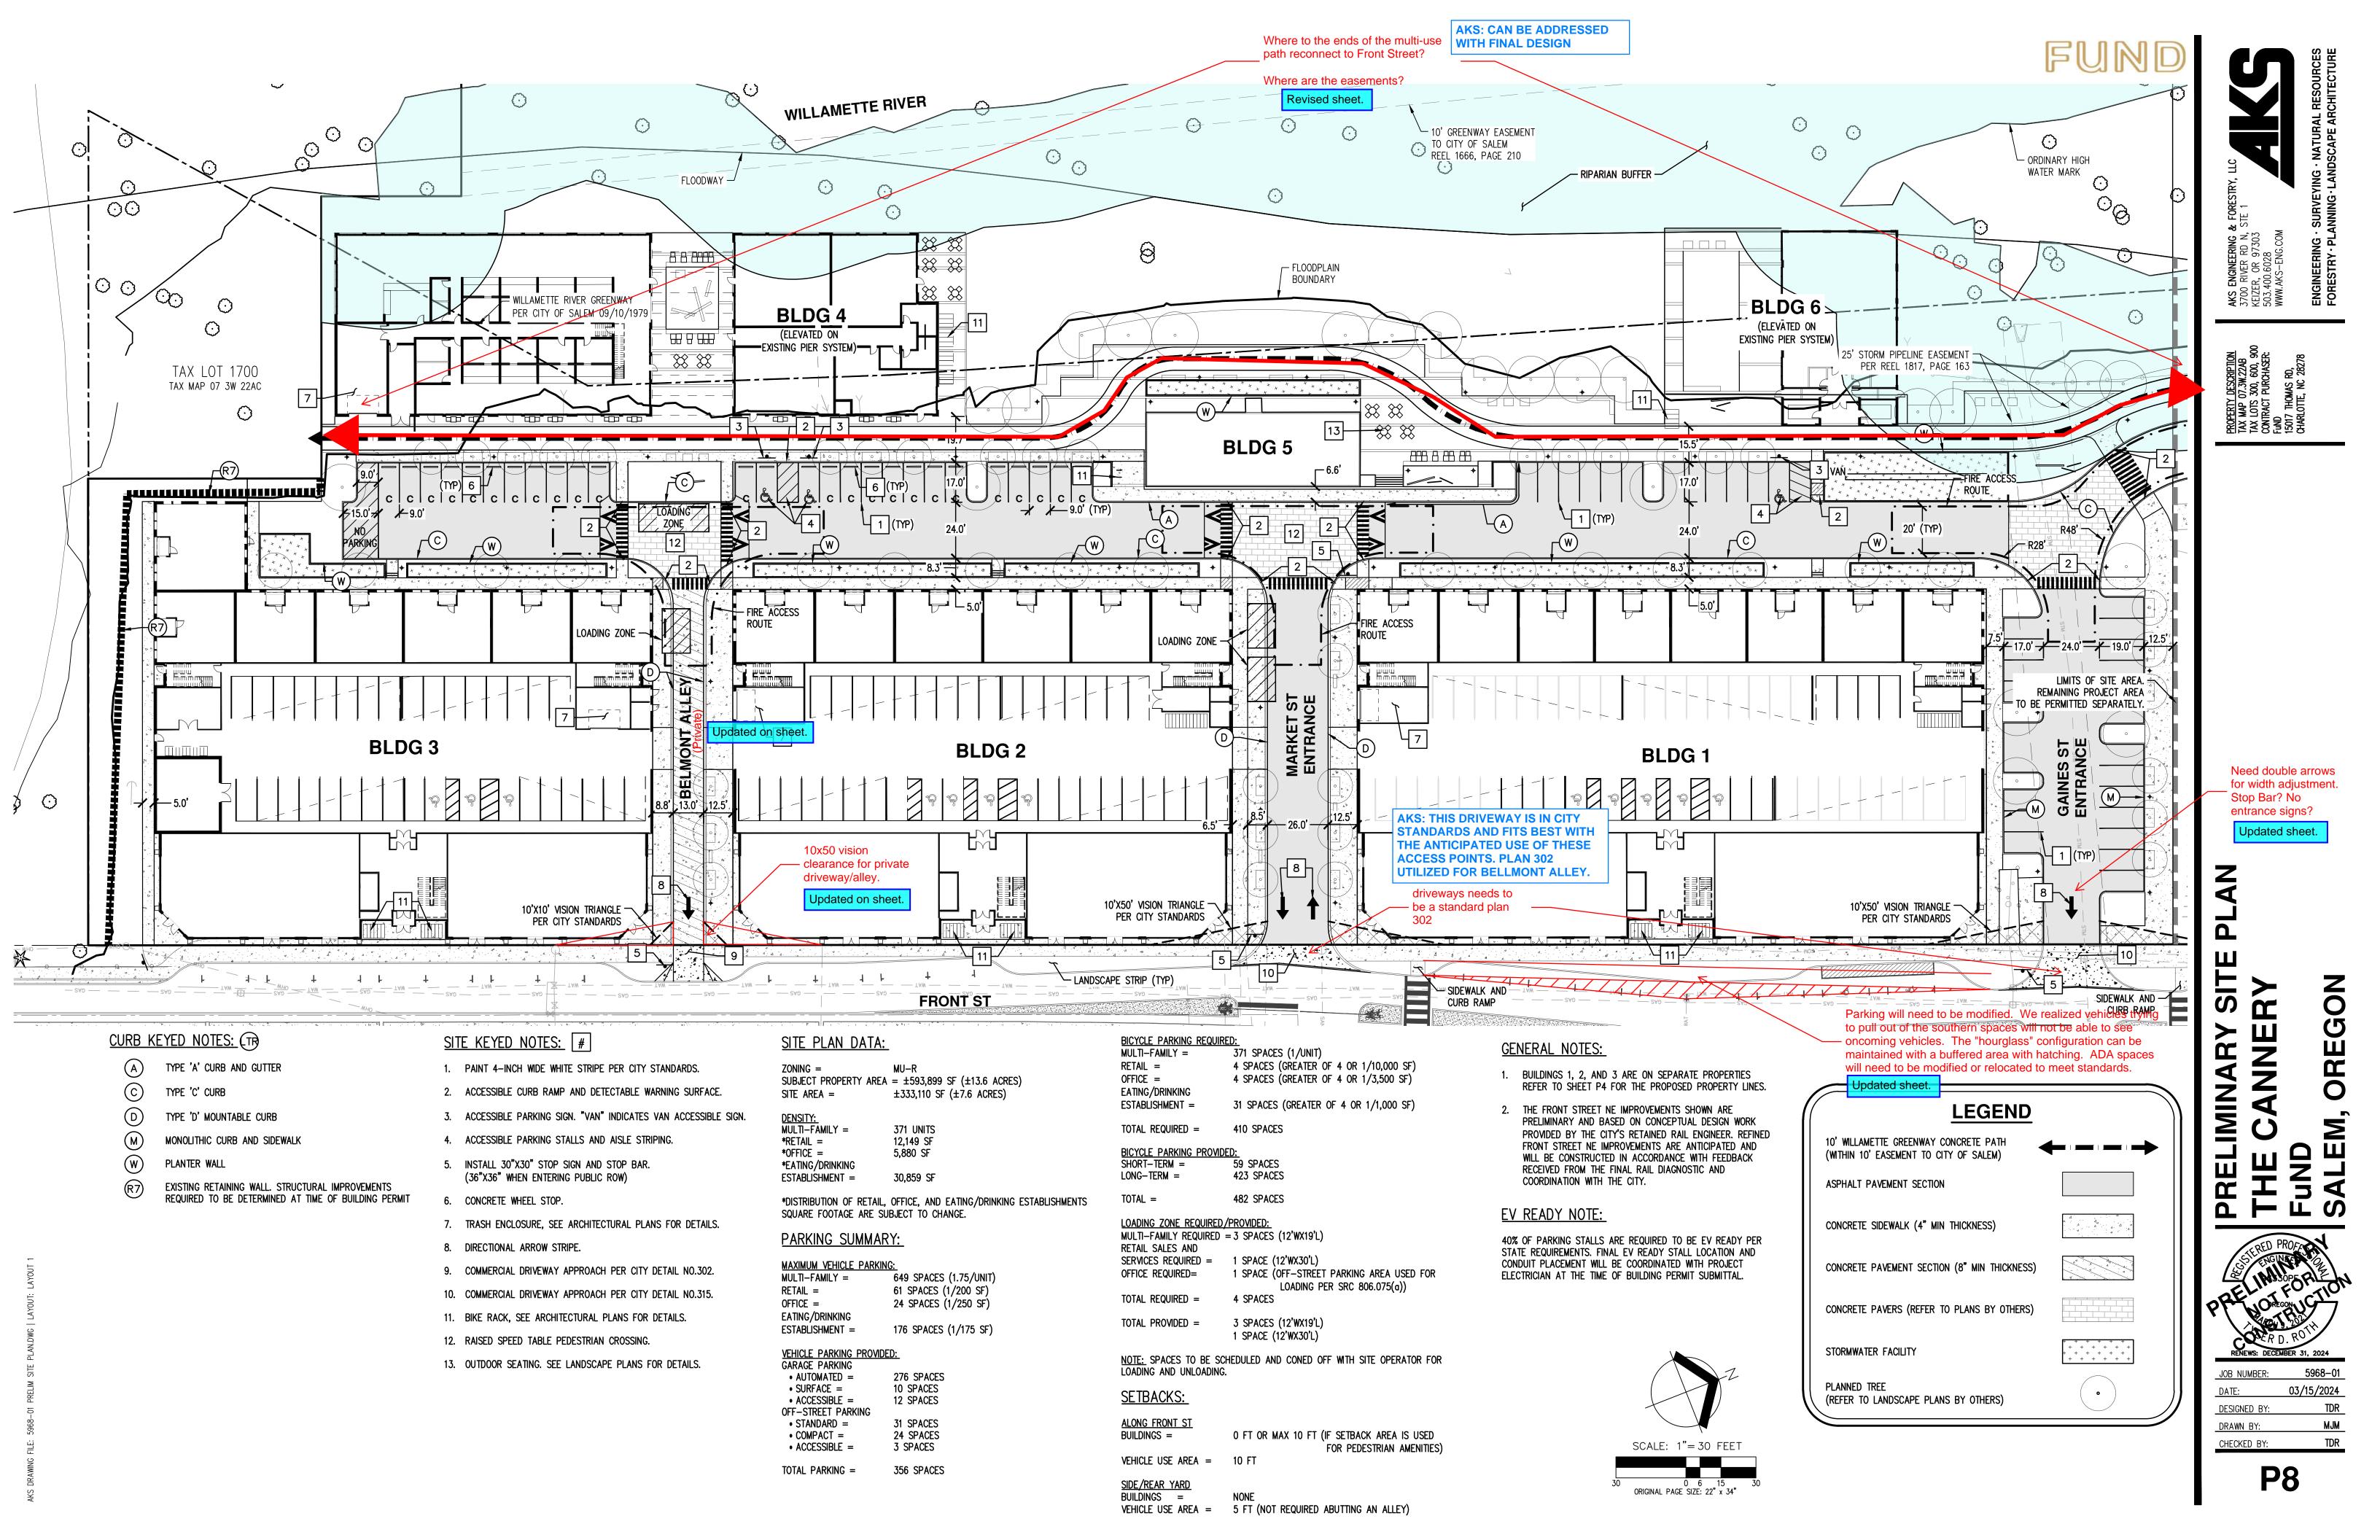

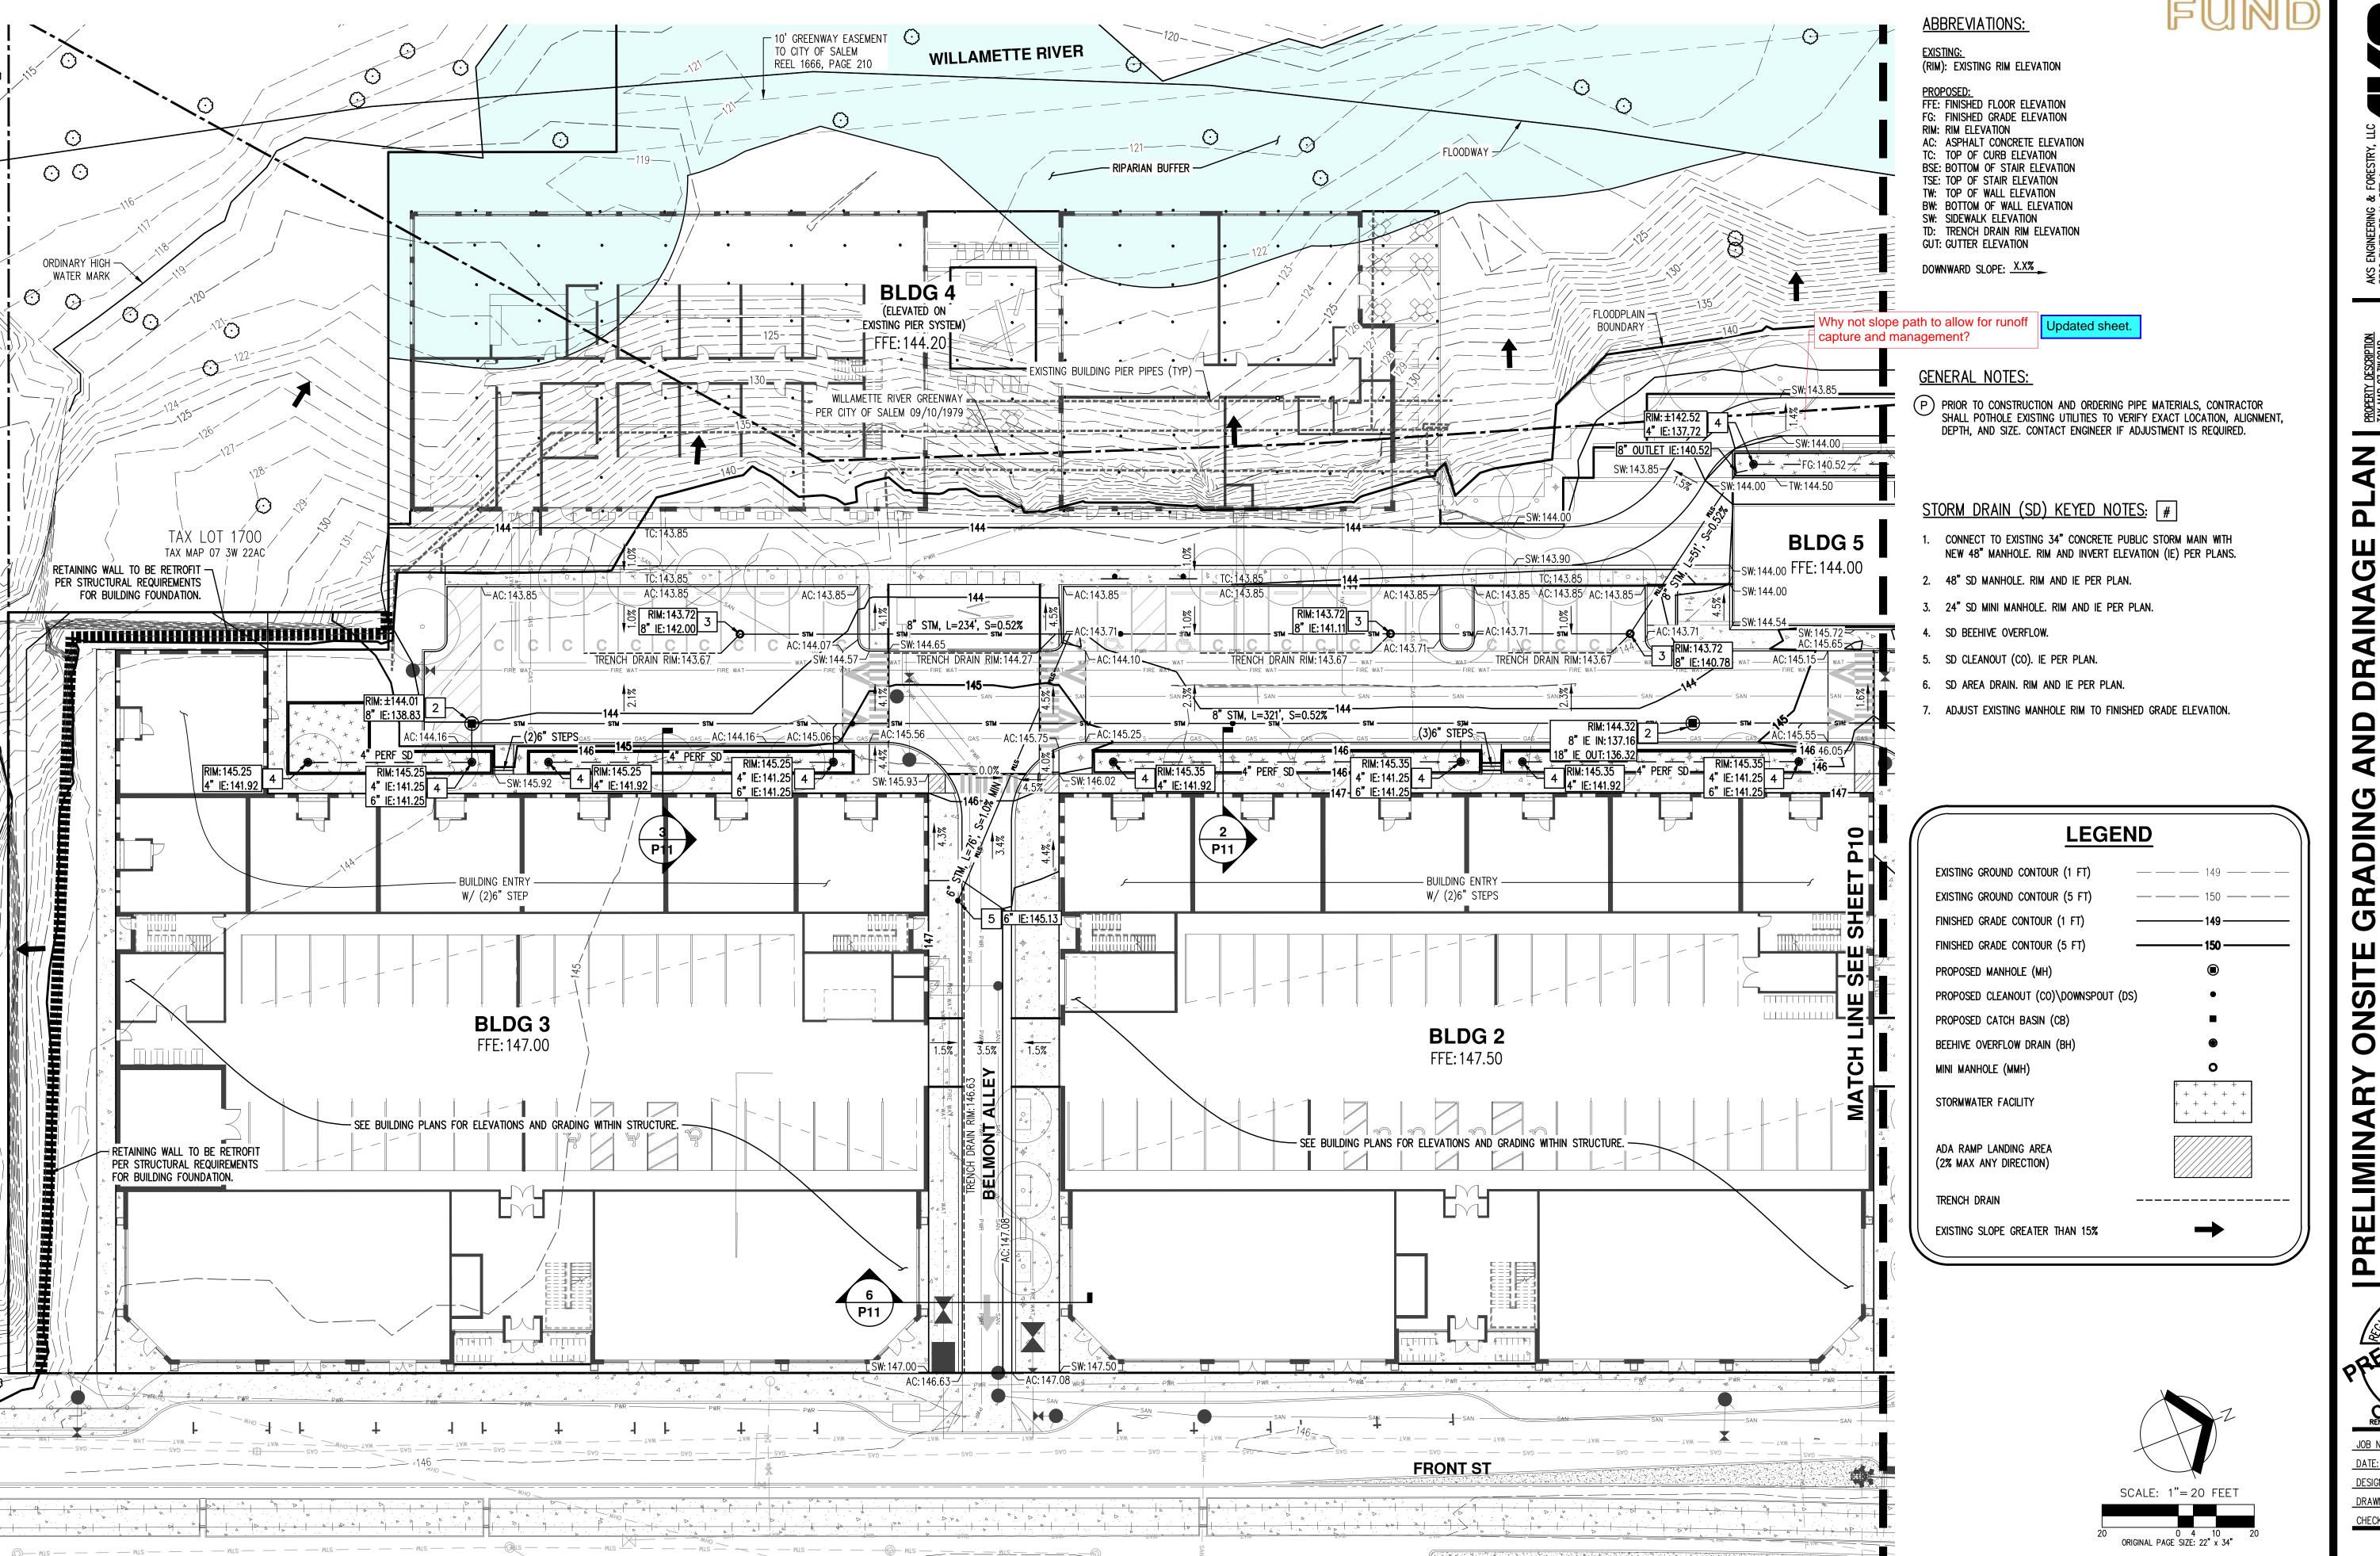

PROPE TAX M TAX L CONTR CONTR FunD 15017

AND DING 4

03/15/2024 DESIGNED BY: DRAWN BY: CHECKED BY:

ABBREVIATIONS:

<u>existing:</u>

(RIM): EXISTING RIM ELEVATION

PROPOSED: FFE: FINISHED FLOOR ELEVATION FG: FINISHED GRADE ELEVATION RIM: RIM ELEVATION

AC: ASPHALT CONCRETE ELEVATION TC: TOP OF CURB ELEVATION BSE: BOTTOM OF STAIR ELEVATION TSE: TOP OF STAIR ELEVATION TW: TOP OF WALL ELEVATION BW: BOTTOM OF WALL ELEVATION

SW: SIDEWALK ELEVATION TD: TRENCH DRAIN RIM ELEVATION **GUT: GUTTER ELEVATION**

DOWNWARD SLOPE: X.X%

GENERAL NOTES:

P PRIOR TO CONSTRUCTION AND ORDERING PIPE MATERIALS, CONTRACTOR SHALL POTHOLE EXISTING UTILITIES TO VERIFY EXACT LOCATION, ALIGNMENT, DEPTH, AND SIZE. CONTACT ENGINEER IF ADJUSTMENT IS REQUIRED.

STORM DRAIN (SD) KEYED NOTES:

1. CONNECT TO EXISTING 34" CONCRETE PUBLIC STORM MAIN WITH NEW 48" MANHOLE. RIM AND INVERT ELEVATION (IE) PER PLANS.

Confirm adequate structure 2. 48" SD MANHOLE. RIM AND IE PER PLAN. size for connecting pipes.

To be confirmed with final design

4. SD BEEHIVE OVERFLOW.


5. SD CLEANOUT (CO). IE PER PLAN.


EXISTING SLOPE GREATER THAN 15%

6. SD AREA DRAIN. RIM AND IE PER PLAN.

7. ADJUST EXISTING MANHOLE RIM TO FINISHED GRADE ELEVATION.

Revised on sheet

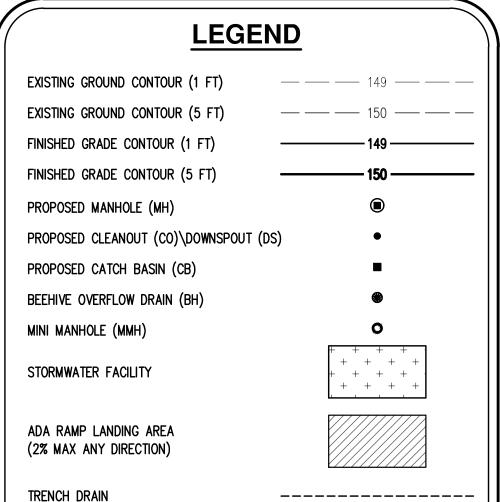

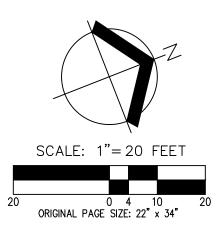



PROP TAX L CONT Fund 15017

A

7

DRAINAGE AND ADING **5** ONSITE CANNERY **PRELIMINARY**

> JOB NUMBER: 03/15/2024 DESIGNED BY: DRAWN BY: CHECKED BY:

AND DRAINAGE

GRADING

CANNERY



EXISTING:
(RIM): EXISTING RIM ELEVATION


ABBREVIATIONS:

PROPOSED:
FFE: FINISHED FLOOR ELEVATION
FG: FINISHED GRADE ELEVATION RIM: RIM ELEVATION AC: ASPHALT CONCRETE ELEVATION
TC: TOP OF CURB ELEVATION BSE: BOTTOM OF STAIR ELEVATION TSE: TOP OF STAIR ELEVATION TW: TOP OF WALL ELEVATION BW: BOTTOM OF WALL ELEVATION SW: SIDEWALK ELEVATION TD: TRENCH DRAIN RIM ELEVATION GUT: GUTTER ELEVATION


DOWNWARD SLOPE: X.X%

For final design, PWDS 2.12 require profiles of stormwater facilities.

Final design item

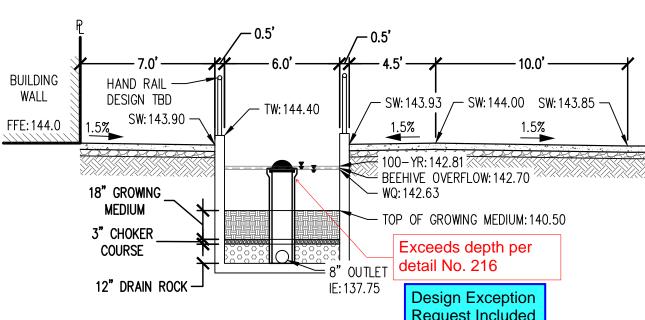

WINERY PLANTER CROSS-SECTION 1" = 5'

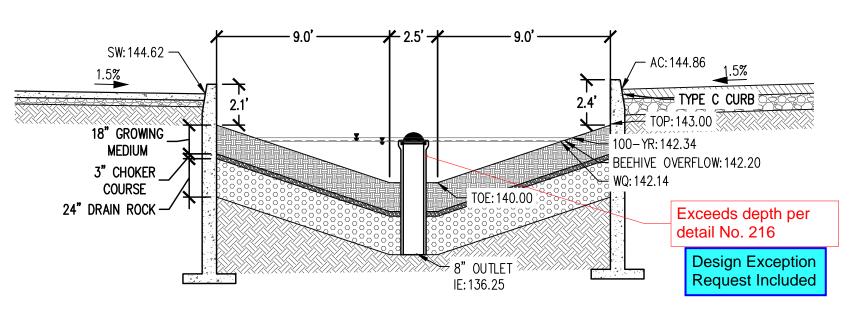

1" = 5'

BUILDING 0.5 0.5 WALL FFE:147.50 (2)6" STEPS ─ TW: 146.92 − SW:146.42 1.5% - 100-YR:145.47 TC: 144.71 -BEEHIVE OVERFLOW: 145.35 [→] WQ:145.27 ` TOP OF GROWING MEDIUM: 144.50 18" GROWING MEDIUM 3" CHOKER COURSE + 12" DRAIN ROCK ─ 6" OUTLET _ A A A

Infiltrating facilities must be set back at least

concrete bottom and/or waterproof liner or

0.5'

1" = 2'

— TW: 147.67

SW: 147.17

- 100–YR:146.69 🤇

- WQ:146.48

 $\stackrel{\wedge}{\Rightarrow}$ BEEHIVE OVERFLOW: 146.55

- TOP OF GROWING MEDIUM: 145.50

BUILDING

WALL

─ SW:147.25

FFE:148.25

(2)6" STEPS

Structural evaluation of

these tall facility walls

Final design item.

will be necessary.

10ft from building foundations. Include

0.5

TW: 147.25 —

COURSE -

12" DRAIN ROCK

BUILDING 1 PLANTER CROSS-SECTION


Final design item. Most likely will

have liner along building footing.


TC: 145.91 -

AC: 145.41 —

BUILDING 2 PLANTER CROSS-SECTION

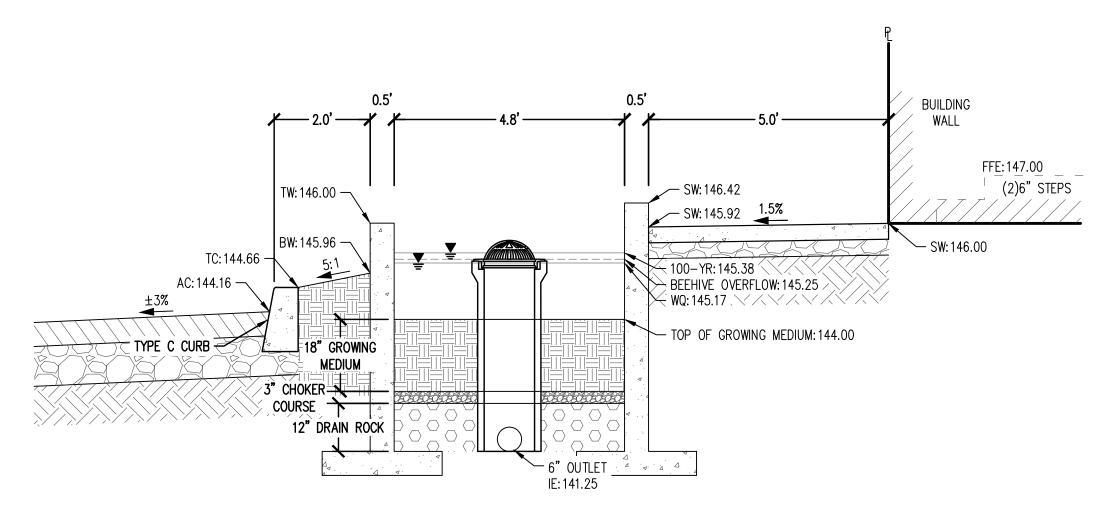


BUILDING 3 PLANTER CROSS-SECTION

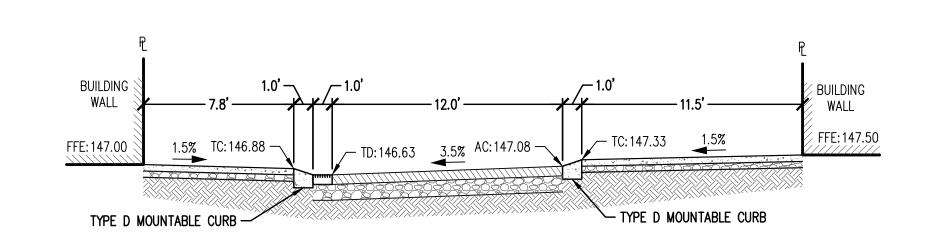


BELMONT ALLEY CROSS-SECTION

RAIN GARDEN CROSS-SECTION

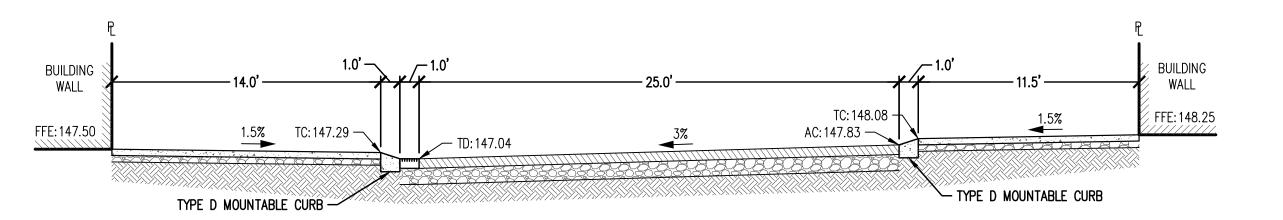


MARKET ST ENTRANCE CROSS-SECTION 1" = 5'

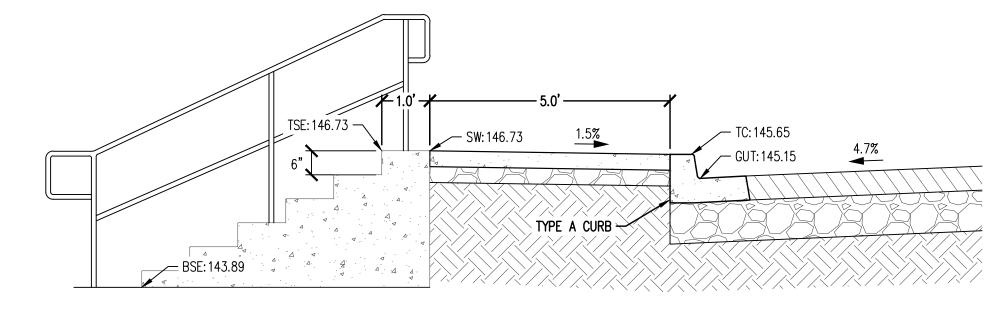

WINERY BUILDING STAIR STEP CONCEPT


OREGON

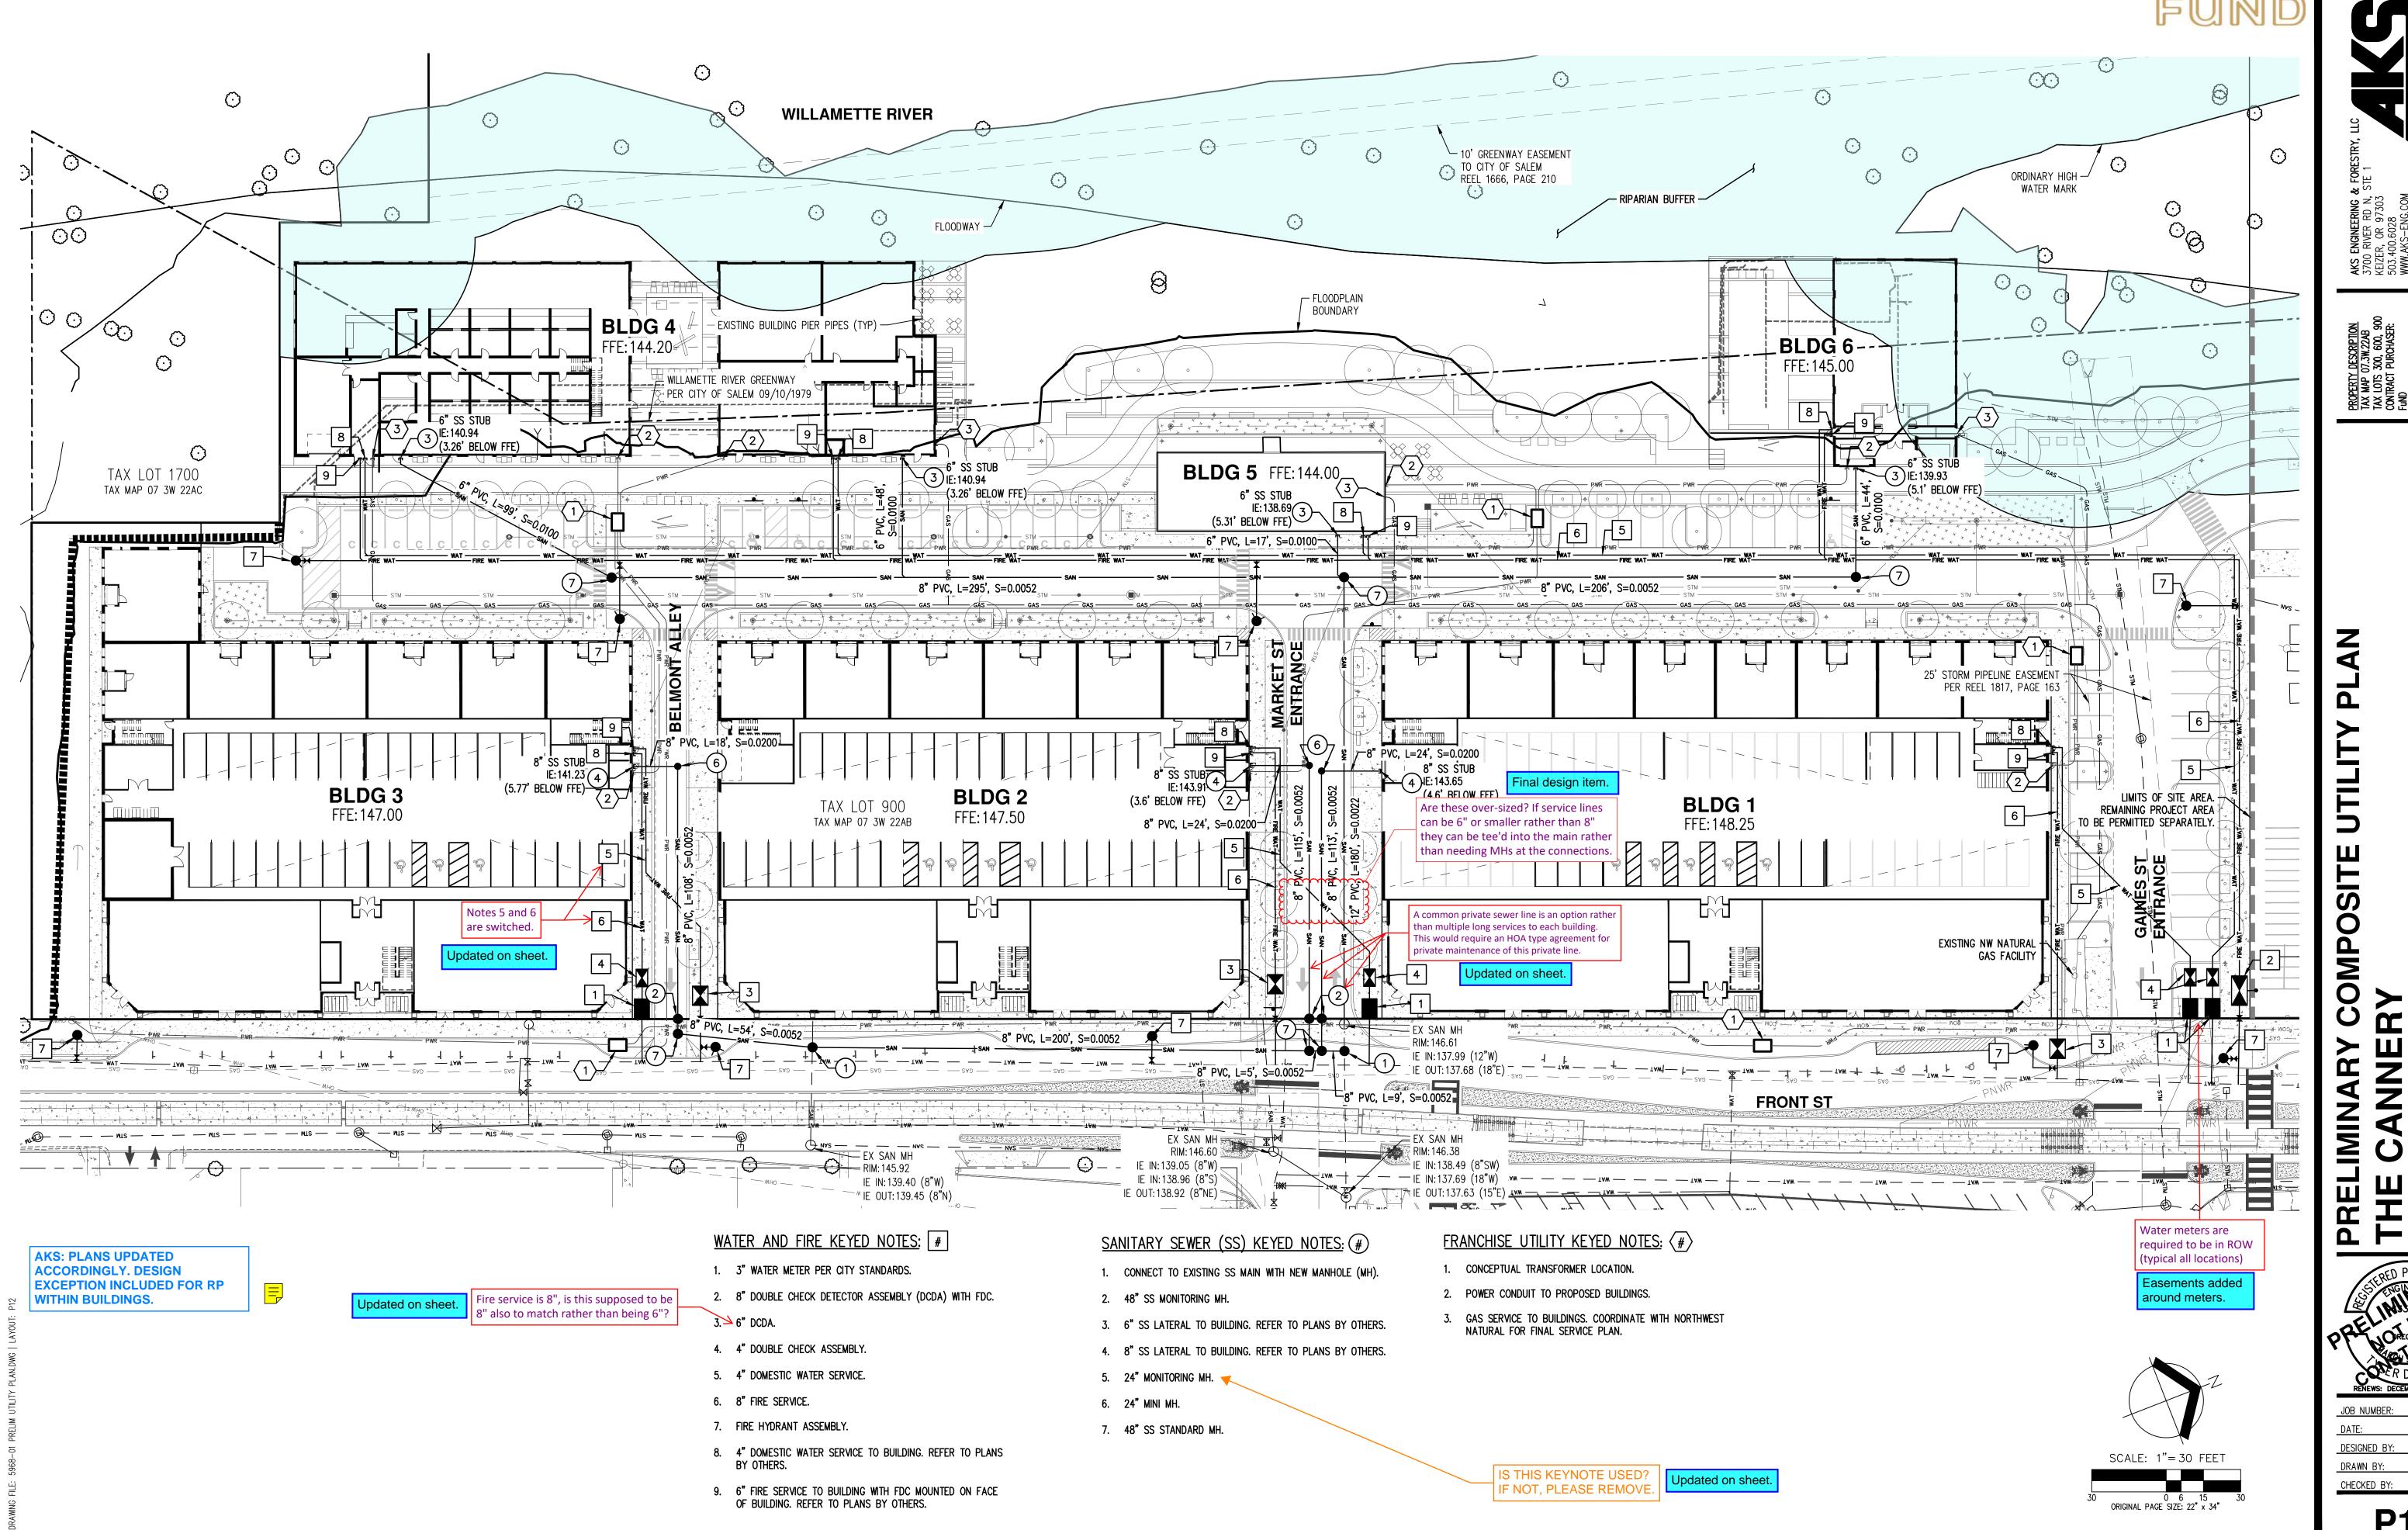

COMPO


03/15/2024


IMPROVEMENTS

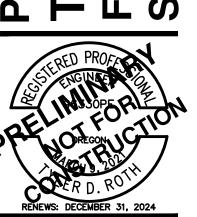

03/15/2024 DESIGNED BY: DRAWN BY: CHECKED BY:

SCALE: 1"= 40 FEET

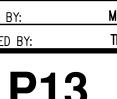

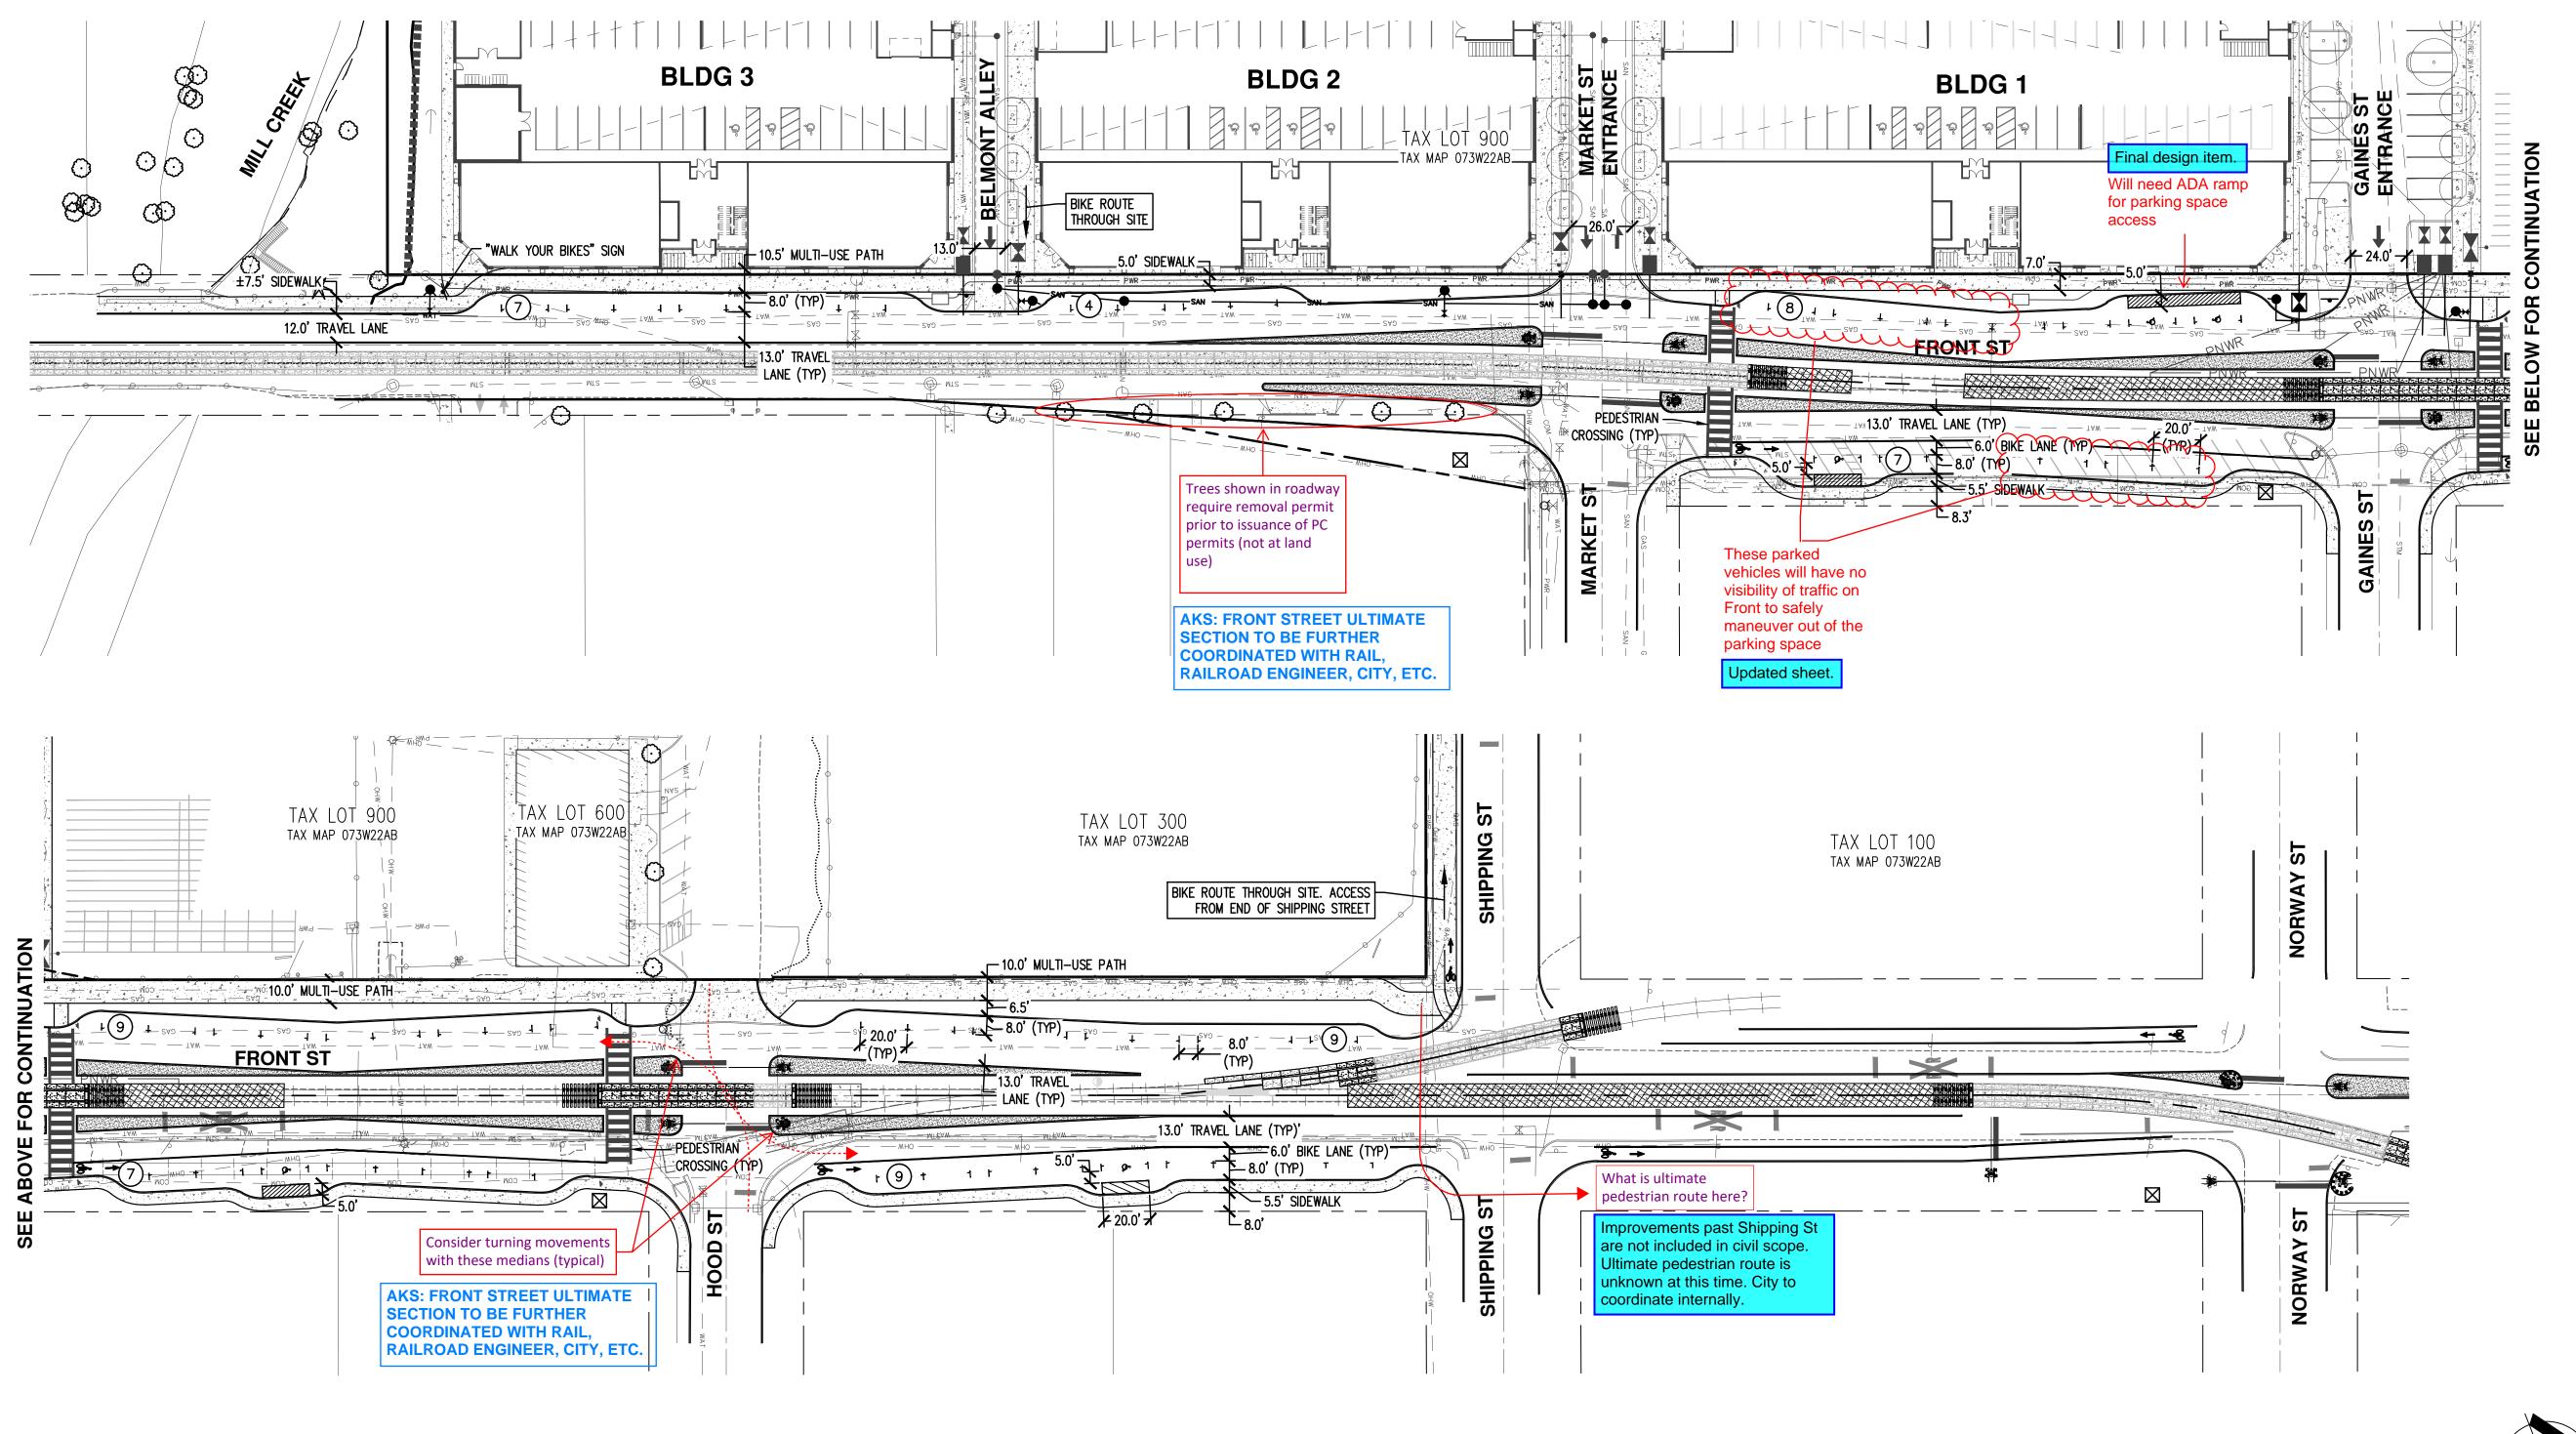

LEGEND:

NUMBER OF PARKING STALLS IN ROW

GENERAL NOTE: PROPOSED FRONT STREET IMPROVEMENTS ARE SUBJECT TO CHANGE BASED ON RAIL AND CITY FEEDBACK. INFORMATION SHOWN IS BASED ON LATEST COORDINATION EFFORTS WITH THE CITY OF SALEM AND RAILROAD ENGINEER.



Subject: Callout

Page Label: [4] P4 TENTATIVE PLAT

Author: LChristian

Date: 4/24/2024 8:22:28 AM

Status: Accepted set by LChristian on 4/24/2024 at 8:22:38

AM Color: Layer: Space:

No PUE shown along the frontage - are you proposing an alternative PUE location?

> AKS: DRY UTILITIES TO BE LOCATED WITHIN STREET **ROW PER UTILITY** PLAN.

Cloud+ (4)



Subject: Cloud+

Page Label: [12] P12 PRELIMINARY COMPOSITE UTILITY

PLAN

Author: Kyle Cochran Date: 4/12/2024 10:05:14 AM

Status: Accepted set by LChristian on 4/19/2024 at 10:10:26

AM Color: Layer: Space:

Are these over-sized? If service lines can be 6" or smaller rather than 8" they can be tee'd into the main rather than needing MHs at the connections.

AKS: FINAL DESIGN ITEM.



Subject: Cloud+

Page Label: [6] P6 PRELIMINARY TREE PRESERVATION

AND REMOVAL PLAN Author: khottmann Date: 3/28/2024 4:14:04 PM

Status: Accepted set by LChristian on 4/19/2024 at 10:11:24

AM Color: Laver: Space:

How does this path connect to Front St

AKS: OUT BELLMONT ALLEY FOR INTERMEDIATE SOLUTION UNTIL CITY **PATHWAY THROUGH CITY PARK IS COMPLETED PER** TSP.



Subject: Cloud+

Page Label: [13] P13 PRELIMINARY FRONT ST

IMPROVEMENTS Author: khottmann

Date: 3/28/2024 4:33:15 PM

Status: Accepted set by LChristian on 4/19/2024 at 10:11:55

Color: Layer: Space:

These parked vehicles will have no visibility of traffic on Front to safely maneuver out of the parking space

AKS: FRONT STREET ULTIMATE SECTION TO BE FURTHER COORDINATED WITH RAIL. RAILROAD ENGINEER, CITY, ETC.



Subject: Cloud+

Page Label: [13] P13 PRELIMINARY FRONT ST

IMPROVEMENTS Author: khottmann

Date: 3/28/2024 4:31:27 PM

Status: Color: Layer: Space:

Group (6)



Subject: Group

Page Label: [13] P13 PRELIMINARY FRONT ST

IMPROVEMENTS Author: Kyle Cochran

Date: 4/19/2024 10:11:00 AM

Status: Accepted set by LChristian on 4/19/2024 at 10:11:02

AM Color: Layer: Space:

Trees shown in roadway require removal permit prior to issuance of PC permits (not at land use)

AKS: FRONT STREET ULTIMATE SECTION TO BE FURTHER COORDINATED WITH RAIL, RAILROAD ENGINEER, CITY, ETC.

Consider turning movements with these medians

SECTION TO BE FURTHER

COORDINATED WITH RAIL,

AKS: FRONT STREET ULTIMATE

RAILROAD ENGINEER, CITY, ETC.

(typical)



Subject: Group

Page Label: [13] P13 PRELIMINARY FRONT ST

IMPROVEMENTS Author: Kyle Cochran Date: 3/26/2024 6:42:01 AM

Status: Accepted set by LChristian on 4/19/2024 at 10:11:10

AM Color: Layer: Space:



Page Label: [13] P13 PRELIMINARY FRONT ST

IMPROVEMENTS Author: Kyle Cochran Date: 3/26/2024 6:52:53 AM

Status: Accepted set by LChristian on 4/19/2024 at 10:11:15

AM Color: Layer: Space:

What is ultimate pedestrian route here?

AKS: FRONT STREET ULTIMATE SECTION TO BE FURTHER COORDINATED WITH RAIL, RAILROAD ENGINEER, CITY, ETC.



Subject: Group

Page Label: [6] P6 PRELIMINARY TREE PRESERVATION

AND REMOVAL PLAN Author: Rob Romanek Date: 4/19/2024 10:12:07 AM

Status: Accepted set by LChristian on 4/19/2024 at 10:12:09

AM Color: Layer: Space:

AKS:PER MEETING WITH CITY STAFF 5/7 10' CLEAR NOT REQUIRED IF INTERMEDIATE SOLUTION UNTIL PATHWAY IS CONSTRUCTED THROUGH CITY PARKS PROPERTY PER TSP. BELLMONT ADJUSTED TO BE A SHARROW FOR BIKERS AND THE PATHWAY CAN THEN BE JUST PEDESTRIAN FOOT TRAFFIC ONLY.



Subject: Group

Page Label: [8] P8 PRELIMINARY SITE PLAN

Author: tmartin

Date: 4/19/2024 10:12:50 AM

Status: Accepted set by LChristian on 4/19/2024 at 10:12:57

Color: Layer: Space:

10x50 vision clearance for private driveway/alley.

AKS: PLANS UPDATED ACCORDINGLY



Subject: Group

Page Label: [8] P8 PRELIMINARY SITE PLAN

Author: tmartin

Date: 4/19/2024 10:13:35 AM

Status: Accepted set by LChristian on 4/19/2024 at 10:13:50

AM
Color: Layer:
Space:

Note (1)



Subject: Note

Page Label: [12] P12 PRELIMINARY COMPOSITE UTILITY

PLAN

Author: sruyle

Date: 3/26/2024 1:19:30 PM

Status: Accepted set by LChristian on 4/19/2024 at 10:11:19

AM
Color: Layer:
Space:

Due to the mixed use an RP Backflow assembly will be required on the domestic water

AKS: PLANS UPDATED
ACCORDINGLY. DESIGN
EXCEPTION INCLUDED FOR RP
WITHIN BUILDINGS.

PolyLine (1)



Subject: PolyLine

Page Label: [8] P8 PRELIMINARY SITE PLAN

Author: tmartin

Date: 4/11/2024 11:57:44 AM

Status: Color: Layer: Space:

q (1)



Subject: q

Page Label: [12] P12 PRELIMINARY COMPOSITE UTILITY

PLĂN

Author: Jerry Casteel Date: 4/12/2024 8:40:41 AM

Status: Accepted set by LChristian on 4/19/2024 at 10:13:55

AM
Color: Layer:
Space:

IS THIS KEYNOTE USED? IF NOT, PLEASE REMOVE.

AKS: PLANS UPDATED ACCORDINGLY

Text Box (4)



Subject: Text Box

Page Label: [8] P8 PRELIMINARY SITE PLAN

Author: LChristian

Date: 3/25/2024 1:56:31 PM

Status: Accepted set by LChristian on 4/19/2024 at 10:09:24

AM
Color: Layer:
Space:

(Private)

AKS: PLANS UPDATED ACCORDINGLY



Subject: Text Box

Page Label: [4] P4 TENTATIVE PLAT

Author: LChristian

Date: 4/19/2024 10:09:40 AM

Status: Accepted set by LChristian on 4/19/2024 at 10:09:43

AM
Color: Layer:
Space:

Show Shipping full ROW and required half cul-de-sac ROW

AKS: PER DISCUSSIONS WITH CITY STAFF SHIPPING STREET ROW DEDICATION AND

IMPROVEMENTS TO BE A PART

OF PHASE 2.



Subject: Text Box

Page Label: [11] P11 PRELIMINARY GRADING AND

DRAINAGE SECTIONS

Author: roseh

Date: 4/5/2024 10:19:37 AM

Status: Accepted set by LChristian on 4/19/2024 at 10:12:28

AM
Color: Layer:
Space:

Infiltrating facilities must be set back at least 10ft from building foundations. Include concrete bottom and/or waterproof liner or increase setback.

AKS: FINAL DESIGN ITEM.
BUILDING FOUNDATION TO
INCLUDE WATERPROOF LINER.



Subject: Text Box

Page Label: [11] P11 PRELIMINARY GRADING AND

DRAINAGE SECTIONS

Author: roseh

Date: 4/5/2024 10:23:07 AM

Status: Accepted set by LChristian on 4/19/2024 at 10:12:32

AM
Color: Layer:
Space:

For final design, PWDS 2.12 require profiles of stormwater facilities.

AKS: TO BE INCLUDED WITH FINAL DESIGN