

## HILFIKER SHOPPING CENTER SALEM,OR - STORE #1865 INTERIOR FINISH OF NEW ULTA STORE

DRINKING FOUNTAIN:

AREA MAP

SERVICE SINK:

SCALE NONE

DESCRIPTION

LEGEND

TAG

REVISION TAG

SYMBOL

ROOM-NAME2

XXX

<u>/#\</u>

OSSC TABLE 2902.1

OSSC TABLE 2902.1

1 REQUIRED

1 REQUIRED

1 PROVIDED

SOUTH GATEWAY

1 PROVIDED (HI-LO)

	BID ALTERNATES	
ITEM	REMARKS	
ELECTRICAL	G.C. TO PROVIDE COST TO ADD (1) ADDITIONAL FLOOR OUTLET, PRIOR TO FINISH FLOOR. COST TO INCLUDE UP TO	
FLOOR OUTLETS	10 LINEAL FEET OF ELECTRICAL TRENCHING.	

RESISTANT

2X4 BLOCKING

G.C. TO PROVIDE COST FOR 2X4 SURFACE MOUNTED BLOCKING FOR L-15 SHELVING IN LIEU OF 3/4" PLYWOOD IN THE STAGING WALL. REFER TO DETAIL 11/A8.3.

SHELVING

SP4 | SPECIFICATIONS

SP5 | SPECIFICATIONS

SP6 | SPECIFICATIONS

SP7 VINYL FLOOR TILE SPECIFICATIONS

MD-1 | MECHANICAL DEMOLITION PLAN

M-1 | MECHANICAL REFLECTED CEILING PLAN

M-2 ENLARGED REFLECTED CEILING PLAN

## SITE MAP

SITE LOCATION: STORE NO. 1865 HILFIKER SHOPPING CENTER 4450 COMMERCIAL ST SE #130 SALEM, OR 97302

PHILLIPS EDISON & COMPANY, INC 3247 SANTA FE ROAD PARK CITY, UT 84098 T: (513) 400-6875 CONTACT: DAVE MURRAY

EMAIL: DMURRAY@PHILLIPSEDISON.COM

TENANT PROJECT MANAGER TALLGRASS CORPORATE CENTER 1000 REMINGTON BLVD., SUITE 120 BOLINGBROOK, IL 60440 T: (415) 797-0128 CONTACT: GRAYSON DAVIS

EMAIL: GDAVIS@2FIVE4.COM

ARCHITECT ROBERT G. LYON AND ASSOCIATES 5100 RIVER ROAD, SUITE 125 SCHILLER PARK, IL 60176 T: (847) 671-7452 F: (847) 671-4200 CONTACT: JOSEPH GEOGHEGAN

PROJECT COORDINATOR RGLA SOLUTIONS, INC. 5100 RIVER ROAD, SUITE 125 SCHILLER PARK, IL 60176 F: (847) 671-4200 CONTACT: LUKE ROMANINI EMAIL: LROMANINI@RGLA.COM

HENDERSON ENGINEERS INC. 8345 LENEXA DRIVE, SUITE 300 LENEXA, KANSAS 66214-695 T: (913) 307 5300 F: (913) 307 5400 WWW.HENDERSONENGINEERS.COM CONTACT: JARED WAGNER

STRUCTURAL ENGINEER WALLACE ENGINEERING STRUCTURAL CONSULTANTS, INC. 1741 MCGEE STREET KANSAS CITY, MO 64108 T: (816) 421-8282 CONTACT: DARCEY SCHUMACHER DARCEY.SCHUMACHER@WALLACE.DESIGN

PROJECT CONTACTS

THE INTENT OF THE SCOPE CONTAINED WITHIN THESE DOCUMENTS RELATES TO THE INTERIOR REMODELING THE ARCHITECT'S SCOPE OF WORK IS STRICTLY LIMITED SOLELY TO THE INTERIOR BUILD-OUT OF AN EXISTING INTERIOR SPACE LOCATED WITHIN AN EXISTING SHELL BUILDING.

SYSTEM. REFER TO ELECTRICAL DRAWINGS FOR

ADDITIONAL INFORMATION.

-   9	SCOPE OF WOR	RK STATE	=MFNT		SCALE
					NONE
A	AREA	FLR.	FLOOR	PT.	PART/ POINT
A.B.	ANCHOR BOLT	F.O.	FRAMED OPENING	P.V.C.	POLY VINYL CHLORIDE
A.C.I.	AMERICAN CONCRETE	F.R.P.	FIBERGLASS REINFORCED	PVMT.	PAVEMENT
	INSTITUTE		PLASTIC	QTY.	QUANTITY
ACOUST.	ACOUSTICAL	FT.	FEET/FOOT	R.A.	RETURN AIR
A.D.A.	AMERICANS WITH	FTG.	FOOTING	R./RAD.	RADIUS
	DISABILITIES ACT	GA.	GAGE/GAUGE	R.D.	ROOF DRAIN
ADH.	ADHESIVE	G.A.	GENERAL CONTRACTOR	RECPT.	RECEPTACLE
ADJ.	ADJACENT	GALV.	GALVANIZED	REINF.	REINFORCING
A.F.F.	ABOVE FINISHED FLOOR	GD.	GRADE	REQ'D.	REQUIRED
AHJ	AUTHORITY HAVING	GL.	GLASS	RM.	ROOM
	JURISDICTION	GYP.	GYPSUM	R.O.	ROUGH OPENING
ALT.	ALTERNATE	H.	HIGH	R.R.	RESTROOM
AL./ALUM.	ALUMINUM	H.C.	HANDICAP ACCESSIBLE	R.T.U.	ROOF TOP UNIT
AMP.	AMPERE	H.C.	HOLLOW CORE	SAN.	SANITARY
ANOD.	ANODIZED	H.D.	HIGH DENSITY	S.C.	SOLID CORE
A.N.S.I	AMERICAN NATIONAL	HDR.	HEADER	SCHD	SCHEDULE
	STANDARDS INSTITUTE	HDW.	HARDWARE	SECT	SECTION
APPROX.	APPROXIMATE	HDWD.	HARDWOOD	SERV.	SERVICE
ARCH.	ARCHITECT	H.M.	HOLLOW METAL	SEV.	SEVER
A.S.T.M	AMERICAN SOCIETY FOR	п.ш. H.P.	HIGH OUTPUT	SF.	STOREFRONT
IVI	TESTING MATERIALS	HORIZ.	HORIZONTAL	SHT.	SHEET
AVC				SHI. SIM.	
AVG.	AVERAGE	H.P.	HIGH POINT		SIMILAR
B/O	BOTTOM OF	H.R.C.	HEATING AND	S.J.	SAWCUT JOINT
BD.	BOARD		REFRIGERATION	SM.	SMALL
BEV.	BEVERAGE		CONTRACTOR(S)	SPECS.	SPECIFICATIONS
BLDG.	BUILDING	HT.	HEIGHT	SPRINK.	SPRINKLERS
B.F.P.	BACKFLOW PREVENTER	H.V.A.C	HEATING, VENTILATION,	SQ.	SQUARE
3LK.	BLACK		AIR CONDITION	SQ. FT.	SQUARE FEET
BLK'G.	BLOCKING	HZ.	HERTZ	S.S., S/S	STAINLESS STEEL
BRG.	BEARING	I.G.	ISOLATED GROUND	STD.	STANDARD
BRKT.	BRACKET	IN.	INCHES	STL.	STEEL
BTM.	BOTTOM	INCL.	INCLUDED	STN.	STATION
BTN.	BETWEEN	INFO.	INFORMATION	STRUCT.	STRUCTURE/-AL
CAB.	CABINET	INSTL.	INSTALLATION/ INSTALLED	SUPPL.	SUPPLY/-IED
C.F.M.	CUBIC FEET PER MINUTE	INSUL.	INSULATION	SUSP	SUSPENDED
C.G.F.	COMPACTED GRANULAR	INT.	INTERIOR	T/O	TOP OF
0.0.1 .	FILL	J-BOX	JUNCTION BOX	TB.	THROUGHBOLT
C.J.	CONTROL JOINT	JST.	JOIST	T&B	TOP AND BOTTOM
C.J. C.L.	CENTER LINE				
		JT.	JOINT	T&G	TONGUE AND GROOVE
CLG.	CEILING	K.S.I.	KIPS PER SQUARE INCH	TEMP.	TEMPERED TEMPERAL
CLOS.	CLOSET	LAM.	LAMINATE	T.G.C.	TENANT GENERAL
CLR.	CLEAR	LAV.	LAVATORY		CONTRACTOR
C.M.U.	CONCRETE	LBF.	POUNDS FORCE	THRU	THROUGH
	MASONRY UNIT	LBS.	POUNDS	TYP.	TYPICAL
CNTR.	COUNTER	L.F.	LINEAL FOOT	U.L.	UNDERWRITERS
CO.	COMPANY	L.G.C.	LANDLORD'S GENERAL		LABORATORIES
COL.	COLUMN		CONTRACTOR	U.N.O.	UNLESS NOTED
CONC.	CONCRETE	L.P.	LOW POINT		OTHERWISE
COND.	CONDUIT	LL	LANDLORD	UV.	ULTRAVIOLET
CONN.	CONNECTION	MA.	MILLIAMPERE	V.	VOLT/ VOLTAGE
CONSTR.	CONSTRUCTION	MATL.	MATERIAL	V.B.	VAPOR BARRIER
CONT.	CONTINUOUS	MAX.	MAXIMUM	V.C.	VOLUME CONTROL
CONTR.	CONTRACTOR	MECH.	MECHANICAL	V.C.T.	VINYL COMPOSITION TILE
CORP.	CORPORATE	MFG./MANUF.	MANUFACTURER	V.I.F.	VERIFY IN FIELD
C.T.	CERAMIC TILE	MIN.	MINIMUM	V.P.	VENT PIPE
C.S.I.	CONSTRUCTION	MISC.	MISCELLANEOUS	VERT.	VERTICAL
	SPECIFICATIONS	MM.	MILLIMETER	W.	WIDE
	INSTITUTE	M.O.	MASONRY OPENING	W/-W/O	WITH/WITHOUT
CU.	CUBIC	M.R.	MOISTURE RESISTANT	W.B.	WALL BASE
CUST	CUSTOMER	MSRY.	MASONRY	W.B.C.	WHITE BOX CONTRACTOR
) <u>.</u>	DEPTH	MTD.	MOUNTED	W.C.	WATER CLOSET
OBL.	DOUBLE	MTL.	METAL NOT APPLICABLE	WD.	WOOD
DEG.	DEGREES	N/A	NOT APPLICABLE	WDW.	WINDOW
DIA.	DIAMETER	N.I.C.	NOT IN CONTRACT	W.H.	WATER HEATER
DIM.	DIMENSION	NOM.	NOMINAL	WK.	WORK
DISC.	DISCONNECT	NO./NUM.	NUMBER	WP.	WATERPROOF
ON.	DOWN	N.T.S.	NOT TO SCALE	WT.	WEIGHT
D.O.	DOOR OPENING	O.A.	OVERALL	W.W.F	WELDED WIRE FABRIC
DR.	DOOR	O.C.	ON CENTER		
DTL.	DETAIL	0.D.	OUTSIDE DIAMETER		
DWG.	DRAWINGS	O.H.	OPPOSITE HAND		
	51011111100	0	5.1.55.1E1881B		

OPTIONAL

OPPOSITE

PLATE

PLYWD.

PERSONAL COMPUTER

PLASTIC LAMINATE

PREPARATION/PREPARED

POUNDS PER

POUNDS PER

SQUARE FOOT

EXTERIOR INSULATION

FINISH SYSTEM

ENGINEER/-ED

FLOOR DRAIN

FOUNDATION

FINISH FIXTURE

EXPANSION/ EXPOSED

ABBREVIATIONS

ELEV./EL.

5.0 L.B.F. (22.2 N) FOR INTERIOR DOORS WITHOUT CLOSURES. DOORS INDICATED AS PART OF THE REQUIRED MEANS OF EGRESS SHALL HAVE HARDWARE WHICH IS READILY OPERABLE FROM THE EGRESS SIDE

WITHOUT THE USE OF A KEY, SPECIAL KNOWLEDGE OR EFFORT. ALL INTERIOR TRIM TO BE CLASS C, FLAME SPREAD 76-200 WITH MAXIMUM SMOKE DEVELOPED OF 450.

D. FLOOR COVERINGS TO HAVE A FLAME SPREAD RATING NOT TO EXCEED 75. ALL COMBUSTIBLE INTERIOR FINISH AND TRIM ITEMS ARE TO BE APPLIED DIRECTLY TO A NON-COMBUSTIBLE BASE. PROVIDE FIRE EXTINGUISHERS AS REQUIRED PER APPLICABLE CODES AND COORDINATE EXACT LOCATION WITH FIRE MARSHAL. PROVIDE AND INSTALL OCCUPANCY SIGN IN A CONSPICUOUS LOCATION IN ACCORDANCE WITH STATE AND LOCAL CODES.

ALL EXTERIOR WORK AND BUILDING SHELL WORK, INCLUDING THE STRUCTURAL INTEGRITY OF EXTERIOR WALLS, AND ROOF, AND ITS ABILITY TO SUPPORT THE TENANTS AWNING AND/OR SIGNAGE OR ANY OTHER ELEMENTS, IS THE RESPONSIBILITY OF THE LANDLORD. ALL OF THE WORK SHALL BE HANDLED UNDER SEPARATE PERMIT AND IS NOT A PART OF THESE PERMIT DRAWINGS. THIS SHALL INCLUDE VERIFICATION OF ANY EXISTING CONDITIONS AND BUILDING STRUCTURE THAT IS A PART OF THE LANDLORD'S WORK AS DESCRIBED IN THE LEASE AGREEMENT BETWEEN ULTA AND

15. SIGNAGE AS SHOWN IN THESE DRAWINGS IS SCHEMATIC ONLY FOR ILLUSTRATION PURPOSES AND DOES NOT IMPLY OR DESCRIBE ANY MEANS, METHODS, OR DETAILS PERTAINING TO INSTALLATION OF THE AWNING OR SIGNAGE. IT SHALL BE SOLELY THE SIGN CONTRACTOR'S RESPONSIBILITY TO DESIGN FABRICATE, AND INSTALL THE SIGN UNDER SEPARATE PERMIT. ANY AND ALL STRUCTURAL CONSIDERATIONS SHALL BE COORDINATED BETWEEN THE SIGNAGE CONTRACTOR, LANDLORD, AND HIS DESIGN PROFESSIONALS. THE AWNING/SIGN CONTRACTOR SHALL SUBMIT SHOP DRAWINGS DESCRIBING THE AWNING/SIGNAGE DESIGN INCLUDING FINISHES. COLORS AND DESIGN DIMENSIONS TO THE OWNER FOR DESIGN INTENT REVIEW ONLY PRIOR TO AWNING/SIGN FABRICATION.

16. SPRINKLER WORK WHERE NEW OR WHERE MODIFICATIONS TO EXISTING SYSTEMS ARE REQUIRED BY CODE OR CONSTRUCTION CONDITIONS SHALL BE SUBMITTED UNDER SEPARATE PERMIT BY A LICENSED SPRINKLER CONTRACTOR. TIE SPRINKLER AND FIRE ALARM INTO BASE BUILDING FIRE

17. G.C. TO INSURE THAT PROPER ENVIRONMENTAL CONDITIONS ARE MET FOR THE INSTALLATION OF ALL INTERIOR FINISHES. 18. REFER TO FIXTURE MANUAL FOR INFORMATION ON ALL FIXTURES. 19. NO ELEMENTS ARE TO BE ATTACHED TO OR SUPPORTED FROM THE ROOF DECK OR BOTTOM CHORD OF ROOF JOISTS. 20. G.C. SHALL NOT USED GAS POWERED CONSTRUCTION EQUIPMENT.

GENERAL NOTES

DESCRIPTION

SECTION TAG-

SEE DWG. AS

DETAIL TAG-

KEY NOTE /

TAG

SYMBOL LEGEND

**ACCESSORIES** 

NAME ELEV: X'-X"

SEE DWG. AS

SYMBOL

DESCRIPTION

**ELEVATION TAG-**

FINISH TAG- SEE

DOOR TAG- SEE

HARDWARE

SCHEDULE

FINISH LEGEND

SEE DWG. AS


NOTED

21. VERIFY ALL EXISTING CONDITIONS PRIOR TO ANY CONSTRUCTION OR FABRICATION. IF DIFFERENT THAN SHOWN, NOTIFY ENGINEER/ARCHITECT IMMEDIATELY FOR MODIFICATION OF DRAWINGS. 22. ALL CONTRACTORS ARE REQUIRED TO COORDINATE THEIR WORK WITH ALL DISCIPLINES TO AVOID CONFLICTS. ALL STRUCTURAL, MECHANICAL, ELECTRICAL AND PLUMBING ASPECTS ARE NOT IN THE SCOPE OF THESE DRAWINGS. THEREFORE, ALL REQUIRED MATERIALS AND WORK MAY NOT BE


INDICATED. IT IS THE CONTRACTOR'S RESPONSIBILITY TO COORDINATE THESE DRAWINGS WITH ALL OTHER CONSTRUCTION DOCUMENTS. LOCATIONS, SIZES AND NUMBERS OF ALL OPENINGS MAY NOT BE COMPLETELY INDICATED IN THE ARCHITECTURAL DRAWINGS. THE RESPECTIVE CONTRACTOR

	CILLOTATE ROMBERTO OF THE OF ENTIRE COMMERCE OF THE PROPERTY O
	SHALL VERIFY THEIR WORK WITH ALL OTHER DISCIPLINES.
23.	THE CONTRACT DOCUMENTS DO NOT INDICATE THE METHOD OF CONSTRUCTION. THE CONTRACTOR SHALL PROVIDE ALL MEASURES NECESSARY TO
	PROTECT THE STRUCTURE DURING CONSTRUCTION. SUCH MEASURES SHALL INCLUDE, BUT NOT LIMITED TO, BRACING, SHORING, UNDERPINNING, ETC.
	ARCHITECT IS NOT RESPONSIBLE FOR THE CONTRACTOR'S MEANS, METHODS, TECHNIQUES, SEQUENCES OR SAFETY PROCEDURES DURING
	CONSTRUCTION.

	APPLICABLE C	ODES			DRAW	ING	INDEX	Ш
BUILDING:	2022 OREGON STRUCTURAL SPI	ECIALTY CODE		REVISION		SHEET	OUEETNAME	11
MECHANICAL:	2022 OREGON MECHANICAL SPE	ECIALTY CODE			02/27/24	#	SHEET NAME	Ш
PLUMBING:	2021 OREGON PLUMBING SPECI	ALTY CODE (OPSC)			•	CS1.0	COVER SHEET	11
ELECTRICAL:	2021 OREGON ELECTRICAL SPE	CIALTY CODE (OESC), BA	ASED ON 2020 NFPA 70, NEC		•	CS2.0	RESPONSIBILITY SCHEDULE	11
LIFE SAFETY:	2022 OREGON FIRE CODE (OFC)				•	CS3.0	VENDOR CONTACTS & SUBMITTAL REQUIREMENTS	11
ACCESSIBILITY:	2017 ICC/ANSI A117.1 ACCESSIBI	LE AND USEABLE BUILDI	NGS AND FACILITIES		•	HC1.1	ACCESSIBILITY DETAILS	11
ENERGY CONSERVATION:	2021 OREGON ENERGY EFFICIE	NCY SPECIALTY CODE   :	2019		•	D-1	DEMOLITION PLAN	11
	OREGON ZERO ENERGY READY	•			•	D-2	DEMOLITION ELEVATION	11
OCCUPANCY LOAD CALCULATI	IONS				•	A1.0	EGRESS PLAN	11
GROSS AREA:	11,277 S.F.				•	A1.1	FIXTURE PLAN AND SPECIFICATIONS	11
MERCANTILE AREA:	8,308 SQ.FT./60 SQ.FT. PER PER	SON = 139			•	A2.0	DIMENSION PLAN AND DETAILS	11
BUSINESS AREA:	1,867 SQ.FT./150 SQ.FT. PER PEF	RSON = 13			•	A2.1	ENLARGED SALON PLAN	11
STAGING AREA:	1,102 SQ.FT./300 SQ.FT. PER PEF	RSON = 4			•	A2.3	WALL TYPES, STUD FRAMING & BLOCKING DETAILS	11
TOTAL OCCUPANCY:		156 PERSONS			•	A2.4	DOOR & HARDWARE SCHEDULES	11
					•	A2.5	ROLLING GRILLES DETAILS	11
	BUILDING REQUIR				•	A3.1	REFLECTED CEILING PLAN AND DETAILS	11
DESCRIPTION	CODE SECTION	REQUIREMENTS			•	A3.2	ARCH & PERIMETER LIGHTING PLAN & DETAILS	11
USE GROUP:	OSSC CHAPTER 3, SECTION 309	M (MERCANTILE)			•	A3.3	DETAILS	11
NUMBER OF STORIES:		1			•	A4.1	FLOOR FINISH PLAN, SCHEDULE & SPECIFICATIONS	11/
CONSTRUCTION TYPE:	OSSC TABLE 601	TYPE II-B (EXIST. NO (	CHANGE)		•	A6.1	INTERIOR ELEVATIONS	
FIRE SPRINKLERS:	OSSC SECTIONS 507.4	FULLY SPRINKLERED			•	A6.2	INTERIOR ELEVATIONS	11
SEISMIC CATEGORY:		D			•	A6.3	INTERIOR ELEVATIONS & ENLARGED TOILET ROOM PLAN	11
TENANT AREA:	OSSC SECTION 507.4	11,277 S.F. AREA OF V	VORK		•	A6.4	INTERIOR ELEVATIONS	11
OCCUPANT LOAD:		156 PERSONS			•	A7.1	EXTERIOR ELEVATION	11
NUMBER OF EXITS:	OSSC TABLE 1006.3.2	2 REQUIRED			•	A7.2	EXTERIOR ELEVATION	s
		2 PROVIDED			•	A7.3	EIFS DETAILS	17
EXIT WIDTH:	OSSC TABLE 1005.3.2	23.4" REQUIRED			•	A8.1	CONSTRUCTION DETAILS	<b>1</b> 1;
		108" PROVIDED			•	A8.2	CONSTRUCTION DETAILS	- F
MAX. TRAVEL DIST.:	OSSC TABLE 1017.2	250-FT. MAX.			•	A8.3	CONSTRUCTION DETAILS	
REQUIRED PLUMBING FIXTURE	ES	•			•	F1.1A	WALL FIXTURE DETAILS	1
		MALE	FEMALE		•	F1.1B	WALL FIXTURE DETAILS	
LAVATORIES:	OSSC TABLE 2902.1	1 REQUIRED	1 REQUIRED		•	F1.1C	FIXTURE ELEVATIONS	
		1 PROVIDED	1 PROVIDED		•	SP1	SPECIFICATIONS	
TOILETS:	OSSC TABLE 2902.1	1 REQUIRED	1 REQUIRED		•	SP2	SPECIFICATIONS	A
		1 PROVIDED	1 PROVIDED		•	SP3	SPECIFICATIONS	

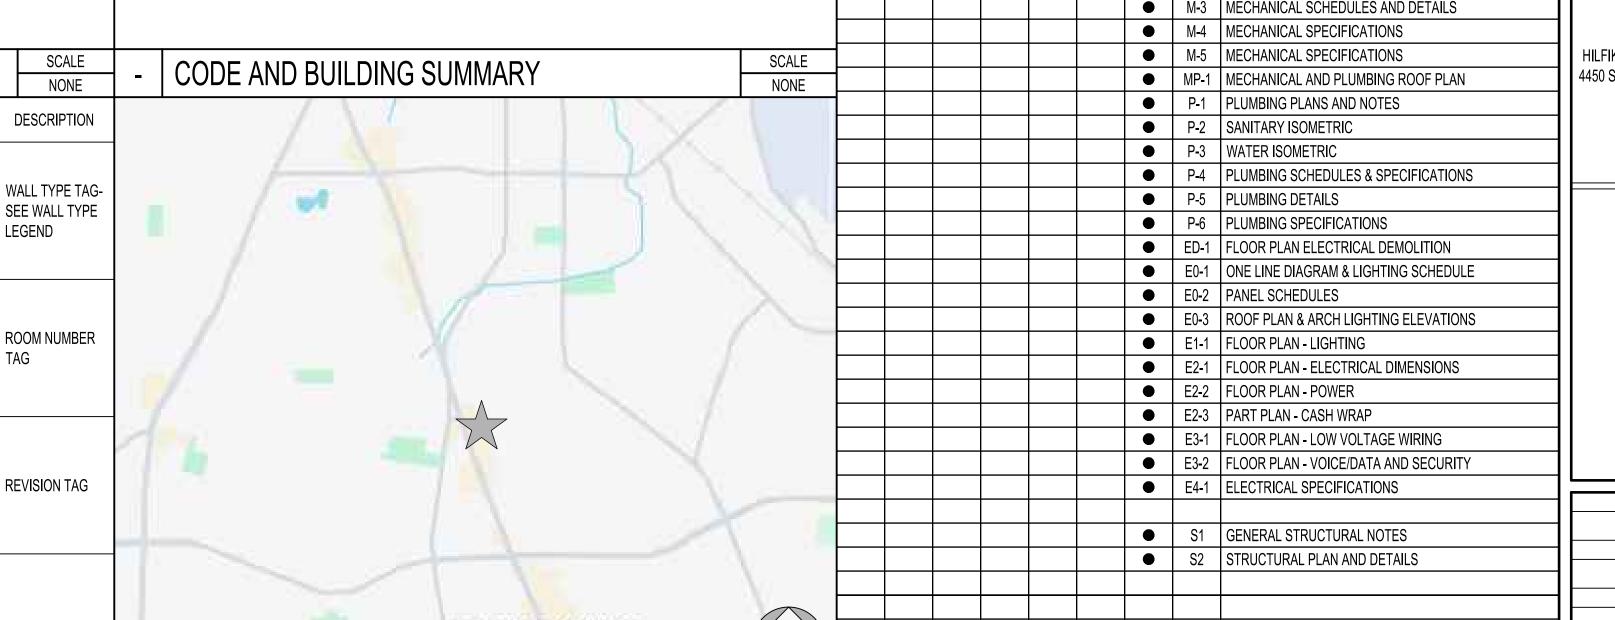

DRAWING INDEX

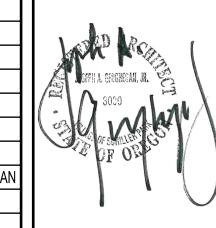

Schiller Park, IL 60176 p: 847.671.7452 f: 847.671.4200 www.rgla.com

LL & ULTA REVIEW

PERMIT ISSUE

associates,

SEAL: 02/28/2024

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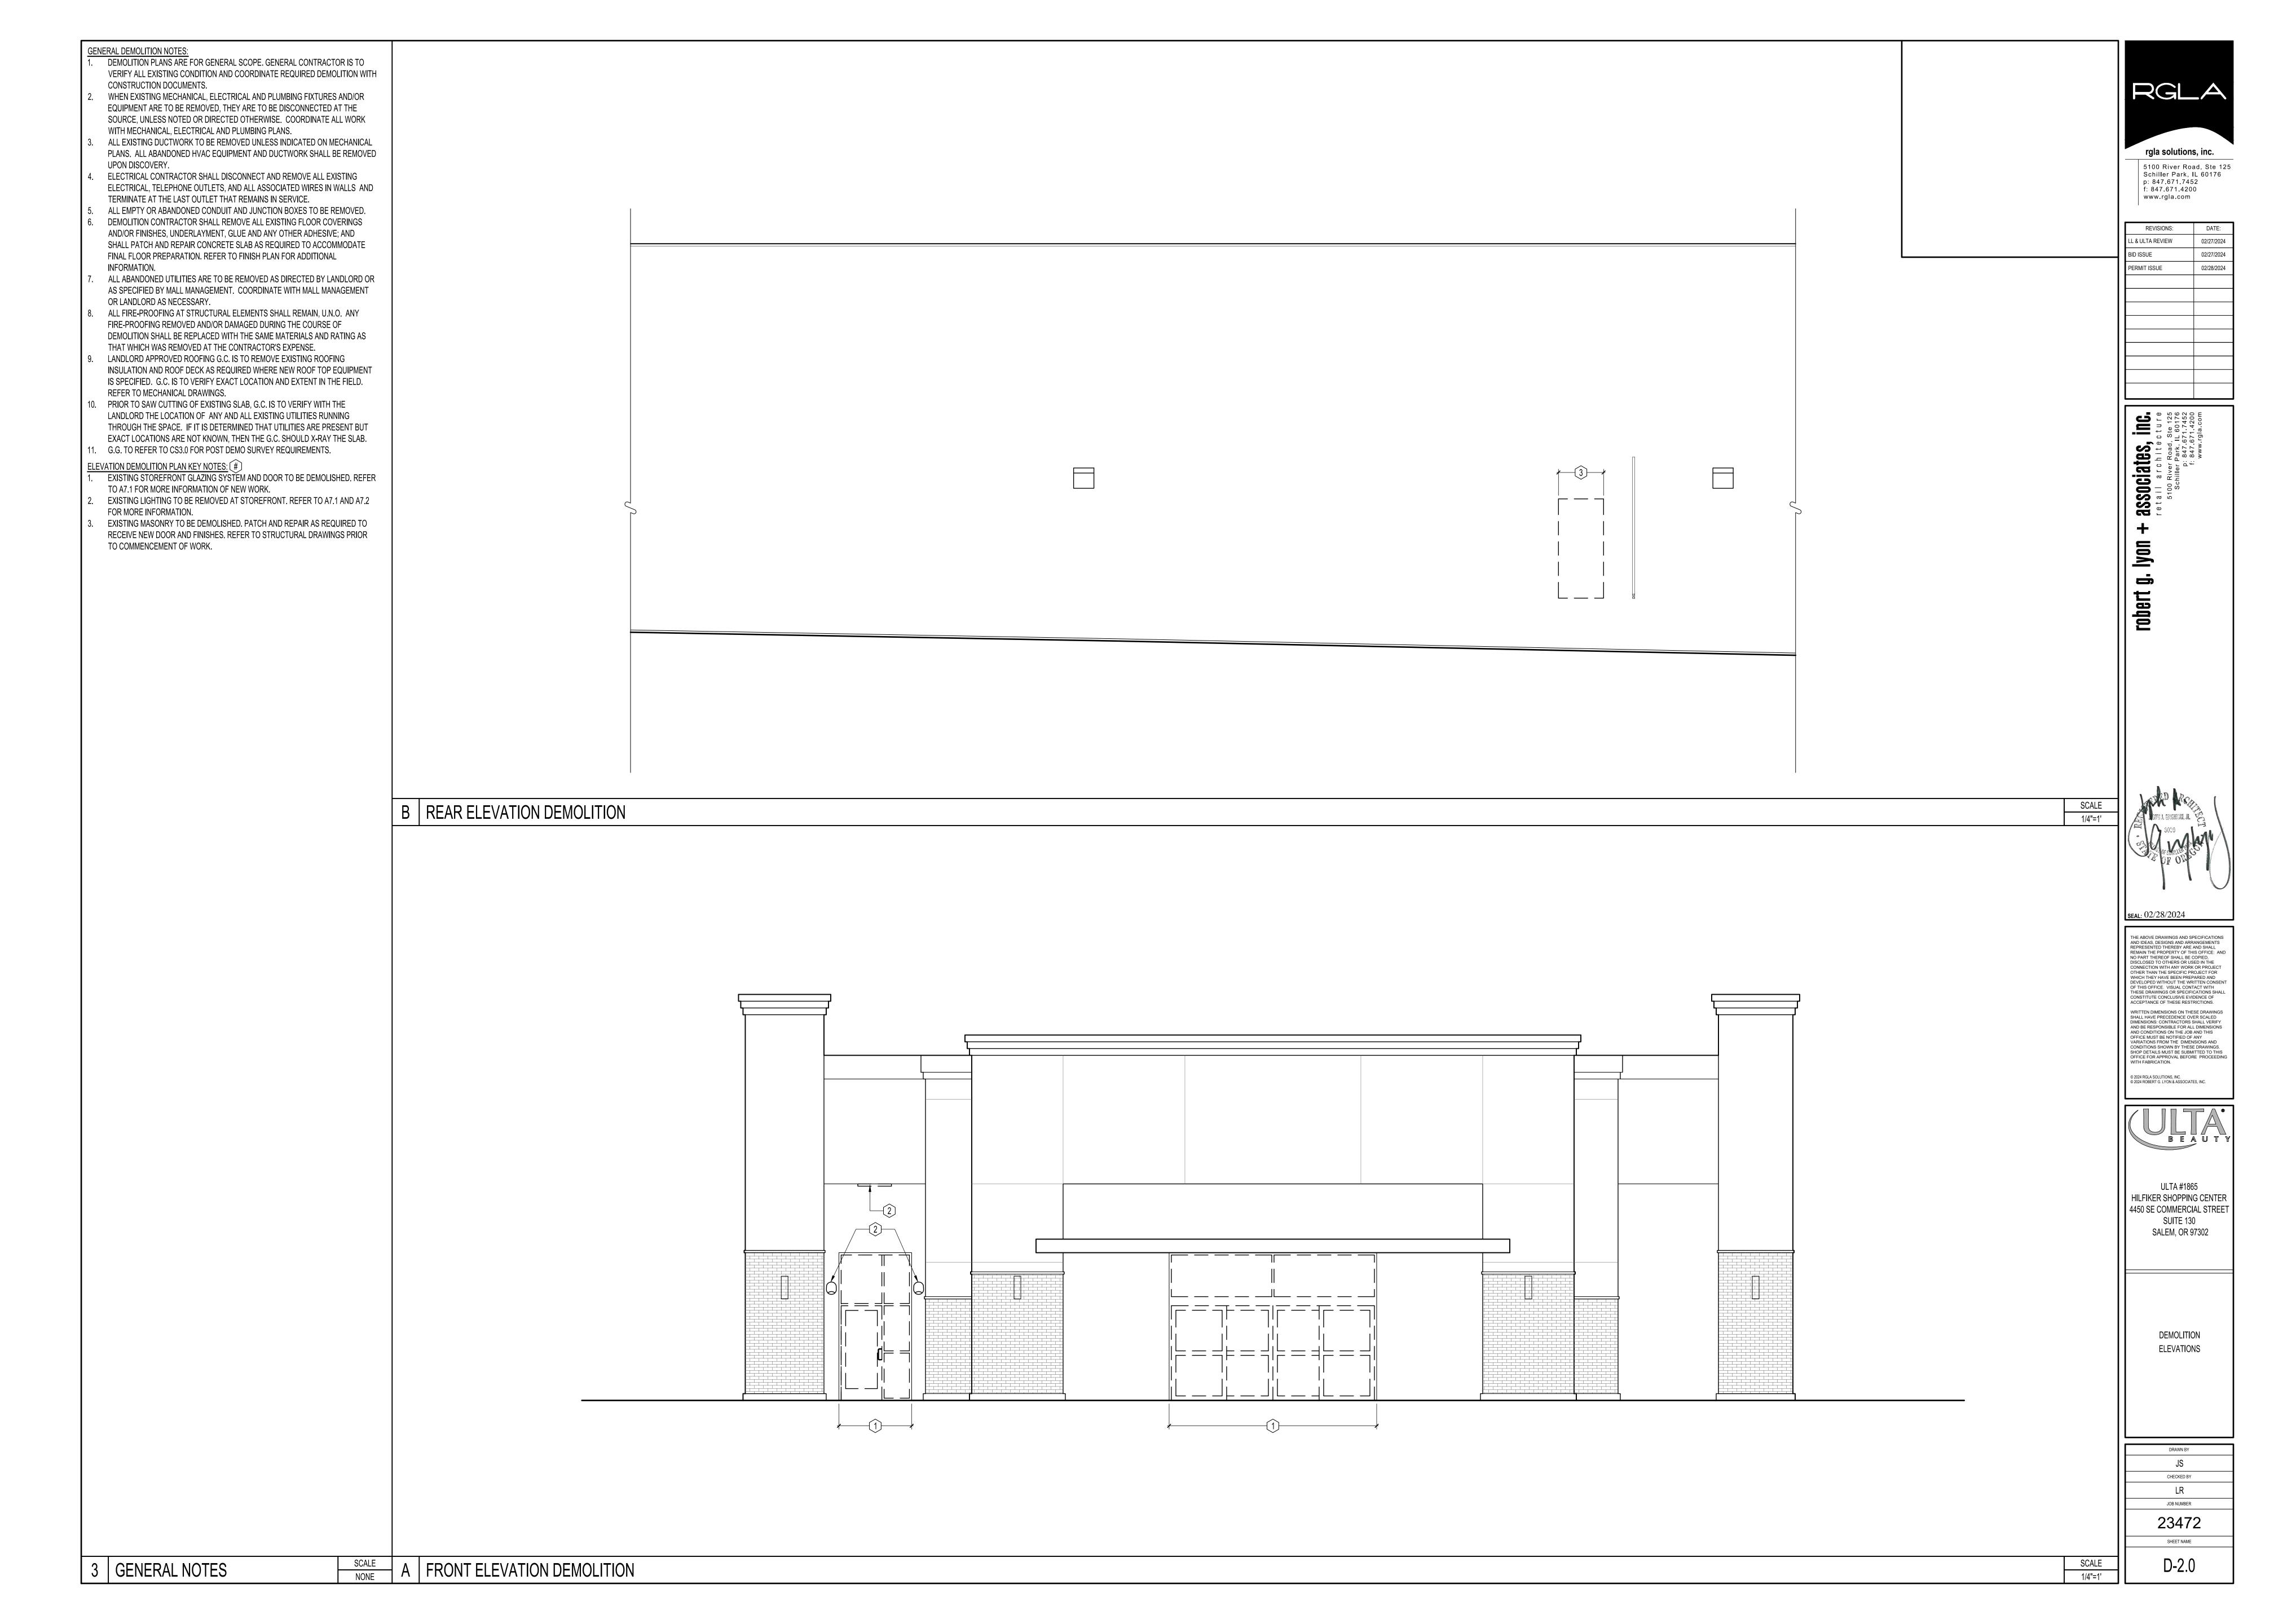
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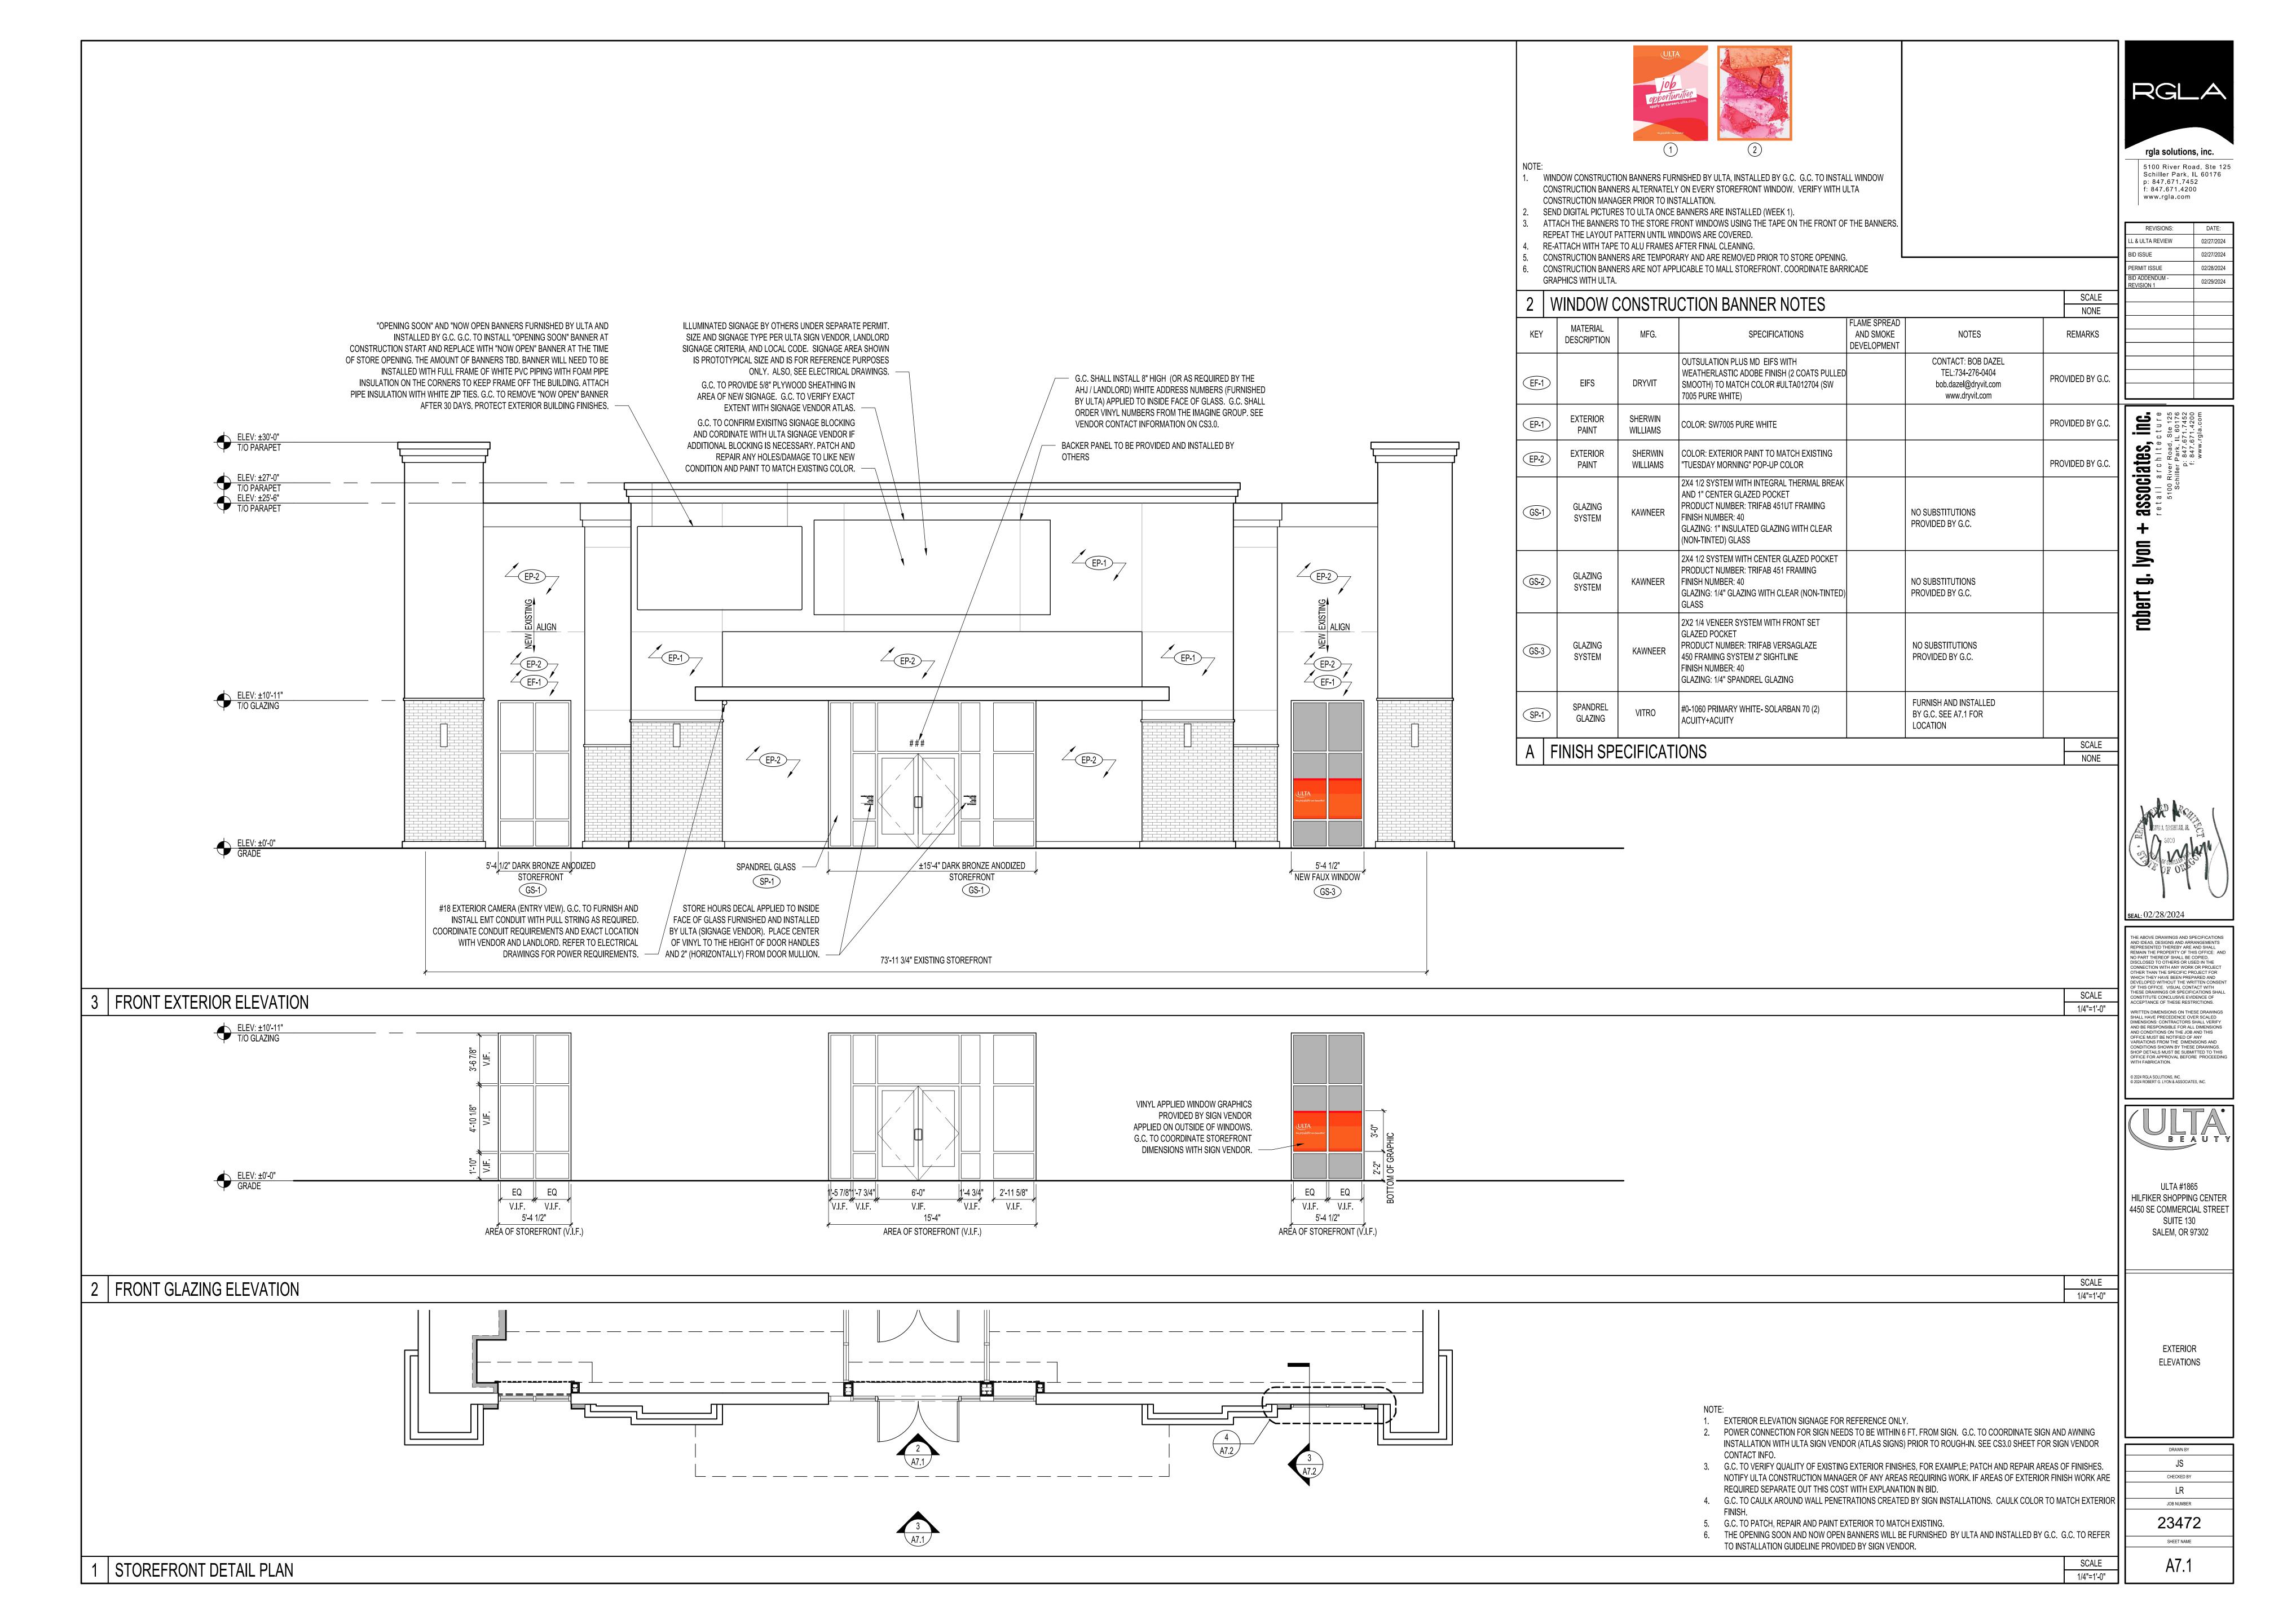
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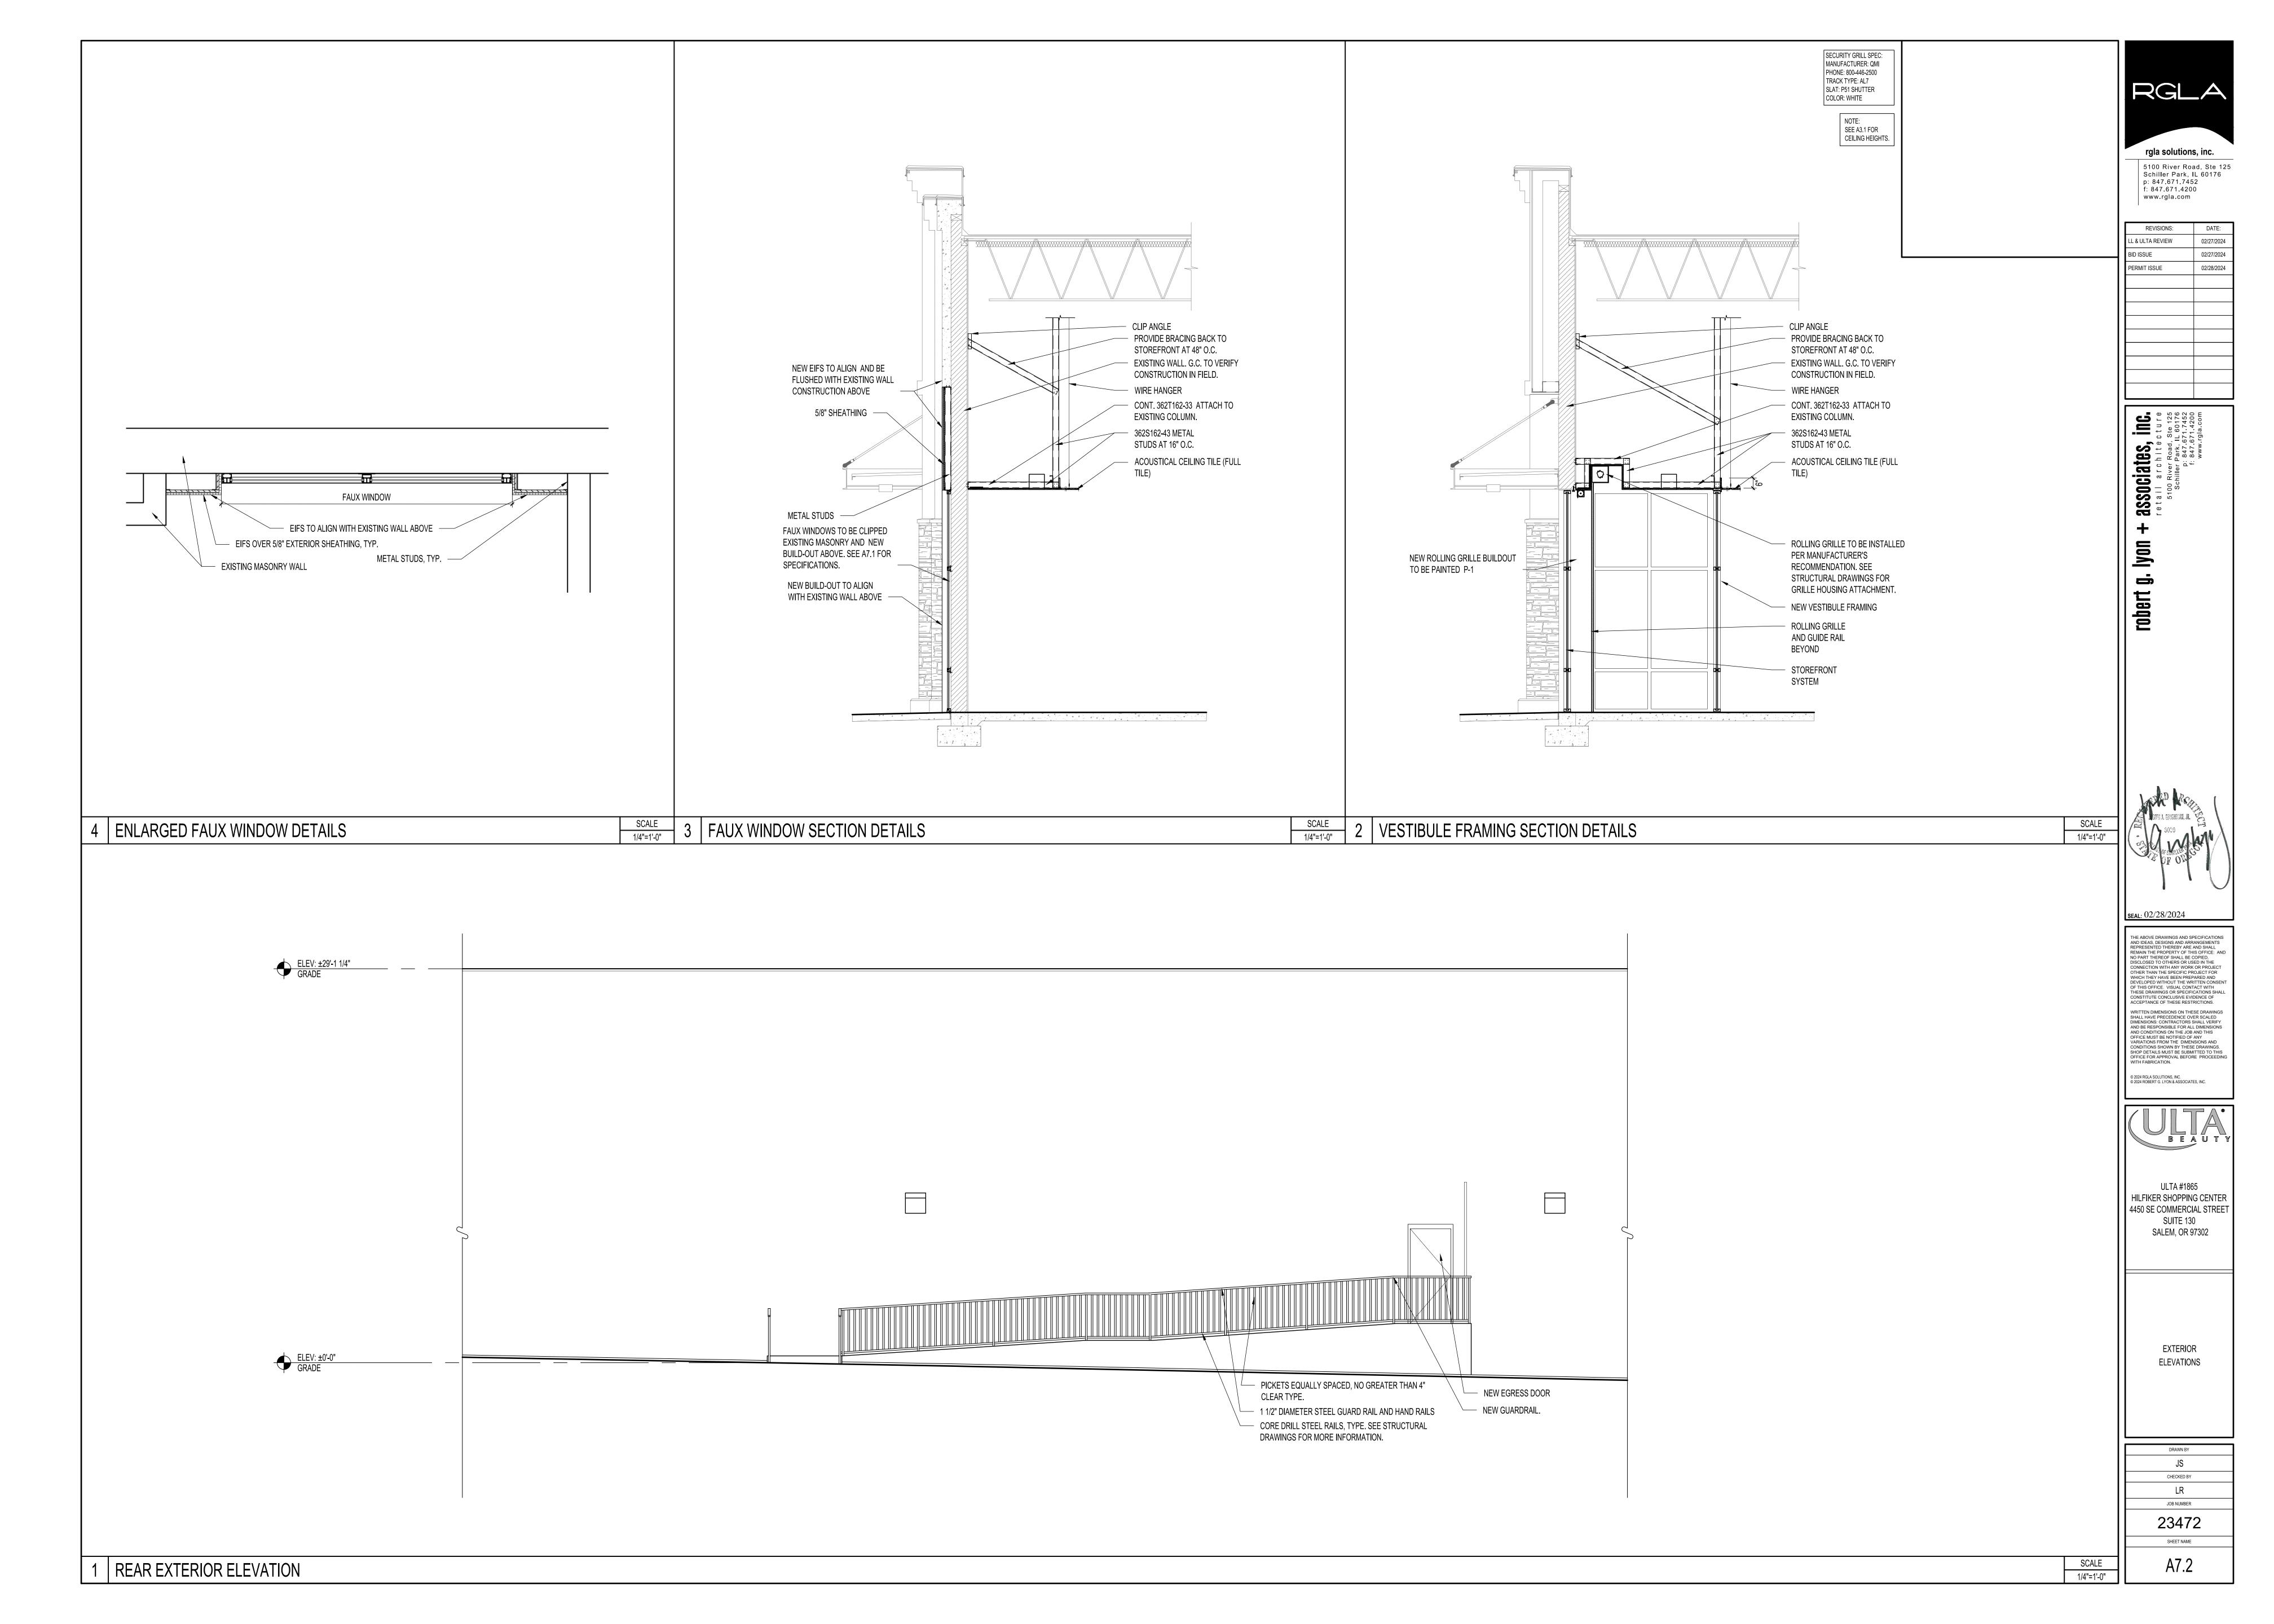
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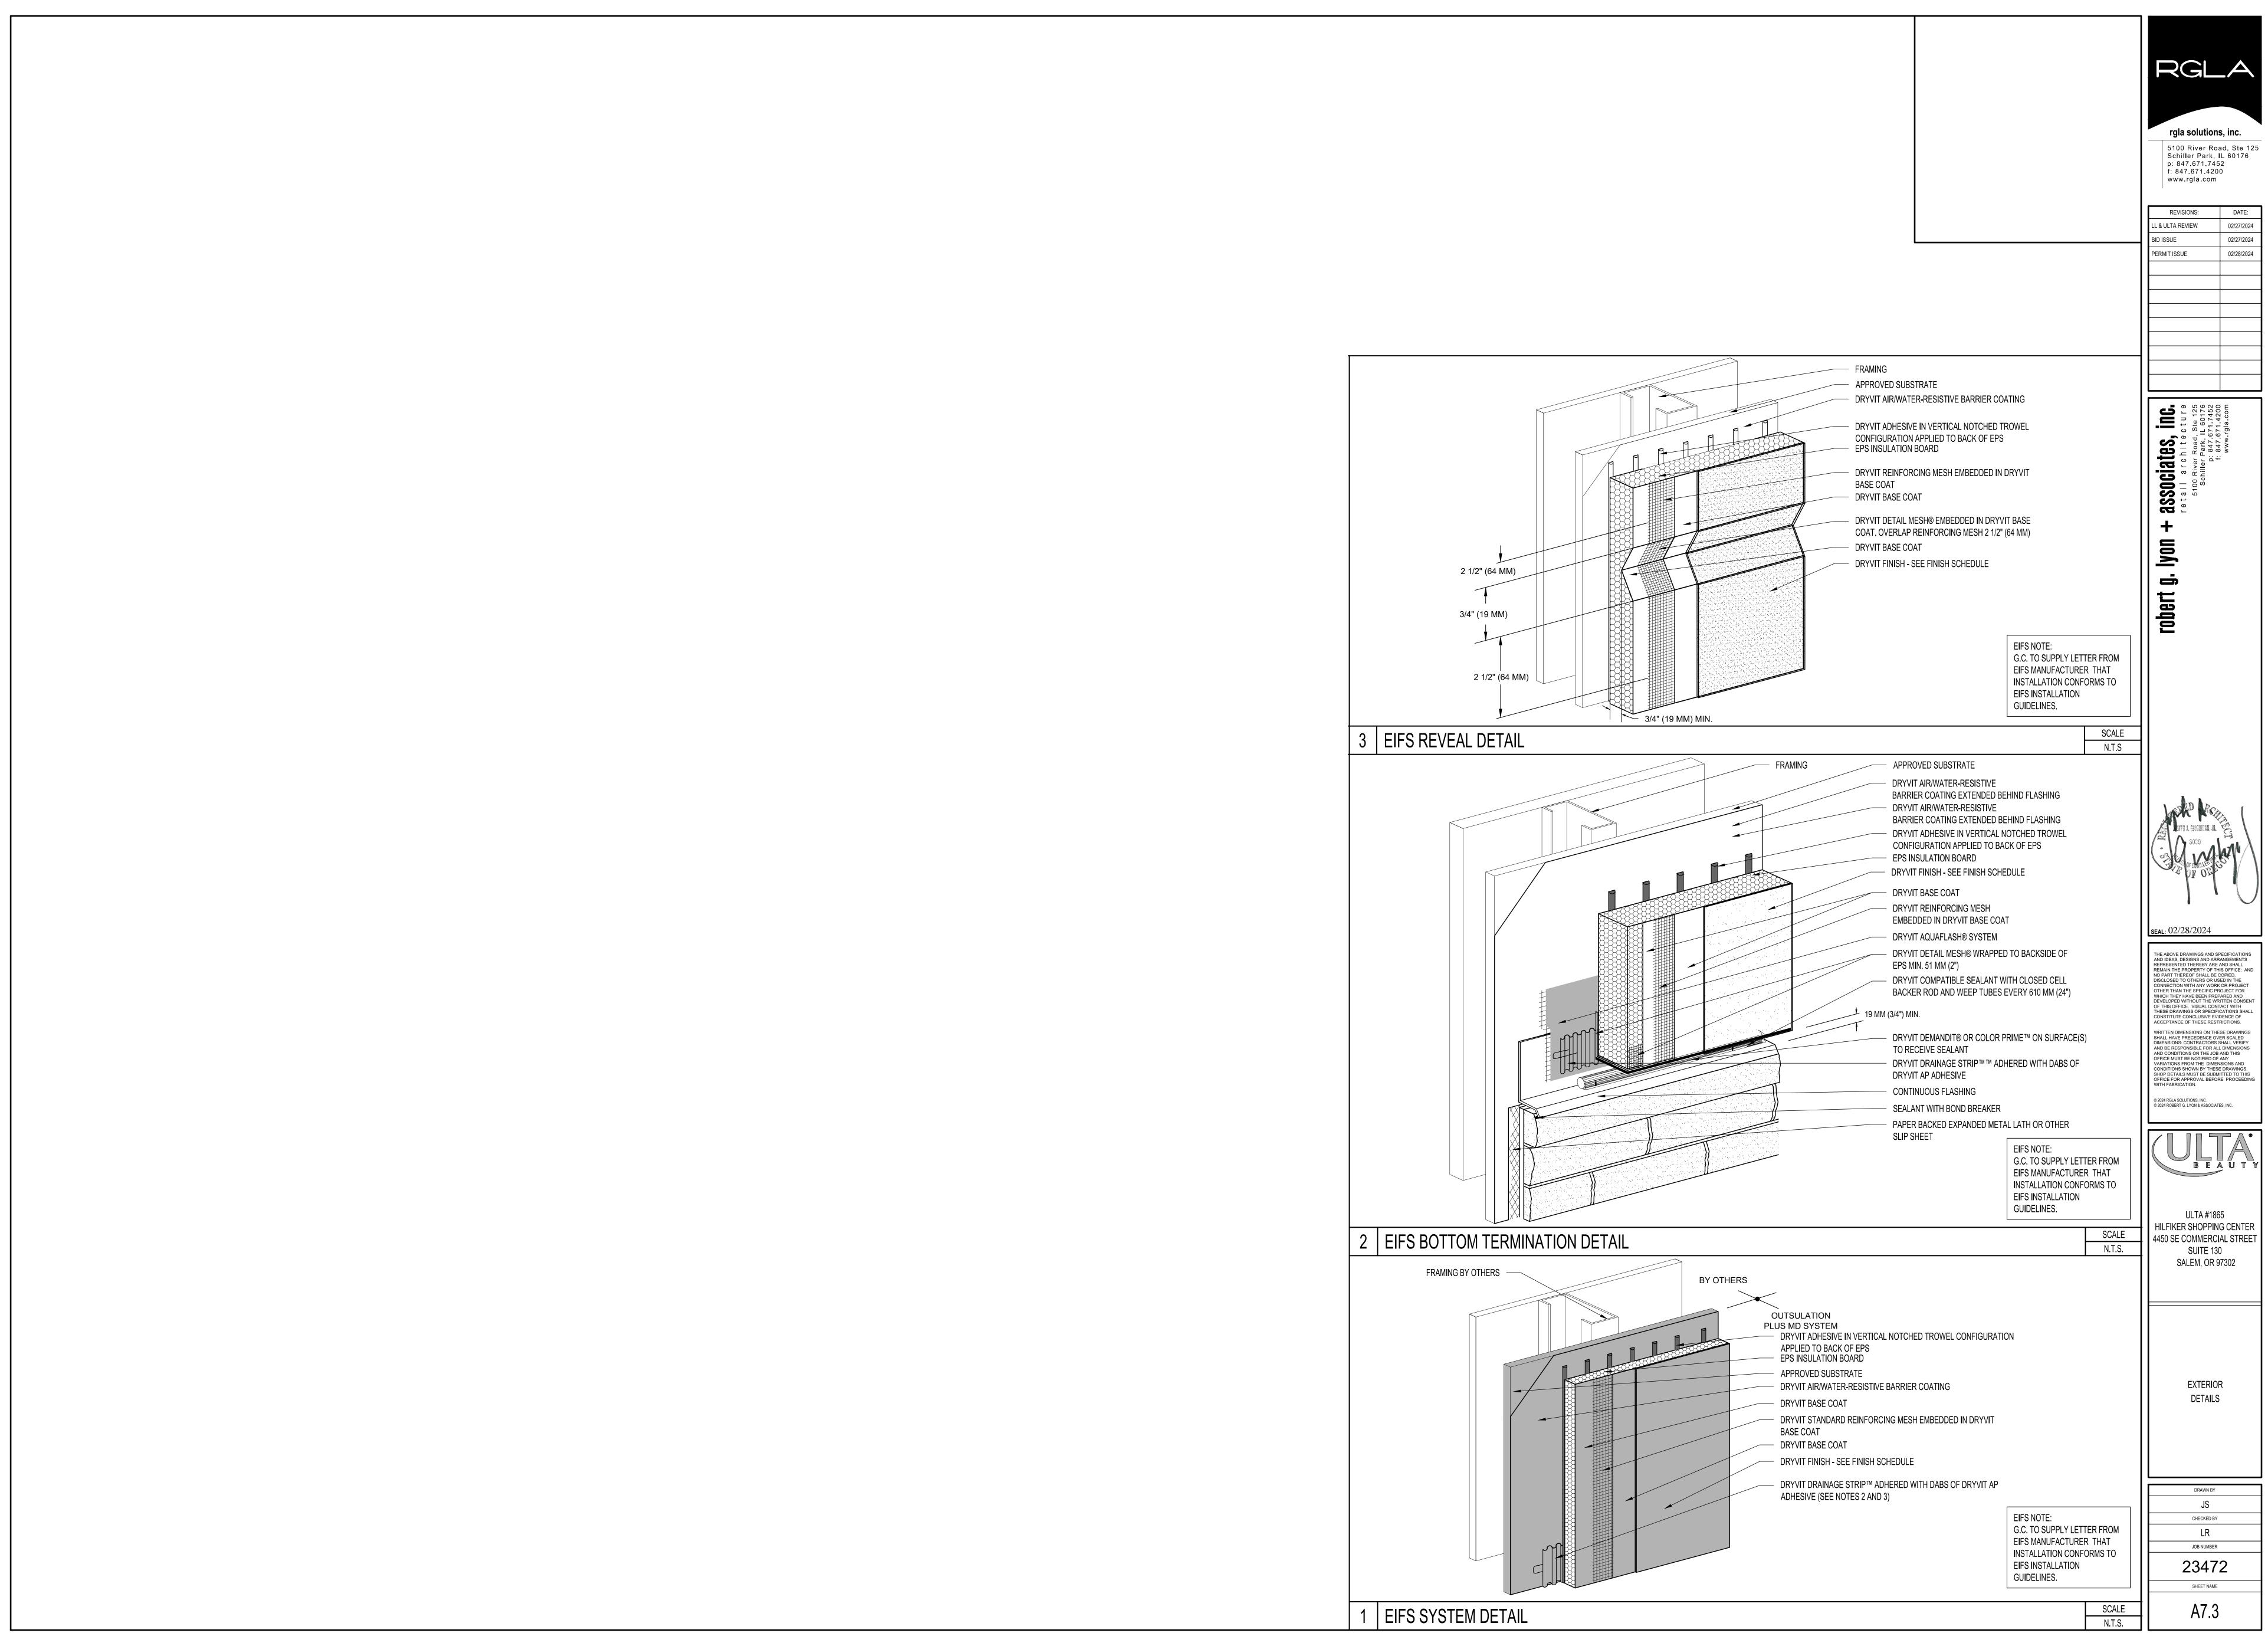
SCALE

NONE










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IIT ISSUE	02/28/2024	




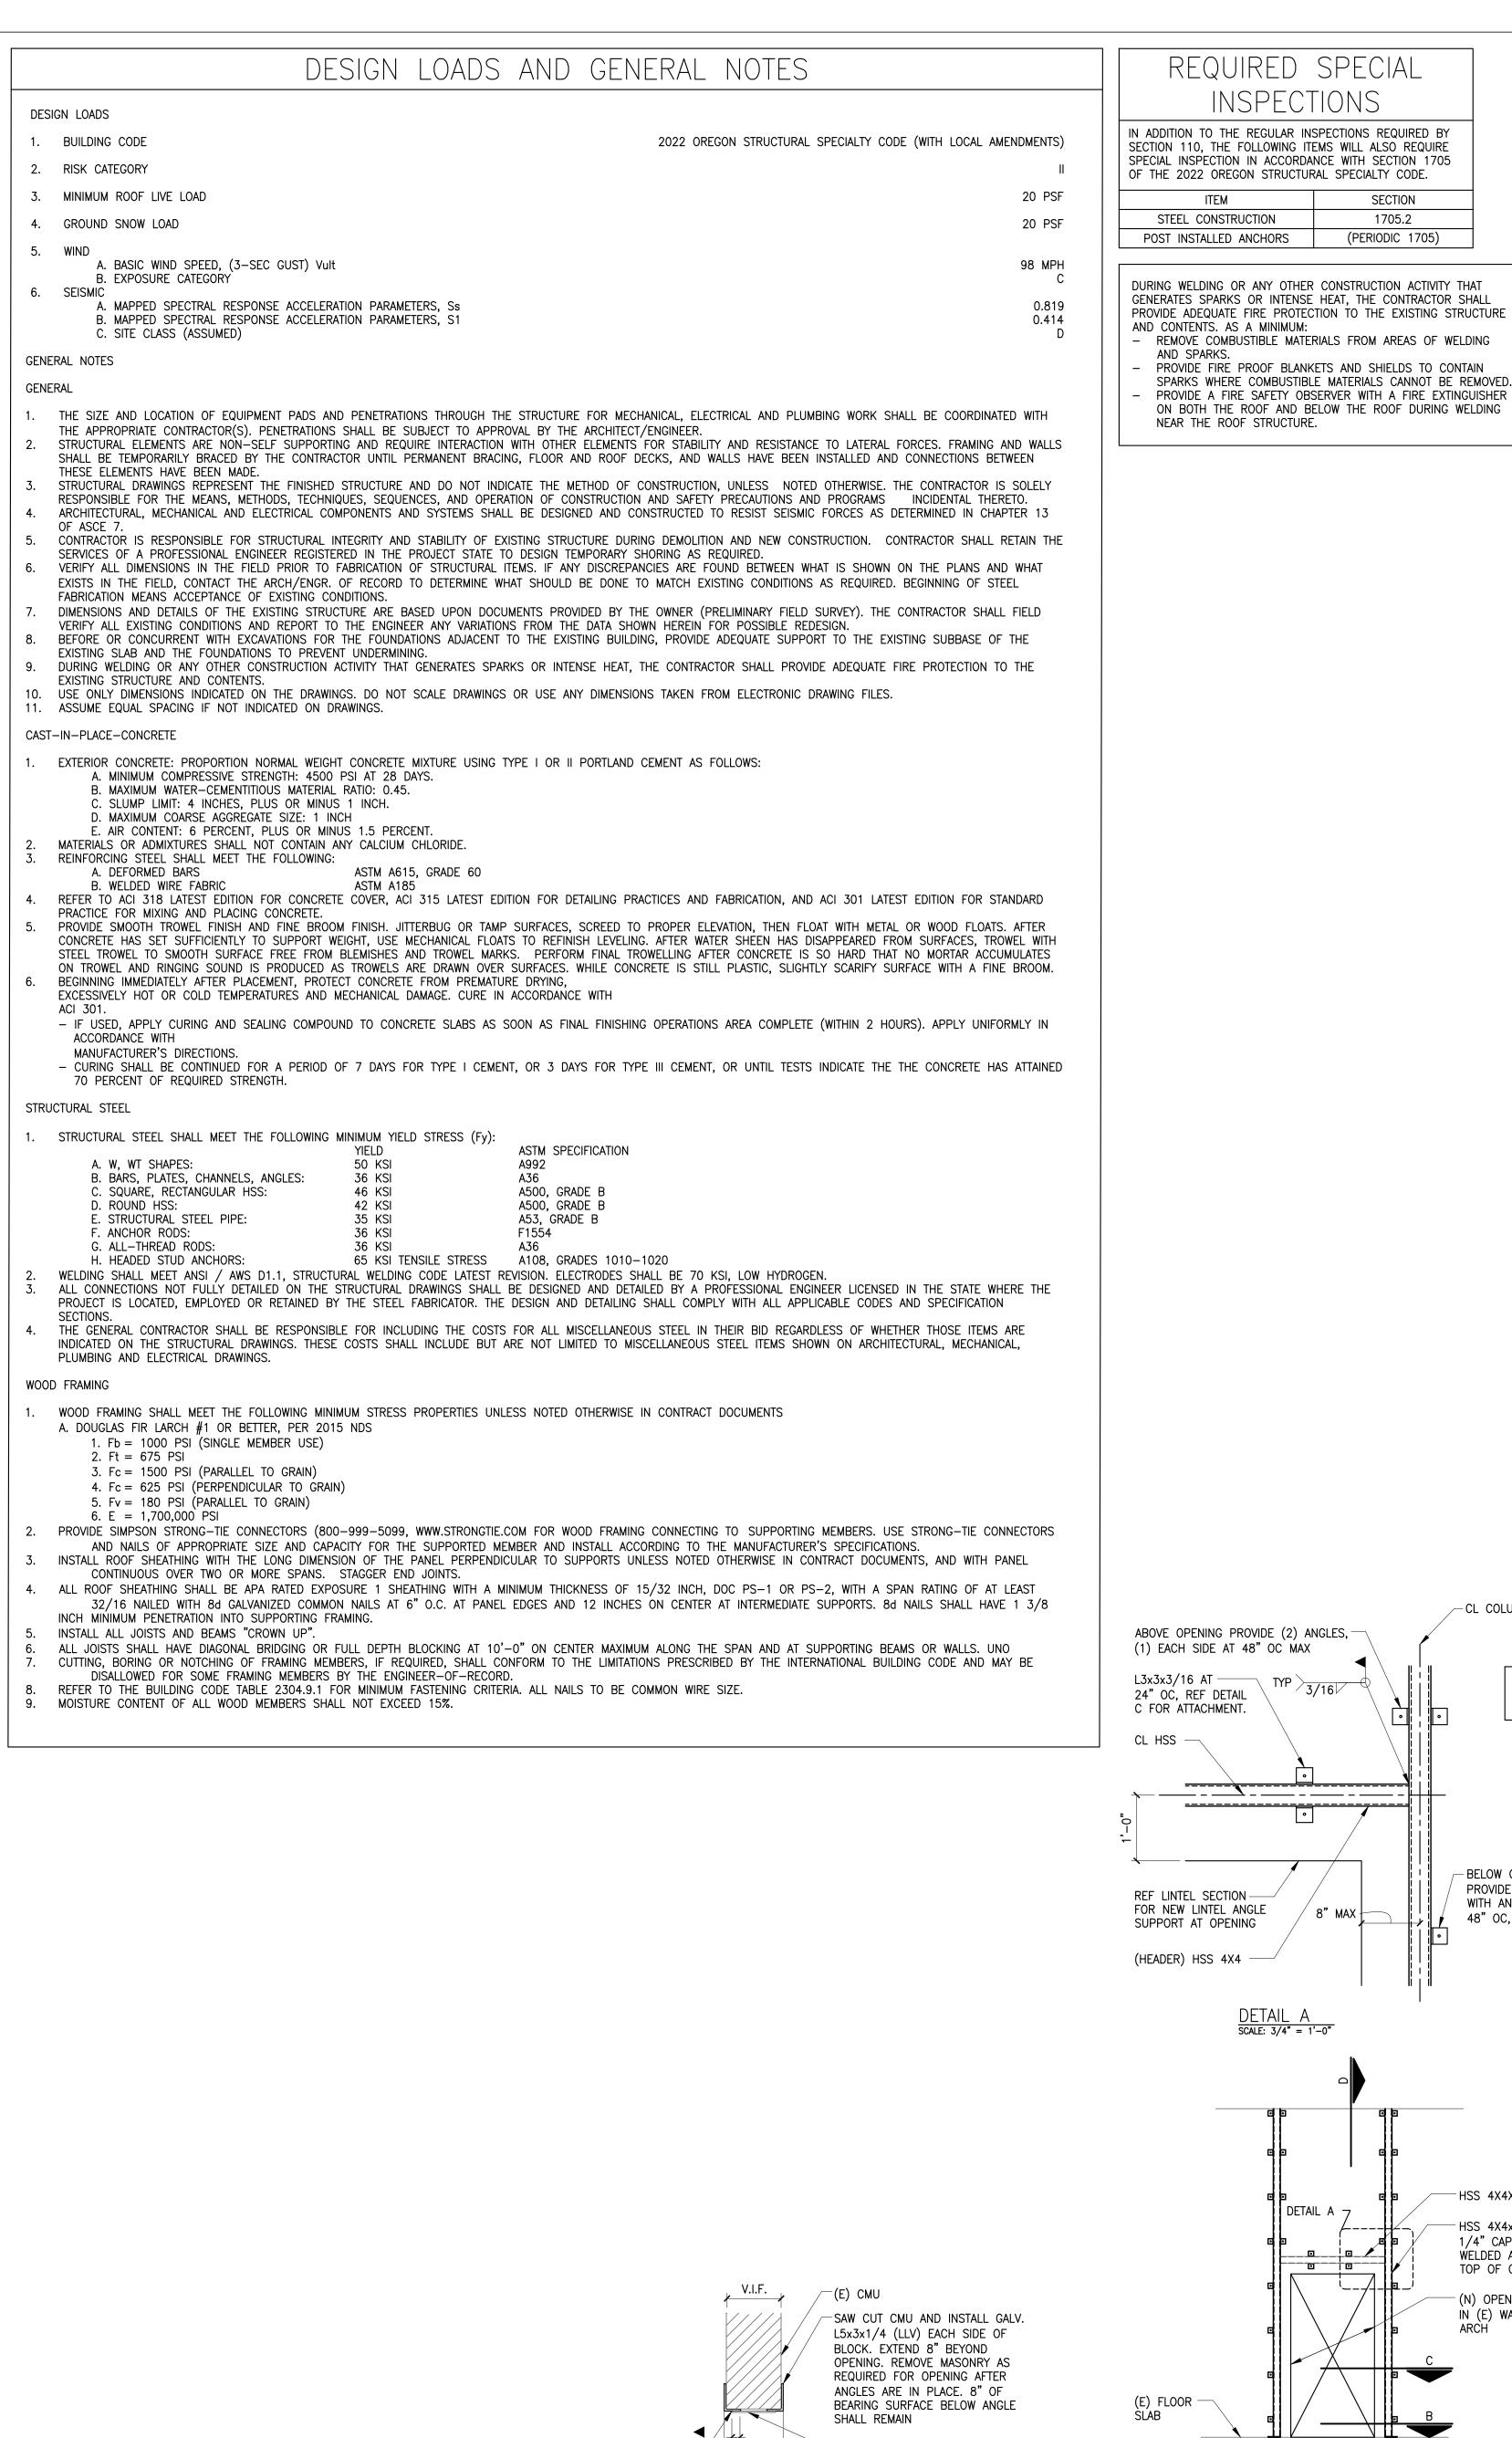

-PLATE 3/16"xCONTx

WIDTH AS REQUIRED

<sup>1</sup> 1/2" TYP

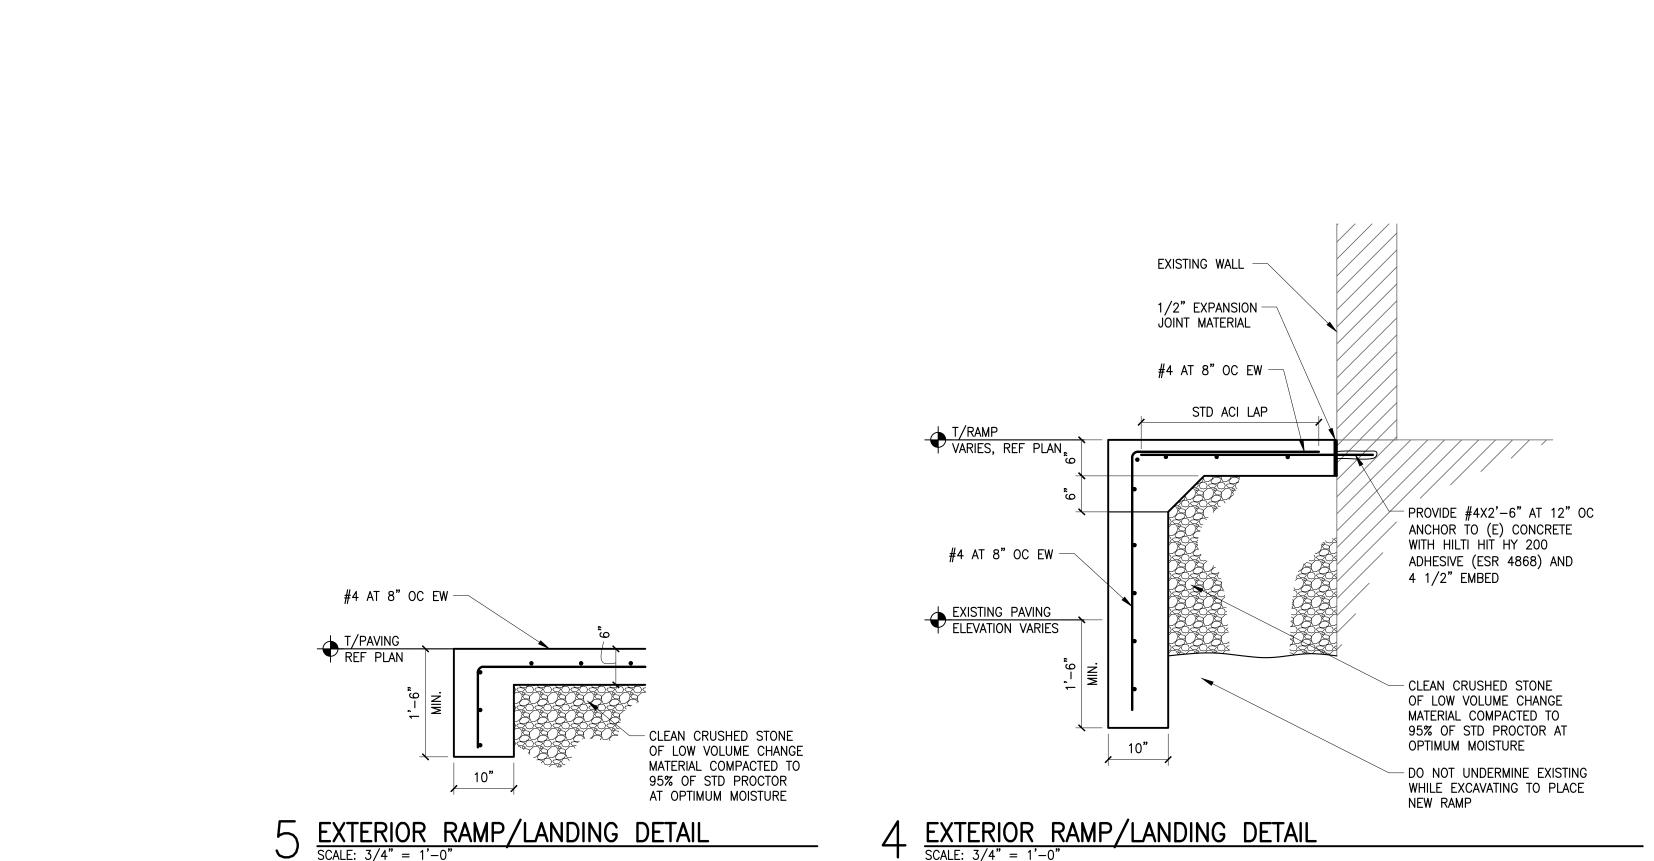

(E) ROOF DECK

DECK BEARING

ANCHOR TOP OF

EACH SIDE OF COLUMN, REF DETAIL

BASE PLATE 10"x5"x3/8" WITH (2) 1/2" DIA HILTI HIT HY 200

ADHESIVE ANCHORS (ESR 4868).

PROVIDE 3 1/2" MIN EMBEDMENT

COLUMN TO (E) CMU WITH CONNECTION

WITH 3" MIN EMBEDMENT.

FIELD VERIFY

SECTION

1705.2

CL COLUMN

BELOW OPENING,

WITH ANCHOR AT

48" OC, MAX

— HSS 4X4X3/16 TYP

1/4" CAP PLATE BUTT

WELDED ALL AROUND

TOP OF COLUMN, TYP

(N) OPENING SAWCUT

IN (E) WALL, REF

2 STRONG BACK AT NEW OPENING SCALE: 3/4"=1'-0"

PROVIDE (1) ANGLE

DO NOT DRILL THROUGH

(E) CMU

SAW CUT EDGE -OF (E) WALL

SAW CUT EDGE

 $TYP > \frac{3/16}{}$ 

OF (E) WALL


 $\frac{\text{DETAIL C}}{\text{SCALE: } 3/4" = 1'-0"}$ 

 $\frac{\text{DETAIL B}}{\text{SCALE: } 3/4" = 1'-0"}$ 

OR DAMAGE EXISTING

REBAR REINFORCING.

(PERIODIC 1705)

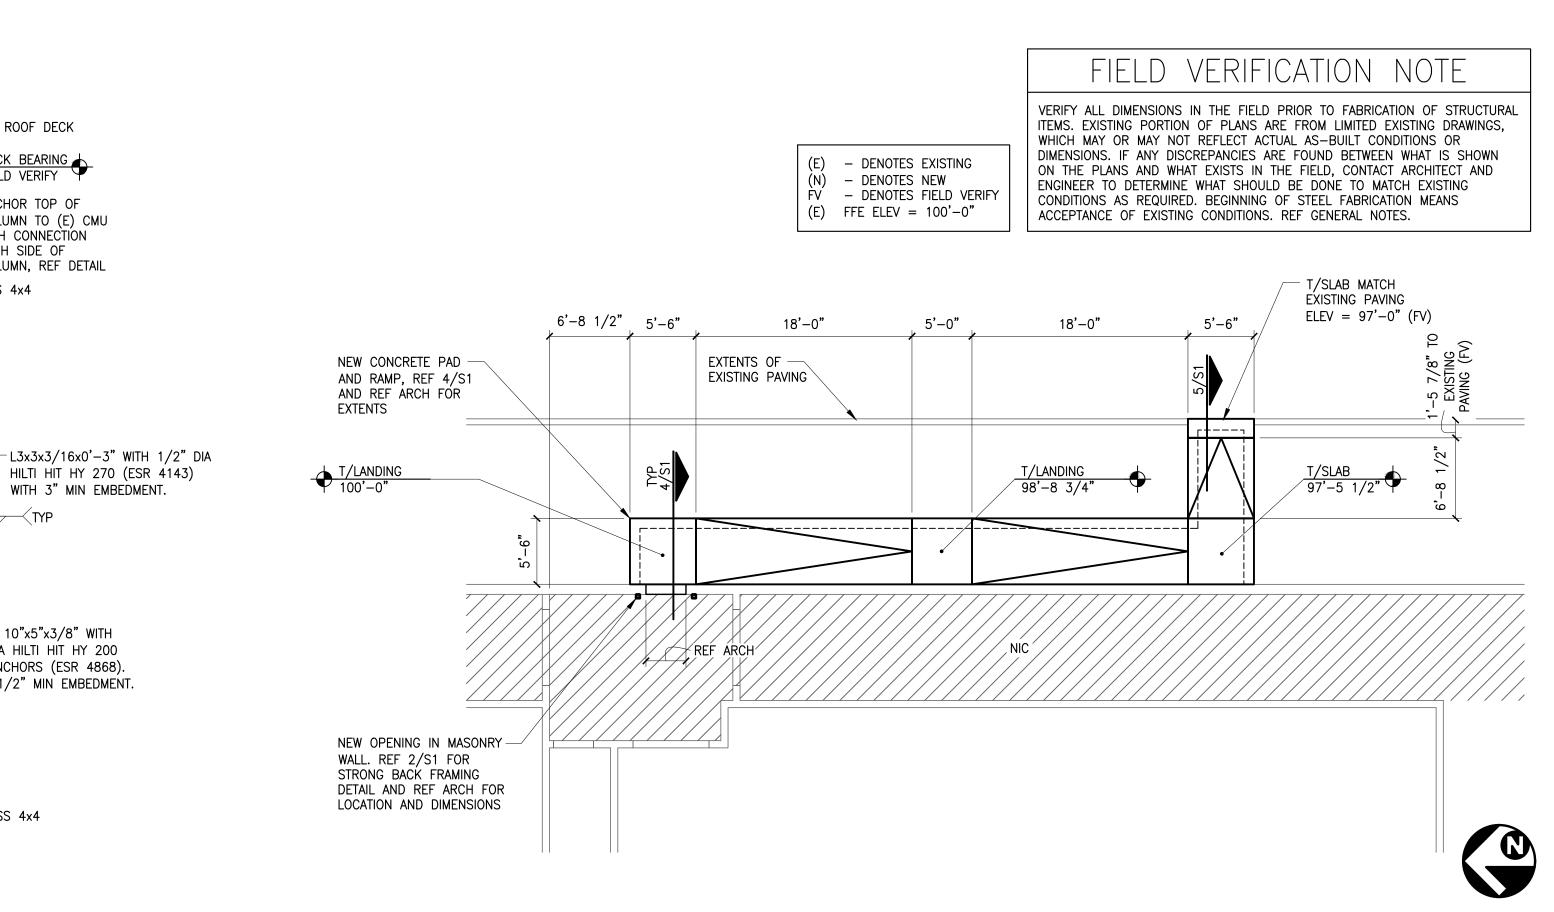



5100 River Road, Ste 125 Schiller Park, IL 60176 p: 847.671.7452 f: 847.671.4200 www.rgla.com

REVISIONS:	DATE:
LL & ULTA REVIEW	02/27/2024
BID ISSUE	02/27/2024
PERMIT ISSUE	02/28/2024

ing. associates, retail archited 5100 River Road S robert



EXPIRES: 06.30.2024

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DIMENSIONS: CONTRACTORS SHALL VERIFY
AND BE RESPONSIBLE FOR ALL DIMENSIONS AND BE RESPONSIBLE FOR ALL DIMENSIONS AND CONDITIONS ON THE JOB AND THIS OFFICE MUST BE NOTIFIED OF ANY VARIATIONS FROM THE DIMENSIONS AND CONDITIONS SHOWN BY THESE DRAWINGS. SHOP DETAILS MUST BE SUBMITTED TO THIS OFFICE FOR APPROVAL BEFORE PROCEEDING WITH FABRICATION.

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ULTA #1865 HILFIKER SHOPPING CENTER 4450 SE COMMERCIAL STREET SUITE 130 SALEM, OR 97302

GENERAL NOTES. PARTIAL FOUNDATION PLAN AND DETAILS

DRAWN BY CHECKED BY CBG/DLS JOB NUMBER 23472

SHEET NAME

**S**1

PARTIAL FOUNDATION PLAN

SCALE: 1/4" = 1'-0"